	PLUMBING
SYMBOL	DESCRIPTION
SAN	SANITARY DRAINAGE - ABOVE GROUND
— — — SAN— — —	SANITARY DRAINAGE - UNDERGROUND
SAN(AR)——	SANITARY DRAINAGE (ACID RESISTANT) - ABOVE GROUND
	SANITARY DRAINAGE (ACID RESISTANT) - UNDERGROUND
STM-	STORM DRAINAGE - ABOVE GROUND
— — — STM— — —	STORM DRAINAGE - UNDERGROUND
PD	PUMPED DISCHARGE
	DOMESTIC COLD WATER SUPPLY
	DOMESTIC HOT WATER SUPPLY
	DOMESTIC HOT WATER RECIRC.
TW	TEMPERED WATER
AWV	ACID RESISTANT VENT
	VENT
NG	NATURAL GAS
RO	REVERSE OSMOSIS PIPING
ISO	RADIO ISOTOPE DRAIN
CA	COMPRESSED AIR
	RUNNING TRAP
	P-TRAP
	EMERGENCY SHOWER
OEW-1	EYE WASH
O CO	CLEANOUT IN FLOOR/BELOW GRADE
- ı co	CLEANOUT IN CEILING
● HB	HOSE BIBB
● NFHB	NON FREEZE HOSE BIBB
G . ک	SINGLE GAS OUTLET
<b>Ç</b> G	DOUBLE GAS OUTLET
● CA	COMPRESSED AIR OUTLET
● RH	ROOF HYDRANT
● GH	GROUND HYDRANT
Ø RD	ROOF DRAIN
Ø CFRD	CONTROL FLOW ROOF DRAIN
O VTR	VENT THROUGH ROOF
O RWL	RAIN WATER LEADER
TSP	TRAP SEAL PRIMER
	SCUPPER DRAIN
МН	MANHOLE
<b>■</b> CB	CATCH BASIN
TD	TRENCH GRATE & FRAME
Ø AD	AREA DRAIN
● FFD	FUNNEL FLOOR DRAIN
Ø FD	FLOOR DRAIN
	HUB DRAIN
<b>⊟</b> FS	FLOOR SINK
Ø FRD	FLOOR DRAIN - FLUSHING RIM
(M)	WATER METER ASSEMBLY
©	GAS METER
D	BACK WATER VALVE
BFP	BACKFLOW PREVENTER
"WC-1"	DENOTES FIXTURE TYPE PER SPECIFICATION

	FIRE PROTECTION						
SYMBOL	DESCRIPTION						
SP	SPRINKLER LINE						
FM	FIRE MAIN						
———F———	STANDPIPE						
X	SUPERVISED VALVE						
s <sup>WFA</sup>	WATER FLOW ALARM						
PS PS	PRESSURE SWITCH						
'₹'	TEST CONNECTION						
•\$	FIRE DEPARTMENT CONNECTION						
	PRESSURE SWITCH						
Y	WATER FLOW ALARM						
P	—EXCESS PRESSURE PUMP						
XX	WET ALARM CHECK VALVE						
J I	TEST & DRAIN VALVE						
_ 1	WATER FLOW ALARM						
	PRESSURE SWITCH						
Z Z	DRY ALARM CHECK VALVE						
7 7	TEST & DRAIN VALVE						
	AIR COMPRESSOR						
SVC	SPRINKLER VALVE CABINET						
FEC	FIRE EXTINGUISHER CABINET						
[ <del>-W-]</del> FHC	FIRE HOSE CABINET						
Ē	FIRE EXTINGUISHER C/W WALL BRACKET						
XPV	POST-INDICATOR VALVE						
<b>-</b>	FIRE HYDRANT C/W SHUT-OFF VALVE						
•	PENDENT SPRINKLER HEAD						
0	UPRIGHT SPRINKLER HEAD						
0	CONCEALED SPRINKLER HEAD						
8	FIRE SUPPRESSION (CLEAN AGENT) SPRINKLER HEAD						
~	SIDEWALL SPRINKLER HEAD						

SFD	COMBINATION SMOKE/FIRE DAMPER (DOUBLE LINE)	
SFD →	COMBINATION SMOKE/FIRE DAMPER (SINGLE LINE)	
BDD	BACK DRAFT DAMPER (DOUBLE LINE)	
BDD →	BACK DRAFT DAMPER (SINGLE LINE)	
BD	BALANCING DAMPER (DOUBLE LINE)	
→ BD	BALANCING DAMPER (SINGLE LINE)	\
	MOTORIZED DAMPER (DOUBLE LINE)	<b>-</b>
<b>\$</b>	MOTORIZED DAMPER (SINGLE LINE)	
600x300	RECTANGULAR DUCTWORK - DIMENSIONS AS SHOWN	
€ 600∅	ROUND DUCTWORK - DIMENSION AS SHOWN	
	DUCTWORK (SINGLE LINE) - DIMENSION AS SHOWN	
	RECTANGULAR SUPPLY/OUTDOOR AIR DUCT UP	ACRONYM AC
	RECTANGULAR EXHAUST/RETURN AIR DUCT UP	ACO AD
2	CIRCULAR SUPPLY/OUTDOOR AIR DUCT UP	AGSS AHU
	CIRCULAR EXHAUST/RETURN AIR DUCT UP	AP AS
	RECTANGULAR SUPPLY/OUTDOOR AIR DUCT DOWN	В
	RECTANGULAR EXHAUST/RETURN AIR DUCT DOWN	BD BDD
	CIRCULAR SUPPLY/OUTDOOR AIR DUCT DOWN	BFP
		СС
	CIRCULAR EXHAUST/RETURN AIR DUCT DOWN	CHWP
(CCC)	MITRED ELBOW WITH TURNING VANES	СР
	DUCT RISE (DOUBLE LINE)	CRAC
<b>├</b>	SUPPLY GRILLE - DIMENSIONS AS SHOWN ON SCHEDULE	CT
<b>├</b>	EXHAUST/RETURN GRILLE - DIMENSIONS AS SHOWN ON SCHEDULE	CUH
	CEILING SUPPLY AIR DIFFUSER - DIMENSIONS AS SHOWN ON SCHEDULE	DA DCWP
	LINEAR SLOT DIFFUSER - DIMENSIONS AS SHOWN ON SCHEDULE	DHWP DHWRP
	CEILING EXHAUST/RETURN GRILLE - DIMENSIONS AS SHOWN ON SCHEDULE	DT EBH
<u> </u>	SUPPLY AIR ROUND DIFFUSER	EF EHC
	BRANCH TAKE-OFF WITH ADJUSTABLE SPLITTER DAMPER IN SUPPLY DUCT (DOUBLE LINE)	EHT ET
Q.E.D.	OPEN ENDED DUCT WITH BALANCING DAMPER AND BELLMOUTH. DIRECTION AS SHOWN (DOUBLE LINE)	EVV FCU
	FLEXIBLE DUCT CONNECTION	FD FD
	ACOUSTICALLY LINED DUCTWORK (DOUBLE LINE)	FDC FE
1+	FLEXIBLE DUCT (DOUBLE LINE)  FLEXIBLE DUCT (SINGLE LINE)	FEC
	FLEXIBLE DUCT CONNECTION WITH BALANCING DAMPER ON TAKE-OFF	FFD FFH FHC
<u> </u>	FIRE RATED DUCTWORK (DOUBLE LINE)	FOP FOT
400x400   400Ø }	DUCT TRANSITION FROM RECTANGULAR TO ROUND	FP FT
	RECTANGULAR DUCT BREAK	GI GLF
<u>γ</u>	ROUND DUCT BREAK	GLP H
SA	SUPPLY AIR	HB HC
	EXHAUST AIR	HEPA HEX
OA	OUTDOOR AIR	HP HRCH
RA		HWP
	RETURN AIR	IAC

VENTILATION

FUSIBLE LINK FIRE DAMPER (DOUBLE LINE)

FUSIBLE LINK FIRE DAMPER (SINGLE LINE)

SMOKE DAMPER (DOUBLE LINE)

SMOKE DAMPER (SINGLE LINE)

DESCRIPTION

SYMBOL

	GENERAL
SYMBOL	DESCRIPTION
	EXISTING TO REMAIN
	EXISTING TO BE DEMOLISHED
R	EXISTING TO BE REMOVED FOR RELOCATION
R	EXISTING RELOCATED IN NEW WORK
	NEW WORK
СТЕ	CONNECT TO EXISTING
<b>&gt;</b>	AIRFLOW / PIPE FLOW DIRECTION
—-э	PIPE TURNING DOWN
<u> </u>	PIPE TURNING UP
₺	PRESSURE REDUCING VALVE
Ф	ROOM THERMOSTAT
Θ	ROOM HUMIDISTAT
	PUMP
ß	CONTROL VALVE - TWO WAY
- 🕏	CONTROL VALVE - THREE WAY
×	ISOLATION VALVE
<b>1</b>	BALANCING VALVE
	CHECK VALVE
Image: Control of the	STRAINER - OVER 50MM WITH VALVED FLUSHING DRAIN
υ	PIPE BRANCH OFF TOP
<b>.</b>	PIPE BRANCH OFF BOTTOM
<b>₹</b> □	RELIEF VALVE
Ø	PRESSURE GAUGE
Ų	TEMPERATURE GAUGE
— CAP	CAP

	— CAP CAP
	ACRONYMS
ACRONYM	DESCRIPTION
AC	AIR CURTAIN
ACO	AIR COMPRESSOR
AD	AREA DRAIN
AGSS	ANAESTHETIC GAS SCAVENGING PUMPS
AHU	AIR HANDLING UNIT
AP	MEDICAL GAS ALARM PANEL
AS	AIR SEPARATOR
В	BOILER (HEATING WATER)
BBH	BASEBOARD HEATER (HOT WATER)
BD	BALANCING DAMPER
BDD	BACKDRAFT DAMPER
BFP BWV	BACKFLOW PREVENTER  BACKWATER VALVE
CC	COOLING COIL
CH CH	CHILLER
CHWP	CHILLED WATER PUMP
CO	CLEAN-OUT
CP	CONDENSATE PUMP
CRAC	COMPUTER ROOM AIR-CONDITIONING UNIT
CRU	STEAM CONDENSATE RECIEVER UNIT
CT	COOLING TOWER
CU	CONDENSING UNIT
CUH	CABINET UNIT HEATER
CWP	CONDENSER WATER PUMP
DA	DEAERATOR
DCWP	DOMESTIC COLD WATER PUMP
DHWP	DOMESTIC HOT WATER PUMP
DHWRP	DOMESTIC HOT WATER RECIRC PUMP
DT	DAY TANK
EBH	BASEBOARD HEATER (ELECTRIC)
EF	EXHAUST FAN
EHC	ELECTRIC HEATING COIL
EHT	ELECTRIC HEAT TRACING
ET	EXPANSION TANK
EVV	EXHAUST VENTURI VALVE
FCU	EXISTING TO REMAIN
FD	FLOOR DRAIN (APPLIES TO PLUMBING DRAWINGS)
FD	FIRE DAMPER (APPLIES TO VENTILATION DRAWINGS)
FDC	FIRE DEPARTMENT CONNECTION
FE	FIRE EXTINGUISHER
FEC	FIRE EXTINGUISHER CABINET
FFD	FUNNEL FLOOR DRAIN
FFH	FORCED FLOW HEATER (ELECTRIC)
FHC	FIRE HOSE CABINET
FOP	FUEL OIL PUMP
FOT	FUEL OIL TANK
FP FT	FIRE PUMP  FLASH TANK
GI	GREASE INTERCEPTOR
GLF	GLYCOL FILL STATION
GLP	GLYCOL HOT WATER PUMP
H	HUMIDIFIER
HB	HOSE BIBB
HC	HEATING COIL
HEPA	HIGH EFFICIENCY PARTICULATE AIR FILTER
HEX	HEAT EXCHANGER (PLATE AND FRAME)
HP	HEAT PUMP
HRCH	HEAT RECOVERY CHILLER
HWP	HOT WATER PUMP
	DOMESTIC HOT WATER TANK
HWT	DOMESTIC HOT WATER TANK

	ACRONYMS
ACRONYM	DESCRIPTION
JP	JOCKEY PUMP
LAC	LAB AIR COMPRESSOR
LDU	LOCAL DISPLAY UNIT
MAC	MEDICAL AIR COMPRESSOR
MAU	MAKE-UP AIR UNIT
MD	MOTORIZED DAMPER
PHC	PREHEAT COIL
PRV	PRESSURE REDUCING VALVE
RF	RETURN FAN
RHC	RE-HEAT COIL
RTU	ROOFTOP UNIT
SF	SUPPLY FAN
SFD	COMBINATION SMOKE/FIRE DAMPER
ST	STARTER

DRAWING #	DRAWING NAME
M-001	Mechanical Legend & Sheet List
M-101	Mechanical Level 1 Demolition Plan - Plumbing
M-151	Mechanical Level 1 New Construction Plan - Plumbing
M-201	Mechanical Level 1 Demolition Plan - HVAC
M-202	Mechanical Level 2 Demolition Plan - HVAC
M-251	Mechanical Level 1 New Construction Plan - HVAC
M-252	Mechanical Level 2 New Construction Plan - HVAC
M-253	Mechanical Roof New Construction Plan - HVAC & Plumbing
M-301	Mechanical Detail Sheet No. 1
M-302	Mechanical Detail Sheet No. 2
M-303	Mechanical Detail Sheet No. 3
M-304	Exhaust Hood Details
M-305	Exhaust Hood Details & Wiring Diagrams
M-306	Mechanical Control Sequences
M-307	Mechanical Control Sequences
M-308	Mechanical Equipment Schedules
M-309	Kitchen Equipment Schedules


- THE MECHANICAL CONTRACTOR SHALL VISIT THE SITE TO VERIFY EXISTING CONDITIONS PRIOR TO SUBMITTING BID. THIS SHALL BE DONE IN ORDER TO CONFIRM THAT EQUIPMENT AND SERVICES CAN BE INSTALLED AS SHOWN ON DRAWINGS AND THAT ADDITIONAL COSTS ARE INCLUDED IN BID TO FACILITATE INSTALLATION. IT IS THE CONTRACTORS RESPONSIBILITY TO NOTIFY THE ENGINEERS OF ANY DISCREPANCIES, OMISSIONS, AND INTERFERENCES. CONTRACTOR SHALL PROVIDE INTERFERENCE DRAWINGS TO CONSULTANT FOR REVIEW AND DIRECTION. CONTRACTOR SHALL VERIFY ALL CONNECTIONS, PIPE SIZES AND LOCATION OF EXISTING SERVICES AT POINTS OF CONNECTIONS ON SITE AND REPORT ANY DISCREPANCY TO THE CONSULTANT PRIOR TO FABRICATION &/OR INSTALLATION OF NEW SERVICES.
- ENSURE THAT ALL NEW AND EXISTING MECHANICAL EQUIPMENT REQUIRING MAINTENANCE IS ACCESSIBLE AND THAT ACCESS REQUIREMENTS ARE NOT OBSTRUCTED BY NEW OR EXISTING SERVICES AND STRUCTURE. COORDINATE WITH PROJECT MANAGER AND ALL OTHER TRADES. INSTALL MECHANICAL EQUIPMENT IN SUCH A WAY AS TO PROVIDE ALL ACCESS REQUIREMENTS. REFER TO SHOP DRAWINGS AND/OR MANUFACTURER'S RECOMMENDATIONS FOR ACCESS REQUIREMENTS. REPORT ANY OBSTRUCTIONS TO THE PROJECT MANAGER AND MECHANICAL ENGINEER. PROVIDE ACCESS DOORS/PANELS WITH MINIMUM DIMENSIONS AS NOTED BELOW (UNLESS INDICATED OTHERWISE ON DRAWINGS):
  - 24 INCHES BY 24 INCHES FOR PERSONNEL ENTRY. 18 INCHES BY 18 INCHES FOR HAND ENTRY.


FOR THIS SCOPE OF WORK.

- 12 INCHES BY 12 INCHES FOR VIEWING ONLY. SIZE DOORS TO ALLOW ADEQUATE OPERATING/MAINTENANCE CLEARANCE FOR DEVICES.
- ACCESS DOORS SHALL BE, WHEREVER POSSIBLE, OF A STANDARD SIZE FOR EACH APPLICATION. PROVIDE ALL REQUIRED CUTTING AND PATCHING OF EXISTING CEILINGS AND WALLS TO FACILITATE DEMOLITION AND THE INSTALLATION OF THE MECHANICAL SERVICES OUTLINED
- WELDING TO BE PERFORMED WITH STRINGENT ENVIRONMENTAL CONDITIONS FOR SMOKE AND FUME EVACUATION.
- SUPPLY AND INSTALL OF SMOKE DETECTORS TO BE COMPLETE WITH TIE-INS TO FIRE ALARM PANEL.
- THE MECHANICAL DRAWINGS ARE PERFORMANCE DRAWINGS, DIAGRAMMATIC, AND SHOW APPROXIMATE LOCATIONS OF EQUIPMENT AND CONNECTING SERVICES. ANY INFORMATION REGARDING ACCURATE MEASUREMENT OF THE BUILDING ARE TO BE TAKEN AT THE SITE. DO NOT SCALE THE DRAWINGS, AND DO NOT USE THE DRAWINGS FOR PREFABRICATION
- FOR CLARITY, NOT ALL EXISTING EQUIPMENT, DUCTWORK, PIPING, ETC. HAS BEEN SHOWN ON THE DRAWINGS. THE EXISTING EQUIPMENT, PIPES, DUCTS AND SERVICES ARE SHOWN FOR REFERENCE ONLY. EXACT LOCATIONS, SIZES AND DIMENSIONS SHALL BE DETERMINED ON SITE. WHERE INTERFERENCES EXIST, CONTRACTOR SHALL REPOUTE THE NEW WORK TO SUIT THE EXISTING PIPING.
- NOT ALL CONNECTIONS TO EQUIPMENT ARE SHOWN. REFER TO THE MANUFACTURERS LITERATURE FOR ALL PIPING CONNECTIONS.
- CONTRACTOR IS TO BE RESPONSIBLE FOR THE REMOVAL AND DISPOSAL OF ALL DUCTWORK AND EQUIPMENT AS SHOWN ON THE DEMOLITION PLAN.
- COORDINATE ALL TEMPORARY SHUT DOWNS WITH THE CLIENT (SCHOOL BOARD) THE DATE AND PERIOD OF THE TIME REQUIRED FOR DISCONNECTING AND MAKING NEW CONNECTIONS TO PIPING, DUCTING, AND ALL RELATED MECHANICAL WORK IN ORDER TO KEEP THE INTERRUPTIONS OF THE SCHOOL DAILY OPERATIONS AS MINIMAL AS POSSIBLE. INCLUDE FOR FREEZING WHERE REQUIRED.
- SURVEY ALL AFFILIATED WORK AREAS AND REPORT ABNORMALITIES AND DISCREPANCIES TO CONSULTANT.
- WHERE CEILING, FLOOR, WALL OR ROOF OPENINGS ARE REQUIRED TO RUN MECHANICAL AND ELECTRICAL SERVICES, INCLUDE ALL COSTS FOR REINSTATING THE CEILING. FLOOR, WALL, OR ROOF. SEAL ALL OPENINGS WITH APPROVED FIRE-STOPPING MATERIALS AS REQUIRED. REFER TO SPECIFICATIONS FOR ADDITIONAL REQUIREMENTS.
- IF ASBESTOS CONTAINING MATERIAL IS SUSPECTED OR IDENTIFIED IN THE WORK AREA AND REQUIRED TO BE HANDLED AS PART OF THE DEMOLITION PHASE OF THE PROJECT, CONTRACTOR SHALL HALT WORK AND INFORM CONSULTANT OF SUCH CONDITIONS. CONTRACTOR SHALL NOT PROCEED WITH DEMOLITION OF SUCH AREAS WITHOUT AUTHORIZATION BY CONSULTANT. REMOVAL OF SUCH MATERIALS TO ACCOMMODATE THE WORK DESCRIBED AND OUTLINED IN THESE DRAWINGS SHALL BE ARRANGED THROUGH THE OWNER. ASBESTOS ABATEMENT, IF ANY, IS EXCLUDED FROM THIS CONTRACT AND WILL BE HANDLED SEPARATELY BY OWNER.
- ALL ABANDONED OR OBSOLETE MECHANICAL SERVICES SUCH AS VALVES, PIPING, EQUIPMENT, INSTRUMENTATION, ETC. SHALL BE REMOVED WITHIN THE WORK AREA TO FACILITATE
- INSULATE ALL NEW DUCTWORK AND AND ANY EXISTING DUCTWORK WHERE INSULATION HAS BEEN REMOVED OR DAMAGED BY THIS WORK . REFER TO SPECIFICATIONS FOR
- CONTRACTOR TO PROVIDE WATER BALANCING PRE-TESTS. CONTRACTOR TO PROVIDE CUTTING & PATCHING FOR THE INSTALLATION OF HIS WORK. EMPLOY THE SERVICES OF THE
- CO-ORDINATE NEW SERVICES WITH EXISTING BUILDING STRUCTURE, EXISTING SERVICES & WORK.
- ANY SERVICES THAT ARE NOT SHOWN ON THE DRAWINGS AND ARE EXPOSED DURING DEMOLITION/CONSTRUCTION SHALL BE VERIFIED BY THE CONTRACTOR AND REPORTED TO THE
- CONTRACTOR SHALL COORDINATE WITH ALL NEW AND EXISTING MECHANICAL AND ELECTRICAL SERVICES WHEN MAKING THE PIPE AND, DUCTING, AND EQUIPMENT CONNECTIONS ON
- CONTRACTOR TO PROVIDE TEMPORARY HEATING/COOLING AND VENTILATION FOR AREAS AFFECTED BY TEMPORARY SHUT-DOWN.
- DO NOT INTERRUPT EXISTING MECHANICAL SERVICES OCCUPIED OR ADJACENT AREAS OUTSIDE THE SCOPE UNLESS APPROVED BY THE OWNER.
- ALL DEMOLITION WORK SHALL BE PERFORMED WITH DUE CARE AND DILIGENCE, SO AS TO PREVENT THE UNNECESSARY DESTRUCTION AND/OR DAMAGE TO SYSTEMS THAT SHALL REMAIN IN OPERATION DURING THE CONSTRUCTION PHASE OFTHIS WORK.
- THE CONTRACTOR IS TO VERIFY LOCATIONS OF ALL EXISTING UTILITIES PRIOR TO CONSTRUCTION.
- THE CONTRACTOR SHALL BE FULLY RESPONSIBLE FOR ANY DAMAGES THAT MIGHT OCCUR TO THE MECHANICAL SYSTEMS DURING CONSTRUCTION. CONTRACTOR SHALL PROTECT ANY AND ALL PORTIONS OF THE EXISTING MECHANICAL SYSTEMS.
- CONTRACTOR TO PROVIDE MINIMUM 7-10 WORKING DAYS NOTICE TO THE CLIENT (SCHOOL BOARD) FOR ANY SHUTDOWN REQUIRED.
- THE CONTRACTOR SHALL TAKE ALL NECESSARY PRECAUTIONS TO PREVENT DAMAGE TO OWNER'S OCCUPIED AREAS ADJACENT TO THE NEW CONSTRUCTION.
- CONTRACTOR TO PAY FOR AND OBTAIN ALL REQUIRED PERMITS .FEES, LICENSES CERTIFICATES OF INSPECTION, ETC. IF REQUIRED.
- SPECIFICATIONS FOR FIRE & SMOKE RATED SEALANTS. CONTRACTOR TO PROVIDE APPARATUS WITH PROPER NAMEPLATES AFFIXED THERE TO , SHOWING THE SIZE, NAME OF THE EQUIPMENT, SERIAL NUMBER AND ALL INFORMATION
- USUALLY PROVIDED, WHICH ALSO INCLUDES VOLTAGE, CYCLE, PHASE AND HORSEPOWER OF MOTORS AND THE NAME AND ADDRESS OF THE MANUFACTURER.

CONTRACTOR SHALL BE RESPONSIBLE FOR PROPERLY SEALING PENETRATIONS THROUGH FIRE RATED, SMOKE RATED OR COMBINATION FIR & SMOKE RATED SEPARATIONS. SEE

- CONTRACTOR TO STOP INSULATION FLUSH WITH ALL WALL AND FLOOR SURFACES AND SEAL SPACE BETWEEN PIPE, DUCT, AND SLEEVE WITH ULC APPROVED AND LISTED FIRE STOPPING MATERIAL AS REQUIRED.
- COORDINATE MECHANICAL WORK WITH WORK OF ALL OTHER DIVISIONS.
- ALL CRANING WORK TO BE COORDINATED WITH OWNER, AND SCHEDULED. ALLOW FOR WEEKEND WORK.
- CONTRACTOR SHALL PROVIDE AS-BUILT DRAWINGS WITHIN 2 WEEKS AFTER COMMISSIONING IS COMPLETED.
- CONTRACTOR SHALL RETURN ALL REMOVED EQUIPMENT TO THE OWNER OR DISPOSE THE DEMOLISHED EQUIPMENT WHICH IS SUBJECT TO THE OWNER APPROVAL.
- DEMOLITION DRAWINGS INDICATE VISIBLE/KNOWN DEVICES AND/OR SERVICES ONLY. CONTRACTOR SHALL BE RESPONSIBLE FOR DETAILED SITE SURVEY PRIOR TO SUBMITTING THE BID AND SHALL INCLUDE FOR ALL COSTS ASSOCIATED WITH DEMOLITION SCOPE OF WORK IN THE BID PRICE. MANDATORY SITE WALKTHROUGHS SHALL BE ARRANGED BY THE OWNER AND CONSULTANT TO ALLOW CONTRACTORS TO INVESTIGATE AND RECORD EXISTING CONDITIONS PRIOR TO SUBMITTING THE BID.
- MECHANICAL CONTRACTOR SHALL BE RESPONSIBLE FOR REINSTALLATION AND RECONNECTION OF ALL SUCH SERVICES TO MATCH EXISTING STANDARDS. CONTRACTOR SHALL INCLUDE ALL COSTS FOR SITE INVESTIGATION TO SOURCE DELETE SERVICES REQUIRED FOR RE-CONNECTION OF EXISTING SERVICES THAT MUST REMAIN. INCLUDE IN YOUR BID ALL COSTS ASSOCIATED WITH SITE INVESTIGATION, ETC, AND ALL REQUIRED COSTS FOR THIS WORK. REVIEW AND NOTE EXISTING CONDITIONS AND CONFIRM EXACT SITE CONDITIONS.
- COSTS TO PERFORM WATER BALANCING TO BE INCLUDED IN THE PRICE FOR THE WORK OF MECHANICAL DIVISION.
- COSTS TO PERFORM DUCT CLEANING OF THE WHOLE BUILDING, TESTING AND BALANCING OF THE HVAC SYSTEM TO BE INCLUDED IN THE PRICE FOR THE WORK OF MECHANICAL
- CONTRACTOR TO CARRY OUT PRE-CONSTRUCTION AND POST-CONSTRUCTION AIR AUDIT.
- CONTRACTOR TO REPAIR BEAMS FIRE RATING SAME WITH PREVIOUS FIRE RATING WHERE SECURING SUPPORTS TO THE EXISTING FIRE RATED BEAMS

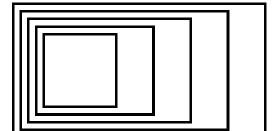

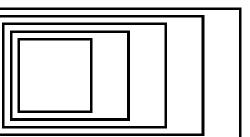

#### **GOW HASTINGS ARCHITECTS**

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DATE

REVIEW

ISSUED/REVISED

Henry St H.S. Culinary Classroom

600 Henry St, Whitby, ON L1N 1L4

Mechanical Legend &

Renovation


**Sheet List** 

Scale: 1:1


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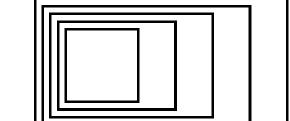
Chirag Khatri Checked By: A. Nakhaei-Zadeh

Project Number: ED-25-052



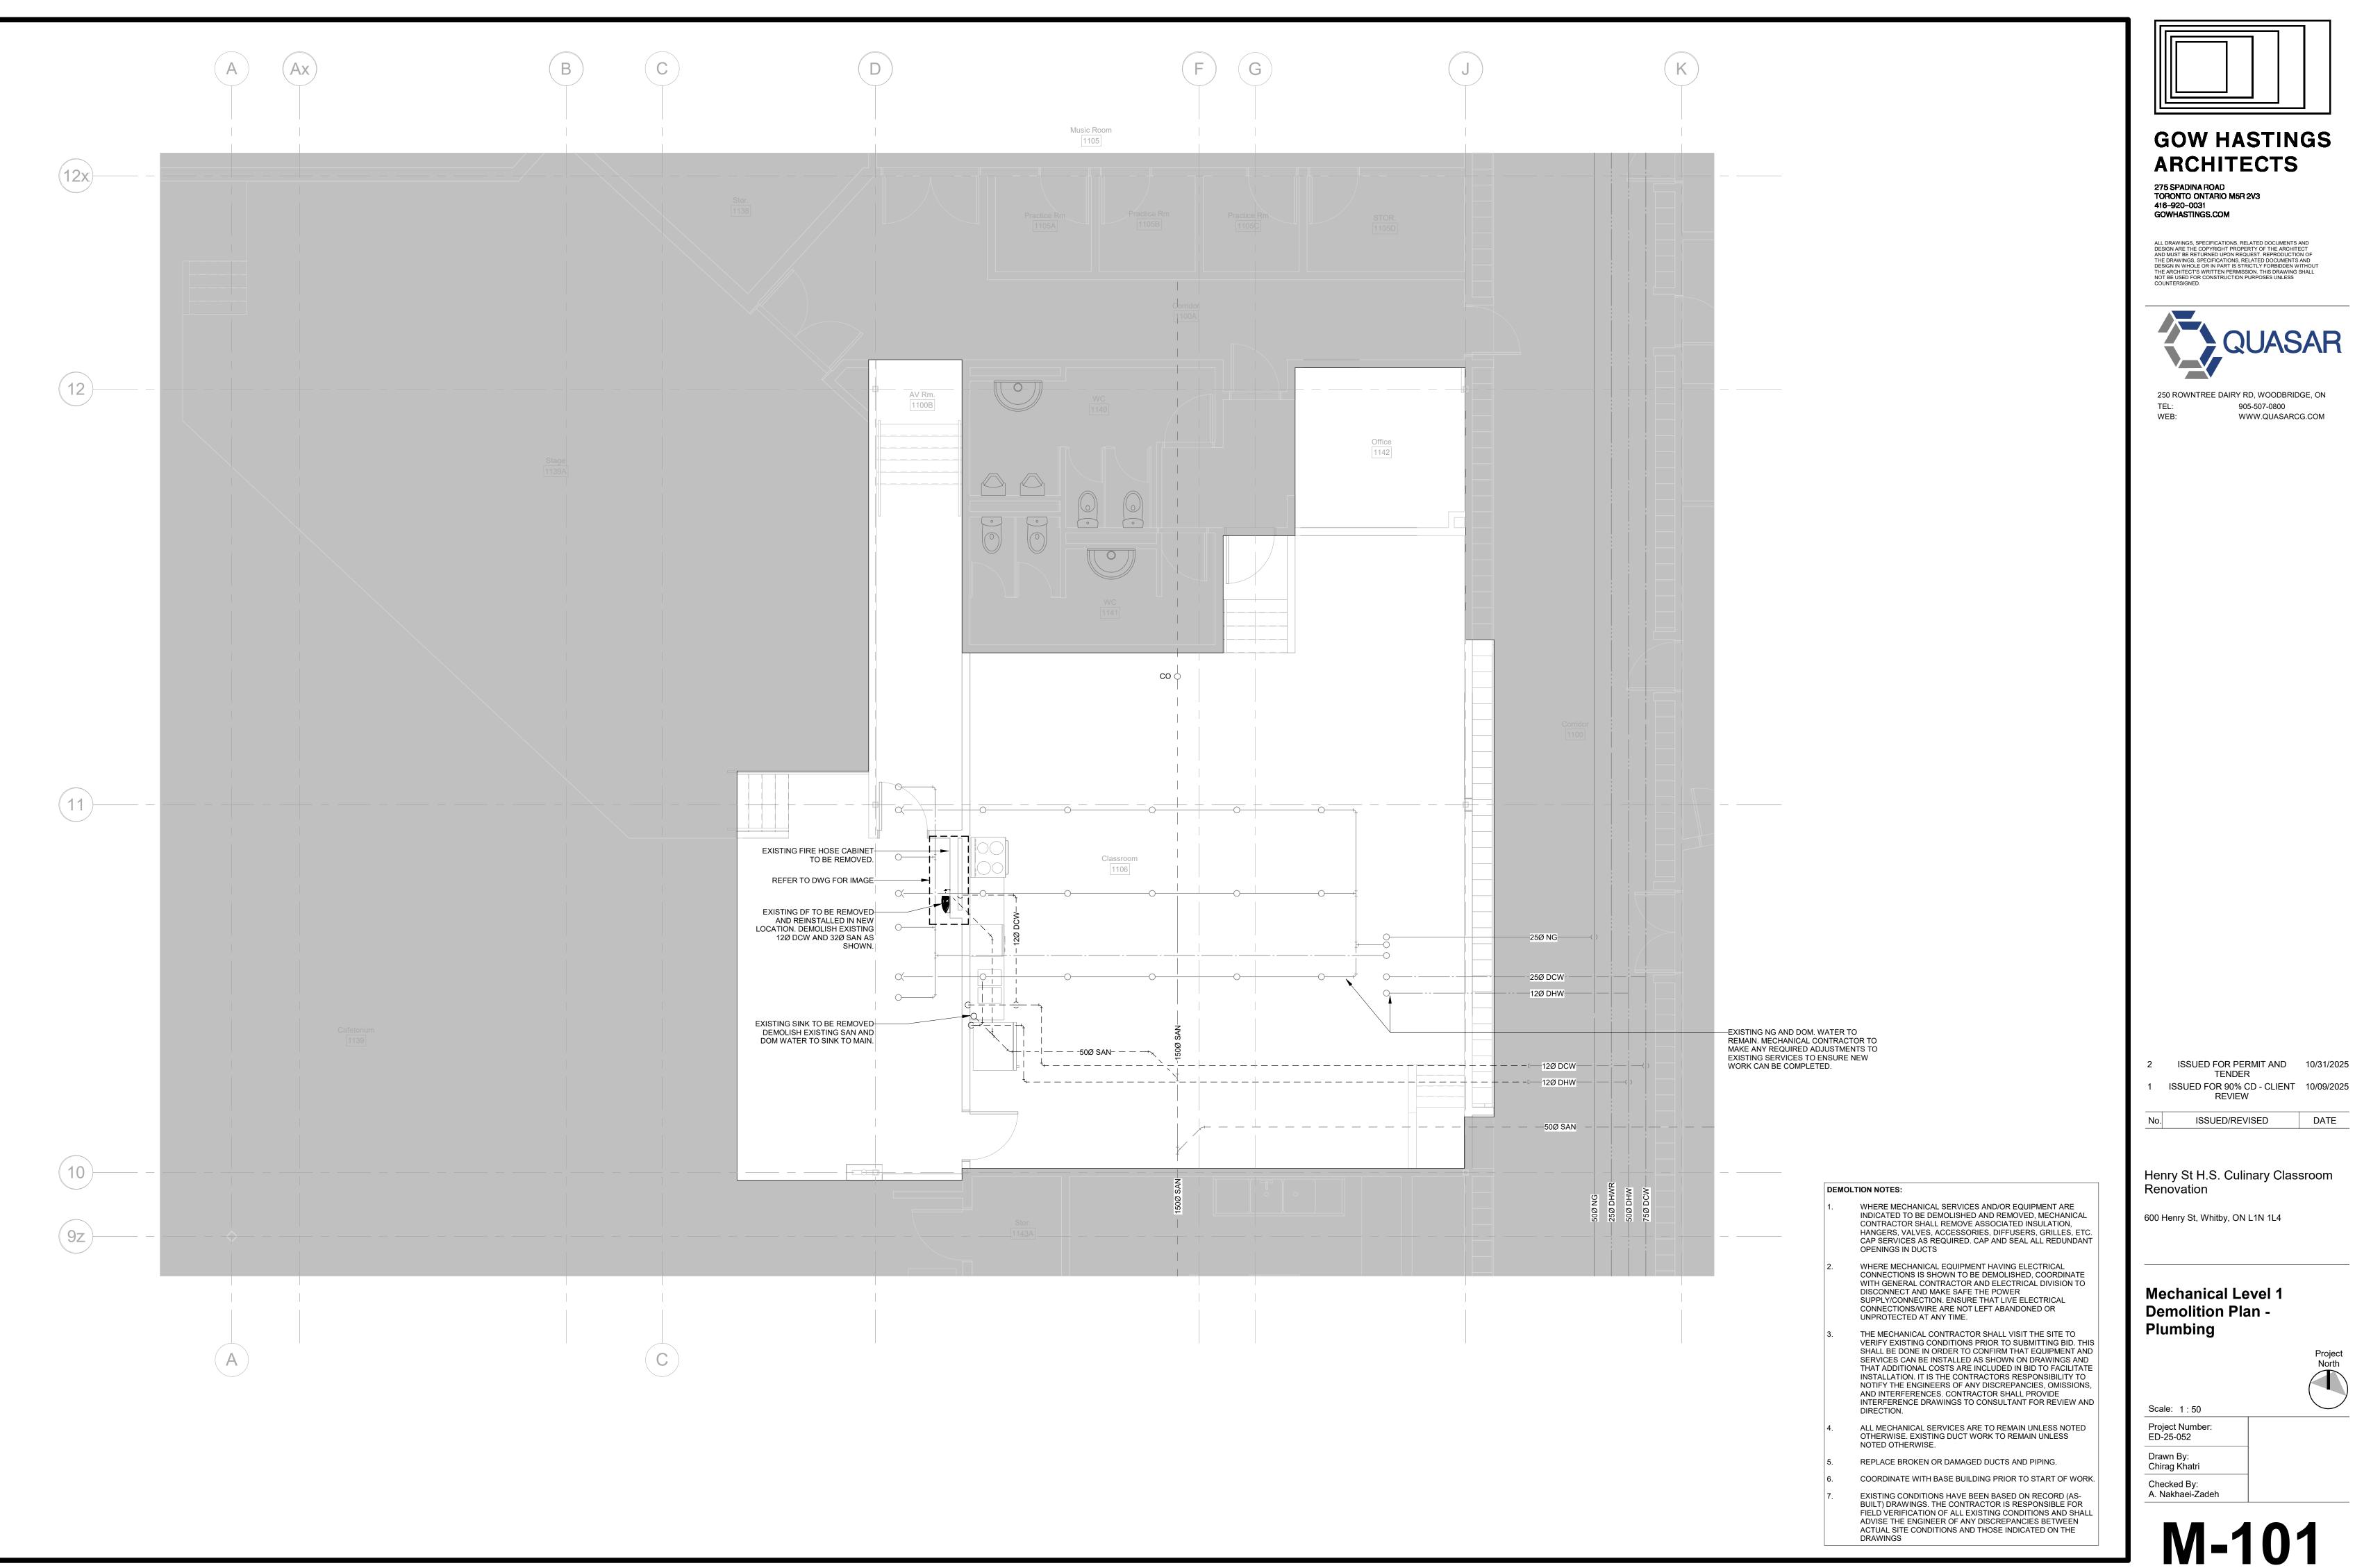



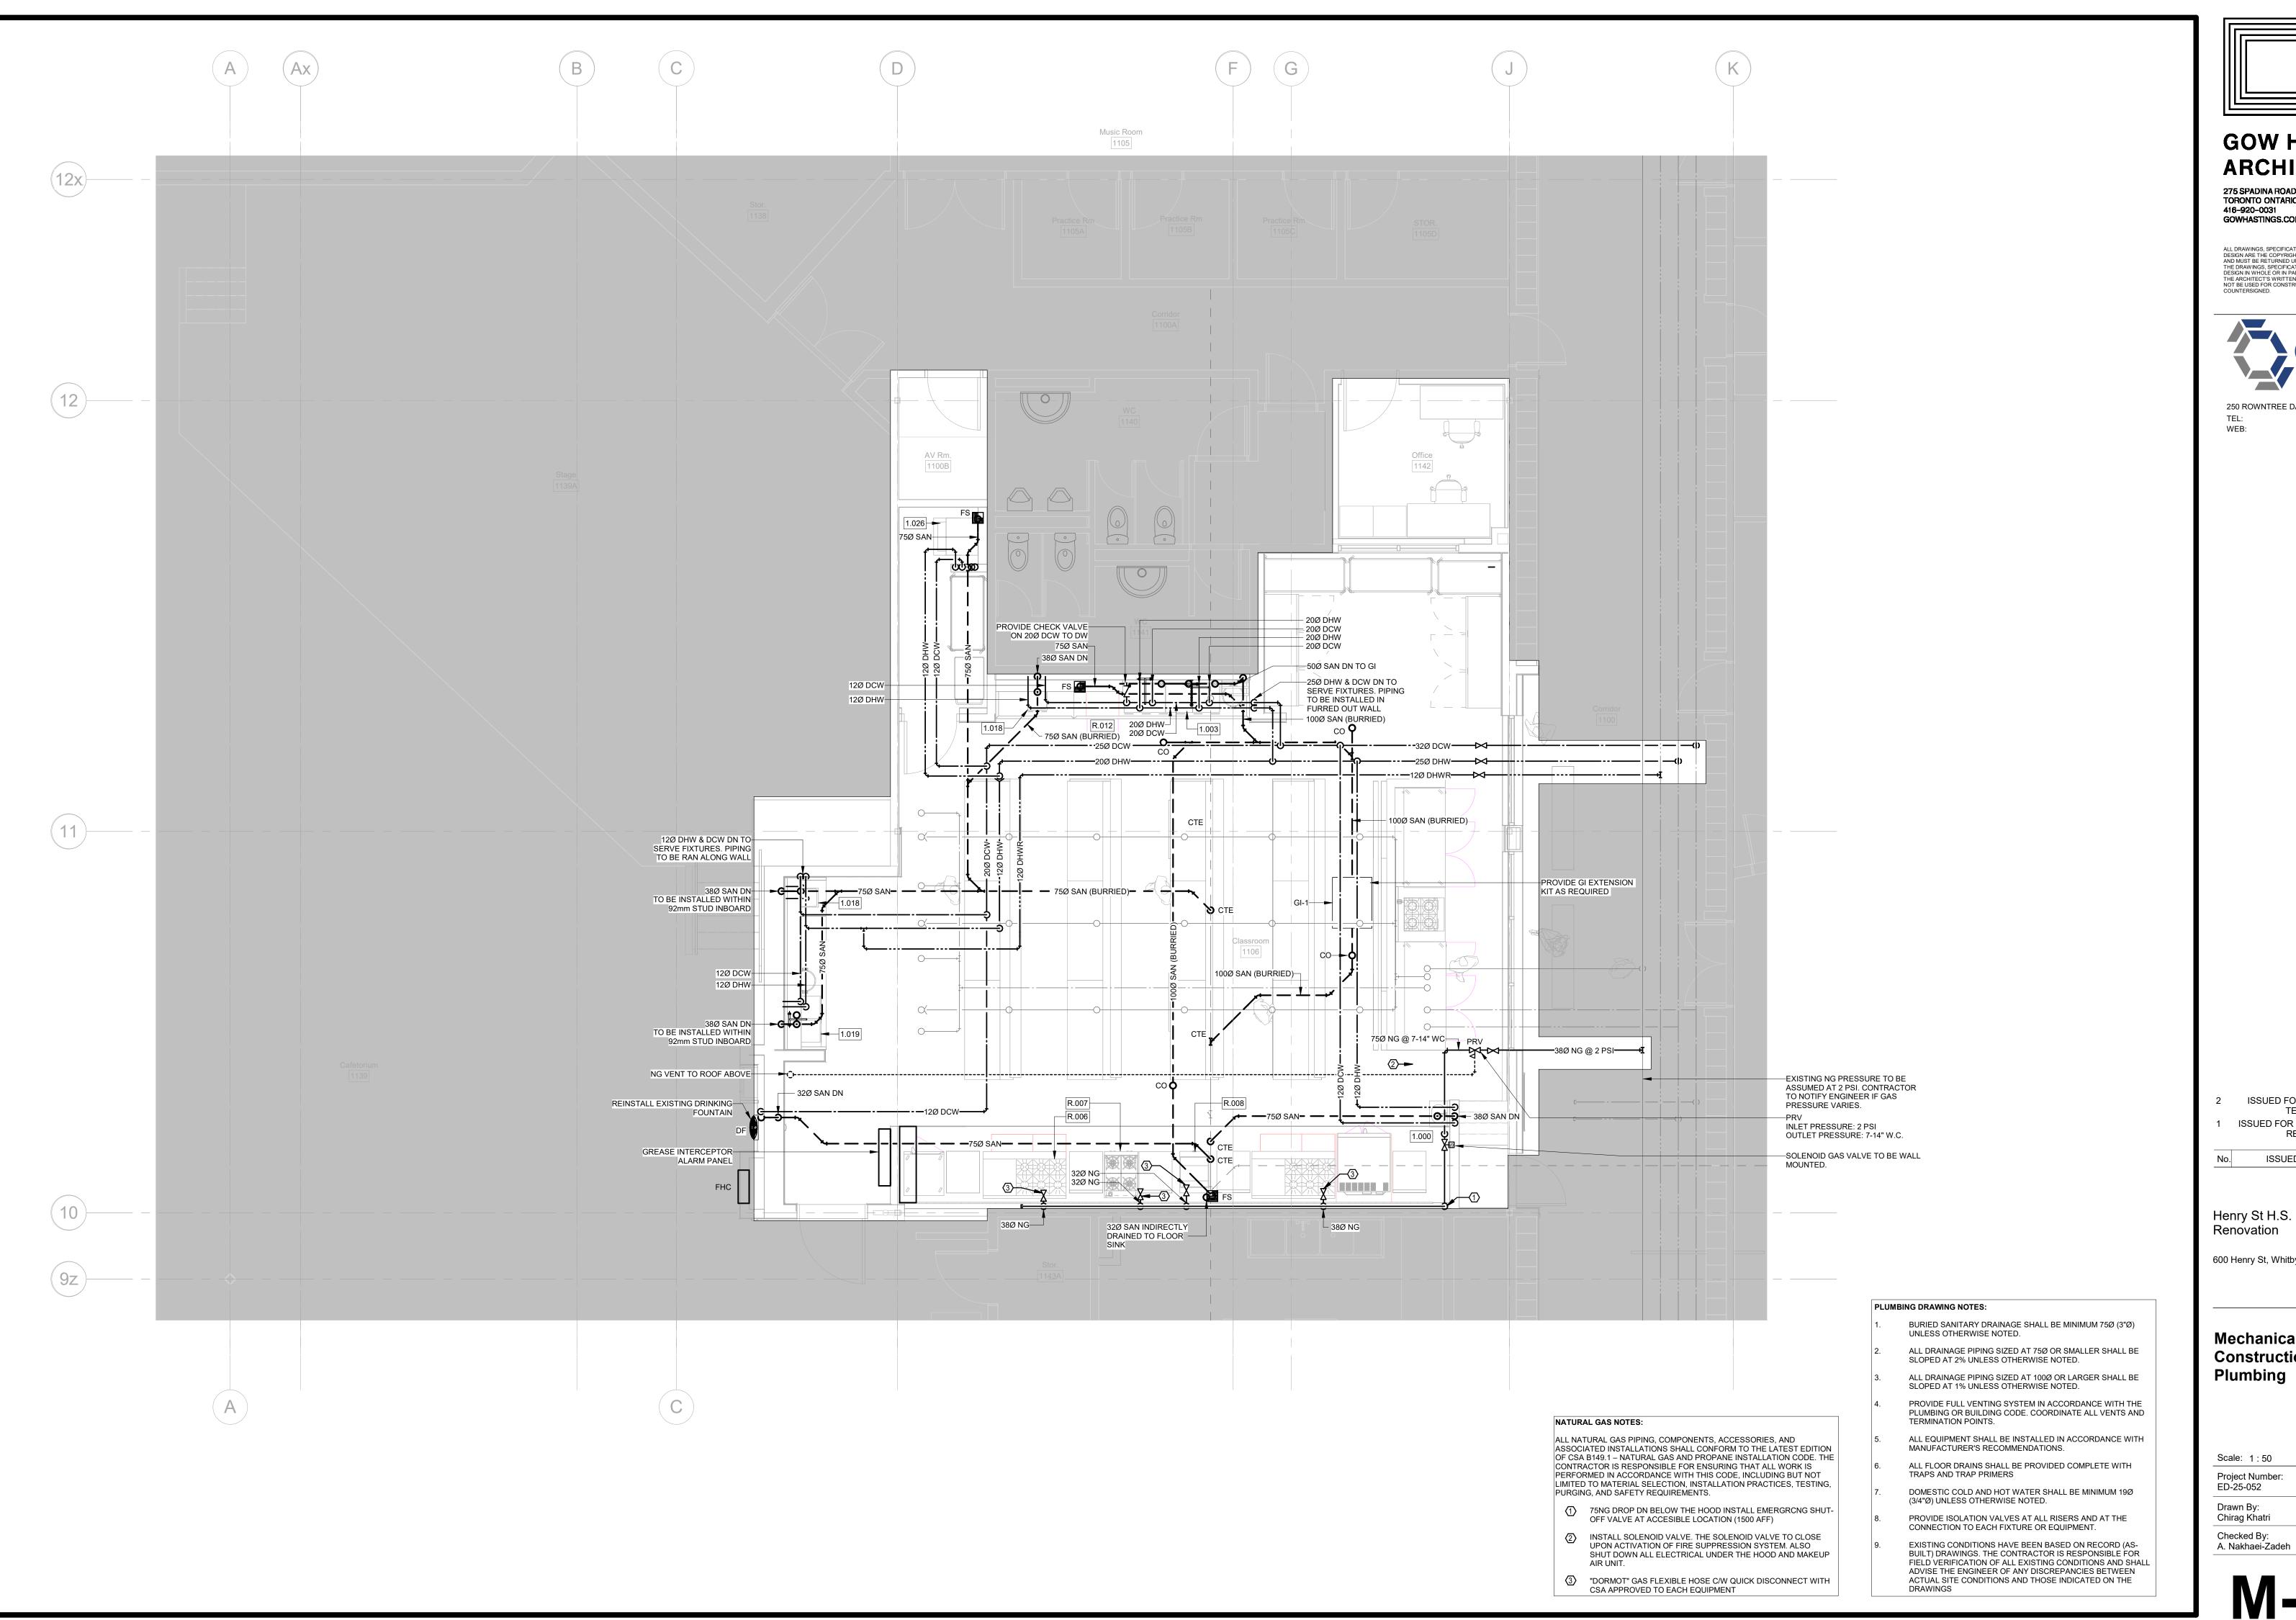

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Henry St H.S. Culinary Classroom

ISSUED/REVISED


600 Henry St, Whitby, ON L1N 1L4


Mechanical Level 1 New **Construction Plan -Plumbing** 

Project North

Scale: 1:50

Project Number: ED-25-052 Drawn By: Chirag Khatri

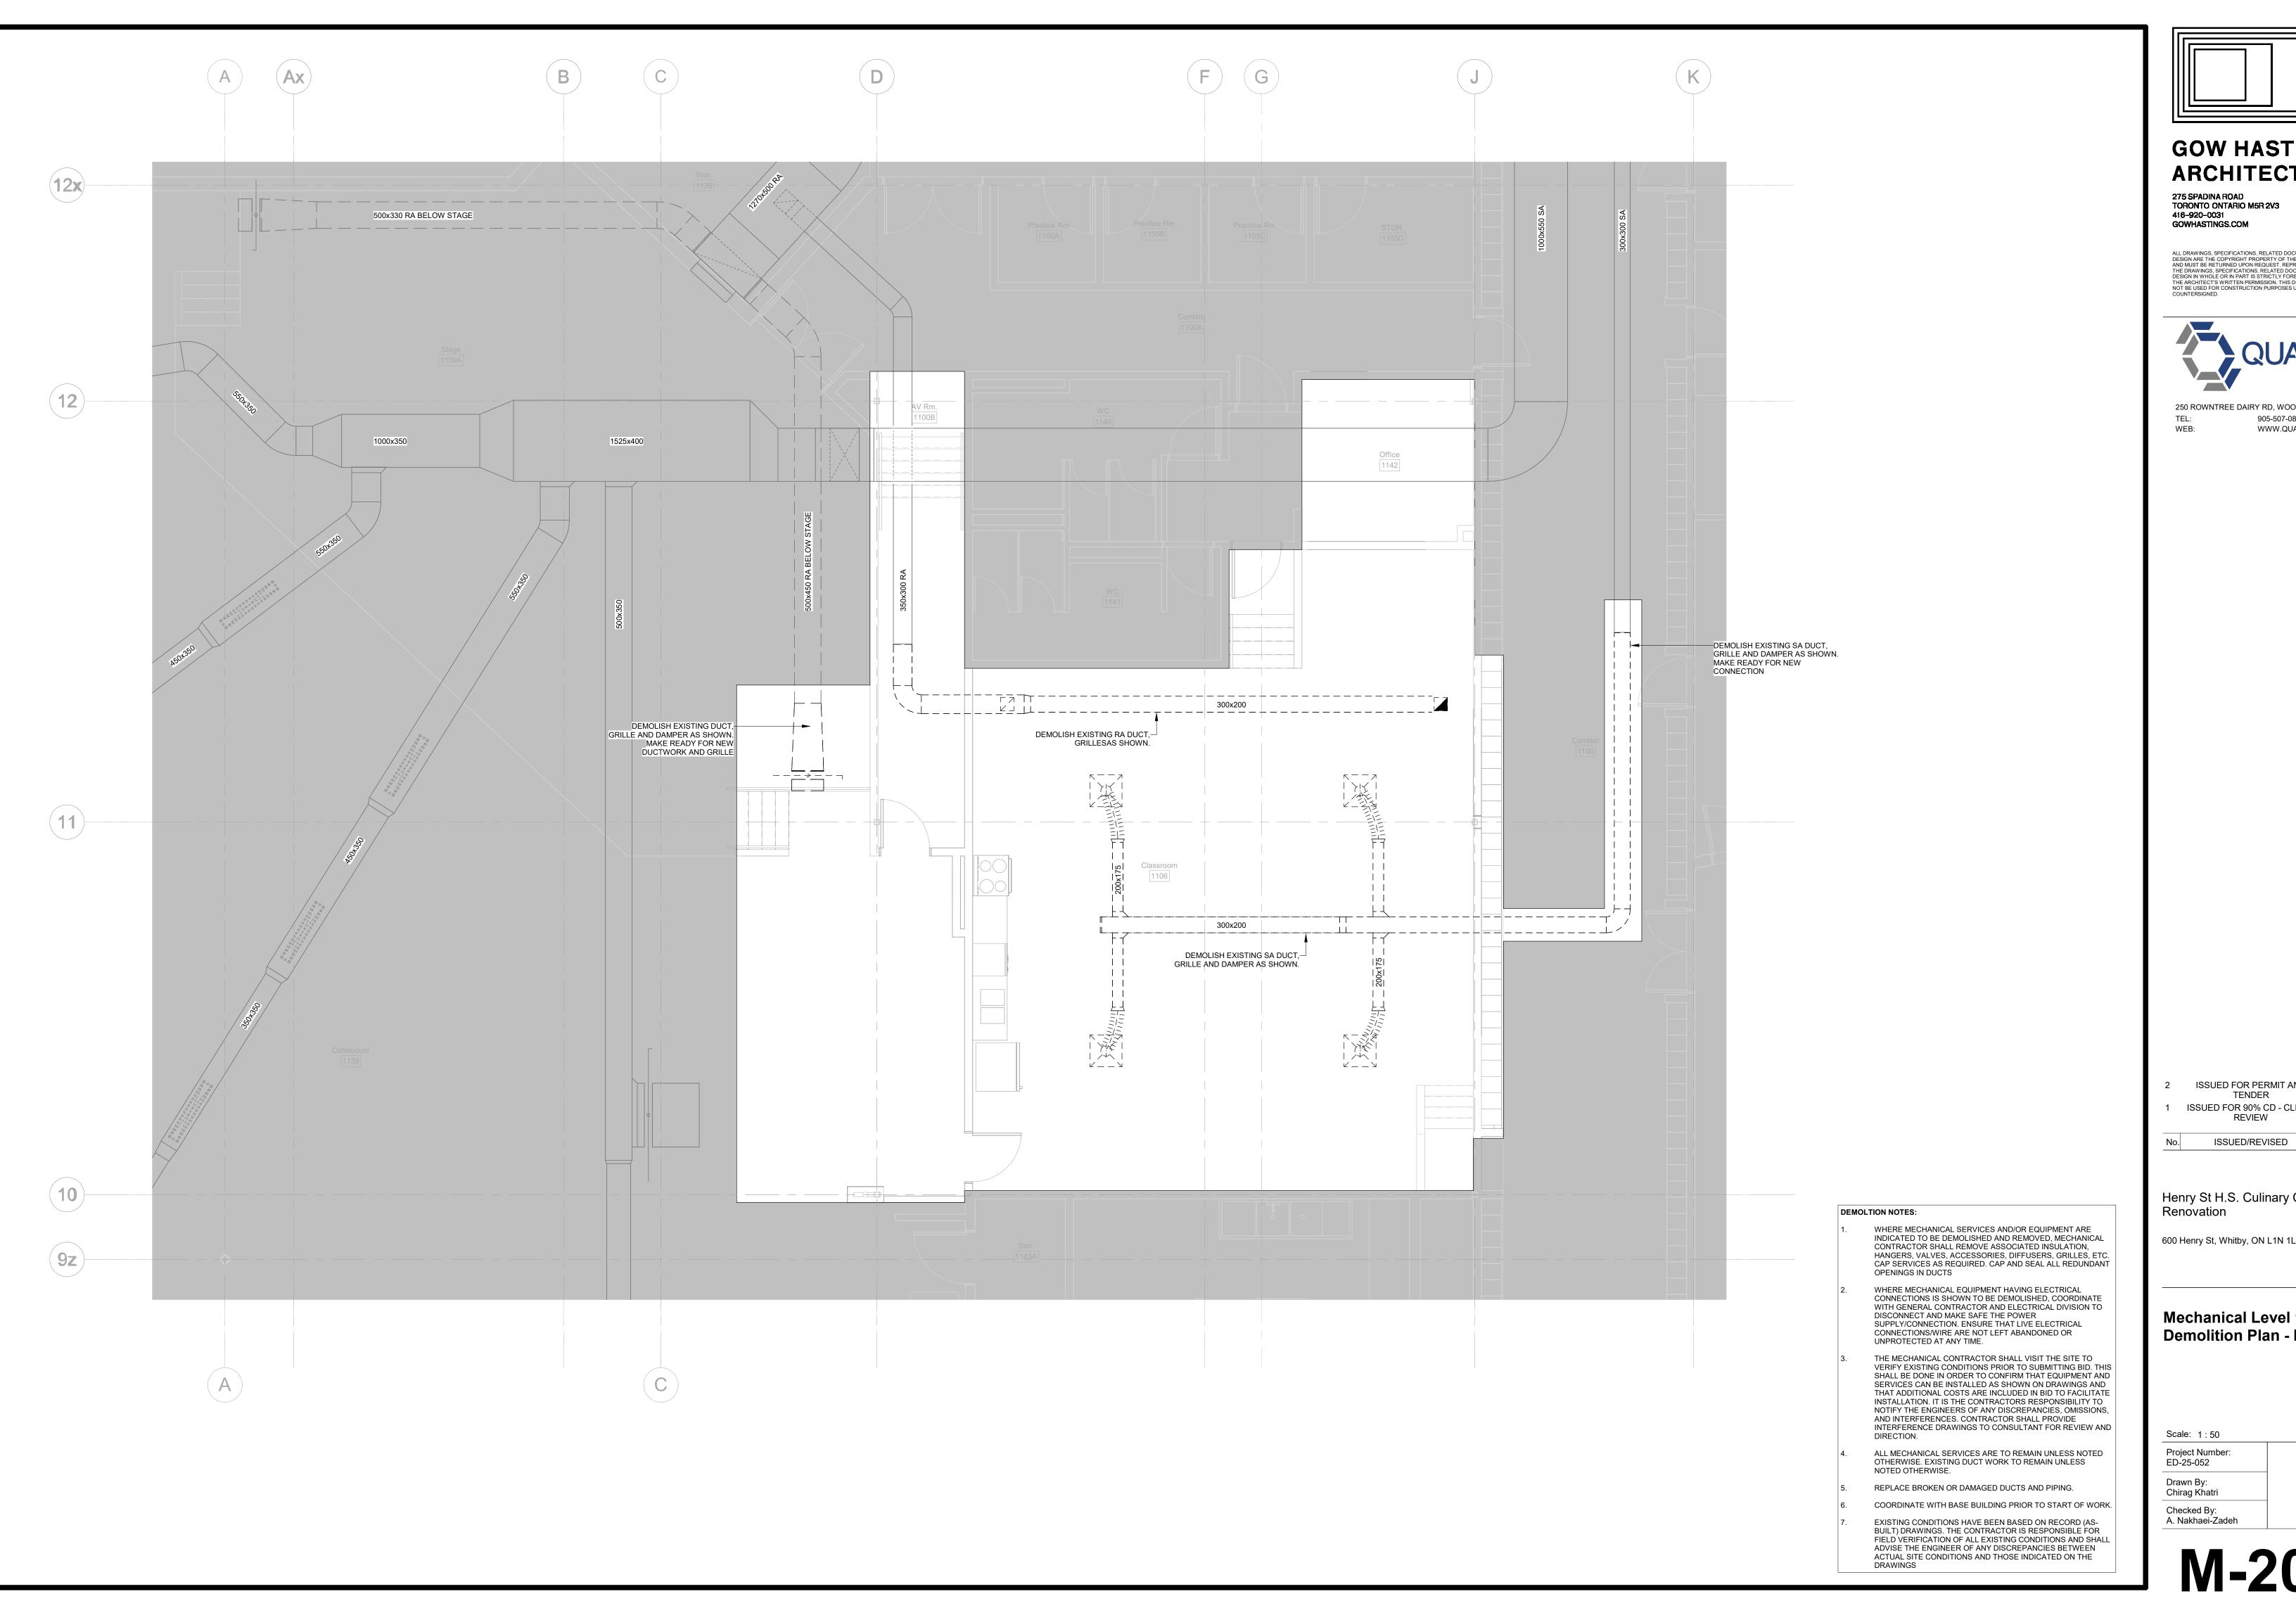

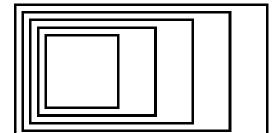

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Henry St H.S. Culinary Classroom Renovation


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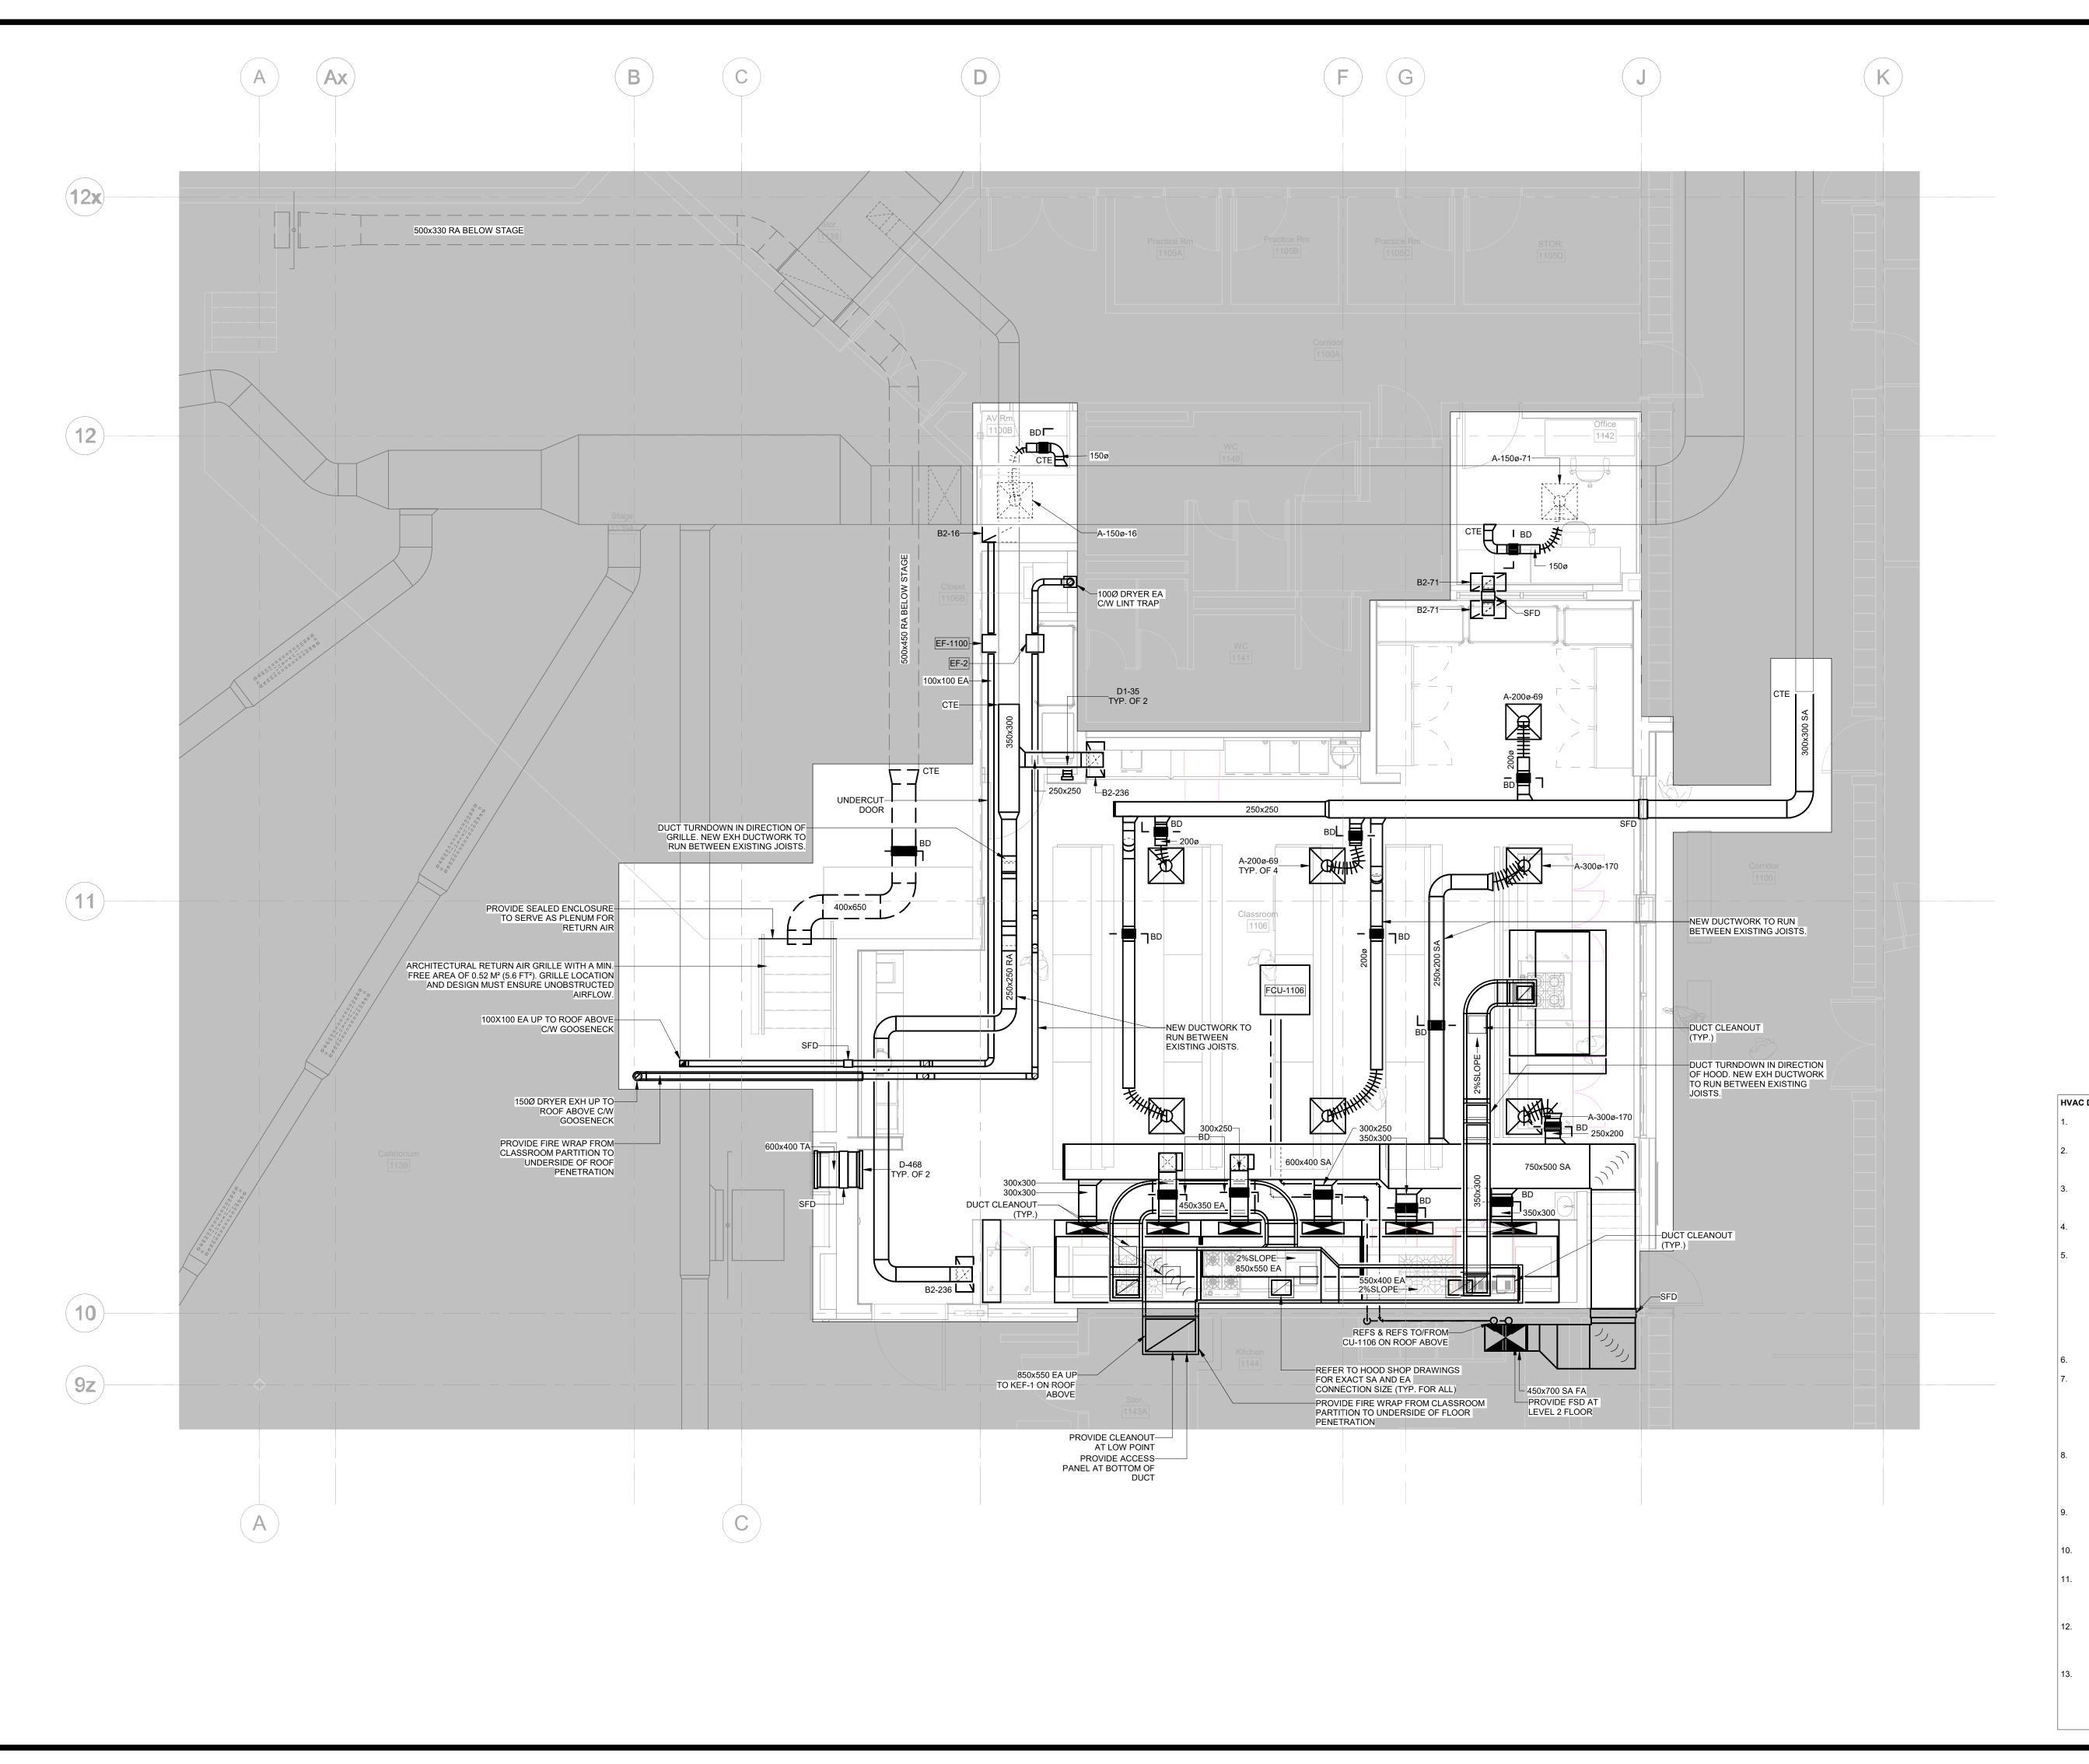
**Mechanical Level 1 Demolition Plan - HVAC** 


DATE

Scale: 1:50

Project Number: ED-25-052 Drawn By: Chirag Khatri



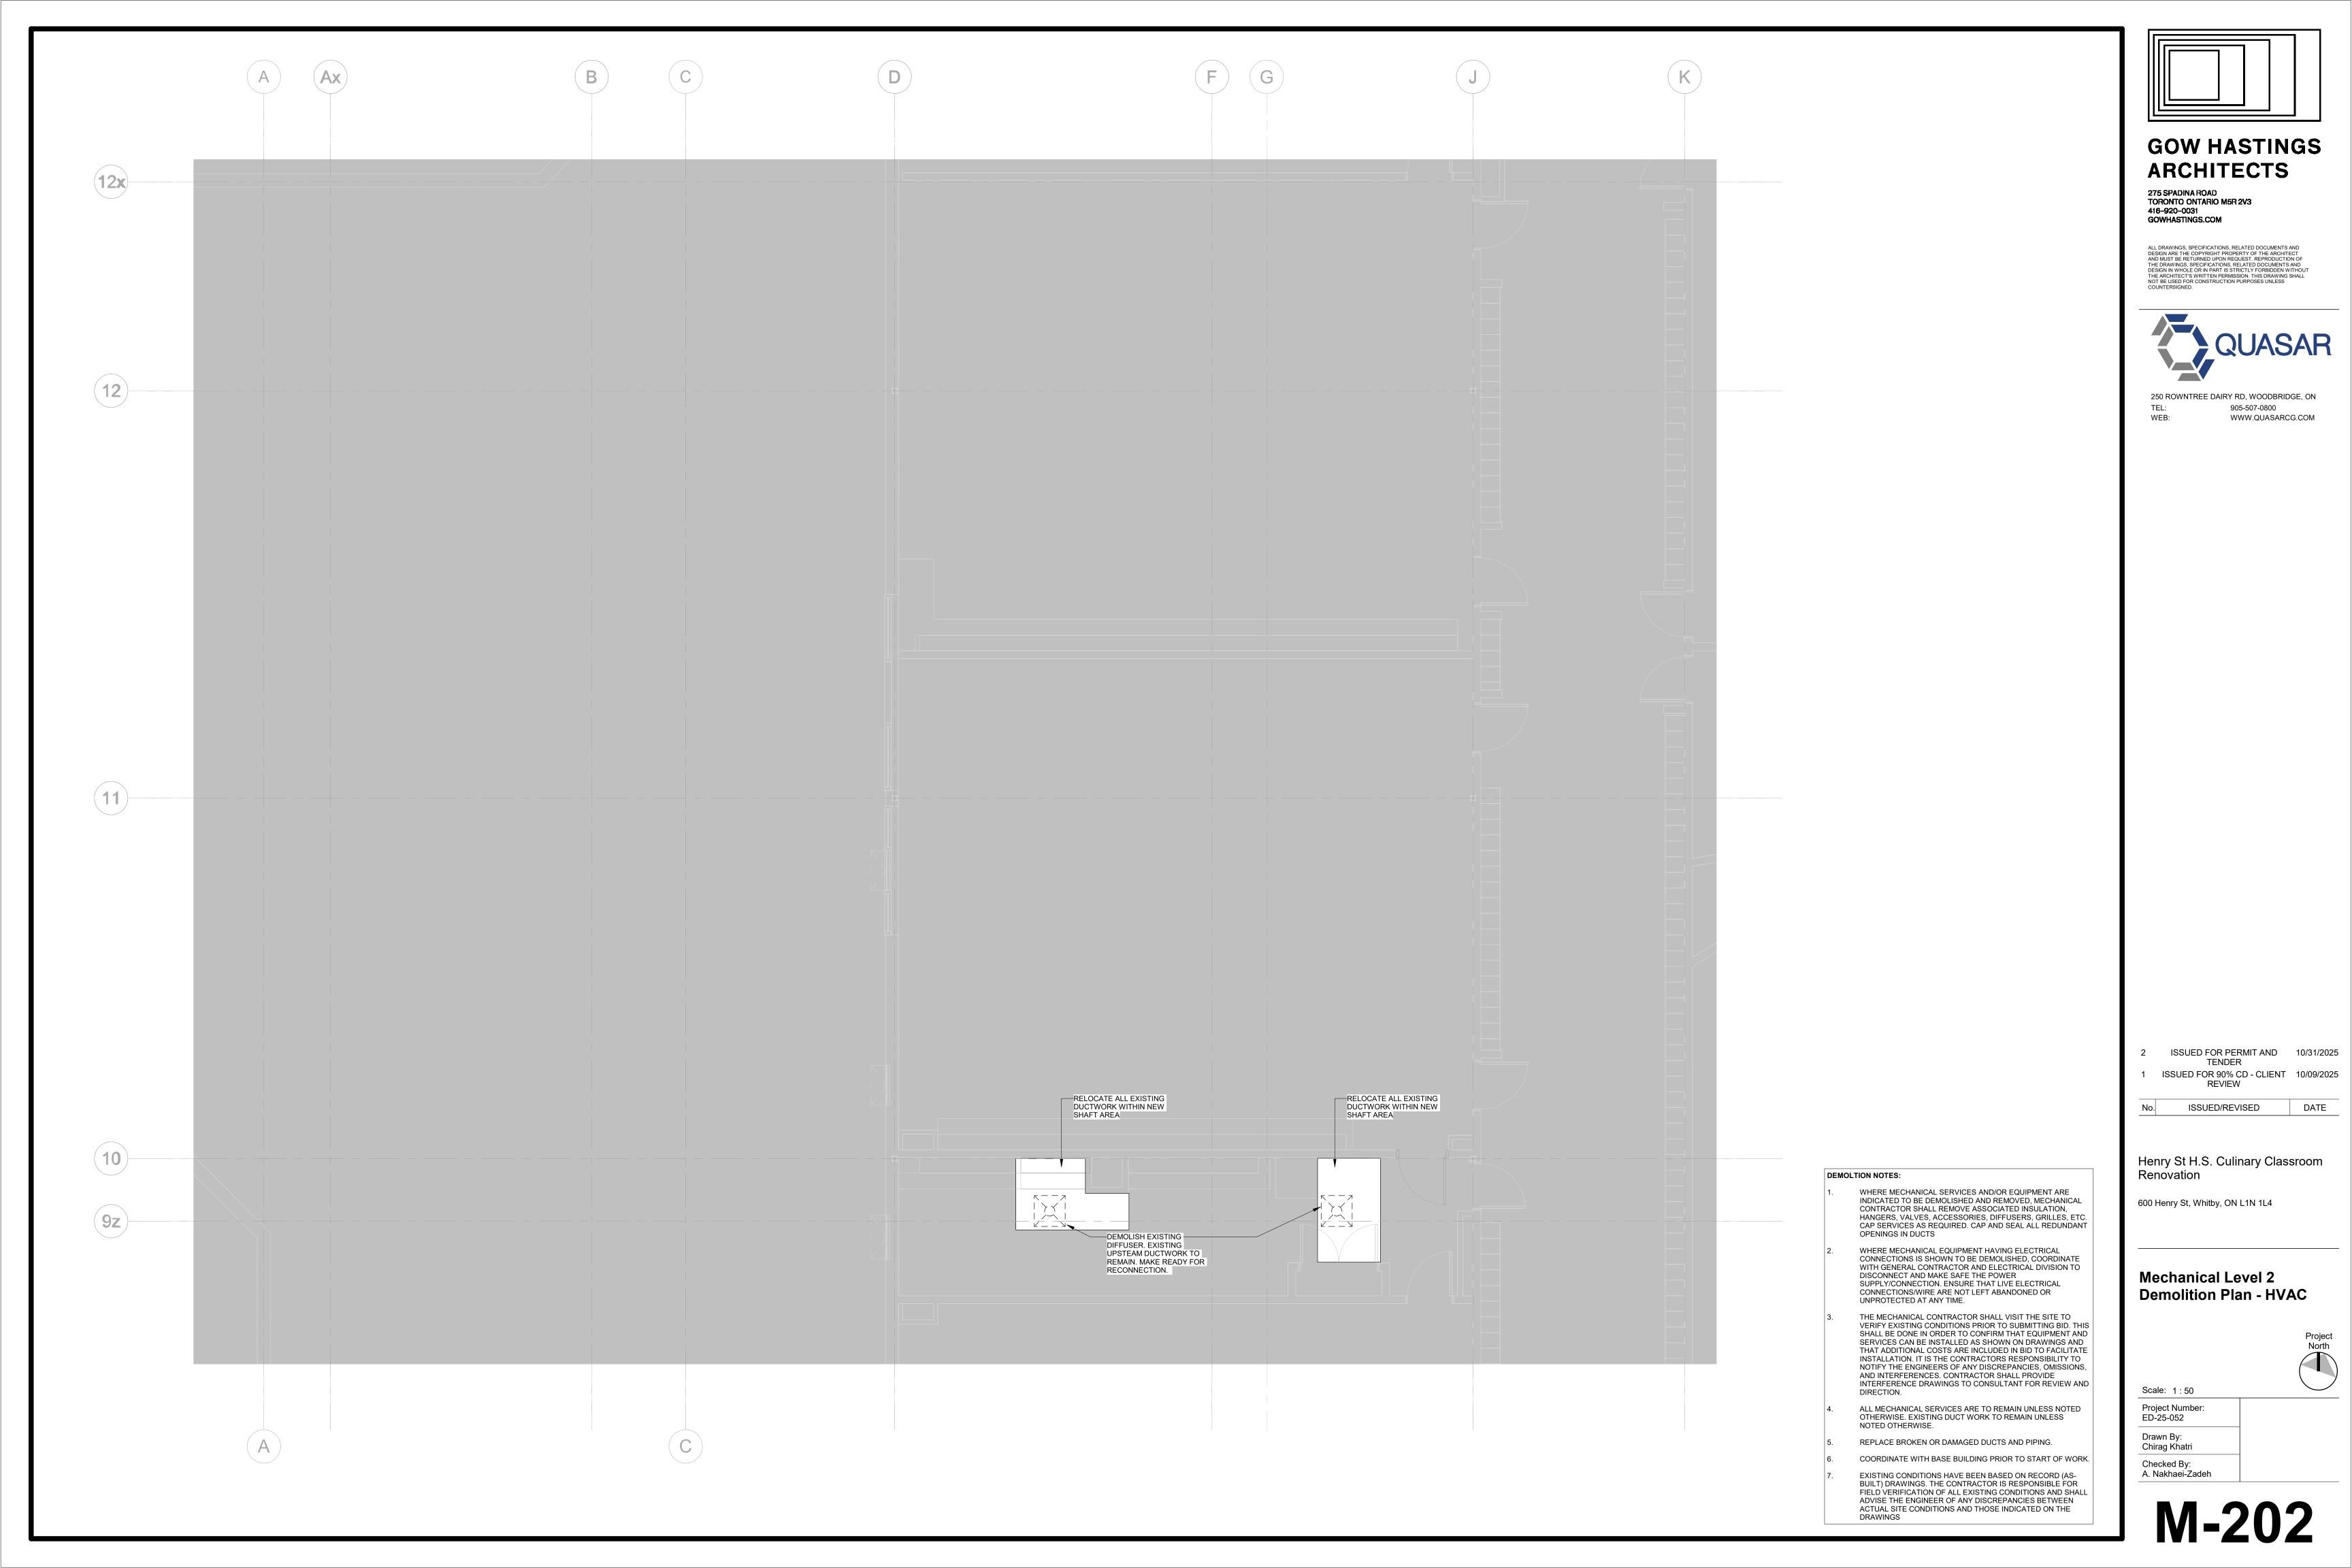

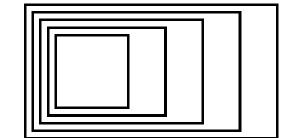

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#### **HVAC DRAWING NOTES:**

- TEMPERATURE SENSORS SHALL BE INSTALLED 1200 MM (48 IN)
- ABOVE FINISHED FLOOR. ALL CONTROL WIRING FROM EQUIPMENT TO WALL MOUNTED THERMOSTATS SHALL BE INSTALLED NEATLY AND TIGHT TO UNDERSIDE OF SLAB STRUCTURE.
- DIFFUSERS AND GRILLES ARE SHOWN FOR QUANTITY AND GENERAL LOCATION. LOCATE DIFFUSERS WITHIN EXISTING CEILING GRID.
- MECHANICAL CONTRACTOR TO INSTALL AND SUPPLY KITCHEN EXHAUST DUCTWORK AS PER NFPA 96.
- THE MECHANICAL CONTRACTOR SHALL VISIT THE SITE TO VERIFY EXISTING CONDITIONS PRIOR TO SUBMITTING BID. THIS SHALL BE DONE IN ORDER TO CONFIRM THAT EQUIPMENT AND SERVICES CAN BE INSTALLED AS SHOWN ON DRAWINGS AND THAT ADDITIONAL COSTS ARE INCLUDED IN BID TO FACILITATE INSTALLATION. IT IS THE CONTRACTORS RESPONSIBILITY TO NOTIFY THE ENGINEERS OF ANY DISCREPANCIES, OMISSIONS, AND INTERFERENCES. CONTRACTOR SHALL PROVIDE INTERFERENCE DRAWINGS TO CONSULTANT FOR REVIEW AND DIRECTION.
- COORDINATE WITH BASE BUILDING PRIOR TO START OF WORK.
- MECHANICAL CONTRACTOR TO RE-INSULATE ALL EXISTING DUCTWORK WITHIN THE SCOPE OF WORK. NOTE THAT THE EXISTING DUCTWORK SHOWN ON PLAN IS DIAGRAMMATIC AND MAY NOT SHOW THE FULL EXTENT OF EXISTING SERVICES. CONTRACTOR SHALL SITE VERIFY AND RE-INSULATE ALL EXISTING DUCTWORK/PIPING EVEN IF IT IS NOT SHOWN ON THE PLANS.
- KITCHEN EXHAUST DUCT SHALL BE WELDED AND MEET NFPA 96 AND LOCAL AUTHORITY REQUIREMENT. PROVIDE FIRE PROOFING TO KITCHEN EXHAUST DUCT. PROVIDE ACCESS DOOR (AD) 20"x20" AT EVERY CHANGE OF DIRECTION TO KITCHEN ÉXHAUST DUCTS.
- CONTRACTOR SHALL BALANCE THE AIR FLOW AS SHOWN IN THE DRAWING AND PROVIDE AIR BALANCING REPORT TO THE
- ENGINEER FOR REVIEW. PROVIDE BALANCING DAMPERS IN TAKEOFFS TO ALL
- DIFFUSERS, GRILLES AND BRANCH DUCTS. CEILING MOUNTED EQUIPMENT SHALL BE INSTALLED WITH SUFFICIENT CLEARANCE FOR FUTURE MAINTENANCE. FOLLOW THE MANUFACTURERS RECOMMENDATIONS FOR
- INSTALLATION. DUCT LAYOUT AS SHOWN ON PLANS IS TO SHOW THE DESIGN INTENT. CONTRACTOR SHALL COORDINATE DUCT ROUTE AND ALL NECESSARY FITTINGS TO ACCOMMODATE THE SITE CONDITIONS AND TO MEET THE DESIGN INTENT.
- EXISTING CONDITIONS HAVE BEEN BASED ON RECORD (ASBUILT) DRAWINGS. THE CONTRACTOR IS RESPONSIBLE FOR FIELD VERIFICATION OF ALL EXISTING CONDITIONS AND SHALL ADVISE THE ENGINEER OF ANY DISCREPANCIES BETWEEN ACTUAL SITE CONDITIONS AND THOSE INDICATED ON THE DRAWINGS


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1	ISSUED FOR 90% CD - CLIENT REVIEW	10/09/2025

0.	ISSUED/REVISED	DATE

Henry St H.S. Culinary Classroom Renovation

600 Henry St, Whitby, ON L1N 1L4

Mechanical Level 1 New **Construction Plan - HVAC** 

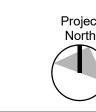



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Project Number: ED-25-052 Drawn By: Chirag Khatri

Checked By:

A. Nakhaei-Zadeh



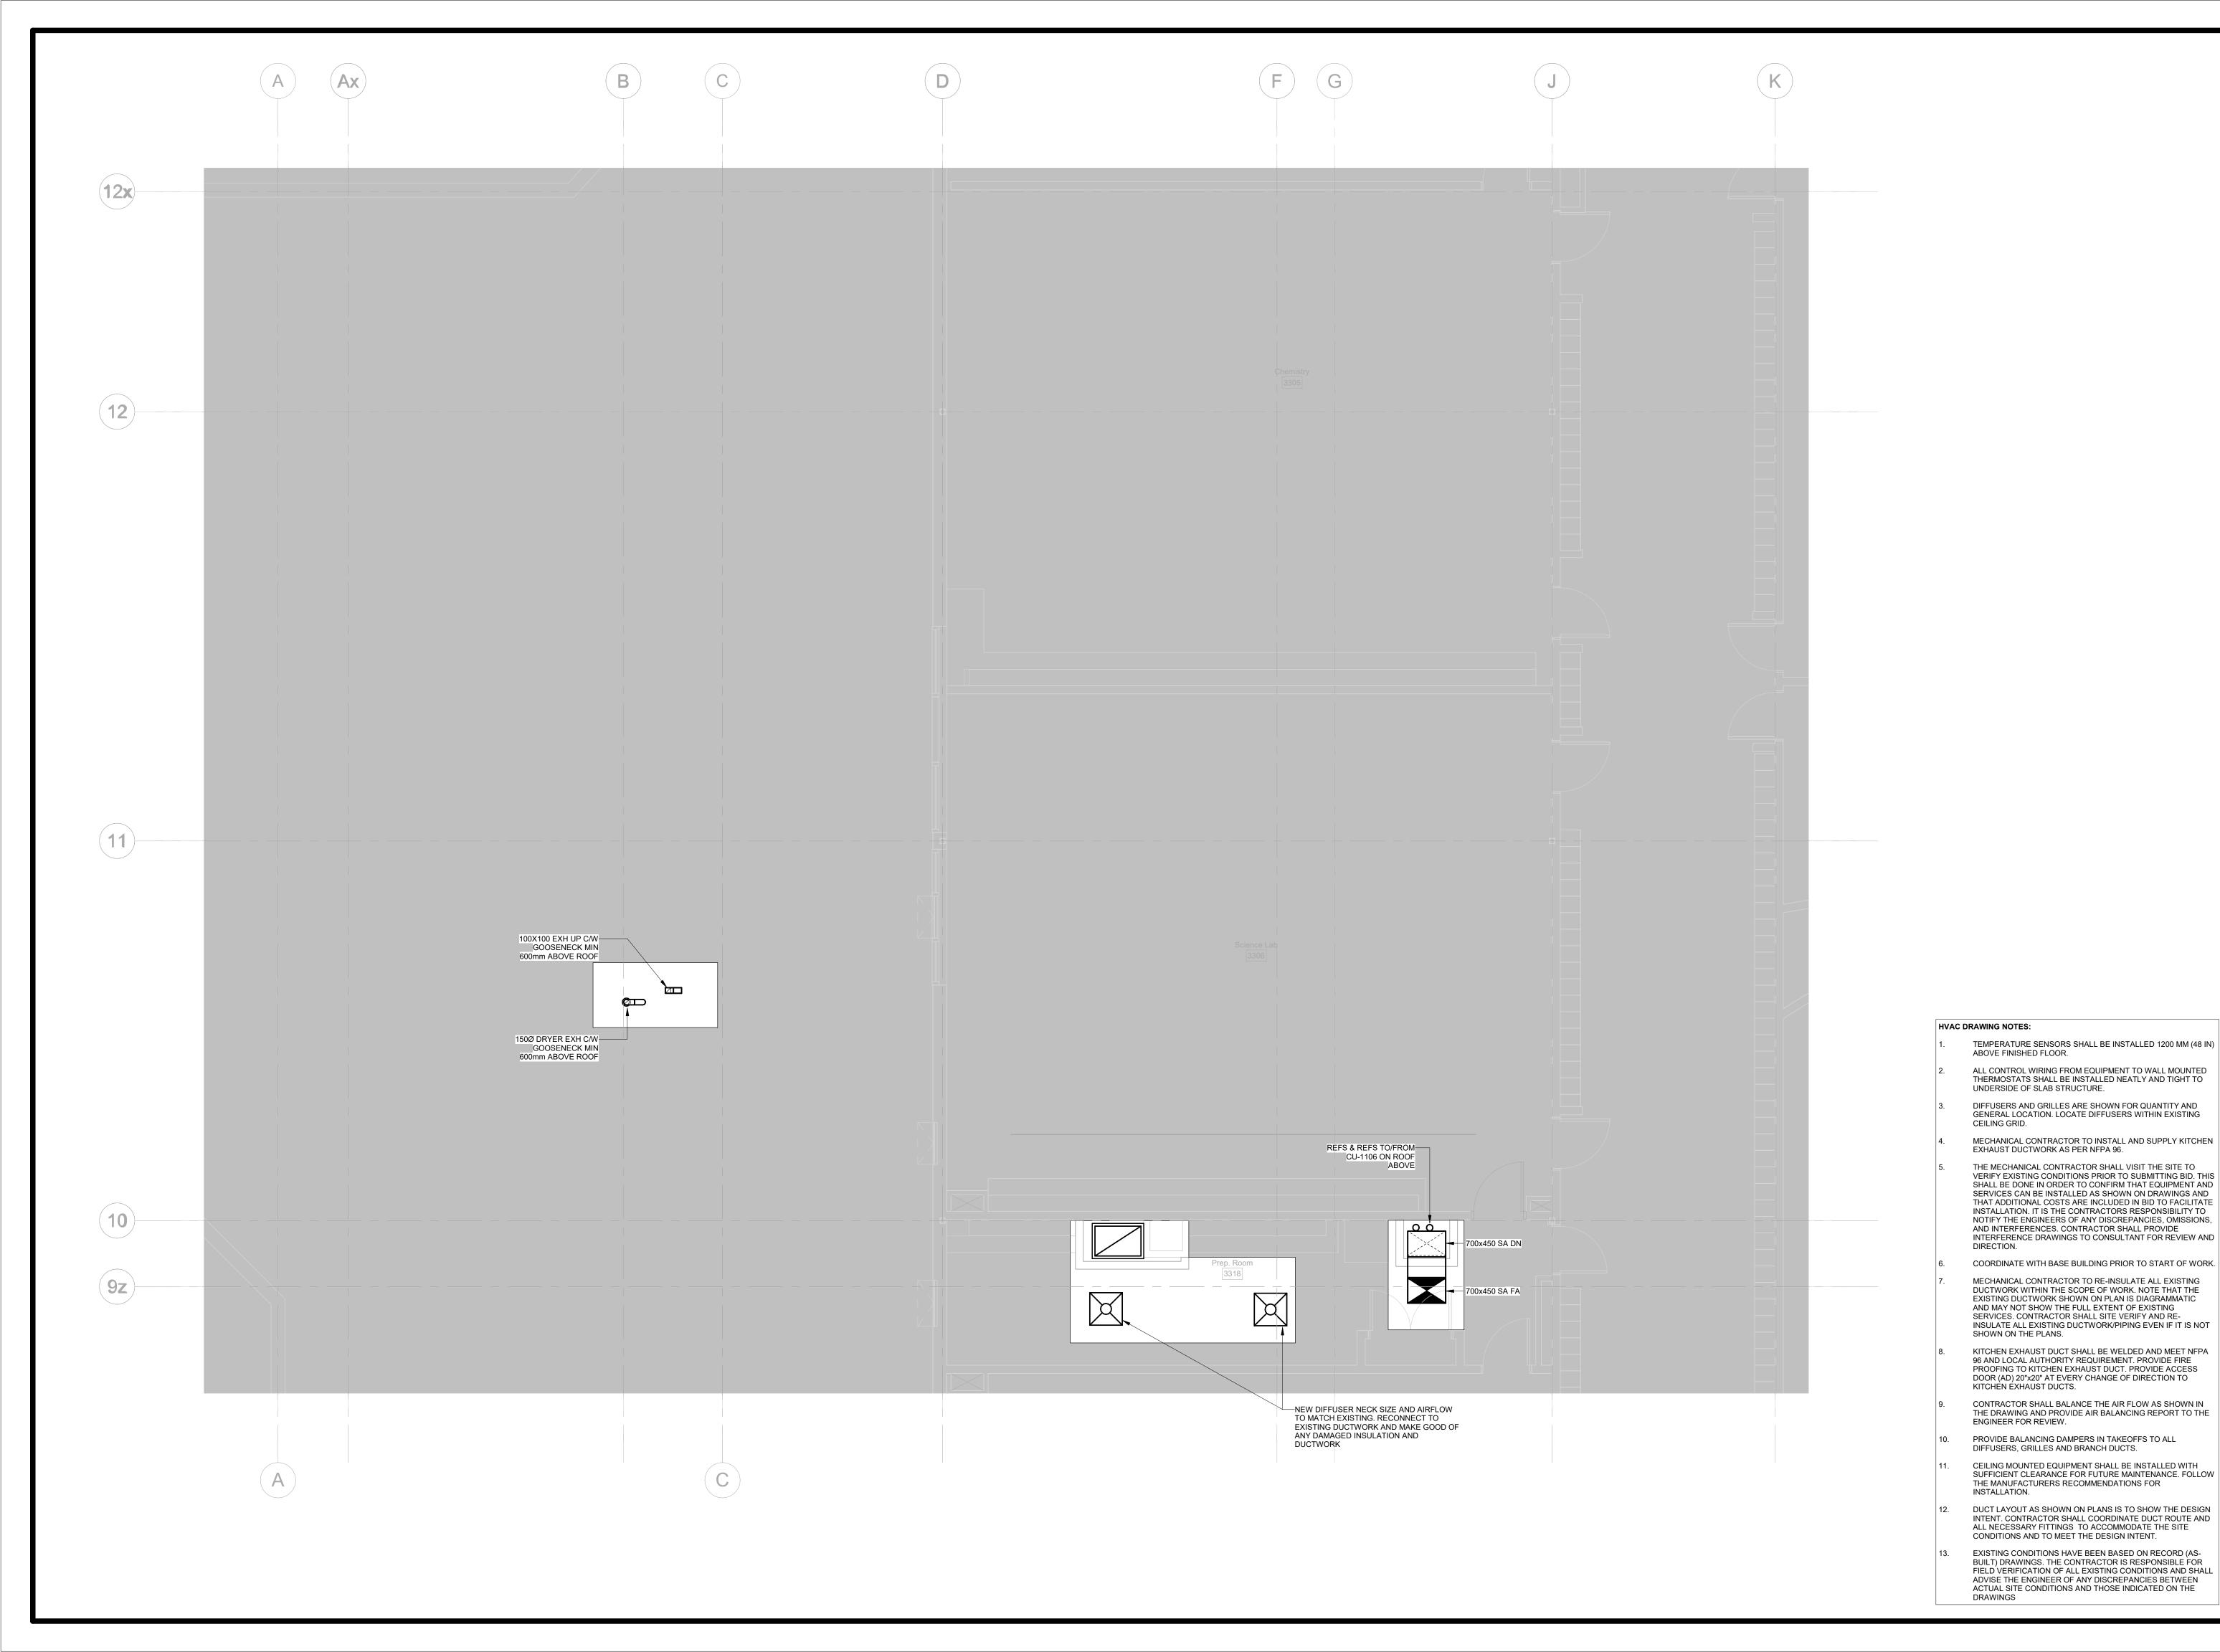
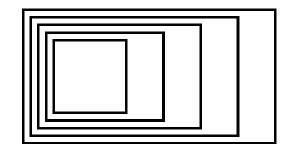
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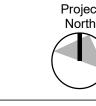
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Mechanical Level 2 New **Construction Plan - HVAC** 





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Project Number: ED-25-052

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# Mechanical Roof New Construction Plan - HVAC & Plumbing

Projec North


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Checked By:

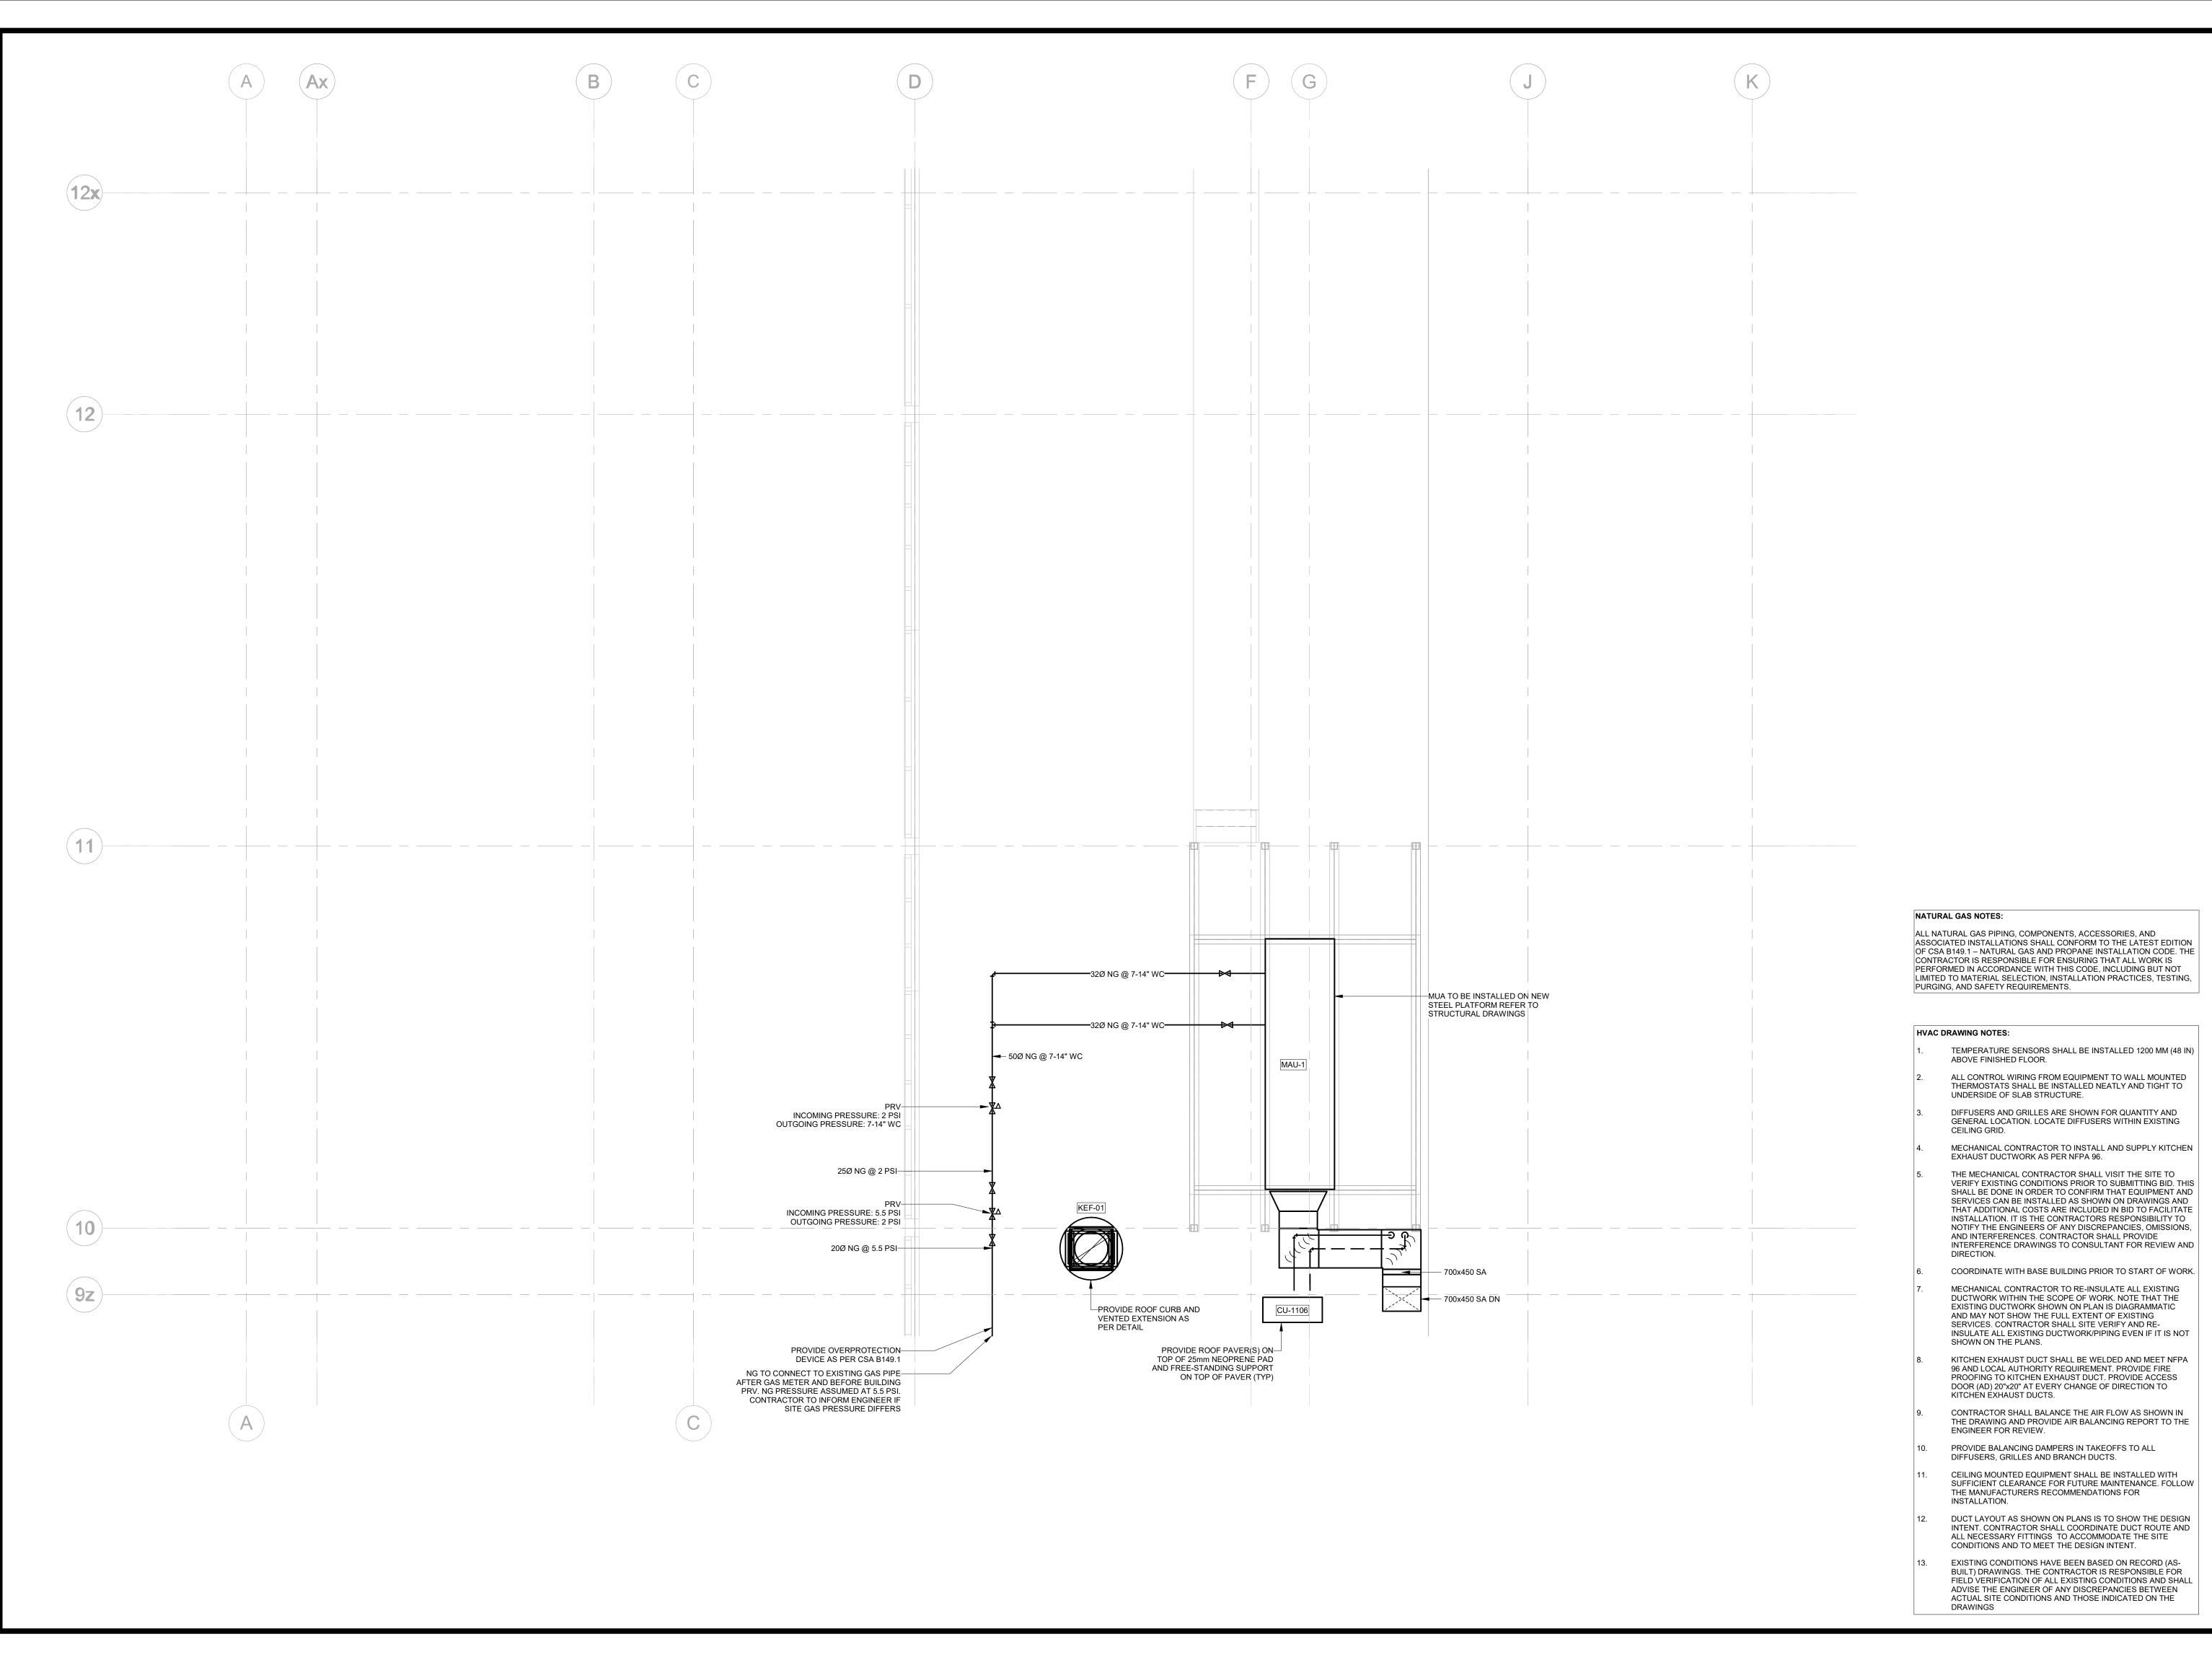
Project Number: ED-25-052 Drawn By: Chirag Khatri

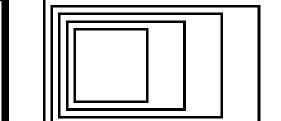A. Nakhaei-Zadeh


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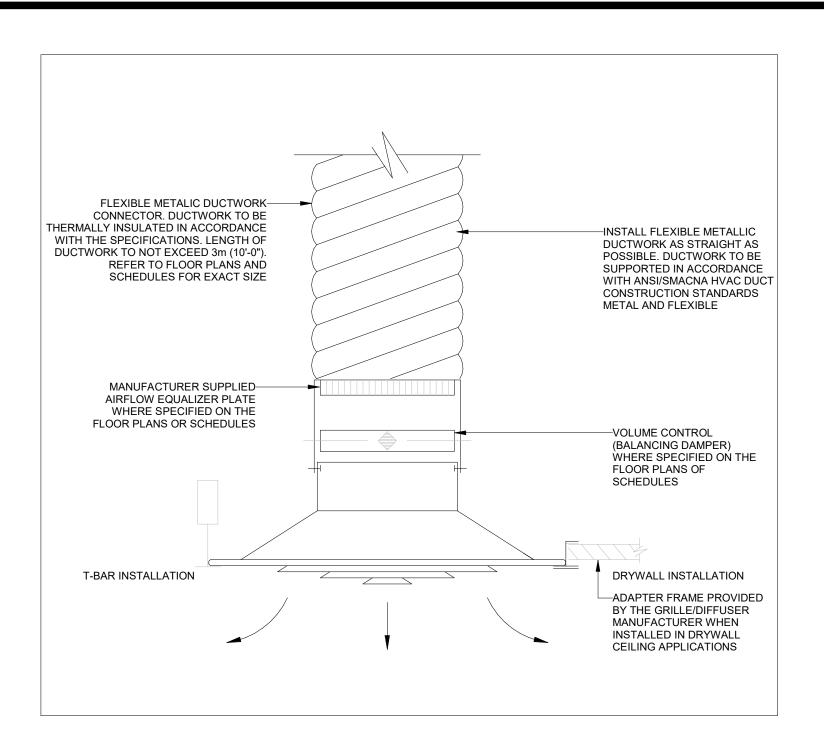
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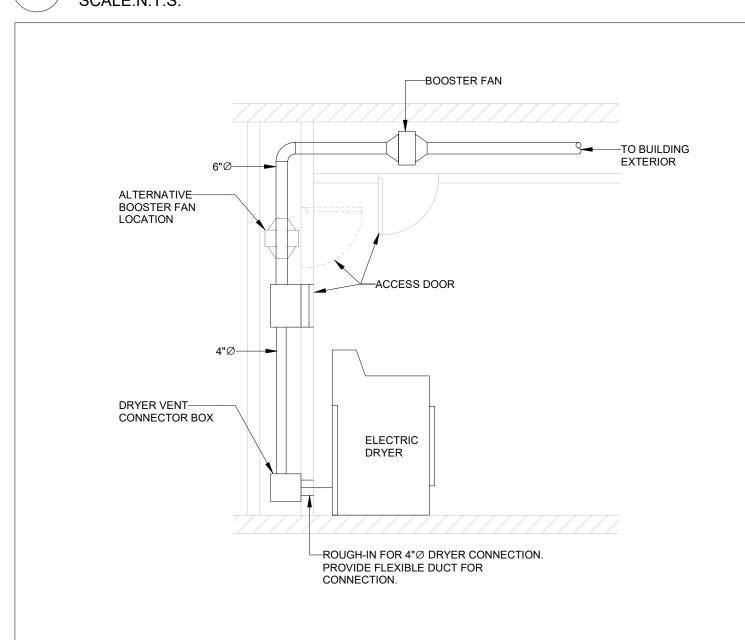
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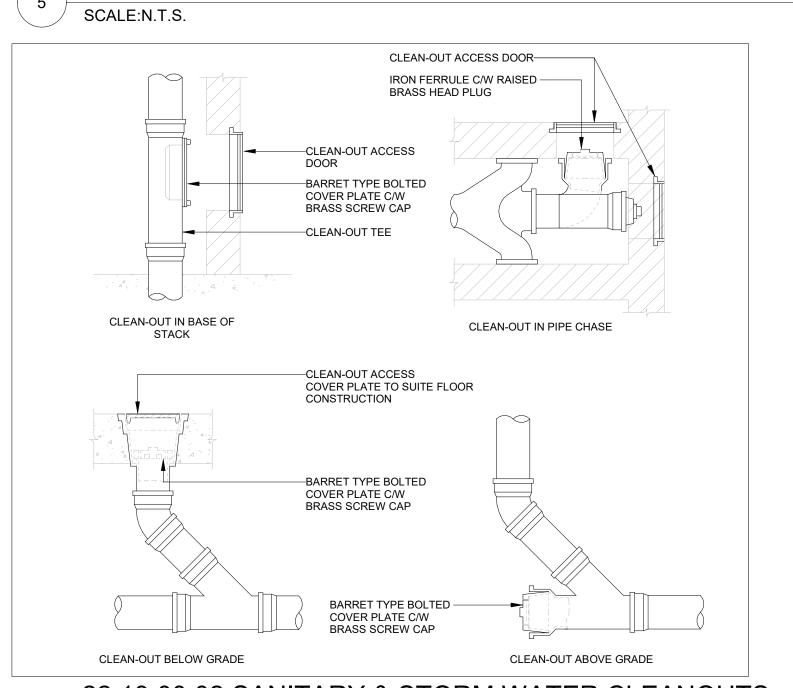
DISHWASHER PLUMBING SCALE:N.T.S.

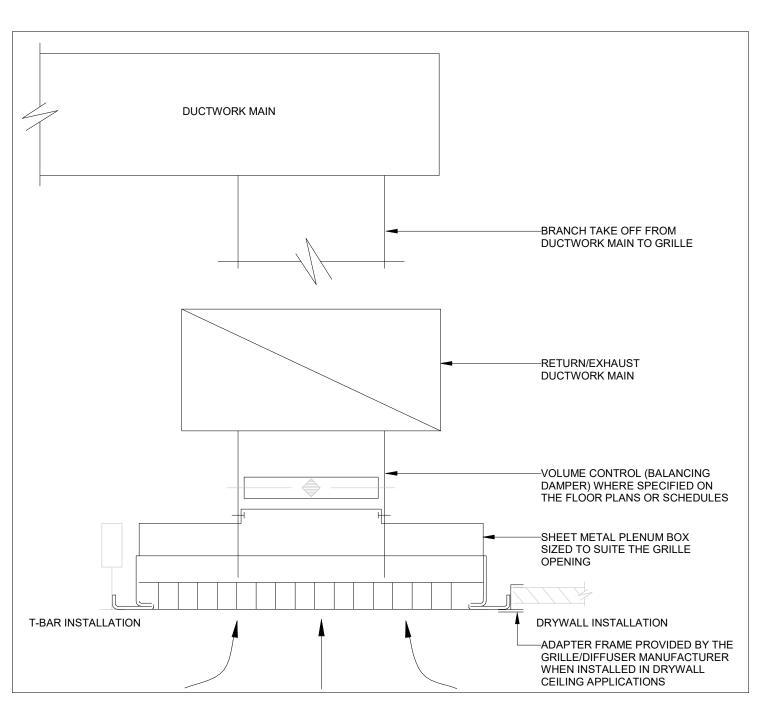


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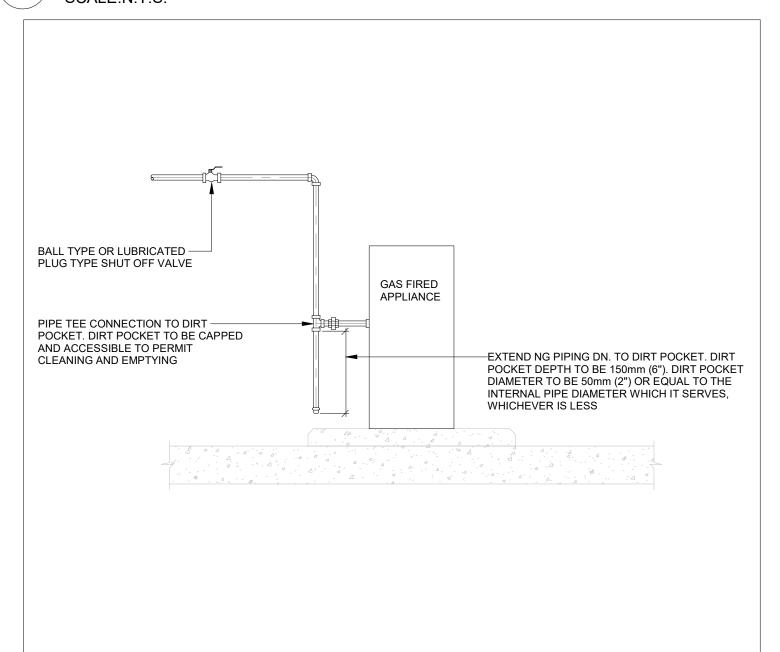
### LAUNDRY DRYER EXHAUST WITH INLINE BOOSTER FAN

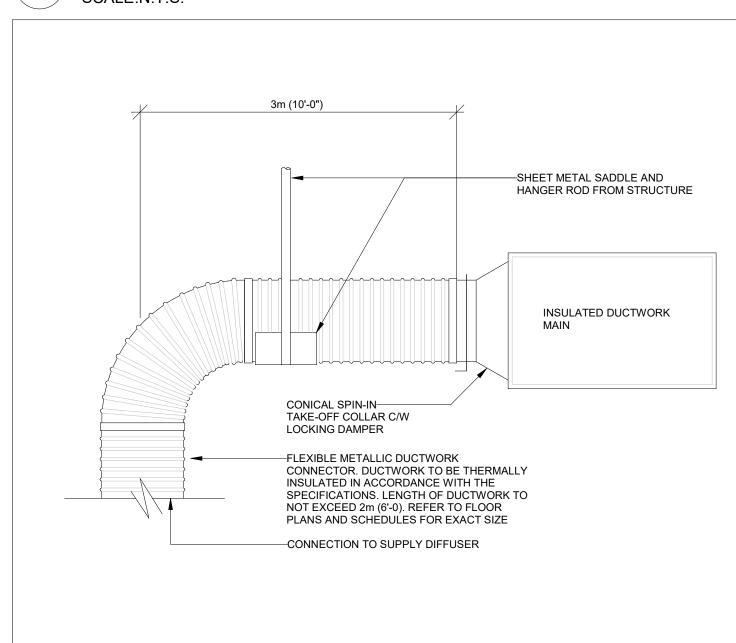


22 13 00.02 SANITARY & STORM WATER CLEANOUTS
SCALE:N.T.S.

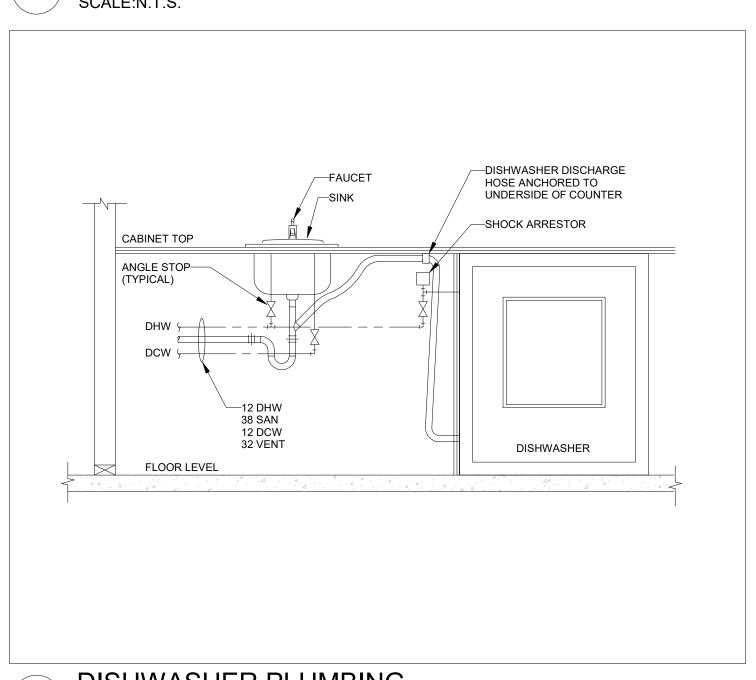


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### 23 11 23.01 NATURAL GAS EQUIPMENT CONNECTION SCALE:N.T.S.

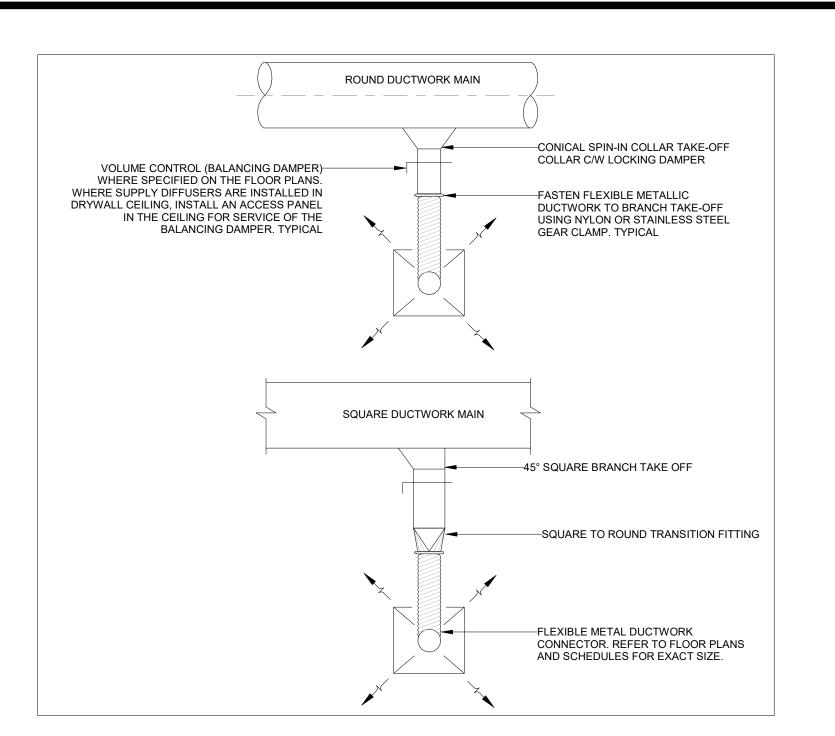

20 05 00.03 PIPING HANGERS AND SUPPORTS SCALE:N.T.S.

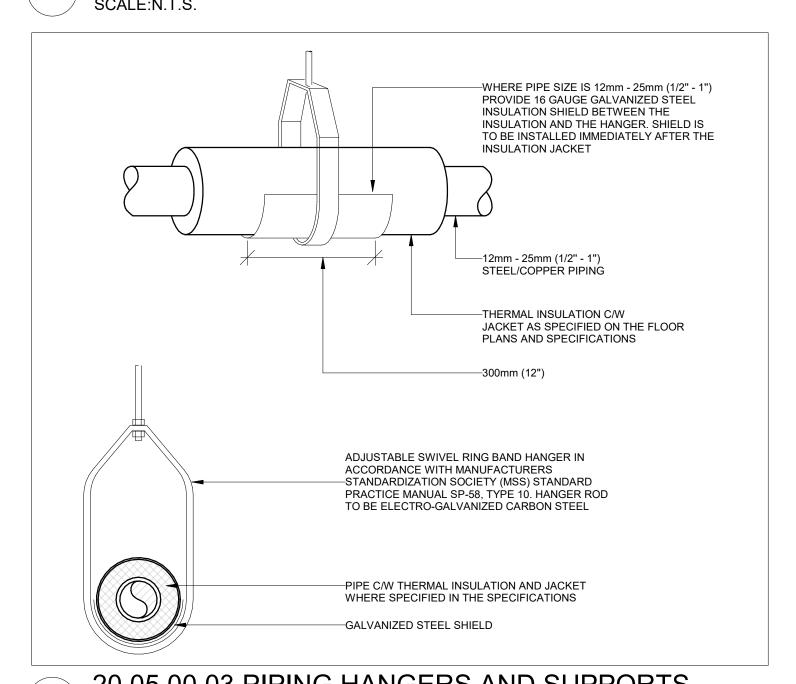

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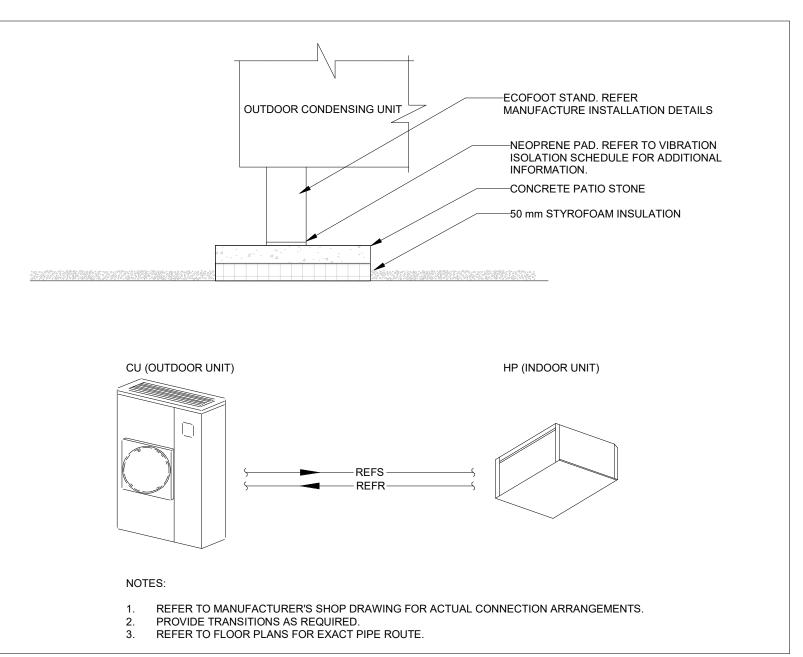
Mechanical Detail Sheet

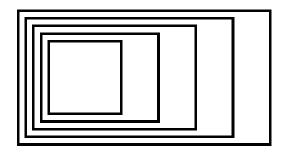Scale: N.T.S.


Project Number:
ED-25-052

Drawn By:
Chirag Khatri


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A. Nakhaei-Zadeh



# 9 OUTDOOR CONDENSING UNIT SCALE:N.T.S.

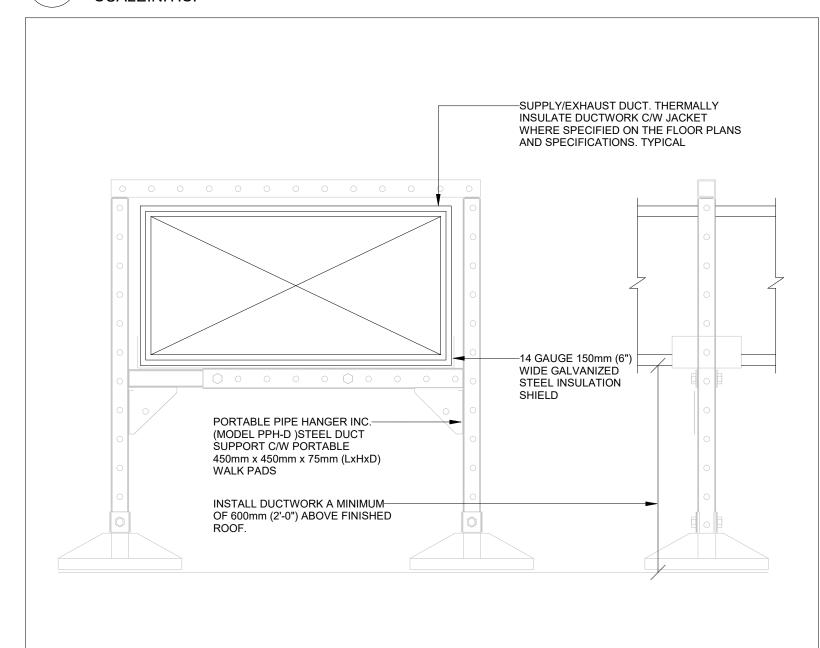

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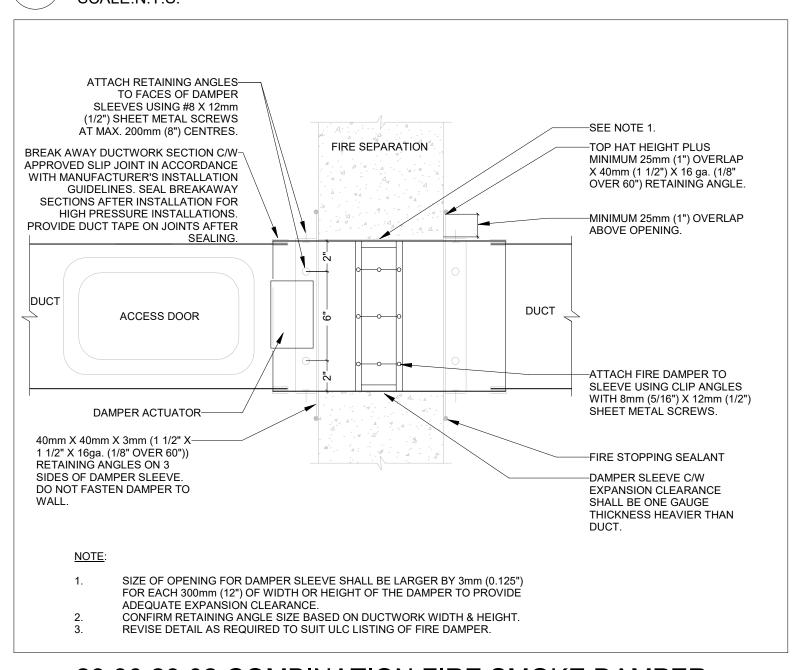


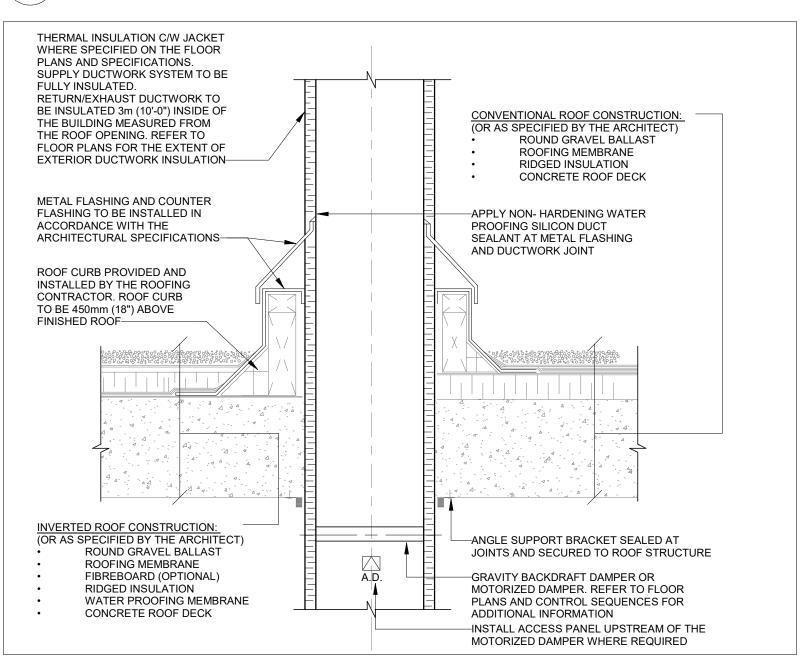20 05 00.01 DUCTWORK ROOF PENETRATION & FLASHING SCALE: N.T.S.


INTERLOCKING QUICK-BLOCK
FROM UV STABILIZED
POLYPROPYLENE

PIPE CLAMP FASTENED TO
BLOCK BASE CLAMP TO BE
DIAMETER


## GAS PIPING ON ROOF - SUPPORT DETAIL SCALE:N.T.S.




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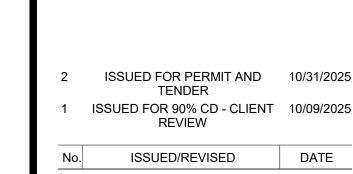
23 30 00.01 DUCTWORK FITTINGS & TAKE-OFF'S SCALE:N.T.S.

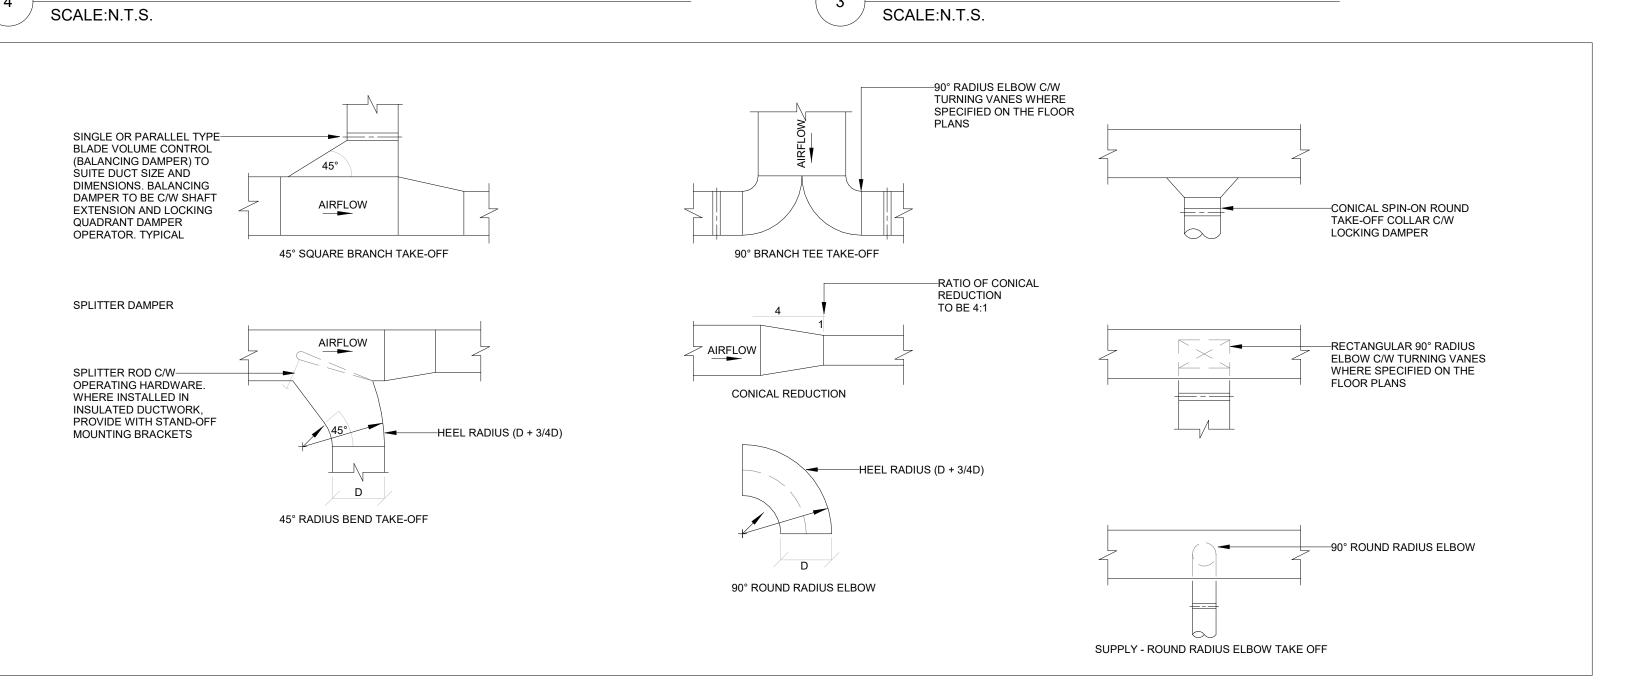

### 23 34 00.08 ROOF MOUNTED EXHAUST FAN

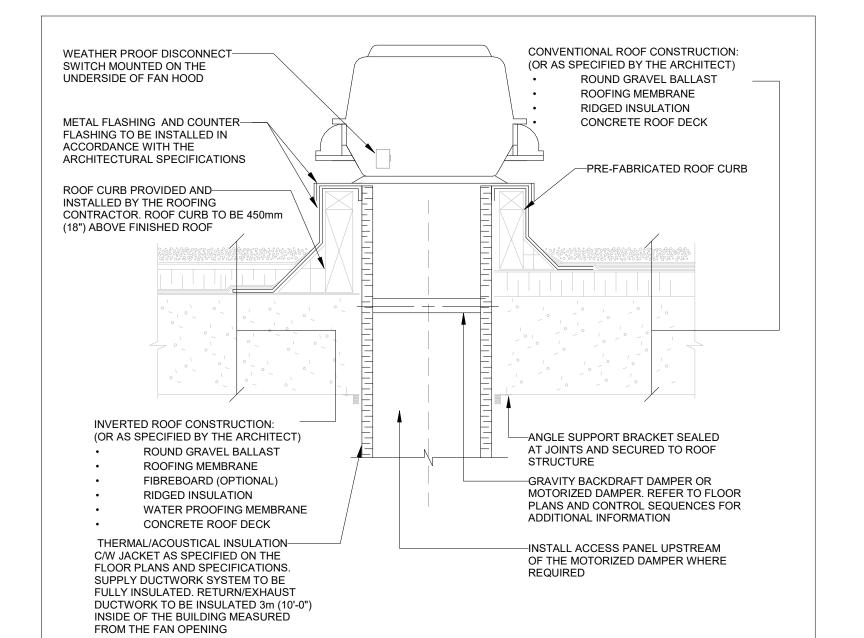

23 30 29.01 FUSIBLE LINK DAMPER
SCALE:N.T.S.

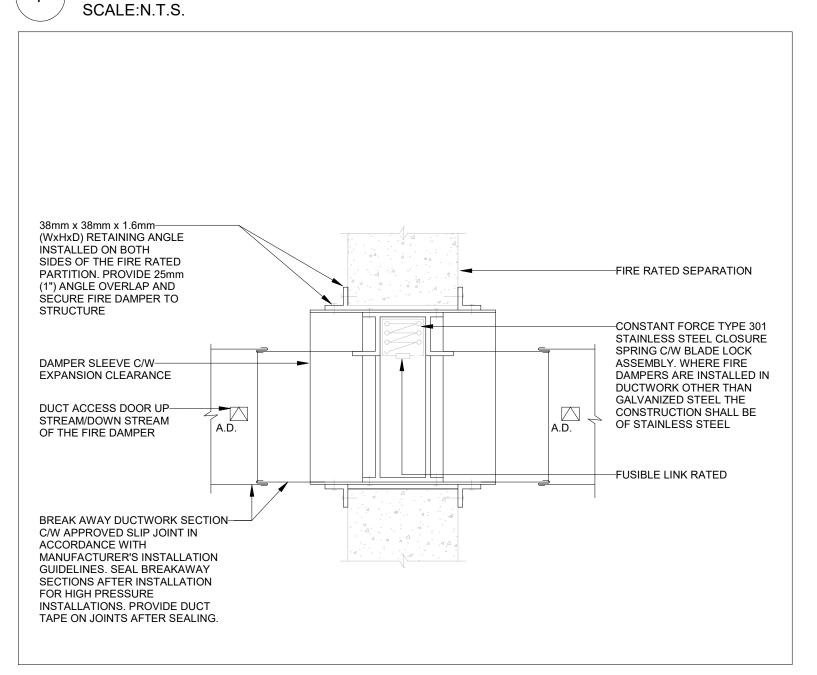

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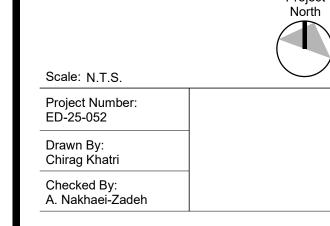
TORONTO ONTARIO M5R 2V3


Henry St H.S. Culinary Classroom Renovation


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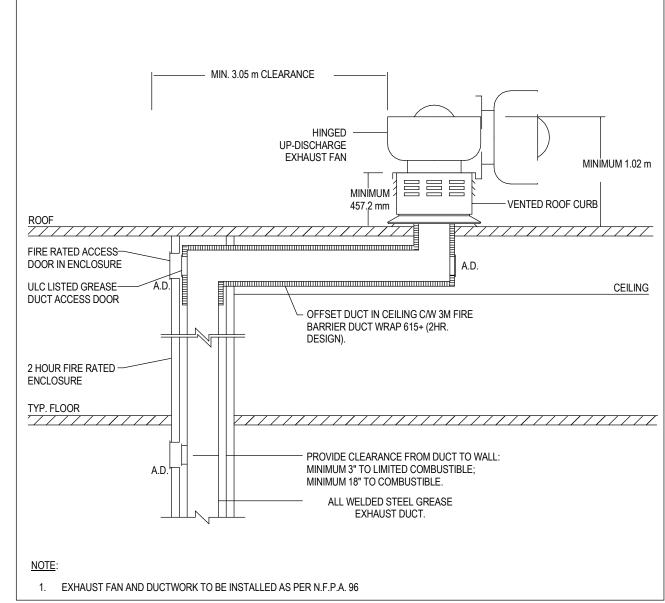
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Mechanical Detail Sheet No. 2









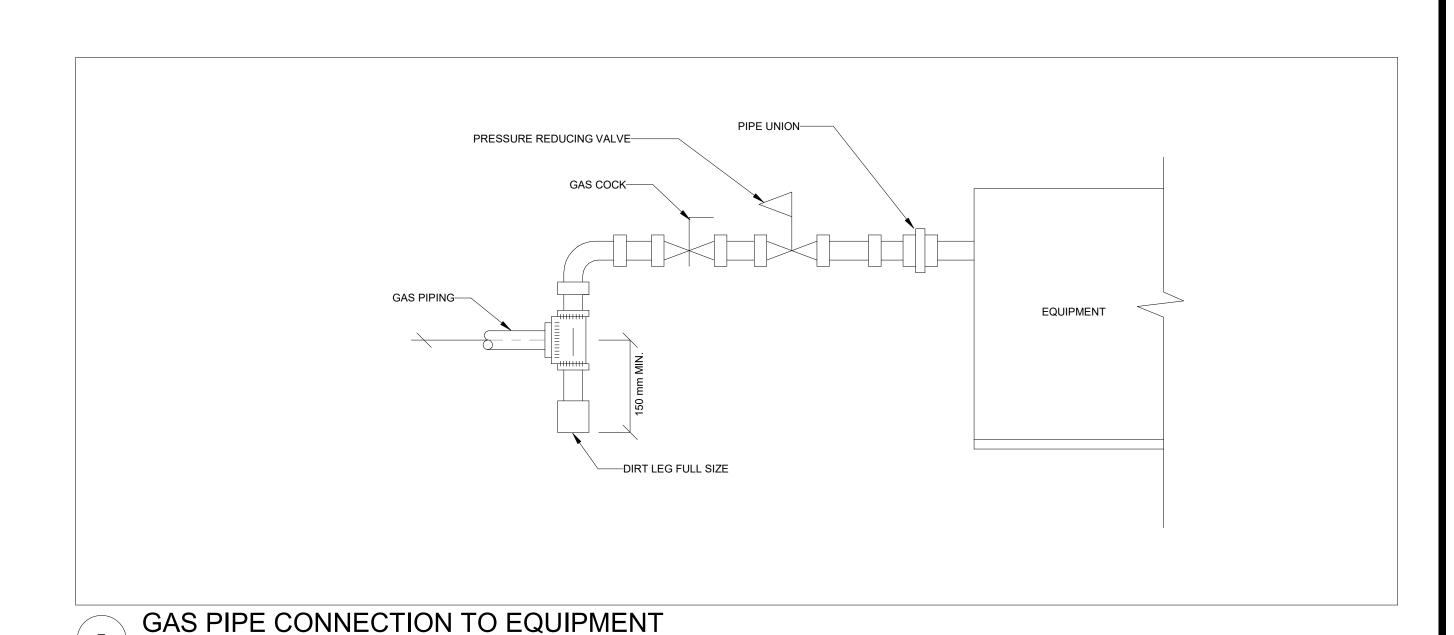

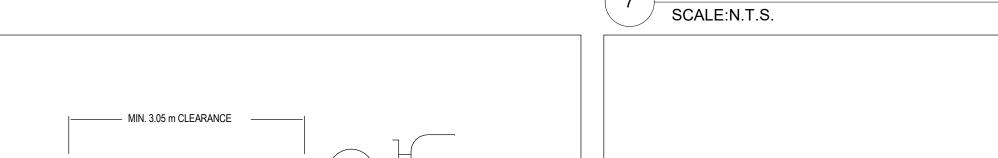
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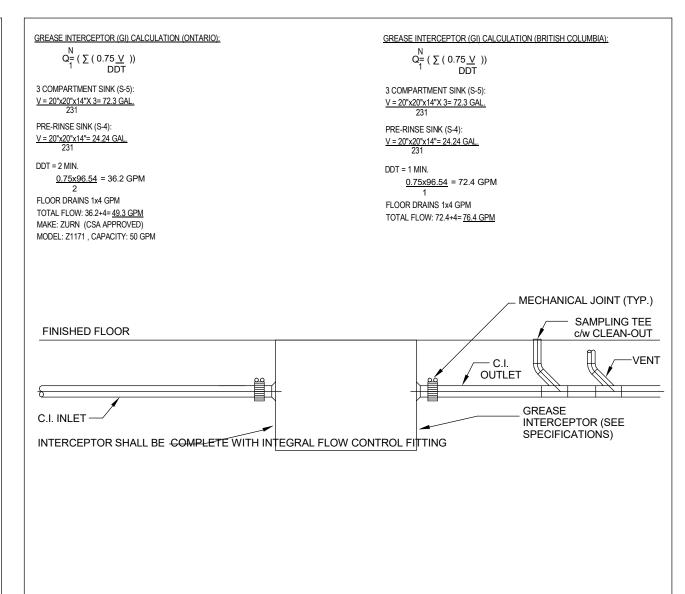
3 KITCHEN EXHAUST FAN SCALE: N.T.S.

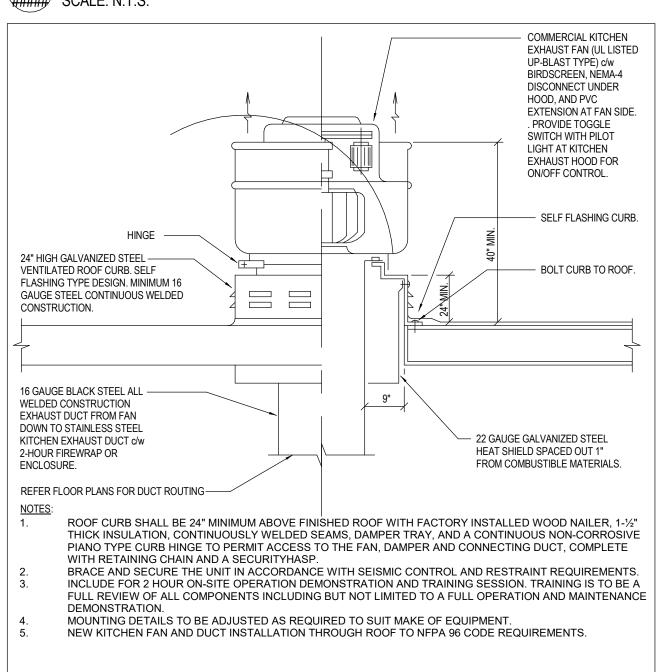


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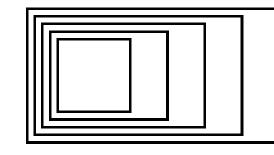
2 DUCT SUPPORT ON ROOF SCALE: N.T.S.

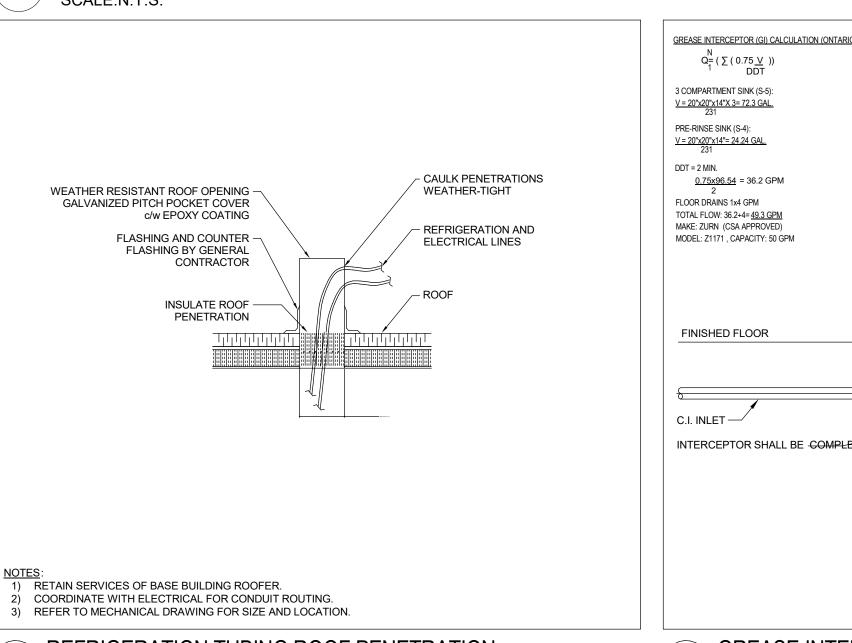



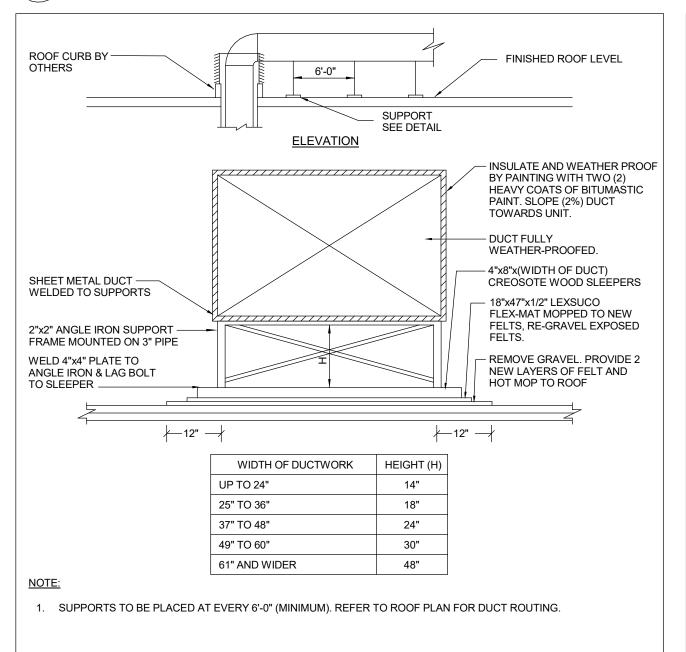

1 KITCHEN EXHAUST DUCT ACCESS DOOR SCALE: N.T.S.

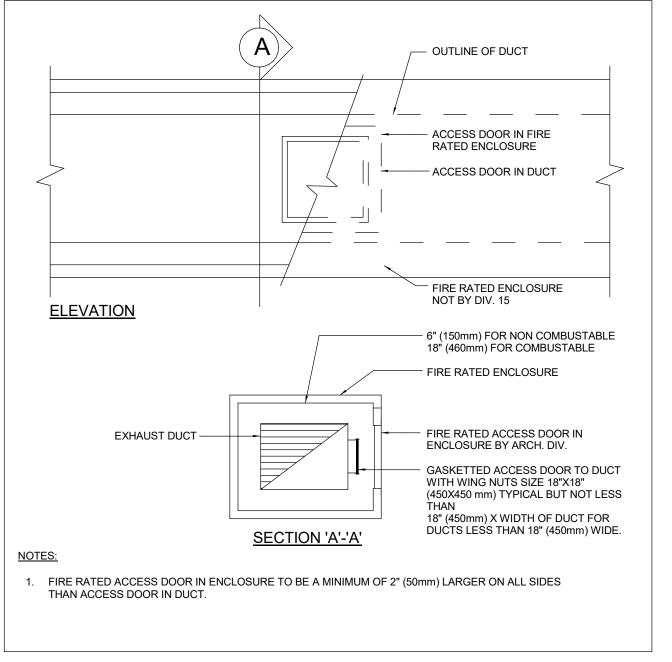

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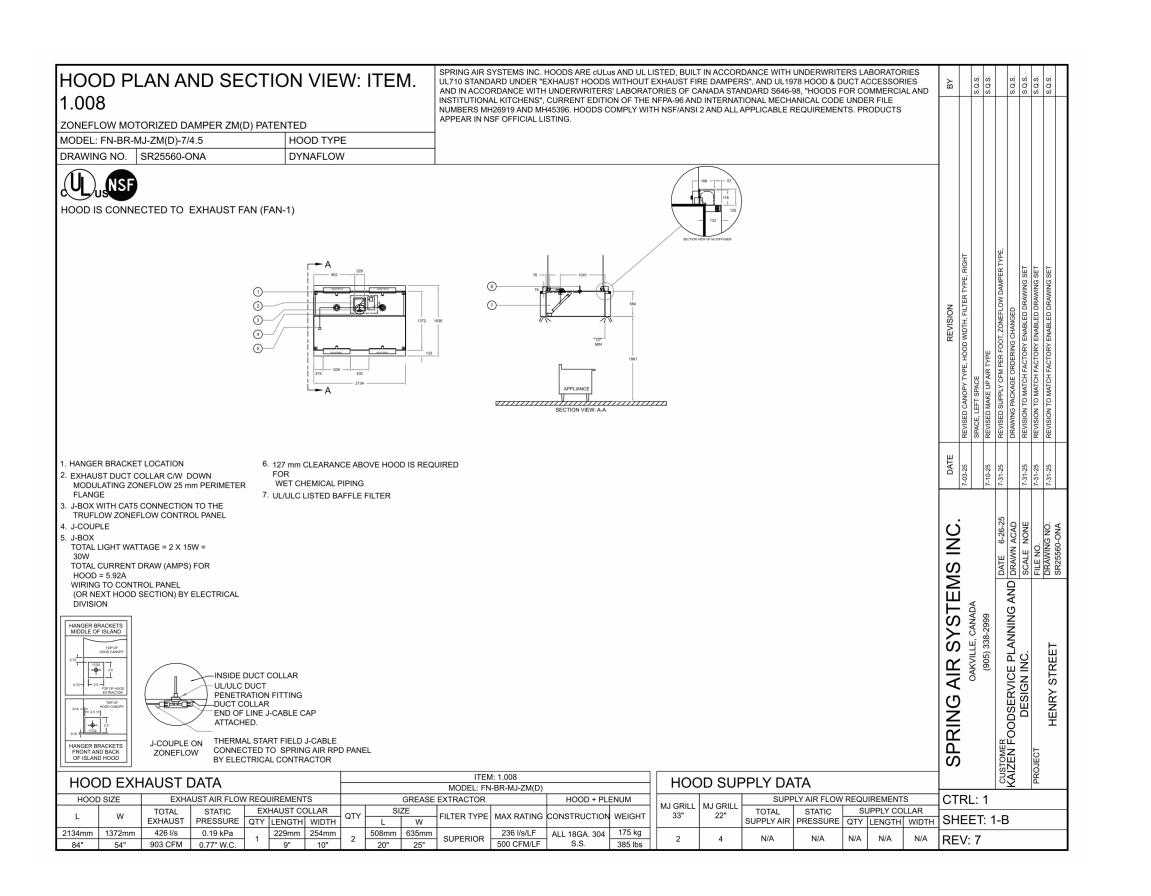
Mechanical Detail Sheet No. 3


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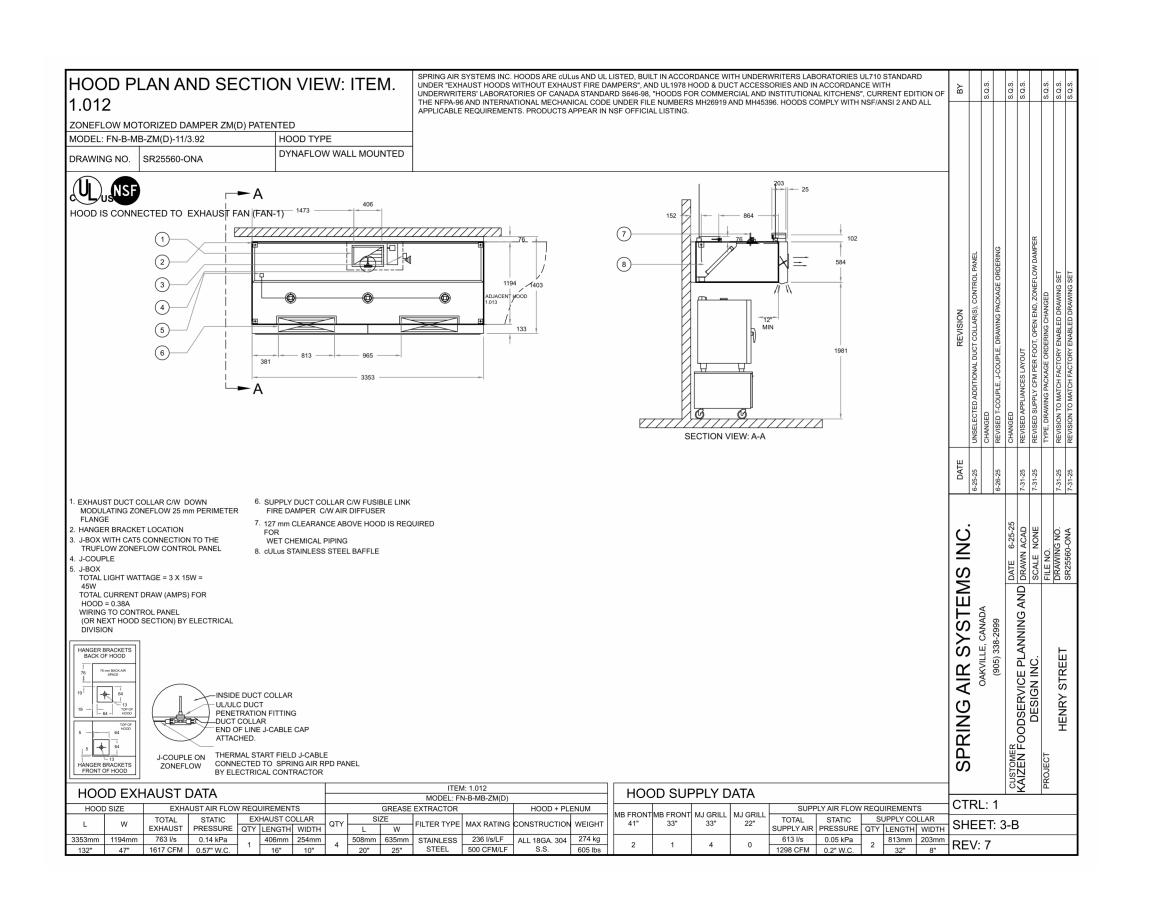
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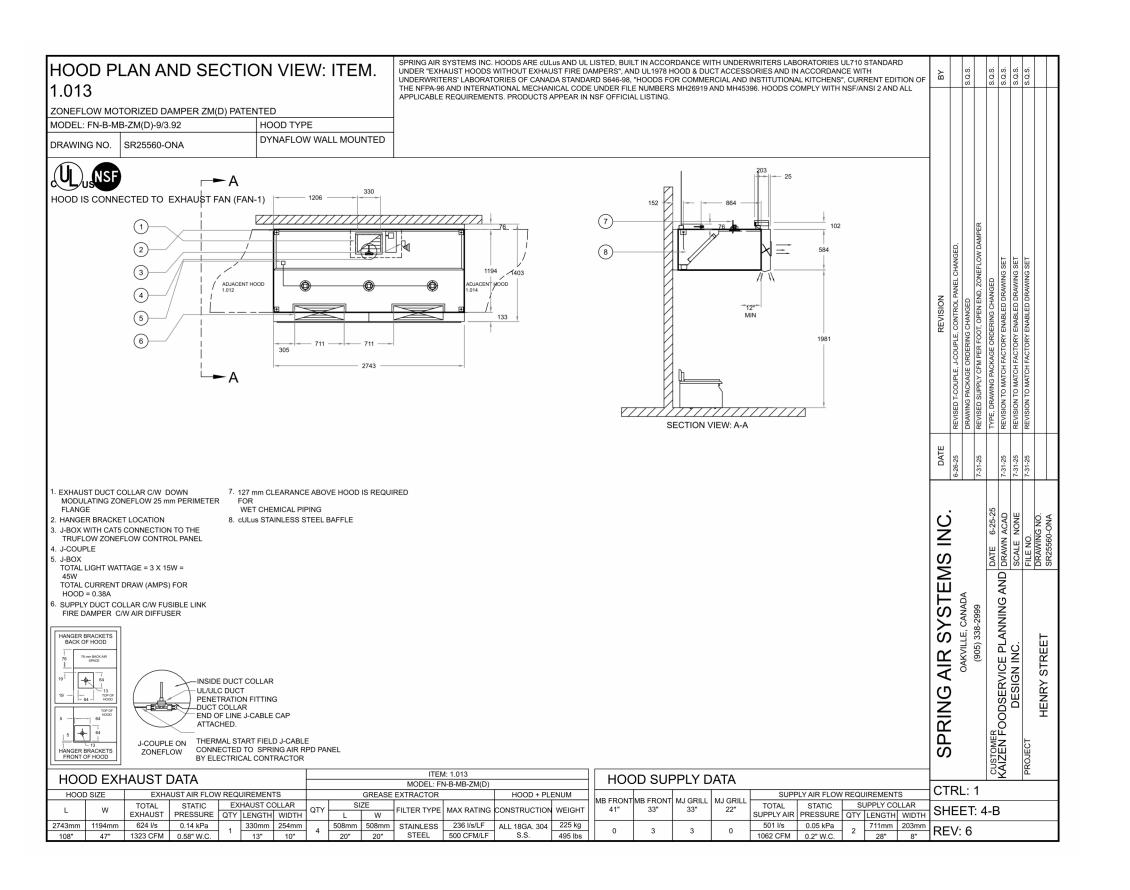
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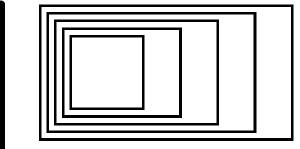
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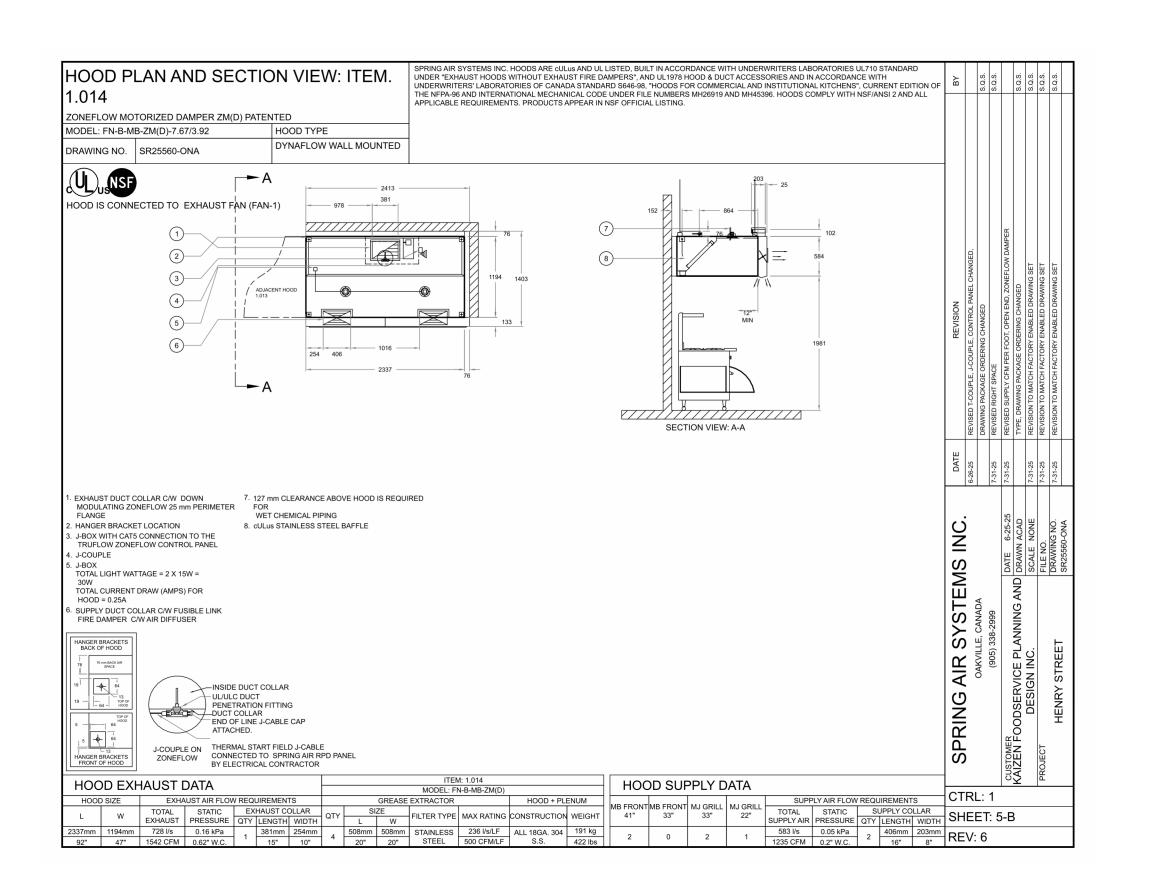
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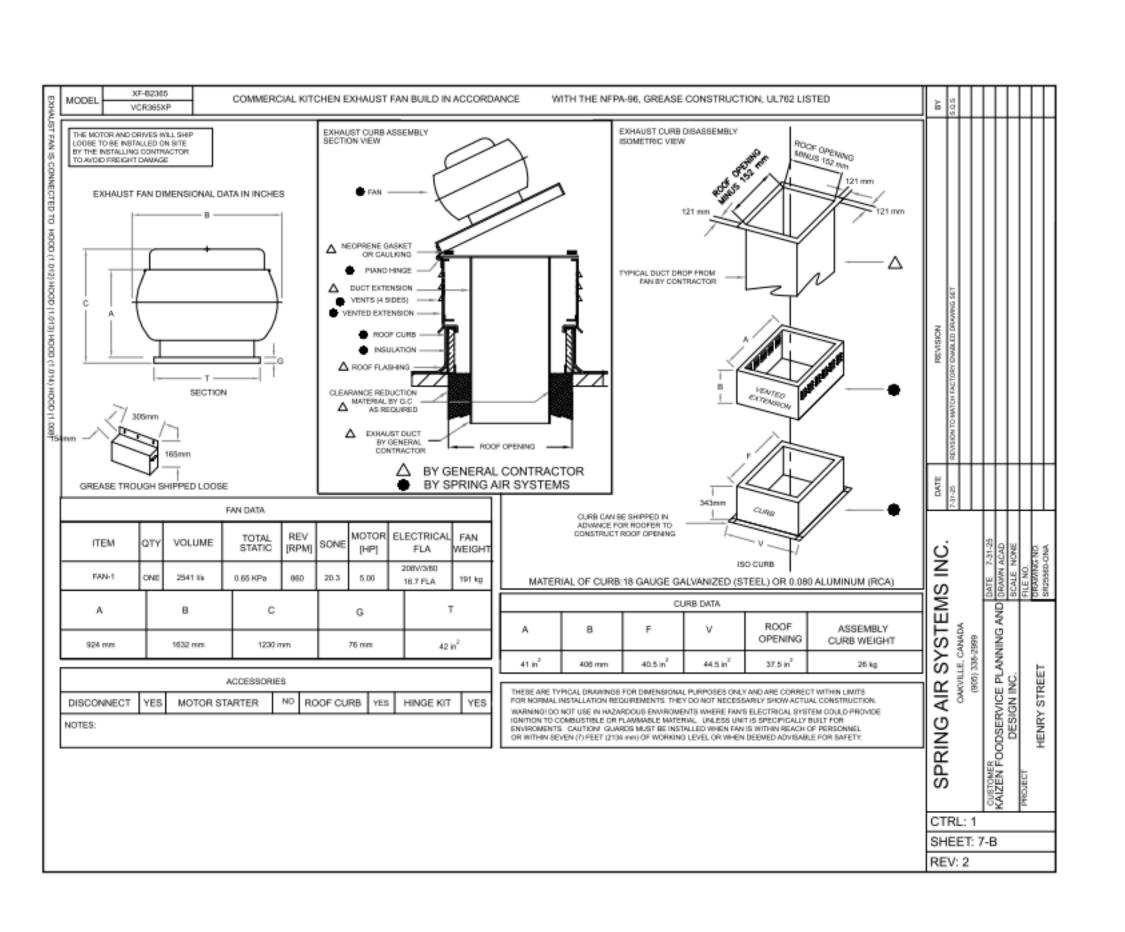
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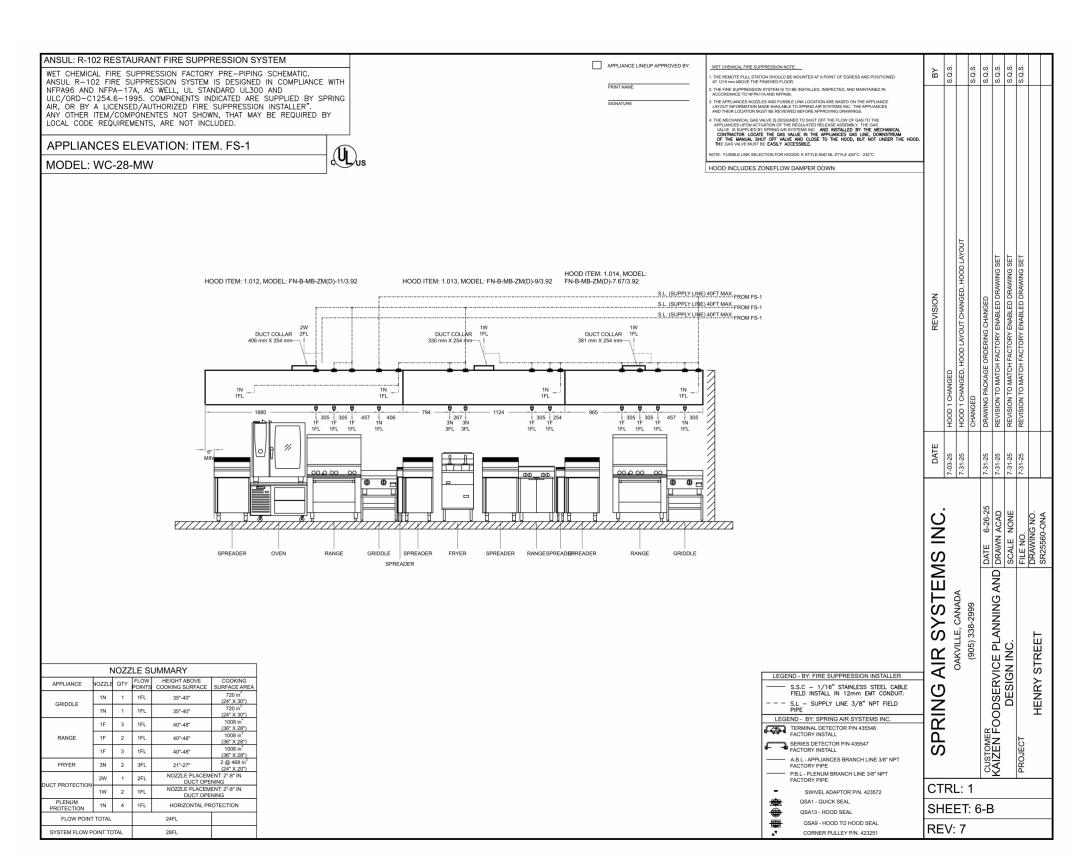
Exhaust Hood Details


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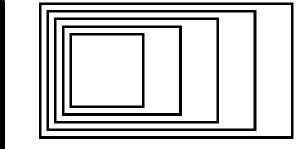
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Exhaust Hood Details & Wiring Diagrams


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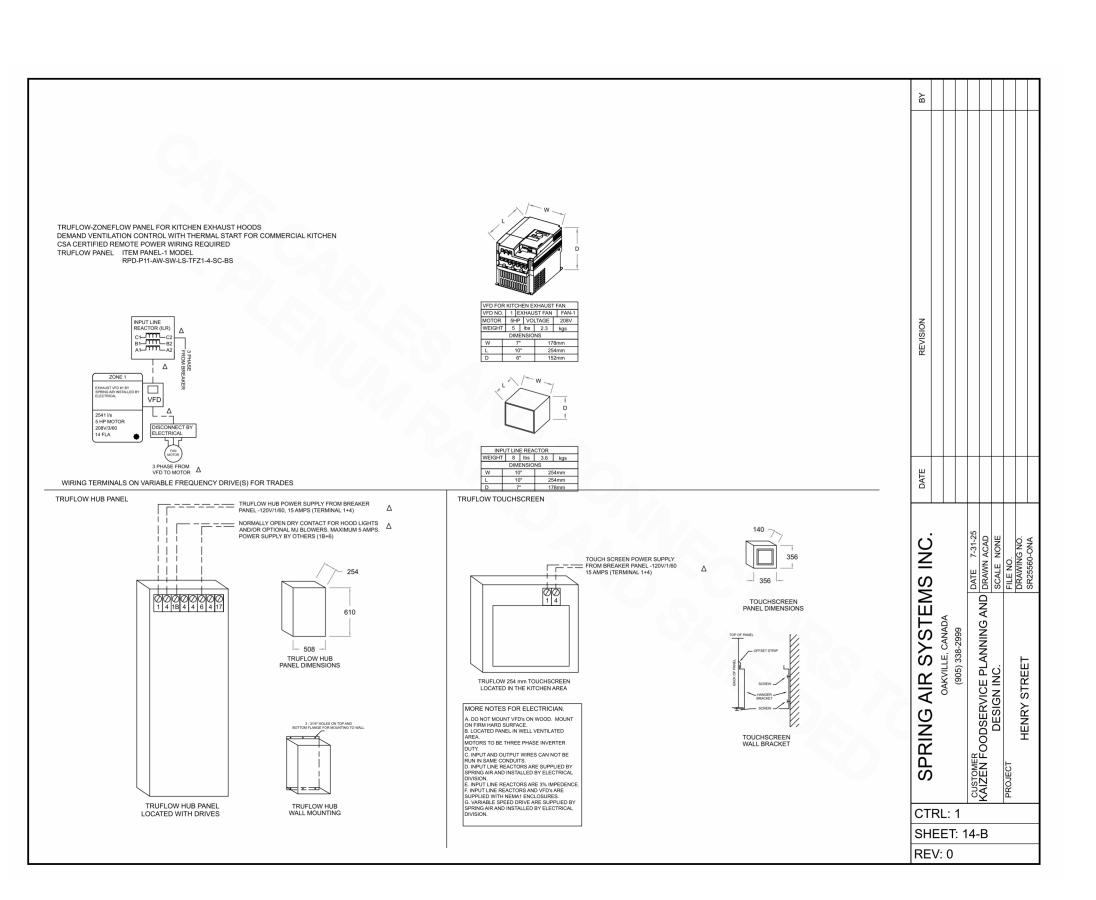
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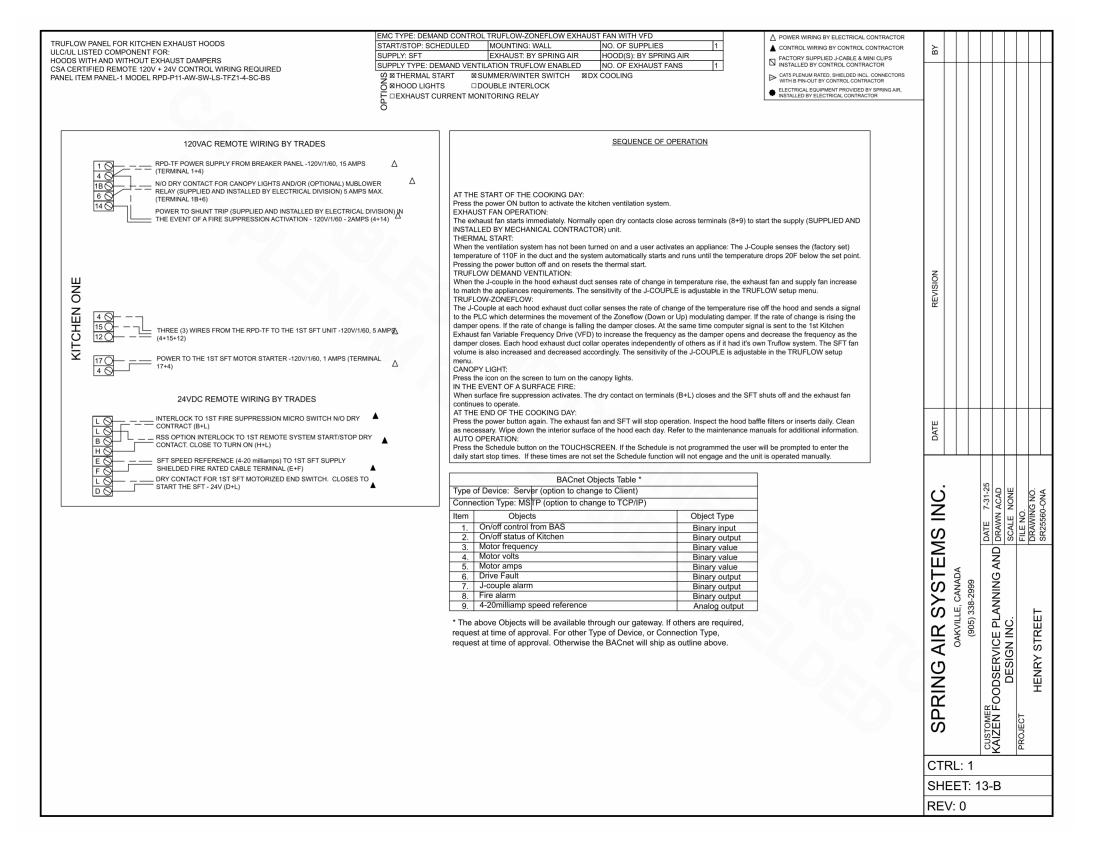
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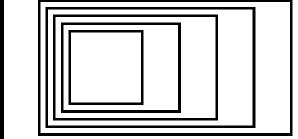
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ISSUED FOR PERMIT AND TENDER
ISSUED FOR 90% CD - CLIENT 10/09/2025 REVIEW

No. ISSUED/REVISED DATE

Henry St H.S. Culinary Classroom Renovation

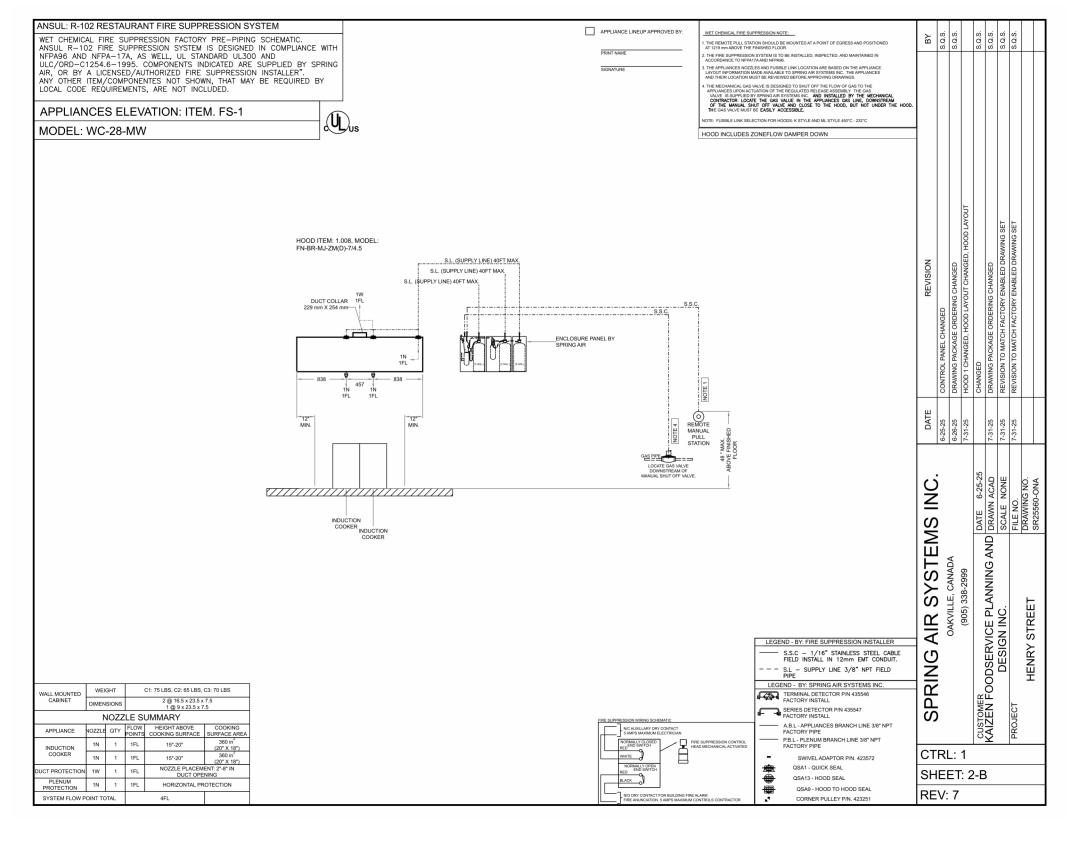600 Henry St, Whitby, ON L1N 1L4

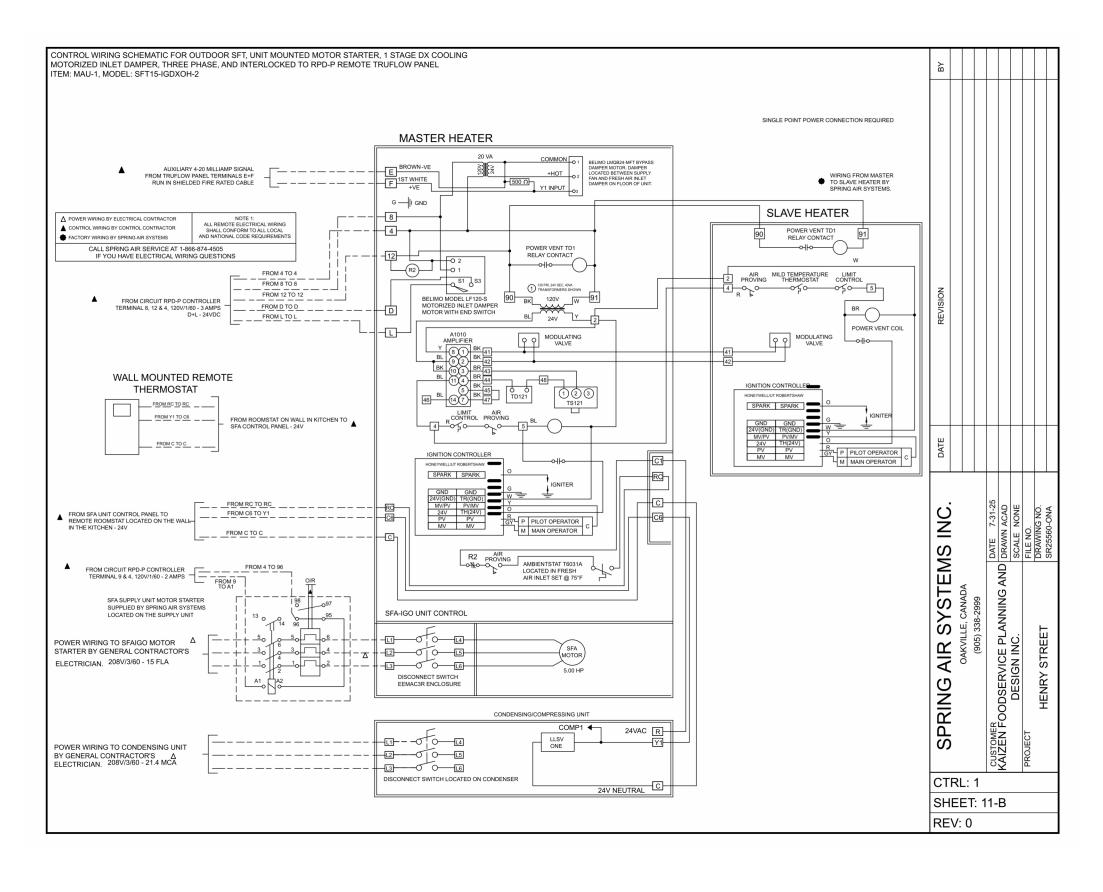
Mechanical Control Sequences

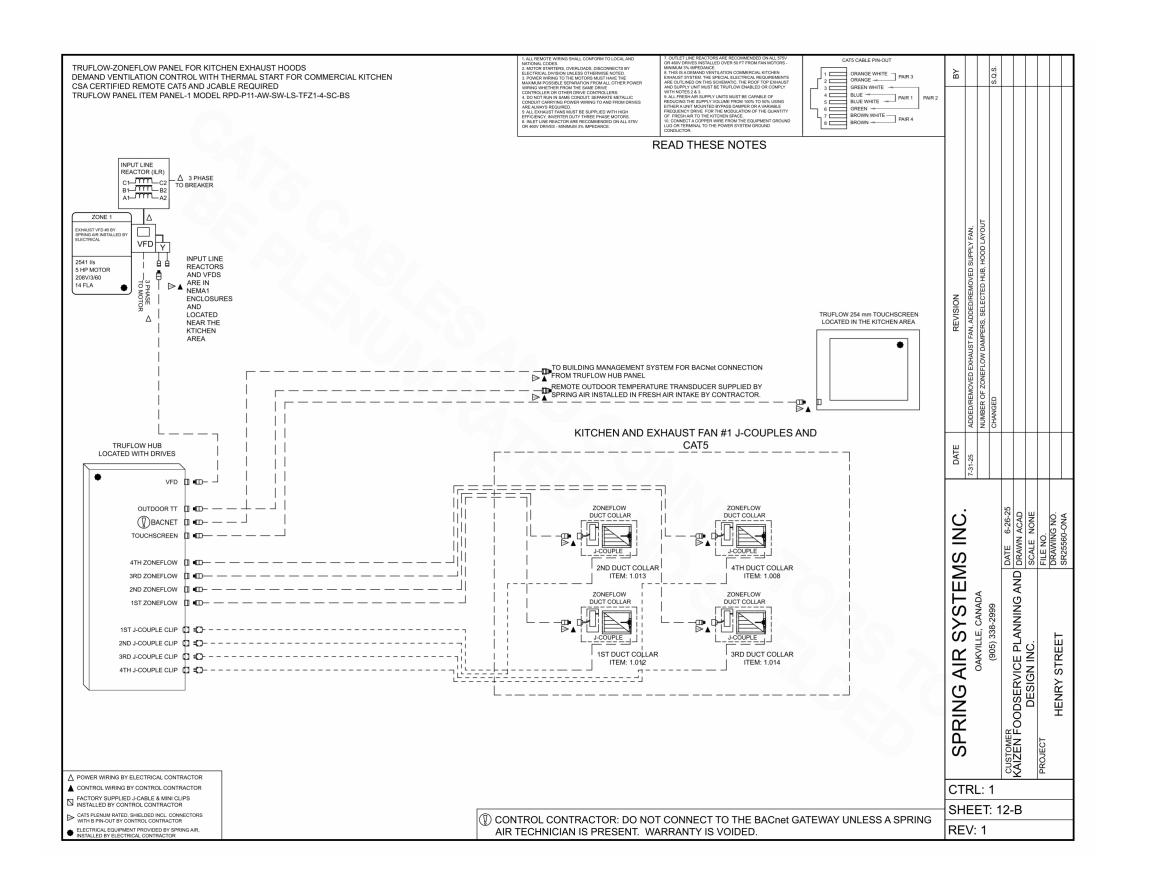Scale:

Project Number:
ED-25-052

Drawn By:
Chirag Khatri

Checked By:
A. Nakhaei-Zadeh

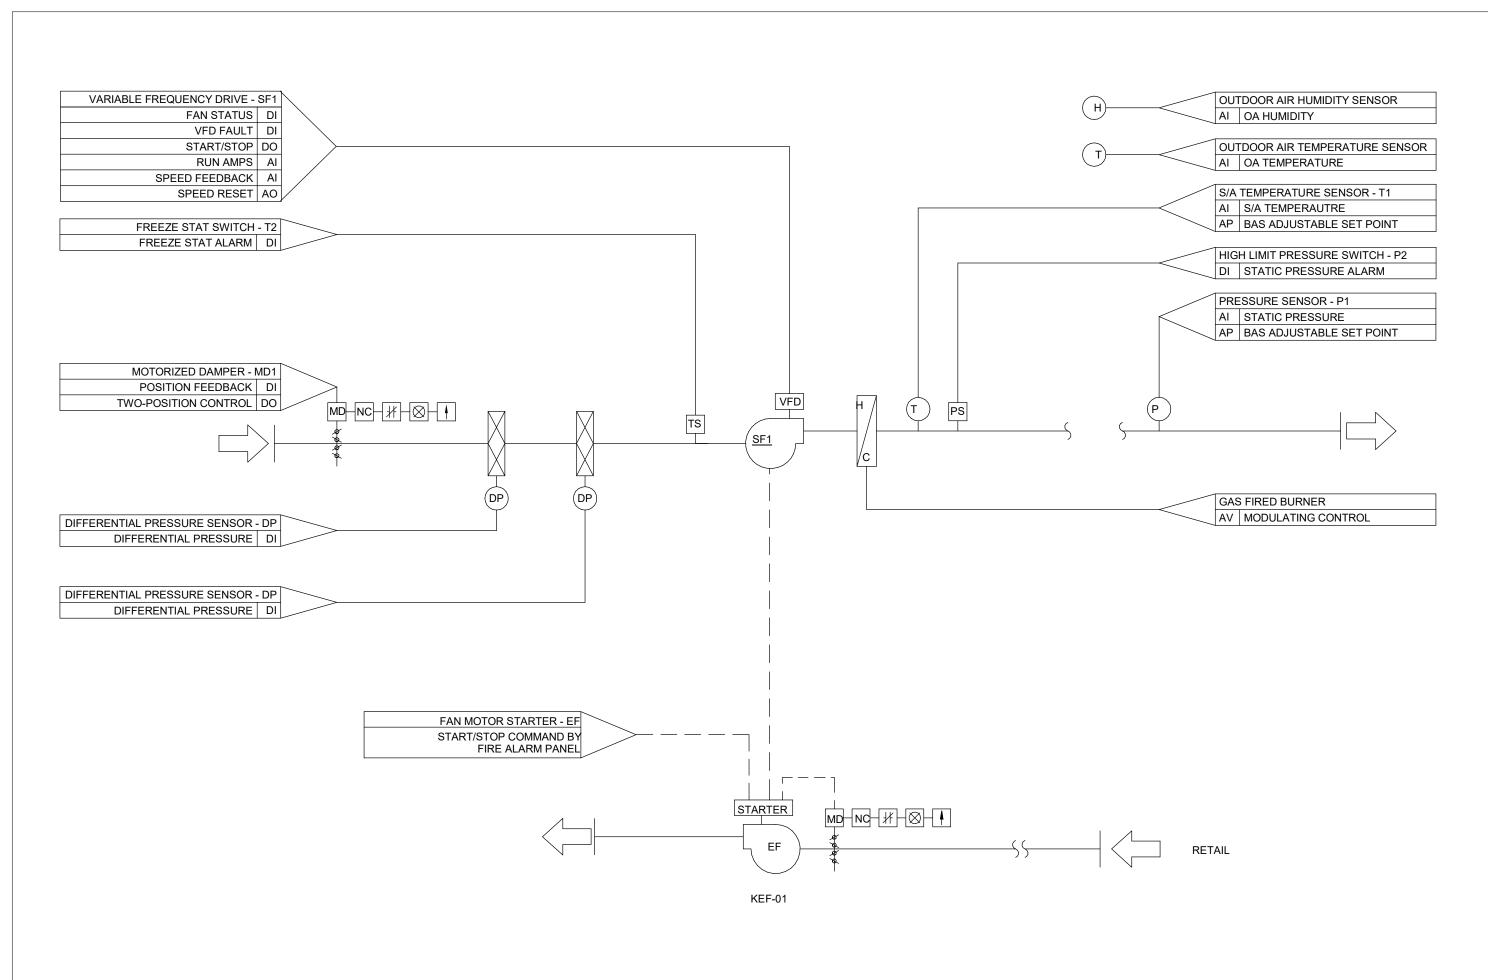

KITCHEN MAKEUP AIR UNIT AND EXHAUST FAN CONTROL SEQUENCE

MUA OPERATING MODE:

1. THE SYSTEM SHALL RUN CONTINUOUSLY ACCORDING TO 24 HOUR SCHEDULE.

MD1 SHALL BE NORMALLY CLOSED.

INITIAL SET UP: THE SYSTEM SHALL BE A 100% OUTDOOR AIR SYSTEM.

FAN SHALL BE BALANCED TO A FIELD DETERMINED AIRFLOW & STATIC PRESSURE AS PER THE VALUES INDICATED ON THE DRAWINGS DURING SYSTEM BALANCING AND COMMISSIONING.

DIFFERENTIAL PRESSURE SENSOR P1 SHALL BE LOCATED IN LOBBY. DIFFERENTIAL SETPOINT SHALL BE INITIALLY 5 Pa TO MINIMIZE STACK EFFECT.

VFD SPEED SHALL BE FIELD OPTIMIZED TO AVOID FAN (TORQUE AND CURRENT) STALL CONDITIONS AND SHALL NOT OPERATE BELOW 30% SPEED. 11. SYSTEM SHALL BE ENABLED BASED ON SCHEDULED OPERATING MODE

12. FAN SHALL BE ENABLED/DISABLED LOCALLY AT THE VFD OR REMOTELY THROUGH THE BAS.

ON COMMAND TO START MD1 SHALL OPEN. UPON PROOF OF MOTORIZED DAMPER POSITION, FAN SHALL BE ENABLED. MD1 SHALL BE INTERLOCKED WITH SF1 TO ENSURE CONTROLS OPERATION WHEN FAN IS OPERATING IN "HAND" OR "AUTO" MODE. CONTROLS SIGNAL SHALL BE DUPLICATED AT THE BAS.

SUPPLY FAN SHALL MODULATE TO MAINTAIN THE STATIC PRESSURE SET POINT DETERMINED BY P1. SUPPLY FAN RAMPING FUNCTION SHALL INCLUDE A DELAY TO ADDRESS CHANGES IN STATIC WHEN THE DOOR OPENS.

#### ECONOMIZER (FREE COOLING) CONTROL: 1. N/A

1. THE AIR HANDLING SYSTEM SHALL MAINTAIN THE FOLLOWING S/A TEMPERATURE SETPOINTS: • WINTER HEATING MODE: 24°C DRY BULB. O/A TEMPERATURE IS LESS THAN 18°C DRY BULB. (ADJ)

2. O/A TEMPERATURE IS GREATER THAN 22°C DRY BULB:

GAS FIRED BURNER SHALL BE DISABLED.

3. O/A TEMPERATURE LESS THAN 18°C (ADJ) DRY BULB:

 ACTIVATE GAS-FIRED BURNER AND MODULATE AS REQUIRED TO MAINTAIN SETPOINT. • WHEN SUPPLY TEMPERATURE IS IS 2°C ABOVE SETPOINT, AFTER A DELAY OF 10 MINUTES (ADJ.) THE BURNER

SHALL SHUT DOWN.

FIRE ALARM MODE:

1. FAN SHALL REMAIN OPERATIONAL DURING FIRE ALARM.

1. UPON SUPPLY FAN FAILURE THE FOLLOWING SHALL OCCUR:

MD1 SHALL BE CLOSED.

HIGH LIMIT DUCT STATIC PRESSURE SENSOR P2 AT THE SUPPLY AIR MAIN SHALL BE HARDWIRED INTERLOCKED WITH THE SUPPLY FAN . FAN WILL BE DISABLED WHEN P2 EXCEEDS 6 IN/WC.

FREEZE STAT T2 SHALL BE HARD WIRED INTERLOCKED WITH THE SUPPLY FAN AND DISABLE THE FAN WHEN T2 DROPS BELOW 4°C. FAN MUST BE MANUALLY RESET PRIOR TO RESTARTING. CLOSE ALL DAMPERS.

• THE AIR HANDLING SYSTEM SHALL RE-SET THE T1 SET POINT UPWARDS/DOWNWARDS WHEN A HEATING FLAG IS

 THE AIR HANDLING SYSTEM SHALL RE-SET THE T1 SET POINT UPWARDS BY 1°C EVERY 10 MINUTES WHEN A HEATING FLAG IS GENERATED.

THE T1 SET POINT SHALL CONTINUE TO RE-SET UNTIL THE HEATING FLAG IS CLEARED.

 HEATING FLAG SHALL HAVE THE ABILITY TO BE IGNORED/REMOVED FROM THE SYSTEM TO AVOID UNNECESSARY TEMPERATURE RE-SETS.

CONTROL WIRING

SYSTEM ALARMS & PRIORITY AT BAS:

 FAN FAILURE: COMMANDED ON/STATUS OFF FAN IN HAND: COMMANDED OFF/STATUS ON

 VFD FAILURE: FAULT CONTACT DAMPER FAILURE: COMMANDED OPEN/CLOSED FEEDBACK

 DAMPER IN HAND: COMMANDED CLOSED/OPEN FEEDBACK HIGH SUPPLY AIR TEMPERATURE: T1 IS GREATER THAN 28°C FOR MORE THAN 30 MINUTES

• LOW SUPPLY AIR TEMPERATURE: T1 IS LOWER THAN 10°C FOR MORE THAN 30 MINUTES

FREEZE STAT: T2 IS EQUAL TO OR LOWER THAN 4°C

SYSTEM TRENDS AT BAS: FAN STATUS

 VFD SPEED STATIC PRESSURE

EQUIPMENT OPERATING HOURS

 POSITION FEEDBACK TEMPERATURE SET POINT MODEL DCV-AV SEQUENCE OF OPERATION

#### DAILY STARTUP

1. WHEN SYSTEM IS FIRST STARTED A DAILY STARTUP ROUTINE WILL BE EXECUTED: A. ALL HOODS WILL COMMAND THEIR DAMPERS TO THEIR HOME POSITION.

B. THE EXHAUST FAN WILL BE STARTED AND RAMP TO 50% SPEED FOR 1 MINUTE. C. AFTER 1 MINUTE WARM-UP CYCLE THE HOODS WILL CONTROL DAMPERS TO DEMANDED AIRFLOW AND EXHAUST FAN WILL MODULATE TO MEET TOTAL AIRFLOW REQUIRED BY ALL

#### **FAN OPERATION**

1. EXHAUST FAN WILL START UNDER THE FOLLOWING CONDITIONS: A. HOOD TEMPERATURE EXCEEDS AMBIENT TEMPERATURE BY THE TEMPERATURE LOW LIMIT (TL) VALUE AS SET DURING SYSTEM COMMISSIONING.

B. THE FAN IS ACTUATED AT THE AIRVANTAGE TOUCHSCREEN. C. THE OVERRIDE BUTTON ON A HOOD IS PRESSED. D. AIRVANTAGE IS SCHEDULED TO RUN THE EXHAUST

E. THE REMOTE START IS ACTIVATED F. THE CONTROLLER BYPASS IS ACTIVATED

2. EXHAUST FAN WILL STOP WHEN THERE ARE NONE OF THE FOLLOWING: A. DEMAND AT ANY HOOD (AFTER 15 MINUTE DELAY)

C. MANUAL OR EXTERNAL COMMANDS

3. EXHAUST FAN WILL MODULATE BETWEEN MINIMUM SPEED AND MAXIMUM SPEED (AS SET DURING COMMISSIONING) ACCORDING TO THE AIRFLOW DEMAND AT EACH HOOD. 4. THE FOLLOWING SIGNALS WILL BE SENT TO EITHER THE BUILDING MANAGEMENT SYSTEM, AN

INDEPENDENT MAKEUP AIR UNIT CONTROLLER, OR THE MAKEUP AIR VFD FOR MAKEUP AIR A. A NORMALLY OPEN CONTACT TO PROVIDE A RUN SIGNAL FOR THE MAKEUP AIR.

i. RUN MAKEUP AIR SIGNAL WILL BE "ON" WHEN EXHAUST FAN IS RUNNING UNDER NORMAL CONDITIONS

ii. RUN MAKEUP AIR SIGNAL WILL BE "OFF" WHEN THE EXHAUST FAN IS NOT RUNNING OR IF THERE IS FIRE PROTECTION DISCHARGE. B. A BYPASS RUN HIGH SIGNAL FOR THE MAKEUP AIR (NORMALLY OPEN CONTACT CLOSURE). C. A 2-10V (4-20mA for VFD only) SIGNAL PROPORTIONAL TO THE EXHAUST FAN SPEED.

#### **HOOD OPERATION**

1. EACH HOOD SECTION WILL INDEPENDENTLY MODULATE AIRFLOW BASED ON DEMAND: A. MAXIMUM AIRFLOW SETPOINT WILL BE SET TO DESIGN AIRFLOW.

❖ FOR DIRECT OUTPUT TO AN ECM MOTOR THERE WILL ONLY BE A SINGLE 2-10V SIGNAL

B. MINIMUM AIRFLOW WILL BE SET TO 50% (ADJ) OF DESIGN AIRFLOW. C. DEMAND IS DETERMINED BY SENSIBLE HEAT LOAD AT THE CANOPY WHEN COMPARED

THE AMBIENT TEMPERATURE. 2. ALL HOOD SECTIONS WILL RETURN DAMPERS TO THEIR HOME POSITION (OPEN) WHEN THE

EXHAUST FAN IS STOPPED. 3. HOOD LIGHTING WILL ACTIVATE UNDER ANY OF THE FOLLOWING CONDITIONS:

A. WHEN THE FAN IS ON. B. WHEN THE HOOD OVERRIDE BUTTON IS PRESSED. C. WHEN THE LIGHTING FOR ALL HOODS IS ACTIVATED AT THE DCV COMMAND CENTER.

#### SYSTEM OVERRIDES

1. OVERRIDE CONDITIONS: A. THE OVERRIDE BUTTON IS PRESSED ON A HOOD SECTION, THAT SECTION WILL DEMAND

AIRFLOW FOR 5 MINUTES (ADJ), THEN RETURN TO NORMAL CONTROL. B. WHEN THERE IS A RAPID TEMPERATURE CHANGE DETECTED INSIDE A HOOD SECTION, THAT

SECTION WILL DEMAND MAXIMUM AIRFLOW FOR 5 MINUTES, THEN RETURN TO NORMAL C. WHEN THERE IS A FIRE PROTECTION DISCHARGE, THE EXHAUST FAN WILL RAMP TO 100%, ALL

HOOD DAMPERS WILL OPEN TO THEIR HOME POSITION TO PROVIDE MAXIMUM AIRFLOW. D. IF THE POWER CIRCUIT FAILS ON A HOOD SECTION DURING COOKING OPERATIONS, THE DAMPER WILL OPEN TO THE FACTORY-SET POSITION TO PROVIDE MAXIMUM EXHAUST AIRFLOW TO THE


COOKLINE. E. IF SYSTEM COMMUNICATION IS LOST TO A HOOD SECTION DURING COOKING OPERATIONS, THE DAMPER WILL OPEN TO THE FACTORY-SET POSITION TO PROVIDE MAXIMUM EXHAUST AIRFLOW

THE COOKLINE. F. MANUAL BYPASS COMMANDS ALL EXHAUST/MAKEUP AIR TO RUN AT MAXIMUM.

**BACNET VARIABLE** 

DESCRIPTION SYMBOL DESCRIPTION PRESSURE SWITCH SUPPLY FAN DIFFERENTIAL PRESSURE SWITCH DOOR SWITCH RETURN FAN ACTUATOR NORMALLY CLOSED DE-ENERGIZED POSITION ACTUATOR NORMALLY OPEN DE-ENERGIZED POSITION (EF , **EXHAUST FAN ACTUATOR FAIL OPEN POSITION** ACTUATOR FAIL CLOSED POSITION **HEATING COIL ACTUATOR FAIL LAST POSITION** TWO-POSITION ACTUATOR COOLING COIL MODULATING ACTUATOR PRESSURE SENSOR PRE-HEAT COIL DIFFERENTIAL PRESSURE SENSOR **VELOCITY SENSOR FILTERS** VELOCITY PRESSURE SENSOR **HUMIDITY SENSOR** AIRFLOW / FLUID DIRECTION TEMPERATURE SENSOR ₩₩ MOTORIZED DAMPER CARBON MONOXIDE SENSOR MANUAL ISOLATION DAMPER <del>-4444-</del> CARBON DIOXIDE SENSOR MOTOR CONTROL CENTRE DIESEL NITROGEN OXIDE SENSOR LOCAL DISPLAY UNIT **OXYGEN SENSOR** CONTROLLER MANUFACTURER SUPPLIED EQUIPMENT CONTROLLER AIRFLOW STATION STARTER MOTOR STARTER VISUAL INDICATOR ALARM VARIABLE FREQUENCY DRIVE AUDIBLE INDICATOR ALARM **BUILDING AUTOMATION SYSTEM** NO NORMALLY OPEN BAS NC NORMALLY CLOSED ANALOG INPUT NORMALLY CLOSED CONTACT ANALOG OUTPUT FLOW SWITCH DIGITAL INPUT LEVEL SWITCH DO DIGITAL OUTPUT TEMPERATURE SWITCH BAS ADJUSTABLE SET POINT

CONTROLS

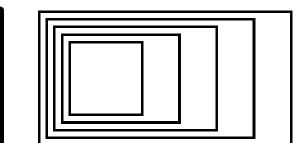

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Henry St H.S. Culinary Classroom Renovation

600 Henry St, Whitby, ON L1N 1L4

**Mechanical Control** Sequences

Scale: As indicated Project Number: ED-25-052 Chirag Khatri Checked By:

A. Nakhaei-Zadeh

TAG         MANUFACTURER         MODEL         DESCRIPTION         VOLUME CONTROL (mm x mm)         SIZE (mm x mm)         FINISH         MATERIAL         NOTES           A         EH PRICE         SPD         SQUARE PLAQUE         YES         600x600         -         STEEL         1,2,3,4,5,6           B         EH PRICE         80 DAL         EGG CRATE FACE         YES         600X300         -         ALUMINUM         1,2,3,4,5,6           C         EH PRICE         90         HEAVY DUTY RETURN         YES         700X600         -         STEEL         1,2,3,4,5,6           D         EH PRICE         630         LOUVERED GRILLE W/         YES         600X400         -         STEEL	GRILLES AND DIFFUSERS											
B         EH PRICE         80 DAL         EGG CRATE FACE         YES         600X300         -         ALUMINUM         1,2,3,4,5,6           C         EH PRICE         90         HEAVY DUTY RETURN         YES         700X600         -         STEEL         1,2,3,4,5,6           D         EH PRICE         630         LOUVERED GRILLE W/         YES         600X400         -         STEEL	TAG	MANUFACTURER	MODEL	DESCRIPTION	VOLUME CONTROL	-	FINISH	MATERIAL	NOTES			
C         EH PRICE         90         HEAVY DUTY RETURN         YES         700X600         -         STEEL         1,2,3,4,5,6           D         EH PRICE         630         LOUVERED GRILLE W/         YES         600X400         -         STEEL	Α	EH PRICE	SPD	SQUARE PLAQUE	YES	600x600	-	STEEL	1,2,3,4,5,6			
D EH PRICE 630 LOUVERED GRILLE W/ YES 600X400 - STEEL	В	EH PRICE	80 DAL	EGG CRATE FACE	YES	600X300	-	ALUMINUM	1,2,3,4,5,6			
	С	EH PRICE	90	HEAVY DUTY RETURN	YES	700X600	-	STEEL	1,2,3,4,5,6			
D	D	EH PRICE	630	LOUVERED GRILLE W/	YES	600X400	-	STEEL				
D1 EH PRICE 630 LOUVERED GRILLE W/ YES 150X150 STEEL	D1	EH PRICE	630	LOUVERED GRILLE W/	YES	150X150		STEEL				

ALL DIFFUSER AND GRILLE FRAMES SHALL SUIT CEILING CONSTRUCTION.
 ALL DAMPERS SHALL BE OF THE SAME MATERIAL AS THE DIFFUSER OR GRILLE.
 REFER TO ARCHITECTURAL DRAWINGS FOR CEILING CONSTRUCTION.
 DIFFUSERS IN DRYWALL CEILING TO BE C/W ADAPTOR FRAME TO ACCOMODATE INSTALLATION. DIFFUSER ADAPTOR FRAME SHALL BE OF THE SAME MATERIAL AS THE DIFFUSER.
 GRILLE AND DIFFUSER COLOUR TO BE B12 WHITE OR AS SPECIFIED BY THE ARCHITECT
 NECK SIZE AS SHOWN ON PLANS.

7. HINGED GRILLE C/W WING HEAD QUICK RELEASE FASTENERS. 8. BLADE ORIENTATION TO BE HORIZONTAL.


	MAKE-UP AIR UNITS																		
TAG				AIR CHARACTERISTICS HEATING CAPACITY	FLUID CHARACTERISTICS	POWER REQUIREMENTS							NOTES						
IAG	LOCATION	SLITTIGE	MANO ACTORER	WODEL	AIRFLOW (L/s)	ESP (kPa)	EAT (°C)	LAT (°C)	(kW)	FLUID	FILTER	FLA (A)	MCA (A)	MOCP (A)	VOLT. (V)	PH. (ტ)	FREQ.	WEIGHT (kg)	NOTES
MAU-1	ROOF	CLASSROOM	SPRING AIR SYSTEMS	SFT15-IGDXO H-2	<u> </u>	0.40	-18.9	28.9	132	NATURAL GAS	MERV-10	0.0	21.4	0.0	208	3	60	90	

MAKEUP AIR UNIT - COOLING COILS												
COOLING COIL	MAU TAG	MANUFACURER	CAPA	ACITY		AIR CH	FLUID CHARACTERISTICS	NOTES				
	WAU TAG	WANUFACURER	TOTAL (kW)	SENSIBLE (kW)	AIRFLOW (L/s)	P.D. (Pa)	EAT DB (°C)	EAT WB (°C)	LAT DB (°C)	FLUID TYPE	NOTES	
	MAU-1	SPRING AIR SYSTEMS	18	0	2032	149	28.9	22.2	23.9	R-454B		

					GREASE IN	TERCEPTORS	6			
TAG	AG MANUFACTURER MODEL		SERVICE	LOCATION	FLOW RATE (L/s)	MAX GREASE CAPACITY (kg)	LENGTH (mm)	WIDTH (mm)	HEIGHT (mm)	NOTES
GI-1	ZURN	Z1173-RD	KITCHEN 3 COMP. SINK AND DW	CLASSROOM, 1106	246.0	68.00 kg	935	727	578	

										FANS									
TAG	MANUFACTURER					AIRFLOW	AIRFLOW	E.S.P.	FAN				WEIGHT						
		MODEL	TYPE	SERVICE	LOCATION	CONNECTED (L/s)	TOTAL (L/s)	(kPa)	RPM	VFD	MOTOR POWER (HP)	FLA	MCA	MOCP	VOLT.(V)	РН.(φ)	FREQ.(Hz)	(KG)	REMARKS
EF-2	REVERSOMATIC	TLD200	INLINE	DRYER EXH	CLOSET 1106B	71	85	0.05	2500	N	0.00	0.0	0	0	0	0	0	0	
EF-1100	GREENHECK	SQ-60	INLINE	AV ROOM	CLOSET 1106B	14	24	0.06	1300	N	0.01	0.0	0	0	120	1	60	13	C/W 400mm VIBRATION ISOLATORS
KEF-01	SPRING AIR SYSTEMS	XF-B2365	UPBLAST	KITCHEN EXH	ROOF	2500	2541	0.65	860	Y	5.00	16.7	0	0	208	3	60	191	C/W CURB AND HINGE KIT


	DX SPLIT AIR CONDITIONER SCHEDULE																		
			CAPAC	ITY (Kw)			EVAPO	RATOR			CONDENSER		ELECTRIC	CAL - EVAP	ORATOR	ELECTR	ICAL - CON	DENSER	
TAG	MANUF.	SERVICE	TOTAL	SENSIBLE	REFRIGERANT	MODEL	TYPE	LOCATION	AIRFLOW (L/s) (H/M/L)	MODEL	LOCATION	AMBIENT TEMP. (°C)	V/PH/HZ	MCA	MOP	V/PH/HZ	MCA	MOP	NOTES
FCU-1106/ CU-1106	DAIKIN	CLASSROOM 1106	10.5		R-32	FXFA36AAVJU	CEILING MOUNT	CLASSROOM 1106	591/433/317	RXTA36AAVJU	ROOF	32.2	208/1/60	-	15	208/1/60	19.8	20	

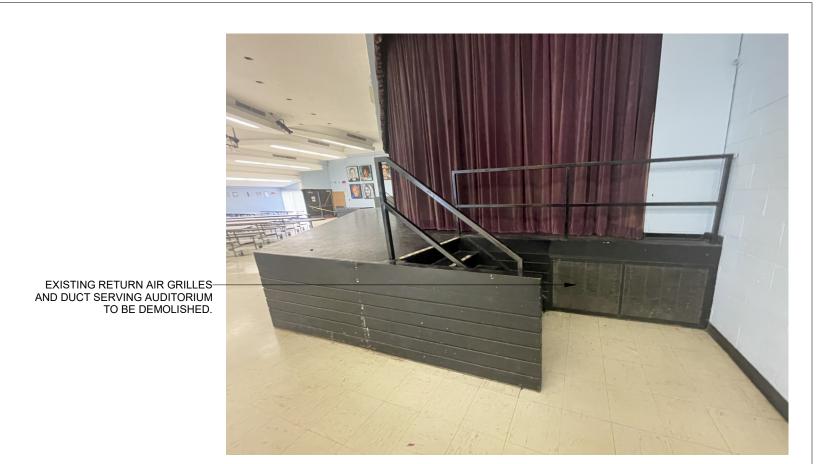





EXISTING DRINKING FOUNTAIN AND FIREHOSE CABINET

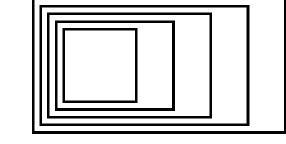

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600 Henry St, Whitby, ON L1N 1L4

**Mechanical Equipment** Schedules


Scale: N.T.S. Project Number: ED-25-052 Drawn By: Chirag Khatri

Checked By: A. Nakhaei-Zadeh

						CTRICAL			DILIAB	MEP SCHEDULE - NEW EQUIPMENT  G MECHANICAL											
					EL	ECTRICAL		wa	PLUMBI	NG	GAS			HVAC EXHA		ECHANIC	AL	MΔ	AKE-UP AIR		
ITEM NO.	QTY.	DESCRIPTION Equip	ment Remarks	MPS	VOLTS	CYCLE CONN.	CW SIZE	/ SIZE	lirect	PLUMBING REMARKS	GONSUMP. B	MECHANICAL REMARKS	DEPTH VENT WIDTH	VENT DIA.	VOLUME	S.P.	VENT	_	VENT DIA.	S.P.	HVAC REMARKS
1.000	1	Hand Sink		Ā	> 4	δδ		13 mm 38		ō	<u> </u>	>	> 0 > 5	>	>	. S.	> Δ	> \$	> >	ν <sub></sub>	
1.001 1.001A	1 1	S.S. CLEAN DISHTABLE S.S. Wall Shelving																			
1.003	1	S.S. DISHTABLE W/THREE SINKS					19 mm	19 mm 51	mm	ADD'L 3/4"(19mm) HW+CW & 2@2" (50mm) DIRECT DRAIN TO G.T.											
1.003A 1.004	1 2	S.S. Sorting Shelf, Wall Mount WASTE BIN W/ DOLLY																			
1.006 1.008	1	SHELVING, MOBILE 24"x60" EXHAUST HOOD		5.92 A	120 1	60 DIRECT						25	54 mm 229 mm	า	426 L/s	0.190 kPa					REFER TO DRAWING SERIES QF-400 FOR DETAIL DRAWINGS
1.008A	1	FIRE SUPRESSION CABINET		5.00 A	120 1	60 DIRECT										Ki u					TON DETAIL DIVAWINGS
1.009	2	SHELVING, MOBILE 24"x48"																			
1.010 1.011	4	s.s.wall s.s skeleton wall		20.0	120 1	60 PLUG															
1.012	1	EXHAUST HOOD		0.38 A	120 1	60 DIRECT						2!	54 mm   406 mm	1	763 L/s	0.140 kPa	203 mm 8	313 mm	69	•	2X EXHAUST & SUPPLY COLLAR. REFER TO DRAWING SERIES QF-400 FOR DETAIL DRAWINGS
1.012A	1	FIRE SUPRESSION CABINET		5.00 A	120 1	60 DIRECT															
1.013	2	EXHAUST HOOD		0.38 A	120 1	60 DIRECT						25	54 mm   330 mm	1	624 L/s	0.140 kPa	203 mm 7	711 mm	56	•	2X EXHAUST & SUPPLY COLLAR. REFER TO DRAWING SERIES QF-400 FOR DETAIL DRAWINGS
1.014	1	EXHAUST HOOD		0.25 A	120 1	60 DIRECT						25	54 mm 381 mm	1	775 L/s	0.160 kPa	203 mm 4	106 mm	65		2X EXHAUST & SUPPLY COLLAR. REFER TO DRAWING SERIES QF-40 FOR DETAIL DRAWINGS
1.015	4	S.S. PREP TABLE		12.0	120 1	60 PLUG															
1.016	1	S.S. WALL PANEL HOOD																			
1.017	1	HOLDING CABINET - FULL SIZE		8.50 A	208 1	60 PLUG															
1.017A		S.S. HOOD ENCLOSURE PANEL					1.0	10 10													
1.018		Undermount Sink						13 mm 13													
1.019	1	S.S. TABLE W/TWO SINKS		12.00 A	120 1	60 PLUG	13 mm	13 mm	38 mr	n ADD'L 1 1/2"(38mm) INDIRECT DRAIN REQ'D TO F.S.											
1.019A 1.020	1	S.S. Wall Shelving S.S.TABLE W/HAND SINK		12.0	120 1	60 PLUG	13 mm	13 mm 38	mm												
1.020A 1.021	1 1	S.S. Wall Shelving SHELVING, MOBILE 24"x54"																			
1.023	1	S.S. HOOD ENCLOSURE PANEL																			
1.024 1.025 1.026	1 1 1	Cart, Utility S.S. HOOD ENCLOSURE PANEL stacked washer/dryer		30.0	120 1	60 PLUG	10 mm	10 mm	51 mr	m TO F.S.											
									MEP	 SCHEDULE - OWNER SUPPLIED	EQUIPMENT										
					EL	ECTRICAL		wa	PLUMBI iste	NG	GAS			HVAC EXHA		ECHANIC	AL	NAA	AKE-UP AIR		
ITEM NO.	QTY.	DESCRIPTION Equip	ment Remarks	AMPS	/OLTS	CYCLE CONN.	CW SIZE	HW SIZE	ndirect	PLUMBING REMARKS	GONSUMP.	MECHANICAL REMARKS	DEPTH VENT	VENT DIA.	/OLUME	S.P.	VENT	_	VENT DIA.	S.P.	HVAC REMARKS
R.000	1	Reach-in SOLID Door Refrigerator		8.50 A	120 1	60 PLUG															
R.001	1	Reach-in SOLID Door FREEZER		12.0	120 1	60 PLUG															
R.002	2	Refrigerator, Undercounter		3.50 A	120 1	60 Plug															
R.003	1	INDUCTION COOKER		38.9	208 3	60 DIRECT	-														
R.004	12	S.S. PREP TABLE		12.0	120 1	60 PLUG															
R.005	1	MASTER ELECTRICAL CONVECTION OVEN EASYTOUCH SCREEN CONTROL		50.00 A	208 1	50 DIRECT	-														
R.006	2	60" Range - 6 Burners 24" Griddle Broiler - 2 Standard Ovens								1	19 mm 276,000 Btu/h										
R.007	1	Hot PLates - Gas								1	120,000 Btu/h										
R.008	1	FRYER DUAL TANK							32 mm	1	13 mm 120,000 Btu/h										
R.010 R.011	1	WORK TABLE STAINLESS STEEL EQUIPMENT STAND			225																
R.012	⊥1	Dishwasher		27.0	208 3	60 DIRECT	19 mm	1	1		I				Ì	1	1				1

60 DIRECT 19 mm

Dishwasher

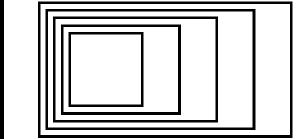

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1 ISSUED FOR PERMIT AND 10/31/2025 TENDER

No. ISSUED/REVISED DATE

Henry St H.S. Culinary Classroom Renovation

600 Henry St, Whitby, ON L1N 1L4

Kitchen Equipment Schedules

Scale:

Scale:

Project Number:
ED-25-052

Drawn By:
Author

Checked By:
Checker