CVM45.0:	ELECTRICAL LEGEND
SYMBOL	DESCRIPTION DETAIL REFERENCES
1	SHEET KEYNOTE
$\frac{\square}{\bigwedge}$	REVISION NUMBER
<u>/ </u>	LINETYPES
	NEW WORK
	WORK TO BE DEMOLISHED, OR REMOVED
	EXISTING MATERIAL/EQUIPMENT/SERVICES TO REMAIN
	FUTURE WORK (NOT IN SCOPE)
	EXTENTS OF FIRE ALARM ZONE, WET LOCATION, OR OTHER AREA AS NOTED ON PLANS
	ABBREVIATIONS
E R	EXISTING TO REMAIN EXISTING TO BE DEMOLISHED/REMOVED
ER	EXISTING IN RELOCATED POSITION
RR	REMOVE AND RELOCATE
C W	CEILING MOUNTED CONNECTION WALL MOUNTED CONNECTION
F	FLOOR MOUNTED CONNECTION
ŧ.	CENTRE LINE
AFF	ABOVE FINISHED FLOOR
AFG O/C	ABOVE FINISHED GRADE OVER COUNTER
U/C	UNDER CABINET
U/F	UNDER RAISED FLOOR
ССТ	CIRCUIT
CTE	CONNECT TO EXISTING
AFCI GFCI	ARC FAULT CIRCUIT INTERRUPTER GROUND FAULT CIRCUIT INTERRUPTER
GFI	GROUND FAULT INTERRUPTER
G	ISOLATED GROUND
TL	TWIST LOCK
TR WG	TAMPER RESISTANT WIRE GUARD
WP	WEATHER PROOF
XP	EXPLOSION PROOF
R/I NIC	ROUGH-IN ONLY NOT IN CONTRACT
SIM.	SIMILAR TO
TYP.	TYPICAL
	APPRELIATIONS CORES AND STANDARDS
OBC	ABBREVIATIONS - CODES AND STANDARDS ONTARIO BUILDING CODE
OESC	ONTARIO ELECTRICAL SAFETY CODE
OFC	ONTARIO FIRE CODE
ACT	ABBREVIATIONS - CEILING TYPES
EXP	ACOUSTIC CEILING TILE (T-BAR) EXPOSED CEILING
OWSJ	OPEN WEB STEEL JOISTS
PCC	PAINTED OR POPCORN CEILING ON EXPOSED
WD	CONCRETE WOOD CEILING
VVD	ANNOTATIONS
CL	CLOSET
WR	WASHROOM
PTP	PLUMBING ELECTRONIC TRAP PRIMER
PSC	PLUMBING SENSOR CONTROL (TOUCHLESS FAUCETS)
	HVAC
<u> </u>	THERMOSTAT OR TEMPERATURE SENSOR
T BBH	TIMER CONTROL ELECTRIC BASEBOARD HEATER (BBH)
FFH	FORCED FLOW HEATER
ERV	ENERGY RECOVERY VENTILATOR
HRU	HEAT RECOVERY UNIT
MUA	MAKE-UP AIR UNIT CONDUIT AND BOXES
	CONDUIT WITH END BUSHING
	CONDUIT UP
	CONDUIT DOWN
	CONDUIT CONTINUES
JB	JUNCTION BOX
	PULL BOX
РВ	HAND HOLE
_	
=	CONNECTIONS TO EQUIPMENT
нн	CONNECTIONS TO EQUIPMENT DISHWASHER
DW FR	DISHWASHER FRIDGE
DW FR MW	DISHWASHER FRIDGE MICROWAVE
DW FR MW	DISHWASHER FRIDGE MICROWAVE HAND DRYER. ALLOW UP TO 208V-1PH-20A
PB HH DW FR MW HD	DISHWASHER FRIDGE MICROWAVE

	ELECTRICAL LEGEND		ELECTRICAL LEGEND
			1
SYMBOL	DESCRIPTION SYSTEM FURNITURE WALL FEED FOR POWER AND TELECOMMUNICATIONS UNLESS NOTED OTHERWISE	SYMBOL	DESCRIPTION SPECIAL RECEPTACLE. VERIFY OUTLET REQUIREMENTS PRIOR TO ROUGH-IN.
X	'C' ADJACENT TO SYMBOL DENOTES CEILING FEED, 'F' ADJACENT TO SYMBOL DENOTES FLOOR FEED.	•	SPECIAL RECEPTACLE. VERIFY OUTLET REQUIREMENTS PRIOR TO ROUGH-IN.
W	ADJACENT TO 3-PHASE DIRECT CONNECTION, DENOTES WALL SYSTEM FURNITURE FEED FOR POWER AND COMMUNICATIONS.	*	FLOOR RECEPTACLE OR RECEPTACLE IN FLOOR BOX (POWER ONLY)
9	CONNECTION TO SINGLE PHASE MOTOR, HP (KW) AS NOTED. PROVIDE LOCAL DISCONNECT.	B	SERVICE POLE. PROVIDE POWER TO JUNCTION BOX I CEILING SPACE ABOVE. DEVICES ON POLE AS NOTED ON PLANS.
	THREE PHASE MOTOR, HP (KW) AS NOTED. PROVIDE LOCAL DISCONNECT.	FB1	ADJACENT TO FLOOR RECEPTACLE, DENOTES FLOOF BOX TYPE
REFER T	LIGHTING CONTROLS O SPECIFICATIONS AND RESPECTIVE SCHEDULES FOR EXACT REQUIREMENTS	*	ADJACENT TO DEVICE, DENOTES DEVICE CONNECTED TO EMERGENCY POWER
₩ 3W	SWITCH OR OTHER USER INTERFACE DEVICE AS DESCRIBED ON LIGHTING CONTROLS SCHEDULE. 3-WAY SWITCH		LIGHTING FIXTURES IN ACCORDANCE WITH IES DG-3-00 AND IES HB-10-11 WHERE NOT DETAILED OTHERWISE HERE. LIGHTING FIXTURE SCHEDULE FOR FURTHER DETAILS
DIM	ADJACENT TO SWITCH, DENOTES DIMMING SWITCH.	REFER TO	AND EXACT FIXTURE REQUIREMENTS.
K -	ADJACENT TO SWITCH, DENOTES KEY SWITCH. ADJACENT TO SWITCH, DENOTES COUNTDOWN TIMER		LINEAR LUMINAIRE, SURFACE MOUNTED TO CEILING LINEAR LUMINAIRE, RECESSED IN CEILING
T	SWITCH ADJACENT TO SWITCH, DENOTES ASTRONOMICAL		LINEAR LUMINAIRE, SUSPENDED: PENDANT, CHAIN, STEM, OR AIRCRAFT CABLE HUNG TO SUIT
AT DS	TIMER SWITCH	• •	APPLICATION, OR AS NOTED IN SCHEDULE. "X", WHEN USED DENOTES POWER FEED LOCATION.
DS PIR	ADJACENT TO SWITCH, DENOTES DOOR SWITCH PASSIVE INFRARED SENSOR		LINEAR LUMINAIRE, WALL MOUNTED
DT	DUAL TECHNOLOGY SENSOR		
UT	ULTRASONIC SENSOR		AS ABOVE, CONNECTED TO EMERGENCY OR NIGHT
os	SENSOR (TYPE UNKNOWN)		LIGHTING CIRCUIT AS INDICATED.
M	ADJACENT TO SWITCH, DENOTES MASTER CONTROL FOR ALL LUMINAIRES IN A ROOM OR SPACE, OR AS NOTED.	OØ	ROUND OR SQUARE DOWNLIGHT, RECESSED
	WALL MOUNTED SWITCH/OCCUPANCY SENSOR. PIR	2	RECESSED DOWNLIGHTS, CONNECTED TO EMERGENCY OR NIGHT LIGHT CIRCUIT
ю<)	DENOTES 'PASSIVE INFRARED', DT DENOTES 'DUAL PASSIVE INFRARED/ULTRASONIC'. LINE VOLTAGE TO	•	ROUND SUSPENDED LUMINAIRE
	SUIT CONTROLLED CIRCUIT, OR AS NOTED.	₽ № 全	WALL SCONCE OR OTHER WALL MOUNTED
RP PP	RELAY PANEL POWER PACK		LUMINAIRES. CONNECTED TO EMERGENCY NIGHT LIGHT CIRCUIT
sc	SCENE CONTROLLER.	EM	(24 HOUR)
P	PHOTOCELL SENSOR.	CE	CONNECTED TO EMERGENCY CIRCUIT. PROVIDE CUL 924 LISTED SHUNT TRIP RELAY OR EQUAL TO PERMIT
<u> </u>	PHOTOCELL SENSOR. 'PC' DENOTES CLOSED LOOP PHOTOCELL CONTROL, 'PO' DENOTES OPEN LOOP PHOTOCELL CONTROL		CONTROL OF LUMINAIRE WITH ZONING BASED ON LOCAL LIGHTING CONTROLS. LUMINAIRE CONNECTED TO NON-EMERGENCY NIGHT
	CEILING MOUNTED OCCUPANCY SENSOR. PIR	NL A, B, Z1,	LIGHT CIRCUIT (24 HOUR) DENOTES ZONING/CIRCUTING ASSIGNMENTS FOR
	DENOTES 'PASSIVE INFRARED', UT DENOTES 'ULTRASONIC' (OR MICROPHONIC), DT DENOTES 'DUAL TECHNOLOGY'. 'OS' DENOTES UNKNOWN	Z2, ETC.	LUMINAIRES AND CONTROLS IN THE SAME SPACE.
⊕ ₽	TECHNOLOGY.	REFER TO E	EMERGENCY LIGHTING EMERGENCY LIGHTING FIXTURE SCHEDULE FOR EXACT FIXTURE REQUIREMENTS.
ΦΦ	WALL MOUNTED OCCUPANCY SENSOR. DISTRIBUTION EQUIPMENT	⊠ ⊠ ⊬⊗	CEILING OR WALL MOUNTED ILLUMINATED EXIT SIGN. SHADED AREA INDICATES ILLUMINATED FACE. PROVIDE DIRECTIONAL ARROWS AS INDICATED ON
\boxtimes	TRANSFORMER, PLAN VIEW		PLANS. CEILING OR WALL MOUNTED ILLUMINATED EXIT SIGN.
	SURFACE MOUNTED LIGHTING AND RECEPTACLE PANELBOARD		SHADED AREA INDICATES ILLUMINATED FACE. PROVIDE DIRECTIONAL ARROWS AS INDICATED ON PLANS.
	RECESSED RECEPTACLE AND LIGHTING PANELBOARD	SL	DENOTES 'SELF-LUMINOUS' EXIT SIGN
	DISTRIBUTION PANELBOARD	PL	PHOTOLUMINOUS EXIT SIGN
ㅁ	DISCONNECT SWITCH		EMERGENCY LIGHTING BATTERY UNIT, WITH AND WITHOUT HEADS.
<u> </u>	FUSED DISCONNECT SWITCH	→ • • •	ONE AND TWO HEAD WALL MOUNTED EMERGENCY LIGHTING REMOTE UNITS.
С	CONTACTOR LOOSE STARTER, COORDINATE STARTING	· · ·	ONE AND TWO HEAD CEILING MOUNTED EMERGENCY LIGHTING REMOTE UNITS.
	CHARACTERISTIC WITH EQUIPMENT REQUIREMENTS.	•	RECESSED EMERGENCY REMOTE HEAD.
₩	COMBINATION STARTER.	EM	DENOTES 'EMERGENCY"
VFD	ADJACENT TO STARTER, DENOTES VARIABLE FREQUENCY DRIVE	CCT	CORRELATED COLOUR TEMPERATURE COLOUR RENDERING INDEX
	POWER RECEPTACLES AND BOXES	OIVI	EXTERIOR LIGHTING
0	120V U-GROUND DUPLEX RECEPTACLE.	^	ARM MOUNTED LUMINAIRE ON POLE. DIRECTIONAL ARROW, WHERE INDICATED DENOTES PRIMARY
\Phi	120V U-GROUND DUPLEX RECEPTACLE MOUNTED ABOVE COUNTER TOP OR AS INSTRUCTED ON SITE.	- ≏	LUMEN ORIENTATION.
=	120V U-GROUND 20A DUPLEX RECEPTACLE.	()>	POST TOP LUMINAIRE ON POLE. DIRECTIONAL ARROW, WHERE INDICATED DENOTES PRIMARY
•	120V U-GROUND DUPLEX RECEPTACLE MOUNTED ABOVE COUNTER TOP OR AS INSTRUCTED ON SITE.		LUMEN ORIENTATION. LIGHTING BOLLARD, DIRECTIONAL ARROW, WHERE
\	120V U-GROUND DUPLEX RECEPTACLE - AUTOMATICALLY CONTROLLED (ASHRAE 90.1-2013, 8.4.2).	ත හ	INDICATED DENOTES PRIMARY LUMEN ORIENTATION GROUND MOUNTED FLOOD LIGHT
*	120V U-GROUND 20A DUPLEX RECEPTACLE - AUTOMATICALLY CONTROLLED (ASHRAE 90.1-2013,		TELECOMMUNICATIONS SYSTEM FURNITURE FEED.
I .	8.4.2). 120V U-GROUND DUPLEX RECEPTACLE - HALF OF		ADJACENT TO SYSTEM FURNITURE FEED, DENOTES
\(\rightarrow\)	RECEPTACLE AUTOMATICALLY CONTROLLED (ASHRAE 90.1-2013, 8.4.2).	W	WALL SYSTEM FURNITURE FEED FOR COMMUNICATIONS.
•	MANUALLY CONTROLLED SPLIT RECEPTACLE	F	ADJACENT TO SYSTEM FURNITURE FEED, DENOTES FLOOR SYSTEM FURNITURE FEED FOR COMMUNICATIONS.
•	120V U-GROUND QUAD RECEPTACLE.		ADJACENT TO SYSTEM FURNITURE FEED, DENOTES
•	INDICATES RECEPTACLE COMPLETE WITH ONE TYPE A AND ONE TYPE C USB CHARGING PORTS. 14-30R RECEPTACLE FOR LAUNDRY DRYER, OR OTHER	С	CEILING SYSTEM FURNITURE FEED FOR COMMUNICATIONS (SERVICE POLE OR DROP CORD A NOTED).
#	RECEPTACLE AS NOTED 14-50R RECEPTACLE FOR ELECTRONIC RANGE, OR		CABLE TRAY (LADDER TYPE)
THIS LEGE	OTHER RECEPTACLE AS NOTED. PROVIDE 40A/2P BREAKER TO SUIT		CABLE TRAY (BASKET TYPE)
APPLICABL	ND IS GENERIC. ALL SYMBOLS LISTED MAY NOT BE LE FOR THIS PROJECT. REFER TO FLOOR PLANS TO E USED DEVICES AND EQUIPMENT.	41	WALL MOUNTED DATA (D) OR VOICE (V) OUTLET. PROVIDE 1V AND 1D UNLESS NOTED OTHERWISE. WALL MOUNTED VOICE (TELEPHONE) OUTLET.

WALL MOUNTED VOICE (TELEPHONE) OUTLET. PROVIDE 1V UNLESS NOTED OTHERWISE.

THIS LEGEND IS GENERIC. ALL SYMBOLS LISTED MAY NOT BE APPLICABLE FOR THIS PROJECT. REFER TO FLOOR PLANS TO

DETERMINE USED DEVICES AND EQUIPMENT.

RICAL LEGEND		ELECTRICAL LEGEND
DESCRIPTION	SYMBOL	DESCRIPTION
FACLE. VERIFY OUTLET PRIOR TO ROUGH-IN.	٥	WALL MOUNTED DATA OUTLET. PROVIDE 1D UNLESS NOTED OTHERWISE.
FACLE. VERIFY OUTLET PRIOR TO ROUGH-IN.	4	WALL MOUNTED TELEVISION OUTLET.
CLE OR RECEPTACLE IN FLOOR BOX	4444	VOICE, DATA, OR TV OUTLET AS DESCRIBED ABOVE, MOUNTED ABOVE COUNTER TOP OR AS INSTRUCTED ON SITE.
ROVIDE POWER TO JUNCTION BOX IN BOVE. DEVICES ON POLE AS NOTED	В	ADJACENT TO COMMUNICATIONS OUTLET, INDICATES BLANK-OFF PLATE. HDMI OUTLET.
OOR RECEPTACLE, DENOTES FLOOR	AV	AUDIO VIDEO GANG, AS NOTED.
VICE, DENOTES DEVICE CONNECTED	WAP	WIRELESS ACCESS POINT (WIFI)
POWER NG FIXTURES	<u>\$</u>	AUDIO VISUAL SYSTEM SPEAKER, CEILING MOUNTED.
WITH IES DG-3-00 AND IES HB-10-11 ILED OTHERWISE HERE. SCHEDULE FOR FURTHER DETAILS	(S) (A)	AUDIO VISUAL SYSTEM SPEAKER, WALL MOUNTED. PUBLIC ADDRESS SYSTEM SPEAKER, CEILING MOUNTED.
URE REQUIREMENTS.	<u>—</u>	PUBLIC ADDRESS SYSTEM SPEAKER, WALL MOUNTED
E, SURFACE MOUNTED TO CEILING E, RECESSED IN CEILING		PUBLIC ADDRESS SPEAKER, WALL MOUNTED HORN
E, SUSPENDED: PENDANT, CHAIN,		SPEAKER. PUBLIC ADDRESS SYSTEM HANDSET
AFT CABLE HUNG TO SUIT AS NOTED IN SCHEDULE. "X", WHEN	ACC	PUBLIC ADDRESS SYSTEM HANDSET PUBLIC ADDRESS SYSTEM ADMIN CONTROL CONSOLE
POWER FEED LOCATION.	₩ VOL	PUBLIC ADDRESS SPEAKER VOLUME CONTROL
E, WALL MOUNTED	4	SWITCH. INTERCOM
ECTED TO EMERGENCY OR NIGHT	IDC	INSULATION DISPLACEMENT CONNECTION
T AS INDICATED.	Ō	CLOCK
DE DOMANI (OUE TESTE E	MTX	GPS CLOCK SYSTEM MASTER TRANSMITTER GPS CLOCK SYSTEM GPS RECEIVER
RE DOWNLIGHT, RECESSED NLIGHTS, CONNECTED TO		GPS CLOCK SYSTEM GPS RECEIVER GPS CLOCK SSTEM SETTELITE TRANSMITTER
NIGHT LIGHT CIRCUIT	RTX	(RECEIVER) GPS CLOCK SYSTEM RECEIVER SWITCH
ED LUMINAIRE	S R X	
R OTHER WALL MOUNTED	CR	ACCESS CONTROL AND DOOR HARDWARE CARD READER
EMERGENCY NIGHT LIGHT CIRCUIT	DA	DOOR ALARM SOUNDER
EMERGENCY CIRCUIT. PROVIDE CUL		DOOR CONTACT
T TRIP RELAY OR EQUAL TO PERMIT IINAIRE WITH ZONING BASED ON	ODC	OVERHEAD DOOR CONTACT ELECTRIC LATCH RETRACTION
CONTROLS. ECTED TO NON-EMERGENCY NIGHT	ES	ELECTRIC STRIKE
HOUR)	PTC	ELECTRIC POWER TRANSFER CABLE
CONTROLS IN THE SAME SPACE.	PTH	POWER TRANSFER HINGE
NCY LIGHTING NG FIXTURE SCHEDULE FOR EXACT	KS	KEY SWITCH ELECTROMAGNETIC LOCK
EQUIREMENTS.	MLR	MOTORIZED LATCH RETRACTION. PROVIDE 120 V.
MOUNTED ILLUMINATED EXIT SIGN. DICATES ILLUMINATED FACE.	REX	REQUEST TO EXIT SENSOR
ONAL ARROWS AS INDICATED ON MOUNTED ILLUMINATED EXIT SIGN.	•	MUSHROOM HEAD PUSH BUTTON FOR 'REQUEST TO EXIT' MAGLOCK RELEASE, OR OTHER PUSH BUTTON AS INDICATED
DICATES ILLUMINATED FACE. IONAL ARROWS AS INDICATED ON		BARRIER FREE DOOR OPERATOR PUSH BUTTON
.UMINOUS' EXIT SIGN	•	BARRIER FREE DOOR OPERATOR PUSH BUTTON TOUCHLESS "WAVE SWITCH" FOR DOOR OPERATOR
S EXIT SIGN	WS	CONTROL
HTING BATTERY UNIT, WITH AND	<mark>♡</mark> □B	DOOR BELL C/W SOUNDER AND STROBE
EAD WALL MOUNTED EMERGENCY E UNITS.	O DB	DOOR BELL (SOUNDER ONLY)
EAD CEILING MOUNTED EMERGENCY		INTRUSION DETECTION
E UNITS. GENCY REMOTE HEAD.		GLASS BREAK (GB)
GENCY REMOTE HEAD.	MD KP	MOTION DETECTOR (MD) KEYPAD (KP)
LOUR TEMPERATURE		VIDEO SURVEILLANCE
RING INDEX	C/P	CCTV CAMERA CCTV CAMERA, CEILING OR POLE MOUNTED
RIOR LIGHTING UMINAIRE ON POLE. DIRECTIONAL	1 €/P	CCTV CAMERA, CEILING OR POLE MOUNTED CCTV CAMERA, WALL MOUNTED
NDICATED DENOTES PRIMARY TON.	PTZ	PAN-TILT-ZOOM
AIRE ON POLE. DIRECTIONAL NDICATED DENOTES PRIMARY		DURESS SYSTEM
TON.	● DB	DURESS BUTTON (MOUNTED ON UNDERSIDE OF TABLETOP)
RD. DIRECTIONAL ARROW, WHERE TES PRIMARY LUMEN ORIENTATION.	● DB-W	WALL MOUNTED DURESS BUTTON WITH POLYCARBONATE ANTI-TAMPER COVER
ED FLOOD LIGHT	□□(DURESS SYSTEM STROBE LIGHT
MMUNICATIONS	0.407	FIRE DETECTION AND ALARM - GENERAL
RE FEED. STEM FURNITURE FEED, DENOTES	DCC	CENTRAL ALARM AND CONTROL FACILITY DISPLAY AND CONTROL CENTER
RNITURE FEED FOR S.	FACP	FIRE ALARM CONTROL PANEL FIRE ALARM TRANSPONDER PANEL
STEM FURNITURE FEED, DENOTES URNITURE FEED FOR	FAAP	FIRE ALARM ANNUNICIATOR PANEL
STEM FURNITURE FEED, DENOTES	FAAG	FIRE ALARM ACTIVE ANNUNCIATOR C/W GRAPHIC
FURNITURE FEED FOR	FAPG	FIRE ALARM PASSIVE GRAPHIC
S (SERVICE POLE OR DROP CORD AS	FAMP	FIRE ALARM ULC MONITORING PANEL
DER TYPE)	FAZ FSZ	FIRE ALARM ZONE FIRE ALARM SUPERVISORY ZONE
	FDSPCP	FIRE ALARM PANEL (FACP, FAAP, FAMP) AS DENOTED
KET TYPE)		ON PLANS
DATA (D) OR VOICE (V) OUTLET.	FDSCP	FIRE DETECTION AND SUPPRESSION CONTROL PANEL FIRE ALARM PANEL (FACP, FAAP, FAMP) AS DENOTED
1D UNLESS NOTED OTHERWISE. OICE (TELEPHONE) OUTLET.		ON PLANS
SS NOTED OTHERWISE.		ND IS GENERIC. ALL SYMBOLS LISTED MAY NOT BE E FOR THIS PROJECT. REFER TO FLOOR PLANS TO
SYMBOLS LISTED MAY NOT BE	DETERMINI	E USED DEVICES AND EQUIPMENT.


SYMBOL	DESCRIPTION
J. IVIDUL	FIRE DETECTION - INITIATION DEVICES
	MANUAL PULL STATION (MPS)
LX	WHERE NOTED ADJACENT TO MANUAL PULL STATIONS DENOTES PULL STATION C/W POLYCARBONATE
	(LEXAN) COVER.
WG	WHERE NOTED ADJACENT TO MANUAL PULL STATIONS DENOTES PULL STATION C/W WIRE GUARD COVER.
Α	WHERE NOTED ADJACENT TO MANUAL PULL STATIONS DENOTES MANUAL PULL STATION C/W AUXILIARY
	CONTACT.
•	PHOTOELECTRIC SMOKE DETECTOR
Ю	SAME AS ABOVE, WALL MOUNTED WHEN ADJACENT TO PHOTOELECTRIC SMOKE
SA	DETECTOR, INDICATES RESIDENTIAL SMOKE ALARM
	RESIDENTIAL SMOKE ALARM, 120 VOLT, COMPLETE WITH STROBE. FOR AREAS AS INDICATED ON PLANS
⊕	BY "CO", PROVIDE INTEGRAL CARBON MONOXIDE DETECTION.
10	SAME AS ABOVE, WALL MOUNTED
100 □260	DUCT MOUNTED SMOKE DETECTOR
СО	CARBON MONOXIDE DETECTOR
VESDA	VERY EARLY SMOKE DETECTING APPARATUS
BSDT	BEAM SMOKE DETECTOR TRANSMITTER
BSDR	BEAM SMOKE DETECTOR RECEIVER (OR REFLECTOR)
ASD	ASPIRATING SMOKE DETECTOR END OF LINE (EOL) DEVICE ON ZONE INITIATION OR
EOL	SIGNAL CIRCUITS
•	HEAT DETECTOR - FIXED TEMPERATURE
Ю	SAME AS ABOVE, WALL MOUNTED ADJACENT TO HEAT DETECTOR, DENOTES "HIGH
НТ	TEMPERATURE"
②	HEAT DETECTOR - 94 DEGREES C (200 DEGREES F) FIXED TEMPERATURE
•	HEAT DETECTOR - 58 DEGREES C (135 DEGREES F)
-	FIXED TEMPERATURE AND RATE OF RISE
FS	LINEAR HEAT DETECTION CABLE FLOW SWITCH
	E DETECTION AND ALARM - SUPERVISORY DEVICES
Ш	LOW TANK LEVEL
LP	LOSS OF POWER
LT	LOW TEMPERATURE
PS	PRESSURE SWITCH
MON	SUPERVISED VALVE SUPERVISED VALVE
	E DETECTION AND ALARM - SIGNALLING DEVICES
N O	FIRE ALARM BELL, WALL MOUNTED.
С	ADJACENT TO BELL OR HORN, DENOTES CEILING
	MOUNTED. FIRE ALARM HORN
M	ADJACENT TO FIRE ALARM HORN, DENOTES 'MINI'
	HORN
	FIRE ALARM HORN/STROBE, WALL MOUNTED.
€V	FIRE ALARM EVACUATION SPEAKER, CEILING MOUNTED
\square	FIRE ALARM EVACUATION SPEAKER, COMPLETE WITH STROBE LIGHT, CEILING MOUNTED
/ (2)	FIRE ALARM EVACUATION SPEAKER, WALL MOUNTED
~~	FIRE ALARM EVACUATION SPEAKER COMPLETE WITH
H <u>€</u> V	STROBE LIGHT, WALL MOUNTED
SS	SILENCE SWITCH
(20)	FIRE ALARM WALL MOUNTED STROBE LIGHT
FIRE DETE	CTION AND ALARM - VOICE COMMUNICATION DEVICES
◀ FF	EMERGENCY TELEPHONE FOR FIREFIGHTER'S USE
FIRE	DETECTION AND ALARM - OTHER DEVICES
EOL	END OF LINE DEVICE
DNE	WIRE GUARD "DO NOT ENTER" SIGN
	KEY SWITCH FOR FIREFIGHTER CONTROL OF
KS	ELEVATOR RECALL, OR AS NOTED
	·
IM	ISOLATOR MODULE
IM R	OUTPUT RELAY, FUNCTION AS INDICATED
IM R CM	OUTPUT RELAY, FUNCTION AS INDICATED CONTROL MODULE
IM R CM	OUTPUT RELAY, FUNCTION AS INDICATED
IM R CM MM	OUTPUT RELAY, FUNCTION AS INDICATED CONTROL MODULE MONITOR MODULE MAGNETIC DOOR HOLDER AND RELEASING DEVICE ("HOLD OPEN")
IM R CM MM HO	OUTPUT RELAY, FUNCTION AS INDICATED CONTROL MODULE MONITOR MODULE MAGNETIC DOOR HOLDER AND RELEASING DEVICE ("HOLD OPEN") FIRE SUPPRESSION RELEASING STATION
IM R CM MM	OUTPUT RELAY, FUNCTION AS INDICATED CONTROL MODULE MONITOR MODULE MAGNETIC DOOR HOLDER AND RELEASING DEVICE ("HOLD OPEN")
IM R CM MM HO	OUTPUT RELAY, FUNCTION AS INDICATED CONTROL MODULE MONITOR MODULE MAGNETIC DOOR HOLDER AND RELEASING DEVICE ("HOLD OPEN") FIRE SUPPRESSION RELEASING STATION FIRE SUPPRESSION ABORT STATION
EM CM MM HO	OUTPUT RELAY, FUNCTION AS INDICATED CONTROL MODULE MONITOR MODULE MAGNETIC DOOR HOLDER AND RELEASING DEVICE ("HOLD OPEN") FIRE SUPPRESSION RELEASING STATION FIRE SUPPRESSION ABORT STATION SINGLE LINE DIAGRAM
M	OUTPUT RELAY, FUNCTION AS INDICATED CONTROL MODULE MONITOR MODULE MAGNETIC DOOR HOLDER AND RELEASING DEVICE ("HOLD OPEN") FIRE SUPPRESSION RELEASING STATION FIRE SUPPRESSION ABORT STATION SINGLE LINE DIAGRAM AIR CIRCUIT BREAKER
	OUTPUT RELAY, FUNCTION AS INDICATED CONTROL MODULE MONITOR MODULE MAGNETIC DOOR HOLDER AND RELEASING DEVICE ("HOLD OPEN") FIRE SUPPRESSION RELEASING STATION FIRE SUPPRESSION ABORT STATION SINGLE LINE DIAGRAM AIR CIRCUIT BREAKER MOLDED CASE CIRCUIT BREAKER
ER CM	OUTPUT RELAY, FUNCTION AS INDICATED CONTROL MODULE MONITOR MODULE MAGNETIC DOOR HOLDER AND RELEASING DEVICE ("HOLD OPEN") FIRE SUPPRESSION RELEASING STATION FIRE SUPPRESSION ABORT STATION SINGLE LINE DIAGRAM AIR CIRCUIT BREAKER MOLDED CASE CIRCUIT BREAKER DISCONNECT (UNFUSED)
	OUTPUT RELAY, FUNCTION AS INDICATED CONTROL MODULE MONITOR MODULE MAGNETIC DOOR HOLDER AND RELEASING DEVICE ("HOLD OPEN") FIRE SUPPRESSION RELEASING STATION FIRE SUPPRESSION ABORT STATION SINGLE LINE DIAGRAM AIR CIRCUIT BREAKER MOLDED CASE CIRCUIT BREAKER DISCONNECT (UNFUSED) FUSE METERING CABINET
	OUTPUT RELAY, FUNCTION AS INDICATED CONTROL MODULE MONITOR MODULE MAGNETIC DOOR HOLDER AND RELEASING DEVICE ("HOLD OPEN") FIRE SUPPRESSION RELEASING STATION FIRE SUPPRESSION ABORT STATION SINGLE LINE DIAGRAM AIR CIRCUIT BREAKER MOLDED CASE CIRCUIT BREAKER DISCONNECT (UNFUSED) FUSE METERING CABINET TRANSFORMER
	OUTPUT RELAY, FUNCTION AS INDICATED CONTROL MODULE MONITOR MODULE MAGNETIC DOOR HOLDER AND RELEASING DEVICE ("HOLD OPEN") FIRE SUPPRESSION RELEASING STATION FIRE SUPPRESSION ABORT STATION SINGLE LINE DIAGRAM AIR CIRCUIT BREAKER MOLDED CASE CIRCUIT BREAKER DISCONNECT (UNFUSED) FUSE METERING CABINET
	OUTPUT RELAY, FUNCTION AS INDICATED CONTROL MODULE MONITOR MODULE MAGNETIC DOOR HOLDER AND RELEASING DEVICE ("HOLD OPEN") FIRE SUPPRESSION RELEASING STATION FIRE SUPPRESSION ABORT STATION SINGLE LINE DIAGRAM AIR CIRCUIT BREAKER MOLDED CASE CIRCUIT BREAKER DISCONNECT (UNFUSED) FUSE METERING CABINET TRANSFORMER
	OUTPUT RELAY, FUNCTION AS INDICATED CONTROL MODULE MONITOR MODULE MAGNETIC DOOR HOLDER AND RELEASING DEVICE ("HOLD OPEN") FIRE SUPPRESSION RELEASING STATION FIRE SUPPRESSION ABORT STATION SINGLE LINE DIAGRAM AIR CIRCUIT BREAKER MOLDED CASE CIRCUIT BREAKER DISCONNECT (UNFUSED) FUSE METERING CABINET TRANSFORMER BUS DUCT
	OUTPUT RELAY, FUNCTION AS INDICATED CONTROL MODULE MONITOR MODULE MAGNETIC DOOR HOLDER AND RELEASING DEVICE ("HOLD OPEN") FIRE SUPPRESSION RELEASING STATION FIRE SUPPRESSION ABORT STATION SINGLE LINE DIAGRAM AIR CIRCUIT BREAKER MOLDED CASE CIRCUIT BREAKER DISCONNECT (UNFUSED) FUSE METERING CABINET TRANSFORMER BUS DUCT
	OUTPUT RELAY, FUNCTION AS INDICATED CONTROL MODULE MONITOR MODULE MAGNETIC DOOR HOLDER AND RELEASING DEVICE ("HOLD OPEN") FIRE SUPPRESSION RELEASING STATION FIRE SUPPRESSION ABORT STATION SINGLE LINE DIAGRAM AIR CIRCUIT BREAKER MOLDED CASE CIRCUIT BREAKER DISCONNECT (UNFUSED) FUSE METERING CABINET TRANSFORMER BUS DUCT GENERATOR
	OUTPUT RELAY, FUNCTION AS INDICATED CONTROL MODULE MONITOR MODULE MAGNETIC DOOR HOLDER AND RELEASING DEVICE ("HOLD OPEN") FIRE SUPPRESSION RELEASING STATION FIRE SUPPRESSION ABORT STATION SINGLE LINE DIAGRAM AIR CIRCUIT BREAKER MOLDED CASE CIRCUIT BREAKER DISCONNECT (UNFUSED) FUSE METERING CABINET TRANSFORMER BUS DUCT GENERATOR AUTOMATIC TRANSFER SWITCH
	OUTPUT RELAY, FUNCTION AS INDICATED CONTROL MODULE MONITOR MODULE MAGNETIC DOOR HOLDER AND RELEASING DEVICE ("HOLD OPEN") FIRE SUPPRESSION RELEASING STATION FIRE SUPPRESSION ABORT STATION SINGLE LINE DIAGRAM AIR CIRCUIT BREAKER MOLDED CASE CIRCUIT BREAKER DISCONNECT (UNFUSED) FUSE METERING CABINET TRANSFORMER BUS DUCT GENERATOR
	OUTPUT RELAY, FUNCTION AS INDICATED CONTROL MODULE MONITOR MODULE MAGNETIC DOOR HOLDER AND RELEASING DEVICE ("HOLD OPEN") FIRE SUPPRESSION RELEASING STATION FIRE SUPPRESSION ABORT STATION SINGLE LINE DIAGRAM AIR CIRCUIT BREAKER MOLDED CASE CIRCUIT BREAKER DISCONNECT (UNFUSED) FUSE METERING CABINET TRANSFORMER BUS DUCT GENERATOR AUTOMATIC TRANSFER SWITCH COMPLETE WITH
	OUTPUT RELAY, FUNCTION AS INDICATED CONTROL MODULE MONITOR MODULE MAGNETIC DOOR HOLDER AND RELEASING DEVICE ("HOLD OPEN") FIRE SUPPRESSION RELEASING STATION FIRE SUPPRESSION ABORT STATION SINGLE LINE DIAGRAM AIR CIRCUIT BREAKER MOLDED CASE CIRCUIT BREAKER DISCONNECT (UNFUSED) FUSE METERING CABINET TRANSFORMER BUS DUCT GENERATOR AUTOMATIC TRANSFER SWITCH COMPLETE WITH SINGLE SIDED BYPASS ISOLATION
	OUTPUT RELAY, FUNCTION AS INDICATED CONTROL MODULE MONITOR MODULE MAGNETIC DOOR HOLDER AND RELEASING DEVICE ("HOLD OPEN") FIRE SUPPRESSION RELEASING STATION FIRE SUPPRESSION ABORT STATION SINGLE LINE DIAGRAM AIR CIRCUIT BREAKER MOLDED CASE CIRCUIT BREAKER DISCONNECT (UNFUSED) FUSE METERING CABINET TRANSFORMER BUS DUCT GENERATOR AUTOMATIC TRANSFER SWITCH COMPLETE WITH SINGLE SIDED BYPASS ISOLATION
	OUTPUT RELAY, FUNCTION AS INDICATED CONTROL MODULE MONITOR MODULE MAGNETIC DOOR HOLDER AND RELEASING DEVICE ("HOLD OPEN") FIRE SUPPRESSION RELEASING STATION FIRE SUPPRESSION ABORT STATION SINGLE LINE DIAGRAM AIR CIRCUIT BREAKER MOLDED CASE CIRCUIT BREAKER DISCONNECT (UNFUSED) FUSE METERING CABINET TRANSFORMER BUS DUCT GENERATOR AUTOMATIC TRANSFER SWITCH COMPLETE WITH SINGLE SIDED BYPASS ISOLATION
ER EM	OUTPUT RELAY, FUNCTION AS INDICATED CONTROL MODULE MONITOR MODULE MAGNETIC DOOR HOLDER AND RELEASING DEVICE ("HOLD OPEN") FIRE SUPPRESSION RELEASING STATION FIRE SUPPRESSION ABORT STATION SINGLE LINE DIAGRAM AIR CIRCUIT BREAKER MOLDED CASE CIRCUIT BREAKER DISCONNECT (UNFUSED) FUSE METERING CABINET TRANSFORMER BUS DUCT GENERATOR AUTOMATIC TRANSFER SWITCH AUTOMATIC TRANSFER SWITCH COMPLETE WITH SINGLE SIDED BYPASS ISOLATION AUTOMATIC TRANSFER SWITCH COMPLETE WITH SINGLE SIDED BYPASS ISOLATION
	OUTPUT RELAY, FUNCTION AS INDICATED CONTROL MODULE MONITOR MODULE MAGNETIC DOOR HOLDER AND RELEASING DEVICE ("HOLD OPEN") FIRE SUPPRESSION RELEASING STATION FIRE SUPPRESSION ABORT STATION SINGLE LINE DIAGRAM AIR CIRCUIT BREAKER MOLDED CASE CIRCUIT BREAKER DISCONNECT (UNFUSED) FUSE METERING CABINET TRANSFORMER BUS DUCT GENERATOR AUTOMATIC TRANSFER SWITCH AUTOMATIC TRANSFER SWITCH COMPLETE WITH SINGLE SIDED BYPASS ISOLATION AUTOMATIC TRANSFER SWITCH COMPLETE WITH SINGLE SIDED BYPASS ISOLATION AUTOMATIC TRANSFER SWITCH COMPLETE WITH SINGLE SIDED BYPASS ISOLATION AUTOMATIC TRANSFER SWITCH COMPLETE WITH SINGLE SIDED BYPASS ISOLATION
ER EM	OUTPUT RELAY, FUNCTION AS INDICATED CONTROL MODULE MONITOR MODULE MAGNETIC DOOR HOLDER AND RELEASING DEVICE ("HOLD OPEN") FIRE SUPPRESSION RELEASING STATION FIRE SUPPRESSION ABORT STATION SINGLE LINE DIAGRAM AIR CIRCUIT BREAKER MOLDED CASE CIRCUIT BREAKER DISCONNECT (UNFUSED) FUSE METERING CABINET TRANSFORMER BUS DUCT GENERATOR AUTOMATIC TRANSFER SWITCH AUTOMATIC TRANSFER SWITCH COMPLETE WITH SINGLE SIDED BYPASS ISOLATION AUTOMATIC TRANSFER SWITCH COMPLETE WITH SINGLE SIDED BYPASS ISOLATION
ER EM EM EM EM EM EM EM EM EM	OUTPUT RELAY, FUNCTION AS INDICATED CONTROL MODULE MONITOR MODULE MAGNETIC DOOR HOLDER AND RELEASING DEVICE ("HOLD OPEN") FIRE SUPPRESSION RELEASING STATION FIRE SUPPRESSION ABORT STATION SINGLE LINE DIAGRAM AIR CIRCUIT BREAKER MOLDED CASE CIRCUIT BREAKER DISCONNECT (UNFUSED) FUSE METERING CABINET TRANSFORMER BUS DUCT GENERATOR AUTOMATIC TRANSFER SWITCH AUTOMATIC TRANSFER SWITCH COMPLETE WITH SINGLE SIDED BYPASS ISOLATION AUTOMATIC TRANSFER SWITCH COMPLETE WITH SINGLE SIDED BYPASS ISOLATION AUTOMATIC TRANSFER SWITCH COMPLETE WITH SINGLE SIDED BYPASS ISOLATION AUTOMATIC TRANSFER SWITCH COMPLETE WITH SINGLE SIDED BYPASS ISOLATION AUTOMATIC TRANSFER SWITCH COMPLETE WITH SINGLE SIDED BYPASS ISOLATION
ER EM	OUTPUT RELAY, FUNCTION AS INDICATED CONTROL MODULE MONITOR MODULE MAGNETIC DOOR HOLDER AND RELEASING DEVICE ("HOLD OPEN") FIRE SUPPRESSION RELEASING STATION FIRE SUPPRESSION ABORT STATION SINGLE LINE DIAGRAM AIR CIRCUIT BREAKER MOLDED CASE CIRCUIT BREAKER DISCONNECT (UNFUSED) FUSE METERING CABINET TRANSFORMER BUS DUCT GENERATOR AUTOMATIC TRANSFER SWITCH AUTOMATIC TRANSFER SWITCH COMPLETE WITH SINGLE SIDED BYPASS ISOLATION AUTOMATIC TRANSFER SWITCH COMPLETE WITH SINGLE SIDED BYPASS ISOLATION AUTOMATIC TRANSFER SWITCH COMPLETE WITH SINGLE SIDED BYPASS ISOLATION AUTOMATIC TRANSFER SWITCH COMPLETE WITH SINGLE SIDED BYPASS ISOLATION AUTOMATIC TRANSFER SWITCH COMPLETE WITH SINGLE SIDED BYPASS ISOLATION AUTOMATIC TRANSFER SWITCH COMPLETE WITH SINGLE SIDED BYPASS ISOLATION
ER EM	OUTPUT RELAY, FUNCTION AS INDICATED CONTROL MODULE MONITOR MODULE MAGNETIC DOOR HOLDER AND RELEASING DEVICE ("HOLD OPEN") FIRE SUPPRESSION RELEASING STATION FIRE SUPPRESSION ABORT STATION SINGLE LINE DIAGRAM AIR CIRCUIT BREAKER MOLDED CASE CIRCUIT BREAKER DISCONNECT (UNFUSED) FUSE METERING CABINET TRANSFORMER BUS DUCT GENERATOR AUTOMATIC TRANSFER SWITCH AUTOMATIC TRANSFER SWITCH COMPLETE WITH SINGLE SIDED BYPASS ISOLATION AUTOMATIC TRANSFER SWITCH COMPLETE WITH SINGLE SIDED BYPASS ISOLATION AUTOMATIC TRANSFER SWITCH COMPLETE WITH SINGLE SIDED BYPASS ISOLATION AUTOMATIC TRANSFER SWITCH COMPLETE WITH SINGLE SIDED BYPASS ISOLATION AUTOMATIC TRANSFER SWITCH COMPLETE WITH SINGLE SIDED BYPASS ISOLATION AUTOMATIC TRANSFER SWITCH CONTACTOR DISTRIBUTION PANELBOARD LIGHTING PANELBOARD MOBILE CONNECTION BOX
ER EM	OUTPUT RELAY, FUNCTION AS INDICATED CONTROL MODULE MONITOR MODULE MAGNETIC DOOR HOLDER AND RELEASING DEVICE ("HOLD OPEN") FIRE SUPPRESSION RELEASING STATION FIRE SUPPRESSION ABORT STATION SINGLE LINE DIAGRAM AIR CIRCUIT BREAKER MOLDED CASE CIRCUIT BREAKER DISCONNECT (UNFUSED) FUSE METERING CABINET TRANSFORMER BUS DUCT GENERATOR AUTOMATIC TRANSFER SWITCH AUTOMATIC TRANSFER SWITCH COMPLETE WITH SINGLE SIDED BYPASS ISOLATION AUTOMATIC TRANSFER SWITCH COMPLETE WITH SINGLE SIDED BYPASS ISOLATION AUTOMATIC TRANSFER SWITCH COMPLETE WITH SINGLE SIDED BYPASS ISOLATION AUTOMATIC TRANSFER SWITCH COMPLETE WITH SINGLE SIDED BYPASS ISOLATION AUTOMATIC TRANSFER SWITCH CONTACTOR DISTRIBUTION PANELBOARD LIGHTING PANELBOARD MOBILE CONNECTION BOX MOTOR CONTROL CENTRE MANUAL TRANSFER SWITCH POWER PANELBOARD
ER EM	OUTPUT RELAY, FUNCTION AS INDICATED CONTROL MODULE MONITOR MODULE MAGNETIC DOOR HOLDER AND RELEASING DEVICE ("HOLD OPEN") FIRE SUPPRESSION RELEASING STATION FIRE SUPPRESSION ABORT STATION SINGLE LINE DIAGRAM AIR CIRCUIT BREAKER MOLDED CASE CIRCUIT BREAKER DISCONNECT (UNFUSED) FUSE METERING CABINET TRANSFORMER BUS DUCT GENERATOR AUTOMATIC TRANSFER SWITCH AUTOMATIC TRANSFER SWITCH COMPLETE WITH SINGLE SIDED BYPASS ISOLATION AUTOMATIC TRANSFER SWITCH COMPLETE WITH SINGLE SIDED BYPASS ISOLATION AUTOMATIC TRANSFER SWITCH COMPLETE WITH CONTACTOR DISTRIBUTION PANELBOARD LIGHTING PANELBOARD MOBILE CONNECTION BOX MOTOR CONTROL CENTRE MANUAL TRANSFER SWITCH POWER PANELBOARD RECEPTACLE PANELBOARD
ER EM	OUTPUT RELAY, FUNCTION AS INDICATED CONTROL MODULE MONITOR MODULE MAGNETIC DOOR HOLDER AND RELEASING DEVICE ("HOLD OPEN") FIRE SUPPRESSION RELEASING STATION FIRE SUPPRESSION ABORT STATION SINGLE LINE DIAGRAM AIR CIRCUIT BREAKER MOLDED CASE CIRCUIT BREAKER DISCONNECT (UNFUSED) FUSE METERING CABINET TRANSFORMER BUS DUCT GENERATOR AUTOMATIC TRANSFER SWITCH AUTOMATIC TRANSFER SWITCH COMPLETE WITH SINGLE SIDED BYPASS ISOLATION AUTOMATIC TRANSFER SWITCH COMPLETE WITH SINGLE SIDED BYPASS ISOLATION AUTOMATIC TRANSFER SWITCH COMPLETE WITH SINGLE SIDED BYPASS ISOLATION AUTOMATIC TRANSFER SWITCH COMPLETE WITH SINGLE SIDED BYPASS ISOLATION AUTOMATIC TRANSFER SWITCH CONTACTOR DISTRIBUTION PANELBOARD LIGHTING PANELBOARD MOBILE CONNECTION BOX MOTOR CONTROL CENTRE MANUAL TRANSFER SWITCH POWER PANELBOARD RECEPTACLE PANELBOARD SURGE PROTECTIVE DEVICE
ER EM	OUTPUT RELAY, FUNCTION AS INDICATED CONTROL MODULE MONITOR MODULE MAGNETIC DOOR HOLDER AND RELEASING DEVICE ("HOLD OPEN") FIRE SUPPRESSION RELEASING STATION FIRE SUPPRESSION ABORT STATION SINGLE LINE DIAGRAM AIR CIRCUIT BREAKER MOLDED CASE CIRCUIT BREAKER DISCONNECT (UNFUSED) FUSE METERING CABINET TRANSFORMER BUS DUCT GENERATOR AUTOMATIC TRANSFER SWITCH AUTOMATIC TRANSFER SWITCH AUTOMATIC TRANSFER SWITCH COMPLETE WITH SINGLE SIDED BYPASS ISOLATION AUTOMATIC TRANSFER SWITCH COMPLETE WITH SINGLE SIDED BYPASS ISOLATION AUTOMATIC TRANSFER SWITCH COMPLETE WITH CONTACTOR DISTRIBUTION PANELBOARD LIGHTING PANELBOARD MOBILE CONNECTION BOX MOTOR CONTROL CENTRE MANUAL TRANSFER SWITCH POWER PANELBOARD RECEPTACLE PANELBOARD

TRANSFORMER

DETERMINE USED DEVICES AND EQUIPMENT.

UNINTERRUPTIBLE POWER SUPPLY THIS LEGEND IS GENERIC. ALL SYMBOLS LISTED MAY NOT BE APPLICABLE FOR THIS PROJECT. REFER TO FLOOR PLANS TO

DRAWING #	DRAWING NAME
E-001	Electrical Legend & Sheet List
E-002	Keyplans Drawing
E-101	Electrical Demolition Plan - Lighting
E-151	Electrical New Work Plan - Lighting
E-201	Electrical Demolition Plan - Level 1 - Power & Systems
E-251	Electrical New Work Plan - Level 1 - Power & Systems
E-252	Electrical Plans - Level 2 - Power and Systems
E-253	Electrical Plans - Roof - Power and Systems
E-301	Electrical Equipment & Panel Schedules
E-302	Electrical Detail Sheet No. 1
E-303	Electrical Detail Sheet No. 2
E-304	Electrical Detail Sheet No. 3
E-305	Lighting Schedules

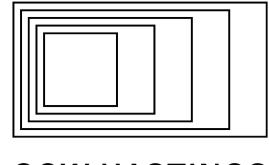


GOW HASTINGS **ARCHITECTS**

275 SPADINA ROAD TORONTO ONTARIO M5R 2V3 416-920-0031 GOWHASTINGS.COM

ALL DRAWINGS, SPECIFICATIONS, RELATED DOCUMENTS AND DESIGN ARE THE COPYRIGHT PROPERTY OF THE ARCHITECT AND MUST BE RETURNED UPON REQUEST. REPRODUCTION OF THE DRAWINGS, SPECIFICATIONS, RELATED DOCUMENTS AND DESIGN IN WHOLE OR IN PART IS STRICTLY FORBIDDEN WITHOUT THE ARCHITECT'S WRITTEN PERMISSION. THIS DRAWING SHALL NOT BE USED FOR CONSTRUCTION PURPOSES UNLESS COUNTERSIGNED.



250 ROWNTREE DAIRY RD, WOODBRIDGE, ON 905-507-0800 WWW.QUASARCG.COM

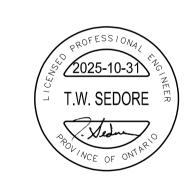

2 ISSUED FOR PERMIT AND 10/31/2025 TENDER 1 ISSUED FOR 90% CD - CLIENT 10/09/2025 REVIEW


> ISSUED/REVISED DATE


Henry St H.S. Culinary Classroom Renovation

600 Henry St, Whitby, ON L1N 1L4

Electrical Legend & Sheet

Scale: 1:1 Project Number: ED-25-052 Drawn By: Author Checked By: Checker

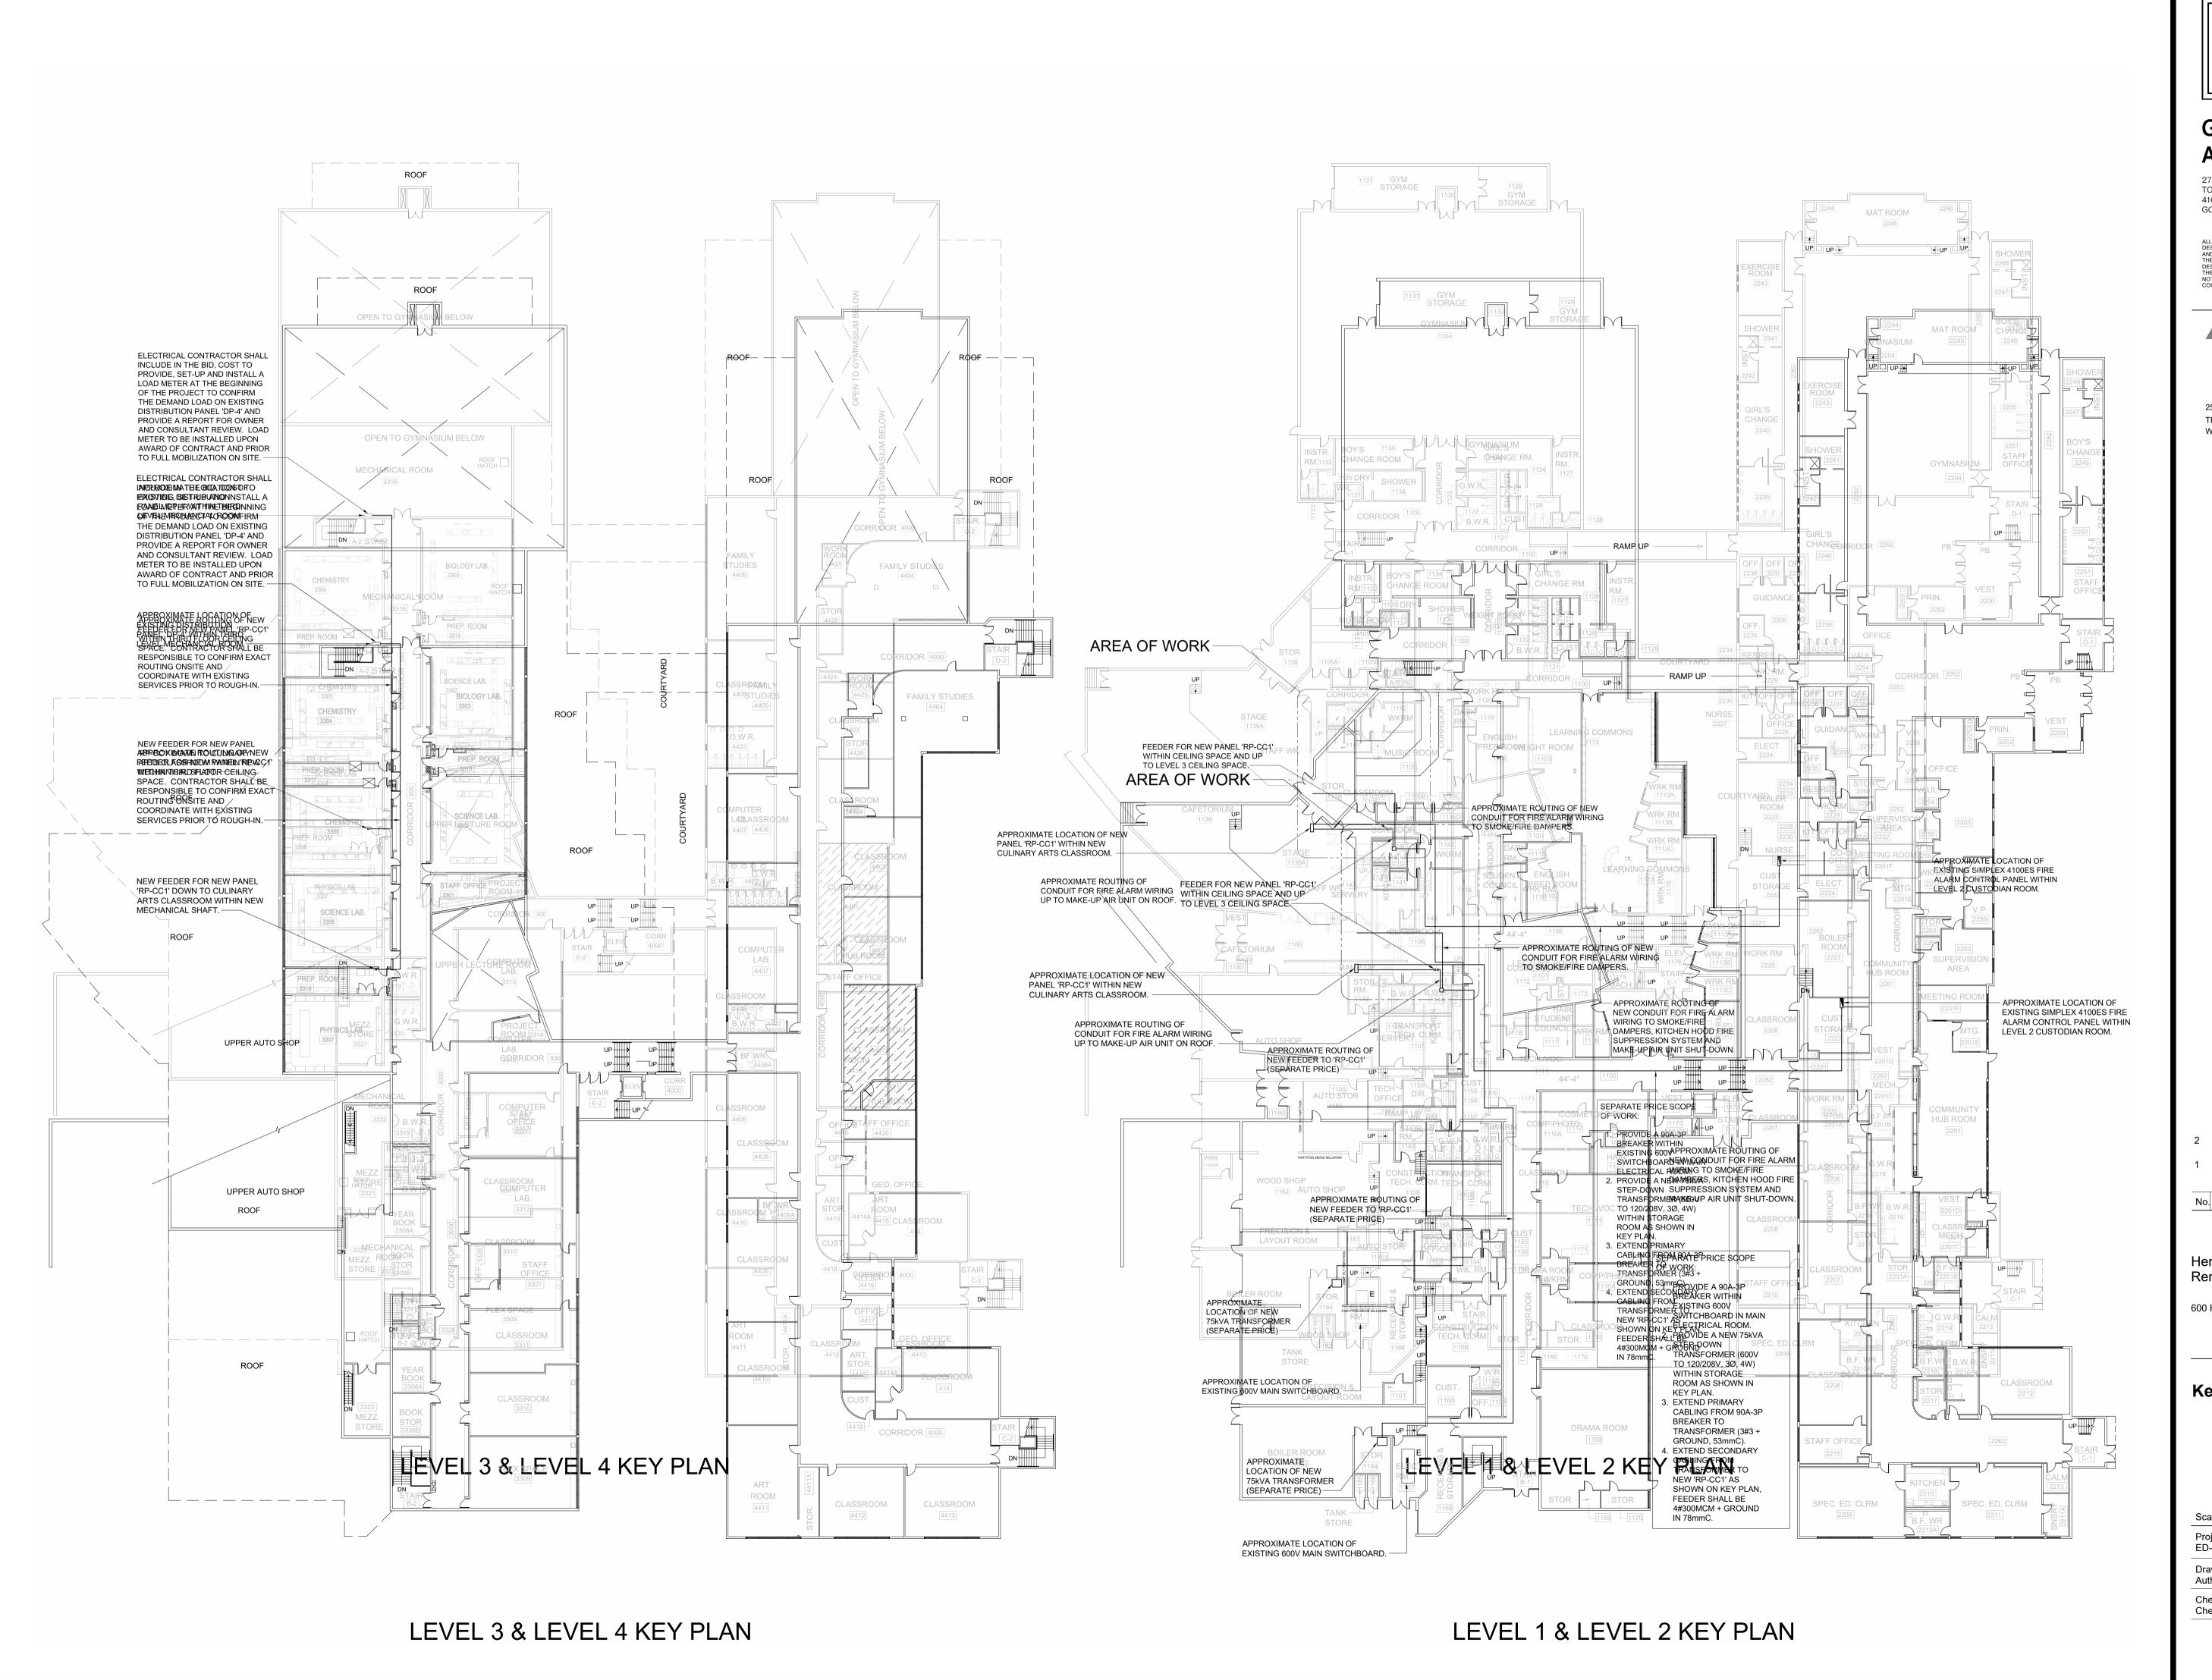

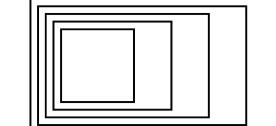

275 SPADINA ROAD TORONTO ONTARIO M5R 2V3 416-920-0031 GOWHASTINGS.COM

ALL DRAWINGS, SPECIFICATIONS, RELATED DOCUMENTS AND DESIGN ARE THE COPYRIGHT PROPERTY OF THE ARCHITECT AND MUST BE RETURNED UPON REQUEST. REPRODUCTION OF THE DRAWINGS, SPECIFICATIONS, RELATED DOCUMENTS AND DESIGN IN WHOLE OR IN PART IS STRICTLY FORBIDDEN WITHOUT THE ARCHITECT'S WRITTEN PERMISSION. THIS DRAWING SHALL NOT BE USED FOR CONSTRUCTION PURPOSES UNLESS COUNTERSIGNED.



250 ROWNTREE DAIRY RD, WOODBRIDGE, ON TEL: 905-507-0800
WEB: WWW.QUASARCG.COM



2 ISSUED FOR PERMIT AND 10/31/2025 TENDER 1 ISSUED FOR 90% CD - CLIENT 10/09/2025 REVIEW

. ISSUED/REVISED DATE

Henry St H.S. Culinary Classroom Renovation

600 Henry St, Whitby, ON L1N 1L4


Keyplans Drawing


Scale: N.T.S.

Project Number:
ED-25-052

Drawn By:
Author

Checked By:
Checker

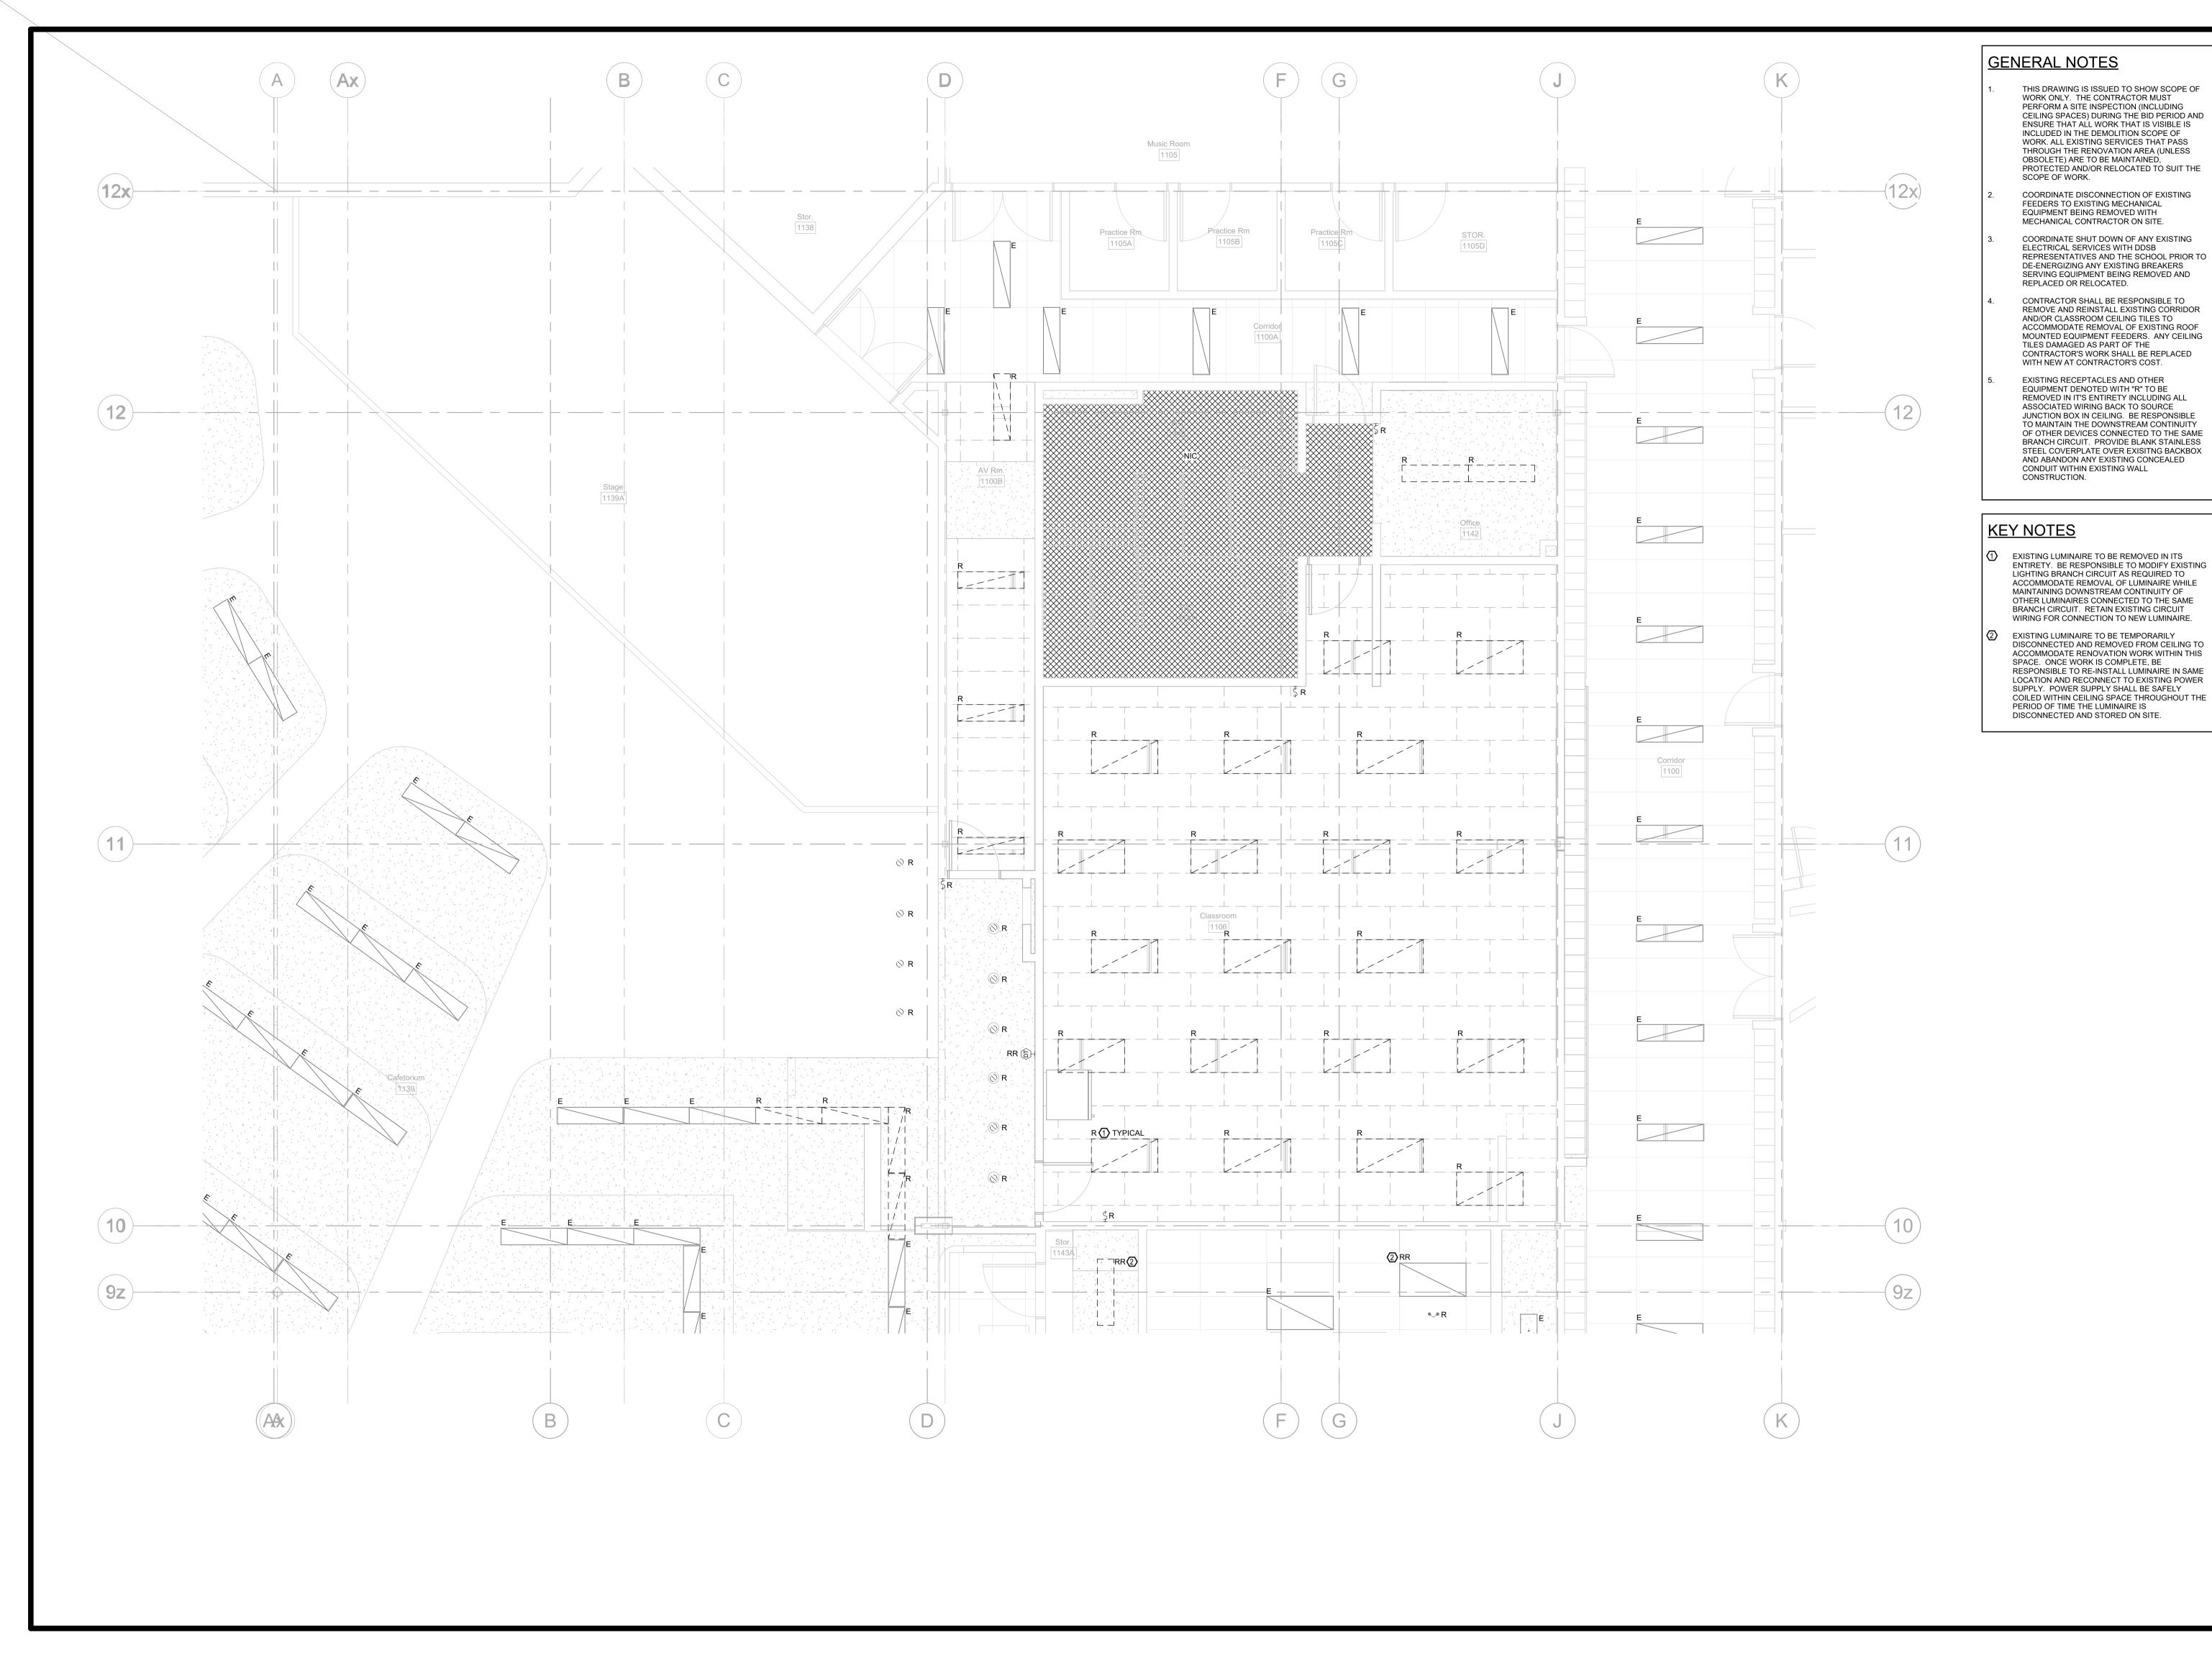

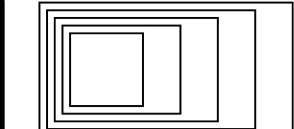

275 SPADINA ROAD TORONTO ONTARIO M5R 2V3 416-920-0031 GOWHASTINGS.COM

ALL DRAWINGS, SPECIFICATIONS, RELATED DOCUMENTS AND DESIGN ARE THE COPYRIGHT PROPERTY OF THE ARCHITECT AND MUST BE RETURNED UPON REQUEST. REPRODUCTION OF THE DRAWINGS, SPECIFICATIONS, RELATED DOCUMENTS AND DESIGN IN WHOLE OR IN PART IS STRICTLY FORBIDDEN WITHOUT THE ARCHITECT'S WRITTEN PERMISSION. THIS DRAWING SHALL NOT BE USED FOR CONSTRUCTION PURPOSES UNLESS COUNTERSIGNED.



250 ROWNTREE DAIRY RD, WOODBRIDGE, ON TEL: 905-507-0800
WEB: WWW.QUASARCG.COM



2 ISSUED FOR PERMIT AND 10/31/2025 TENDER 1 ISSUED FOR 90% CD - CLIENT 10/09/2025 REVIEW

ISSUED/REVISED DATE

Henry St H.S. Culinary Classroom Renovation

600 Henry St, Whitby, ON L1N 1L4


Electrical Demolition Plan
- Lighting


Scale: 1:50

Scale: 1:50

Project Number: ED-25-052

Drawn By:
Author
Checked By:

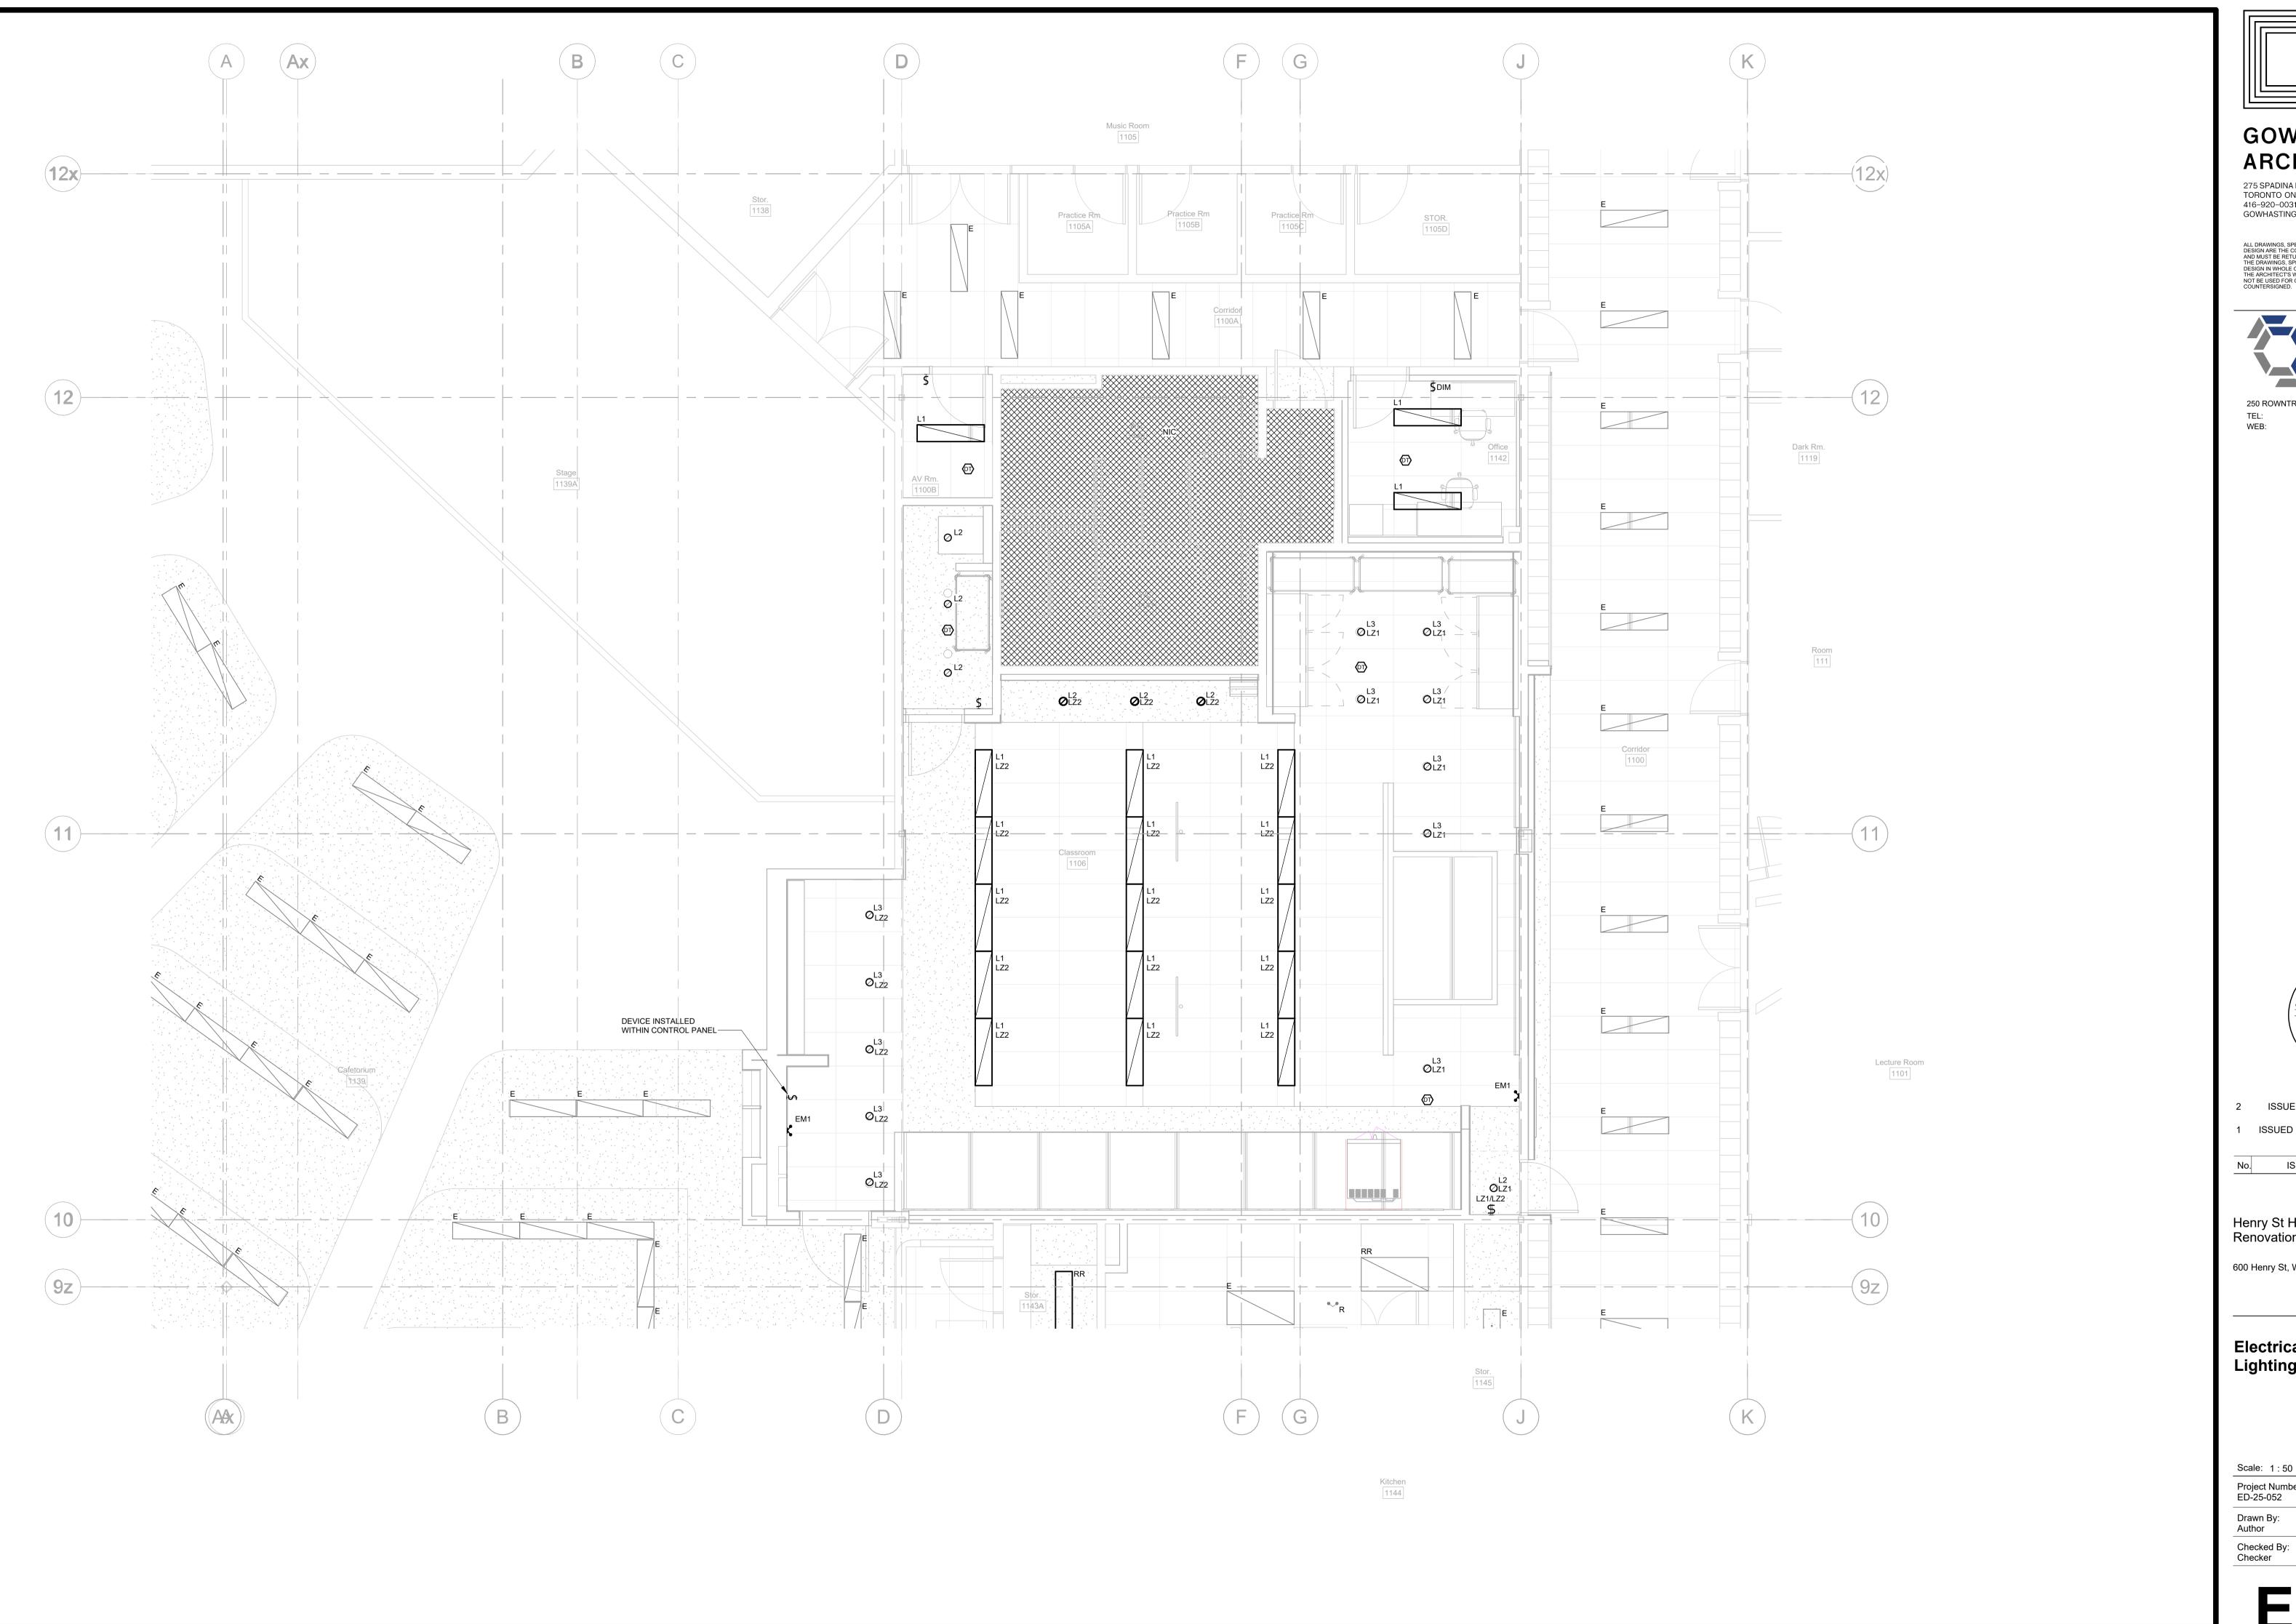

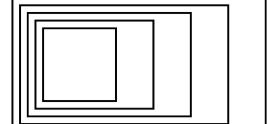

275 SPADINA ROAD TORONTO ONTARIO M5R 2V3 416–920–0031 GOWHASTINGS.COM

ALL DRAWINGS, SPECIFICATIONS, RELATED DOCUMENTS AND DESIGN ARE THE COPYRIGHT PROPERTY OF THE ARCHITECT AND MUST BE RETURNED UPON REQUEST. REPRODUCTION OF THE DRAWINGS, SPECIFICATIONS, RELATED DOCUMENTS AND DESIGN IN WHOLE OR IN PART IS STRICTLY FORBIDDEN WITHOUT THE ARCHITECT'S WRITTEN PERMISSION. THIS DRAWING SHALL NOT BE USED FOR CONSTRUCTION PURPOSES UNLESS COUNTERSIGNED.



250 ROWNTREE DAIRY RD, WOODBRIDGE, ON 905-507-0800 WWW.QUASARCG.COM



2 ISSUED FOR PERMIT AND 10/31/2025 TENDER 1 ISSUED FOR 90% CD - CLIENT 10/09/2025 REVIEW

DATE ISSUED/REVISED


Henry St H.S. Culinary Classroom Renovation


600 Henry St, Whitby, ON L1N 1L4

Electrical New Work Plan -Lighting

Scale: 1:50 Project Number: ED-25-052

Drawn By: Author

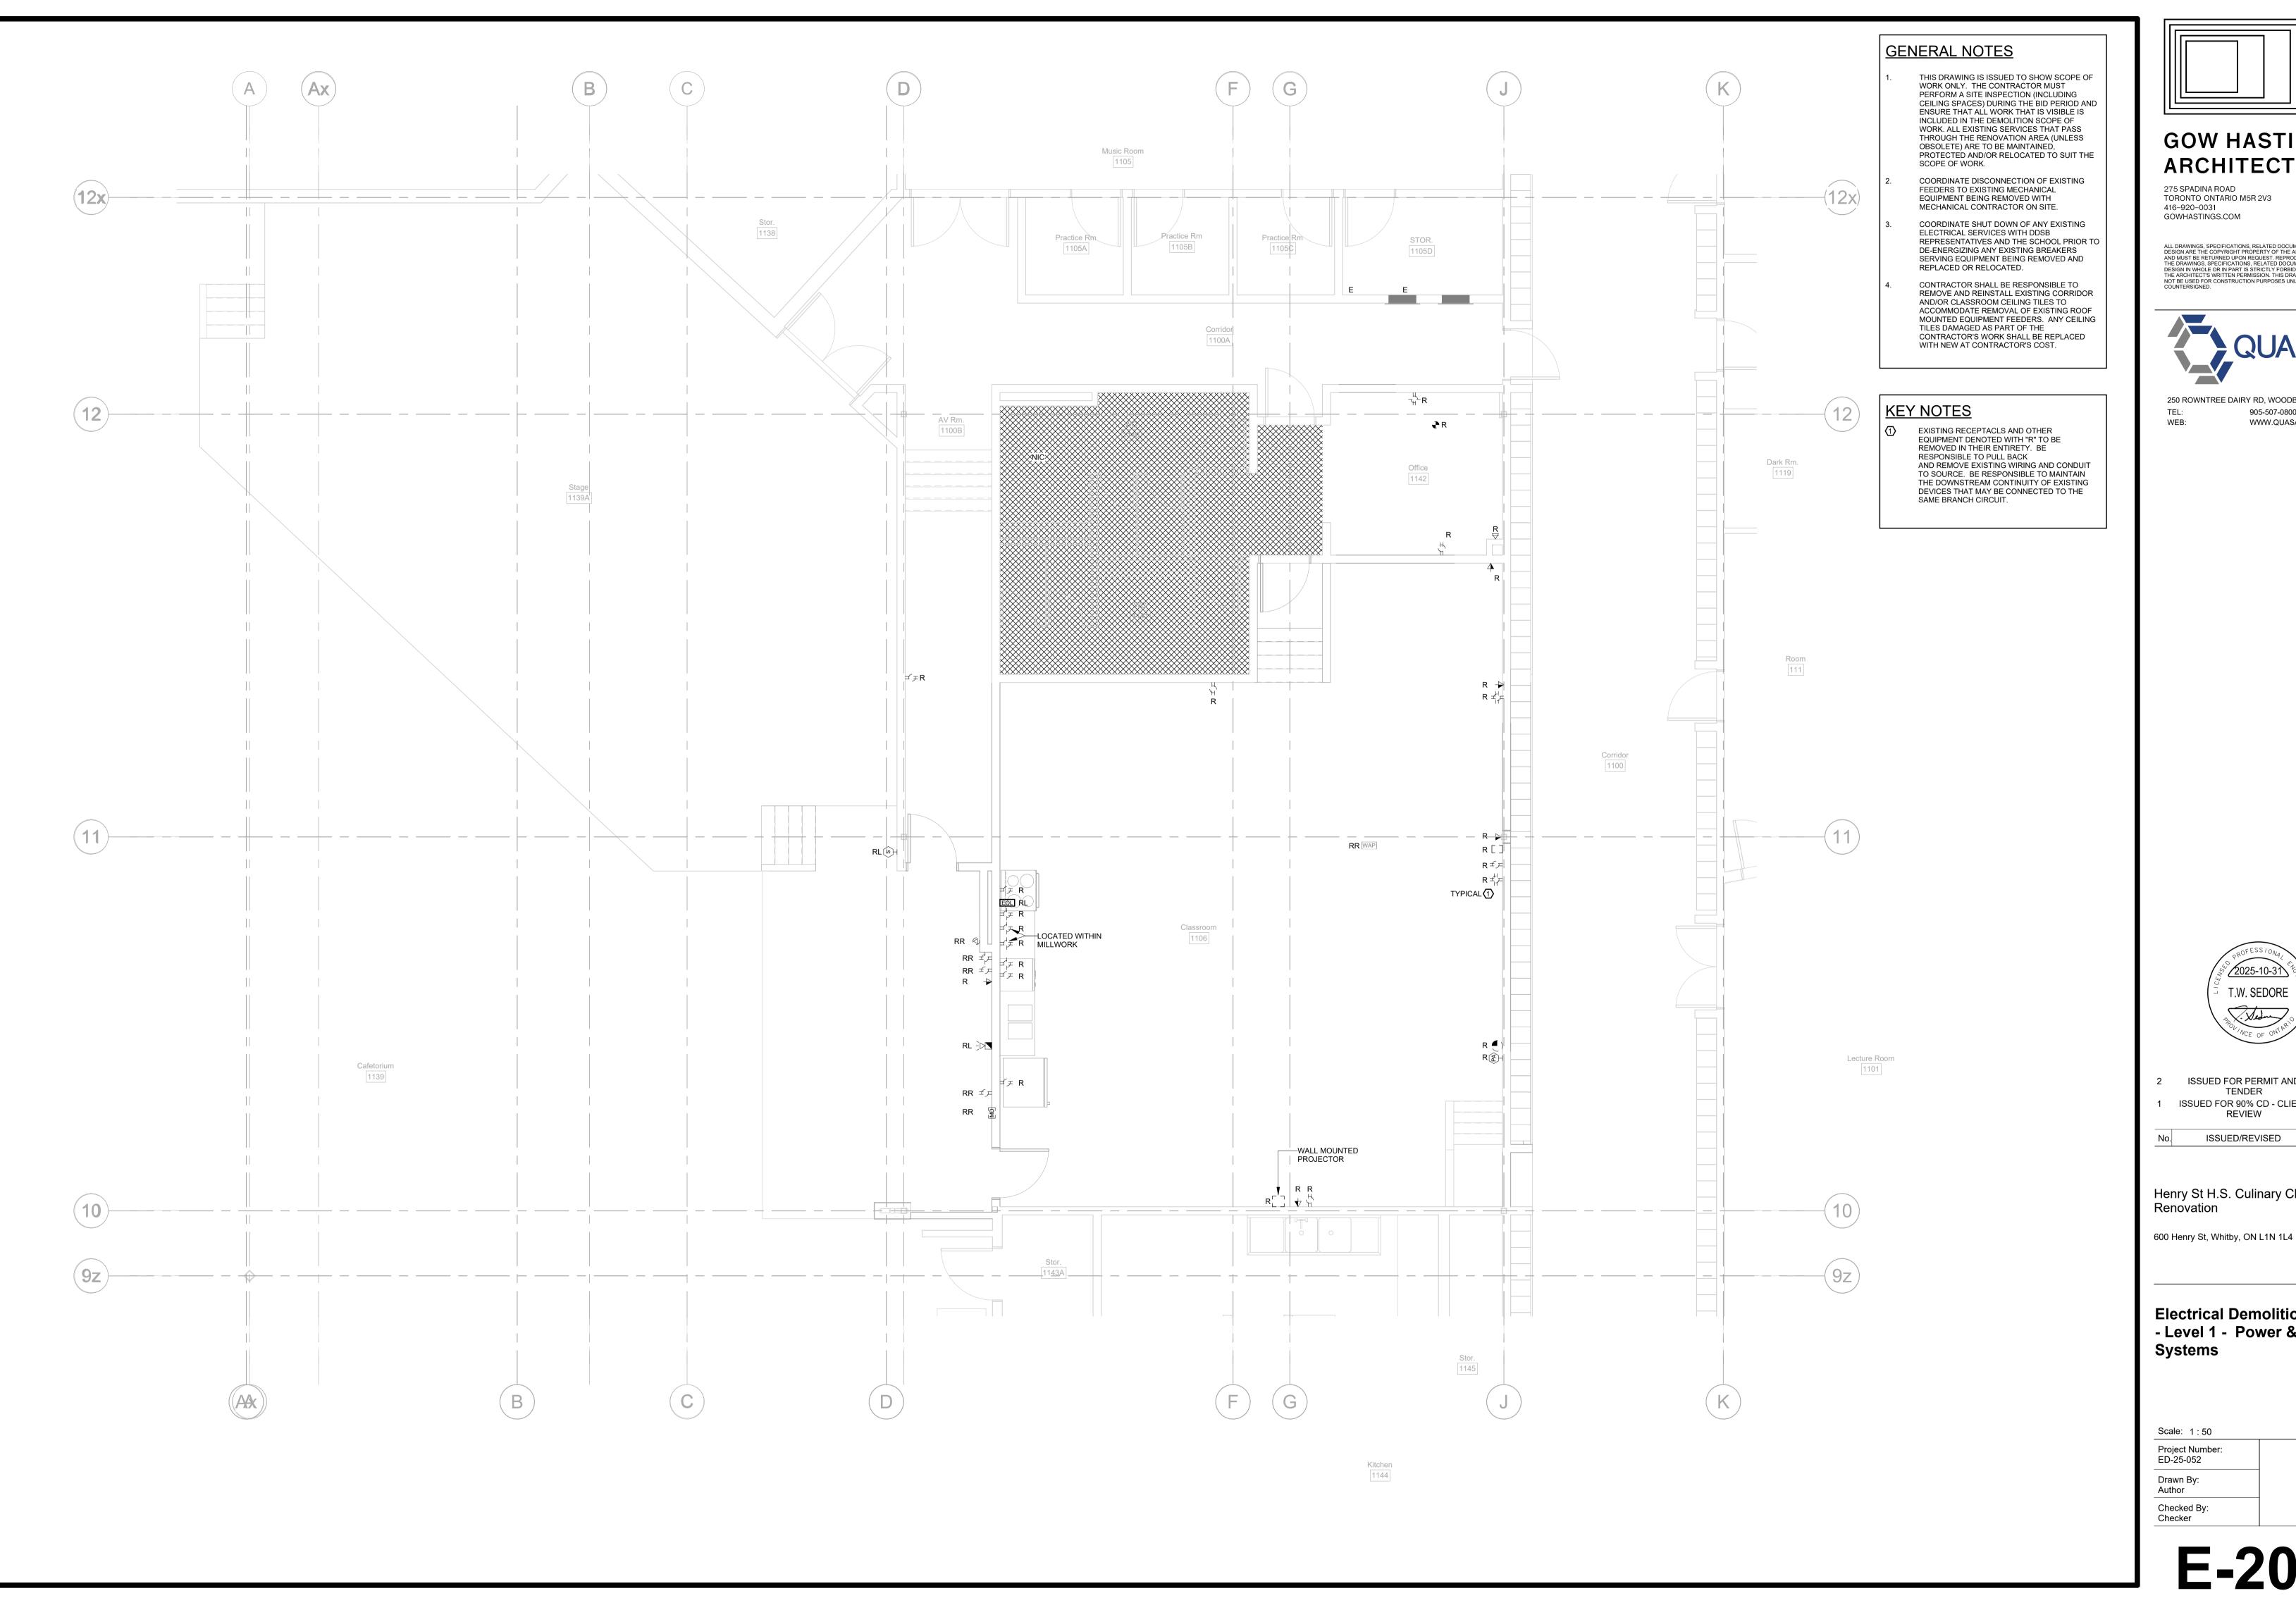

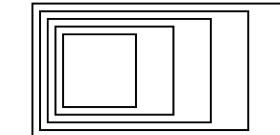

275 SPADINA ROAD TORONTO ONTARIO M5R 2V3 416-920-0031 GOWHASTINGS.COM

ALL DRAWINGS, SPECIFICATIONS, RELATED DOCUMENTS AND DESIGN ARE THE COPYRIGHT PROPERTY OF THE ARCHITECT AND MUST BE RETURNED UPON REQUEST. REPRODUCTION OF THE DRAWINGS, SPECIFICATIONS, RELATED DOCUMENTS AND DESIGN IN WHOLE OR IN PART IS STRICTLY FORBIDDEN WITHOUT THE ARCHITECT'S WRITTEN PERMISSION. THIS DRAWING SHALL NOT BE USED FOR CONSTRUCTION PURPOSES UNLESS COUNTERSIGNED.



250 ROWNTREE DAIRY RD, WOODBRIDGE, ON 905-507-0800 WWW.QUASARCG.COM




ISSUED FOR PERMIT AND 10/31/2025 TENDER 1 ISSUED FOR 90% CD - CLIENT 10/09/2025 REVIEW


> DATE ISSUED/REVISED


Henry St H.S. Culinary Classroom Renovation

Electrical Demolition Plan - Level 1 - Power & **Systems**

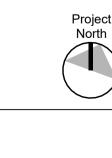

Project Number:

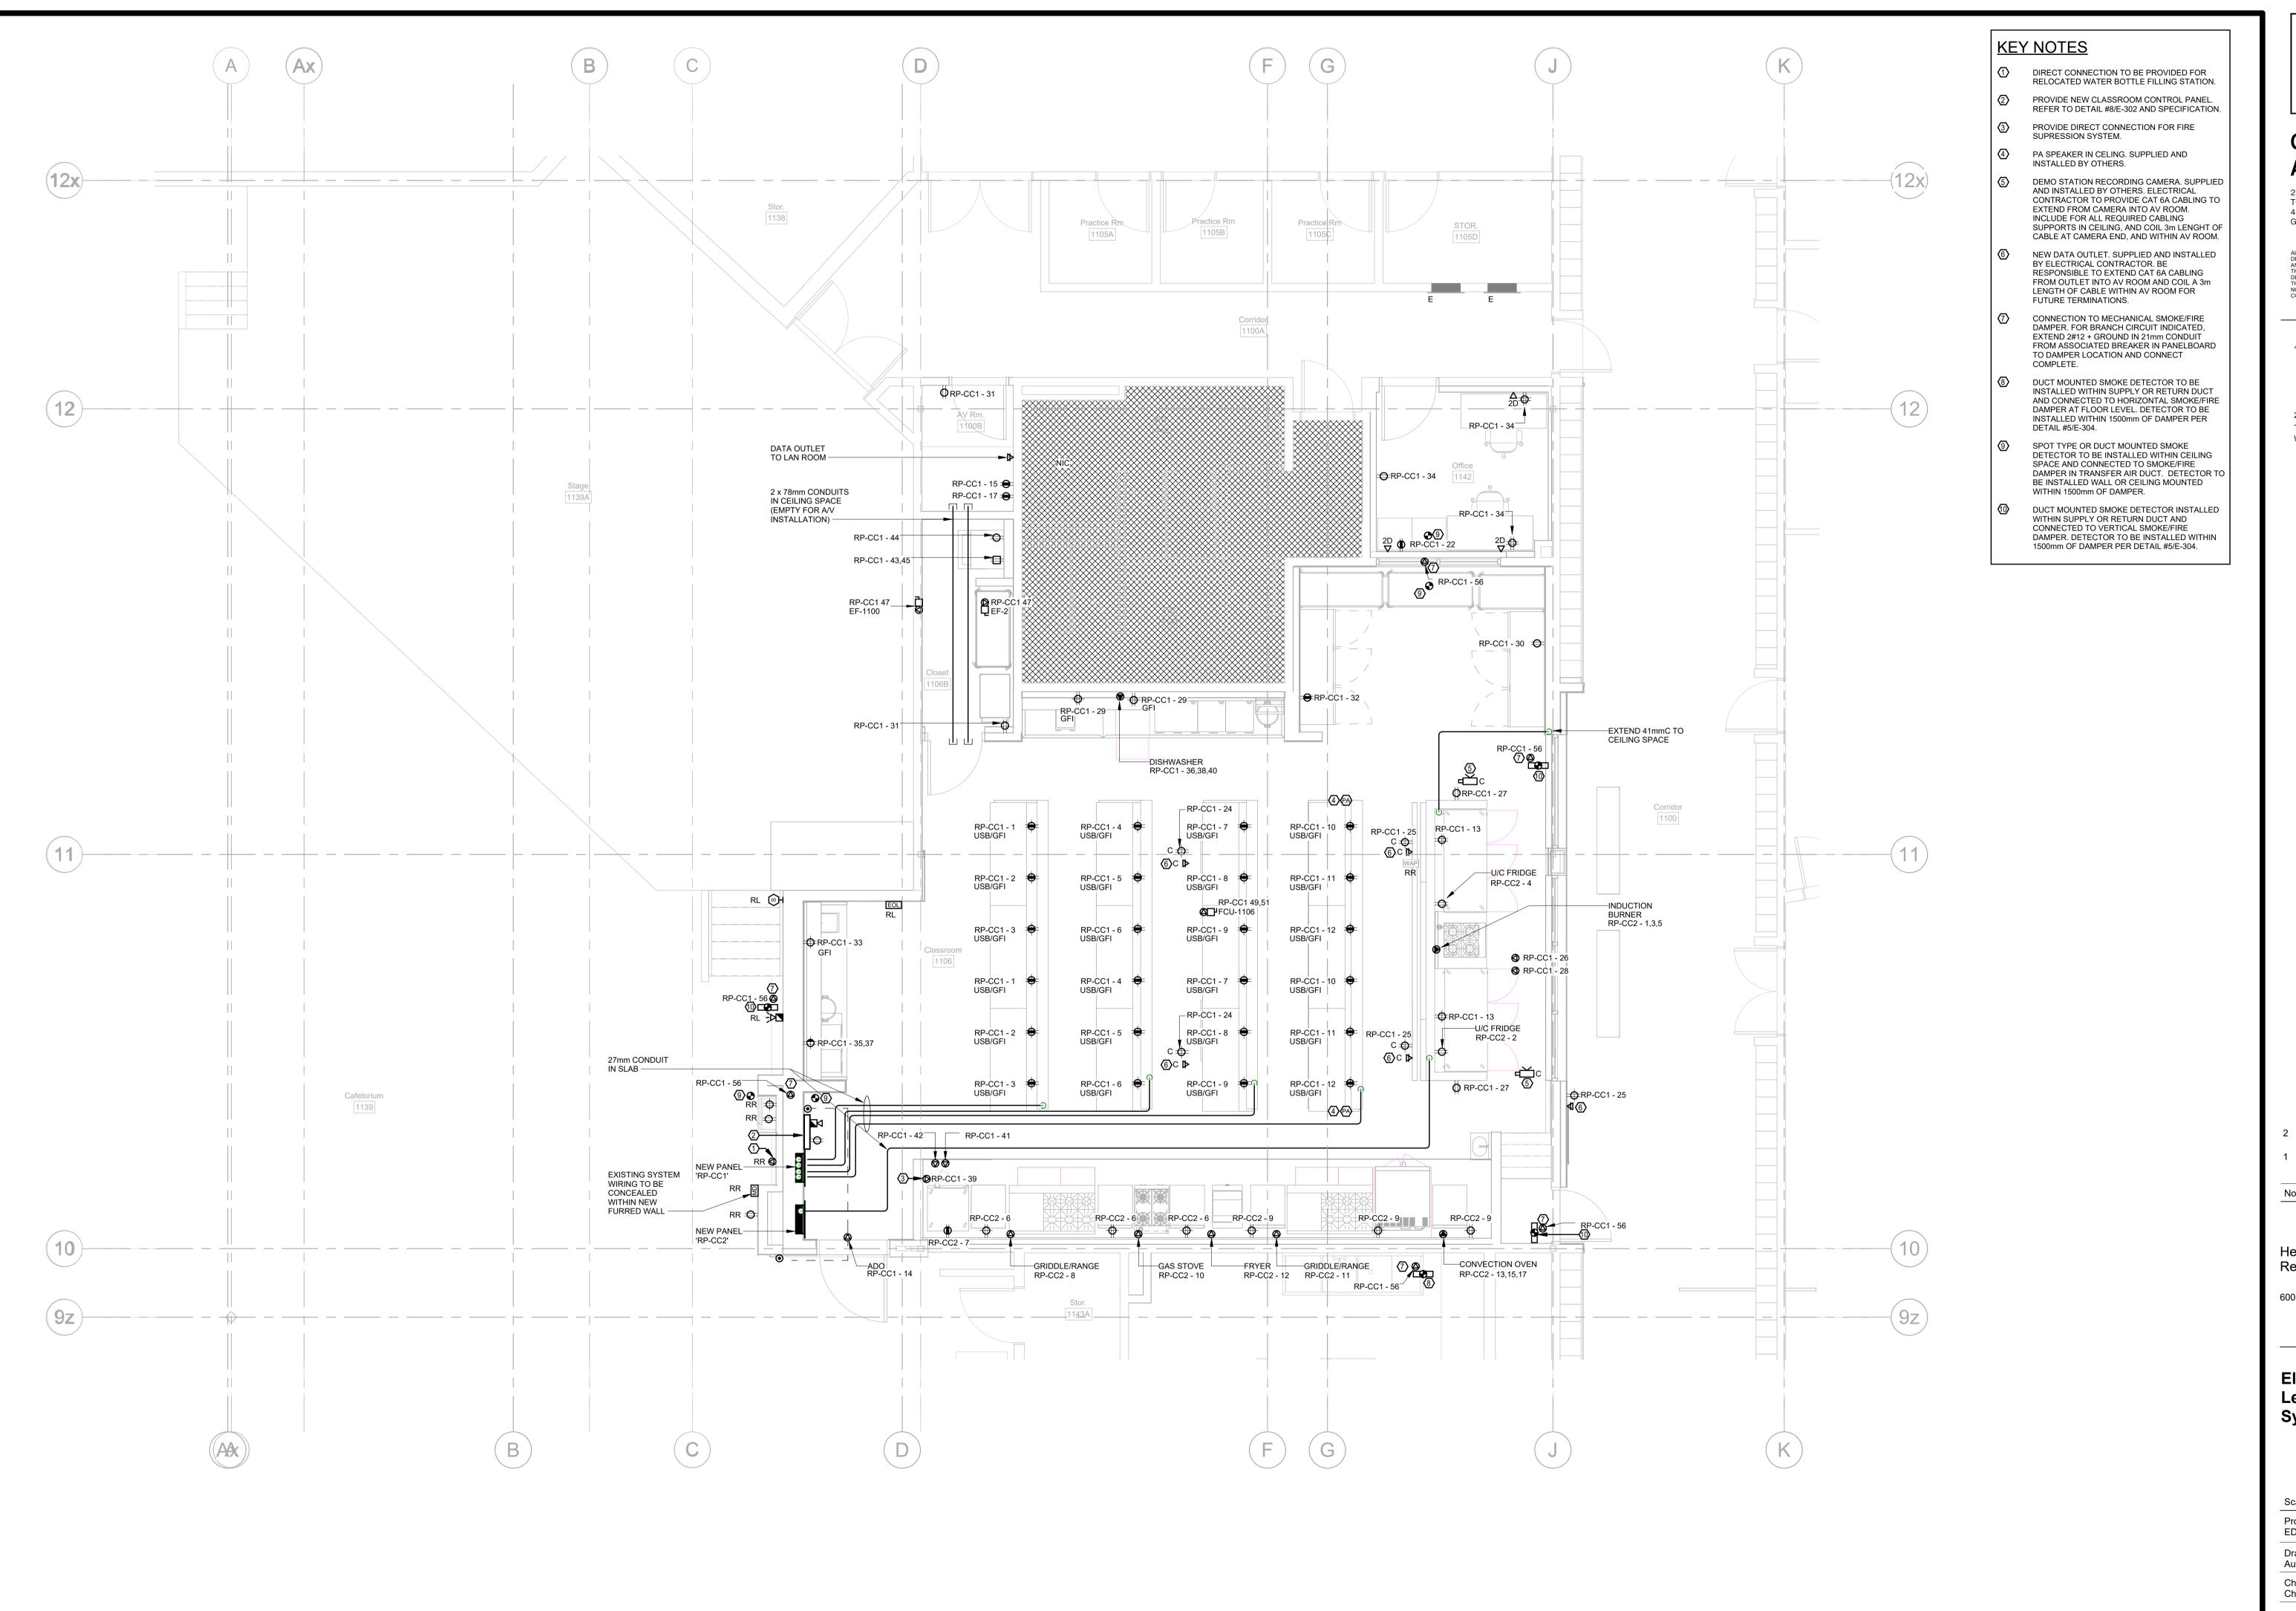

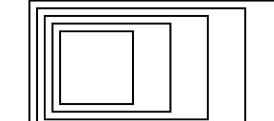

275 SPADINA ROAD TORONTO ONTARIO M5R 2V3 416-920-0031 GOWHASTINGS.COM

ALL DRAWINGS, SPECIFICATIONS, RELATED DOCUMENTS AND DESIGN ARE THE COPYRIGHT PROPERTY OF THE ARCHITECT AND MUST BE RETURNED UPON REQUEST. REPRODUCTION OF THE DRAWINGS, SPECIFICATIONS, RELATED DOCUMENTS AND DESIGN IN WHOLE OR IN PART IS STRICTLY FORBIDDEN WITHOUT THE ARCHITECT'S WRITTEN PERMISSION. THIS DRAWING SHALL NOT BE USED FOR CONSTRUCTION PURPOSES UNLESS COUNTERSIGNED.



250 ROWNTREE DAIRY RD, WOODBRIDGE, ON TEL: 905-507-0800
WEB: WWW.QUASARCG.COM



2 ISSUED FOR PERMIT AND 10/31/2025 TENDER 1 ISSUED FOR 90% CD - CLIENT 10/09/2025 REVIEW

ISSUED/REVISED DATE

Henry St H.S. Culinary Classroom Renovation

600 Henry St, Whitby, ON L1N 1L4

Electrical New Work Plan -Level 1 - Power & Systems

Pr N Cale: 1:50

Scale: 1:50

Project Number:
ED-25-052

Drawn By:
Author

Checked By:
Checker

GENERAL NOTES

THIS DRAWING IS ISSUED TO SHOW SCOPE OF WORK ONLY. THE CONTRACTOR MUST PERFORM A SITE INSPECTION (INCLUDING CEILING SPACES) DURING THE BID PERIOD AND ENSURE THAT ALL WORK THAT IS VISIBLE IS INCLUDED IN THE DEMOLITION SCOPE OF WORK. ALL EXISTING SERVICES THAT PASS THROUGH THE RENOVATION AREA (UNLESS OBSOLETE) ARE TO BE MAINTAINED, PROTECTED AND/OR RELOCATED TO SUIT THE SCOPE OF WORK.

> COORDINATE DISCONNECTION OF EXISTING FEEDERS TO EXISTING MECHANICAL EQUIPMENT BEING REMOVED WITH MECHANICAL CONTRACTOR ON SITE.


COORDINATE SHUT DOWN OF ANY EXISTING ELECTRICAL SERVICES WITH DDSB REPRESENTATIVES AND THE SCHOOL PRIOR TO DE-ENERGIZING ANY EXISTING BREAKERS SERVING EQUIPMENT BEING REMOVED AND REPLACED OR RELOCATED.

CONTRACTOR SHALL BE RESPONSIBLE TO REMOVE AND REINSTALL EXISTING CORRIDOR AND/OR CLASSROOM CEILING TILES TO ACCOMMODATE REMOVAL OF EXISTING ROOF MOUNTED EQUIPMENT FEEDERS. ANY CEILING TILES DAMAGED AS PART OF THE CONTRACTOR'S WORK SHALL BE REPLACED WITH NEW AT CONTRACTOR'S COST.

(1) EXISTING LUMINAIRE TO BE REMOVED IN ITS ENTIRETY. BE RESPONSIBLE TO MODIFY EXISTING LIGHTING BRANCH CIRCUIT AS REQUIRED TO ACCOMMODATE REMOVAL OF LUMINAIRE WHILE MAINTAINING DOWNSTREAM CONTINUITY OF OTHER LUMINAIRES CONNECTED TO THE SAME BRANCH CIRCUIT. RETAIN EXISTING CIRCUIT WIRING FOR CONNECTION TO NEW LUMINAIRE.

KEY NOTES

- EXISTING LUMINAIRE TO BE TEMPORARILY DISCONNECTED AND REMOVED FROM CEILING TO ACCOMMODATE RENOVATION WORK WITHIN THIS SPACE. ONCE WORK IS COMPLETE. BE RESPONSIBLE TO RE-INSTALL LUMINAIRE IN SAME LOCATION AND RECONNECT TO EXISTING POWER SUPPLY. POWER SUPPLY SHALL BE SAFELY COILED WITHIN CEILING SPACE THROUGHOUT THE PERIOD OF TIME THE LUMINAIRE IS DISCONNECTED AND STORED ON SITE.
- 3 EXISTING RECEPTACLE TO BE REMOVED IN IT'S ENTIRETY INCLUDING ALL ASSOCIATED WIRING BACK TO SOURCE JUNCTION BOX IN CEILING. BE RESPONSIBLE TO MAINTAIN THE DOWNSTREAM CONTINUITY OF OTHER DEVICES CONNECTED TO THE SAME BRANCH CIRCUIT. PROVIDE BLANK STAINLESS STEEL COVERPLATE OVER EXISITNG BACKBOX AND ABANDON ANY EXISTING CONCEALED CONDUIT WITHIN EXISTING WALL CONSTRUCTION.
- EXISTING PUBLIC ADDRESS SYSTEM SPEAKER TO BE TEMPORARILY DISCONNECTED AND REMOVED FROM CEILING TO ACCOMMODATE RENOVATION WORK WITHIN THIS SPACE. ONCE WORK IS COMPLETE, BE RESPONSIBLE TO REINSTALL SPEAKER IN SAME LOCATION AND RECONNECT TO EXISTING SYSTEM WIRING COMPLETE. TEST AND VERIFY THAT SPEAKER IS FUNCTIONAL UPON COMPLETION OF WORK.
- (5) PROVIDE NEW LUMINAIRE AND CONNECT TO EXISTING LIGHTING BRANCH CIRCUIT COMPLETE. REFER TO ARCHITECTURAL REFLECTED CEILING PLANS FOR EXACT INSTALLATION LOCATION OF LUMINAIRE.

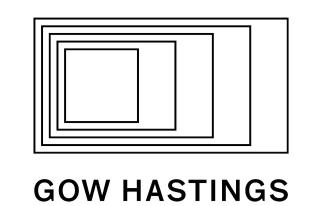

ARCHITECTS

ALL DRAWINGS, SPECIFICATIONS, RELATED DOCUMENTS AND DESIGN ARE THE COPYRIGHT PROPERTY OF THE ARCHITECT AND MUST BE RETURNED UPON REQUEST. REPRODUCTION OF THE DRAWINGS, SPECIFICATIONS, RELATED DOCUMENTS AND DESIGN IN WHOLE OR IN PART IS STRICTLY FORBIDDEN WITHOUT THE ARCHITECT'S WRITTEN PERMISSION. THIS DRAWING SHALL NOT BE USED FOR CONSTRUCTION PURPOSES UNLESS COUNTERSIGNED.

250 ROWNTREE DAIRY RD, WOODBRIDGE, ON

905-507-0800

WWW.QUASARCG.COM

275 SPADINA ROAD TORONTO ONTARIO M5R 2V3

416-920-0031

GOWHASTINGS.COM



ISSUED FOR 90% CD - CLIENT 10/09/2025 REVIEW


ISSUED/REVISED

Henry St H.S. Culinary Classroom Renovation

DATE


600 Henry St, Whitby, ON L1N 1L4


Electrical Plans - Level 2 -**Power and Systems**

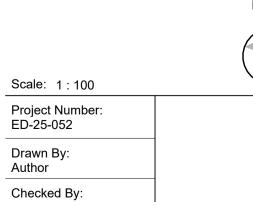



LEVEL 2 - NEW CONSTRUCTION

SCALE: 1:100

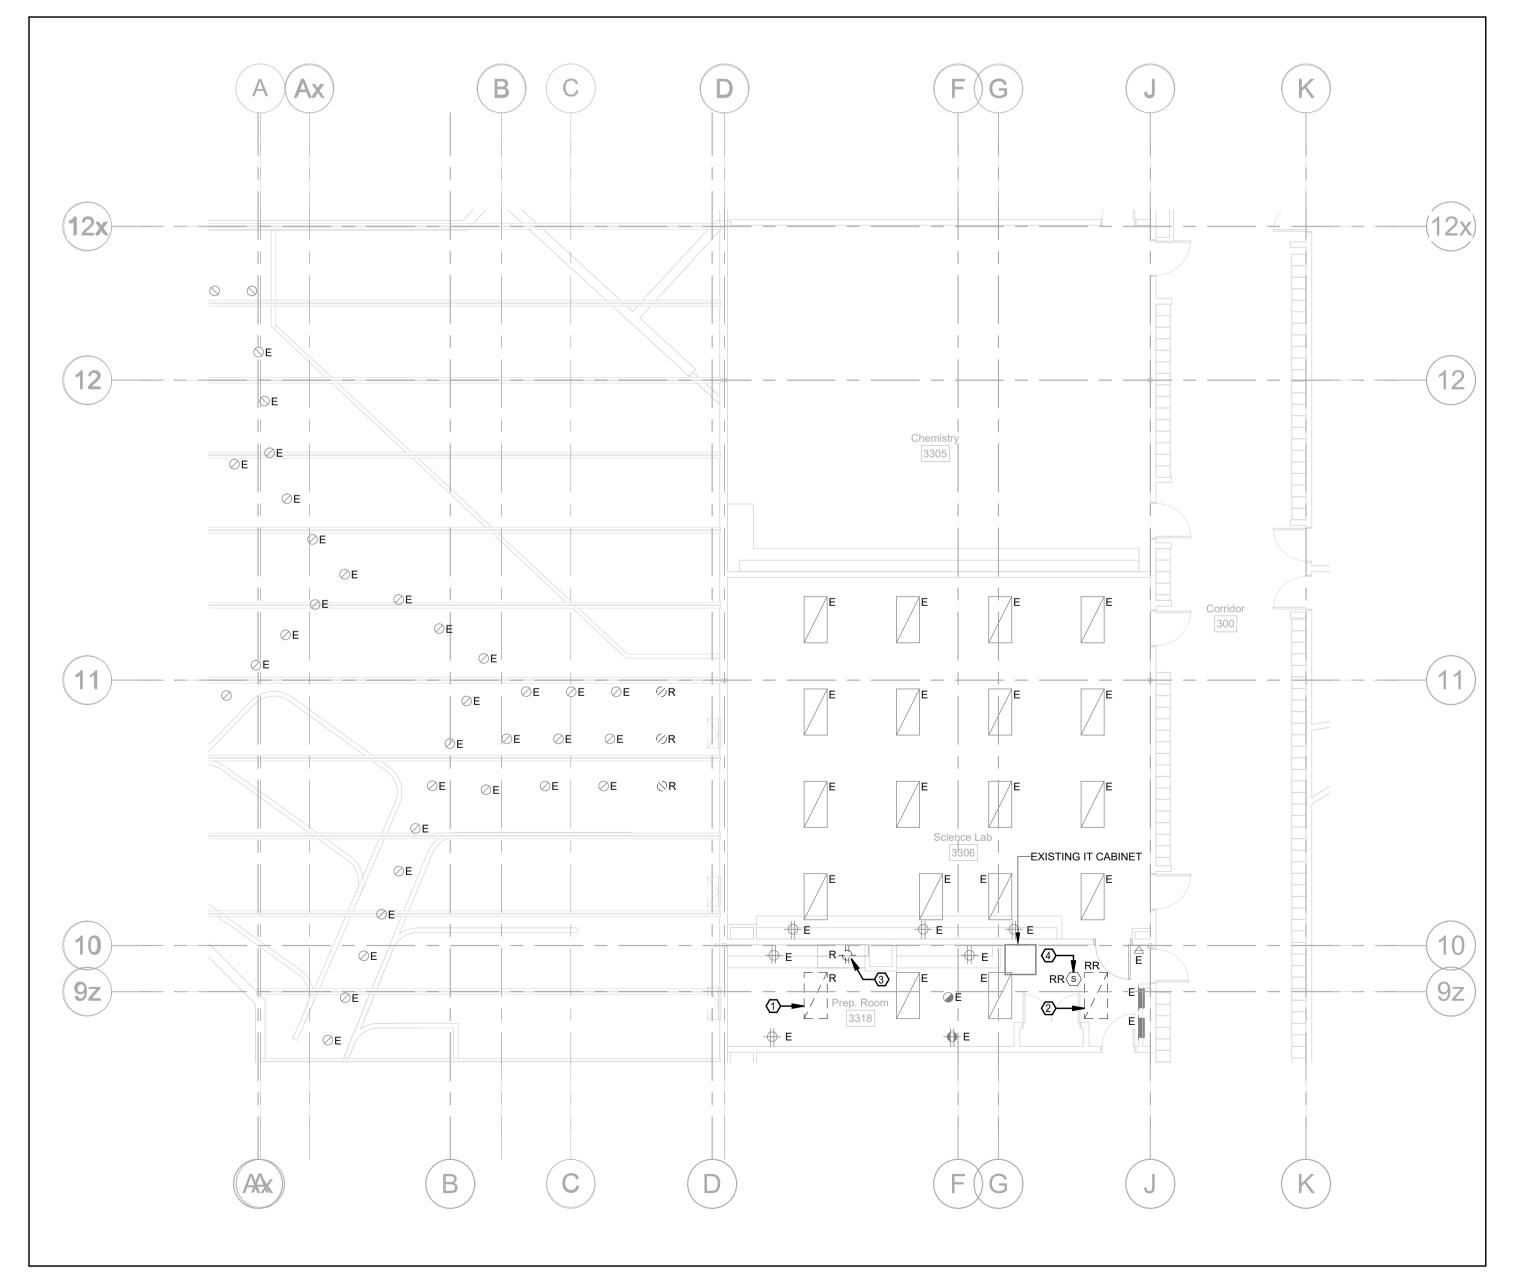

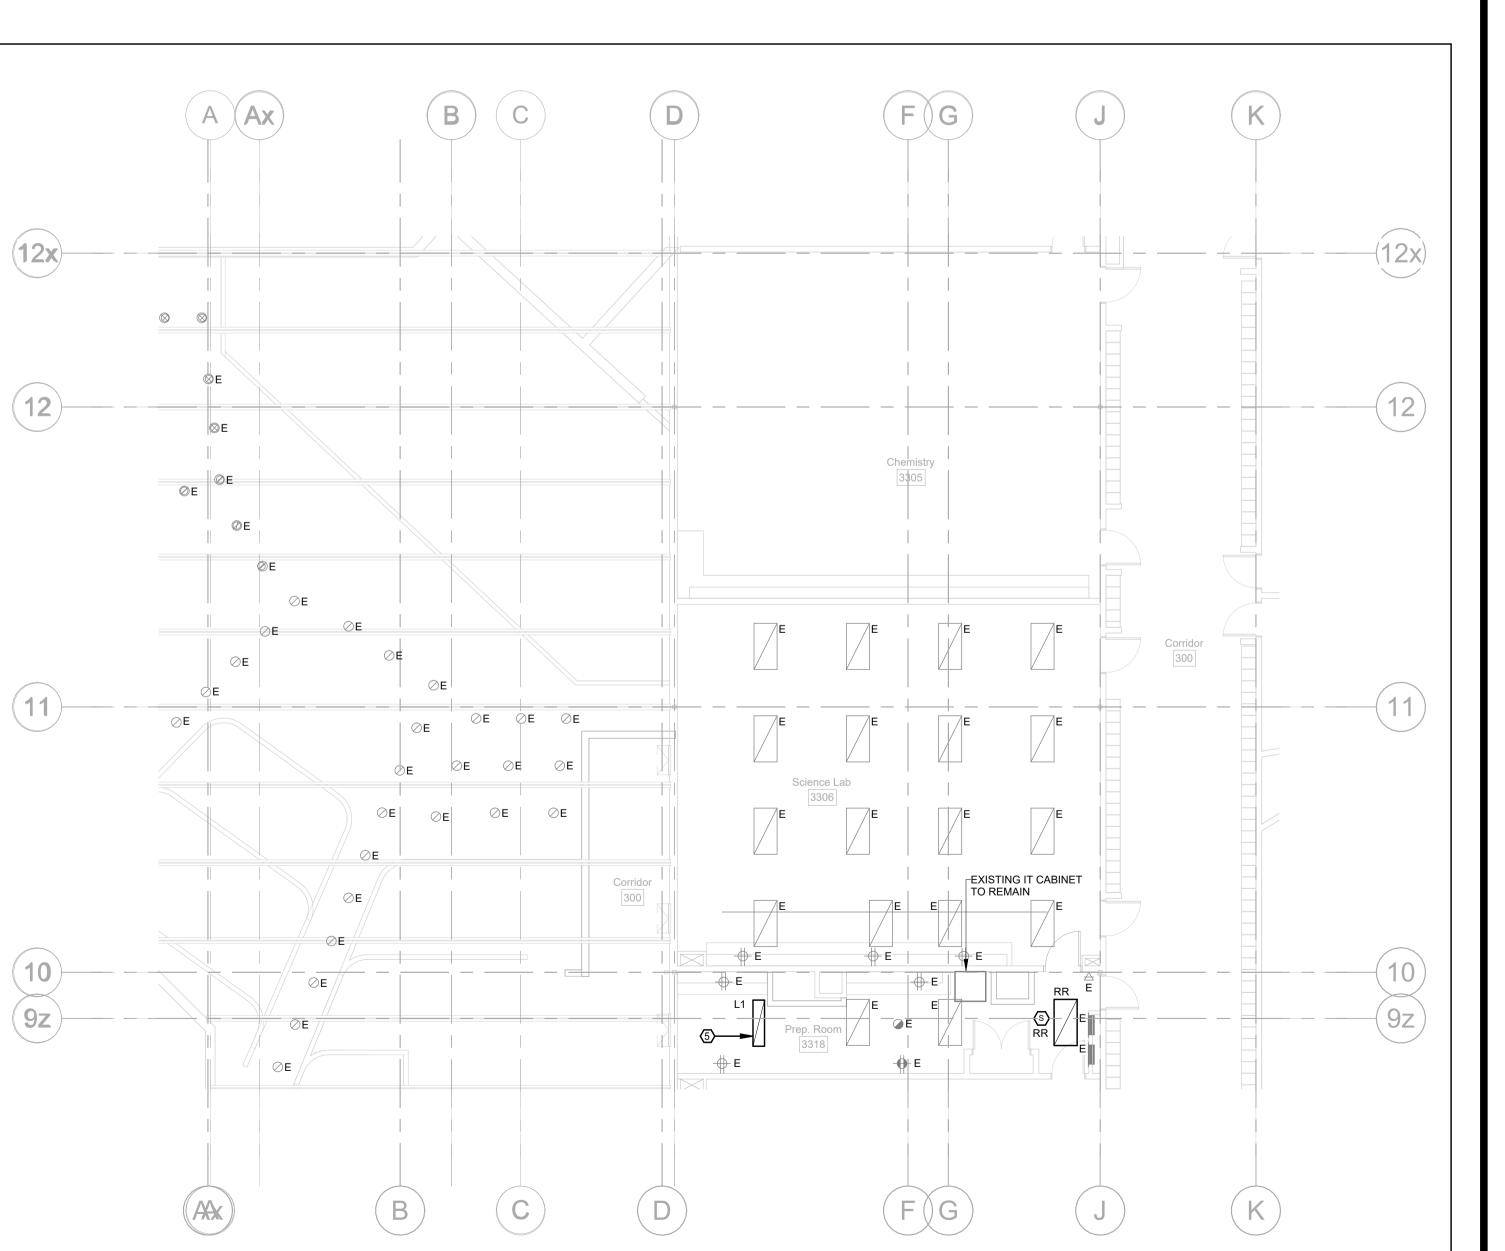

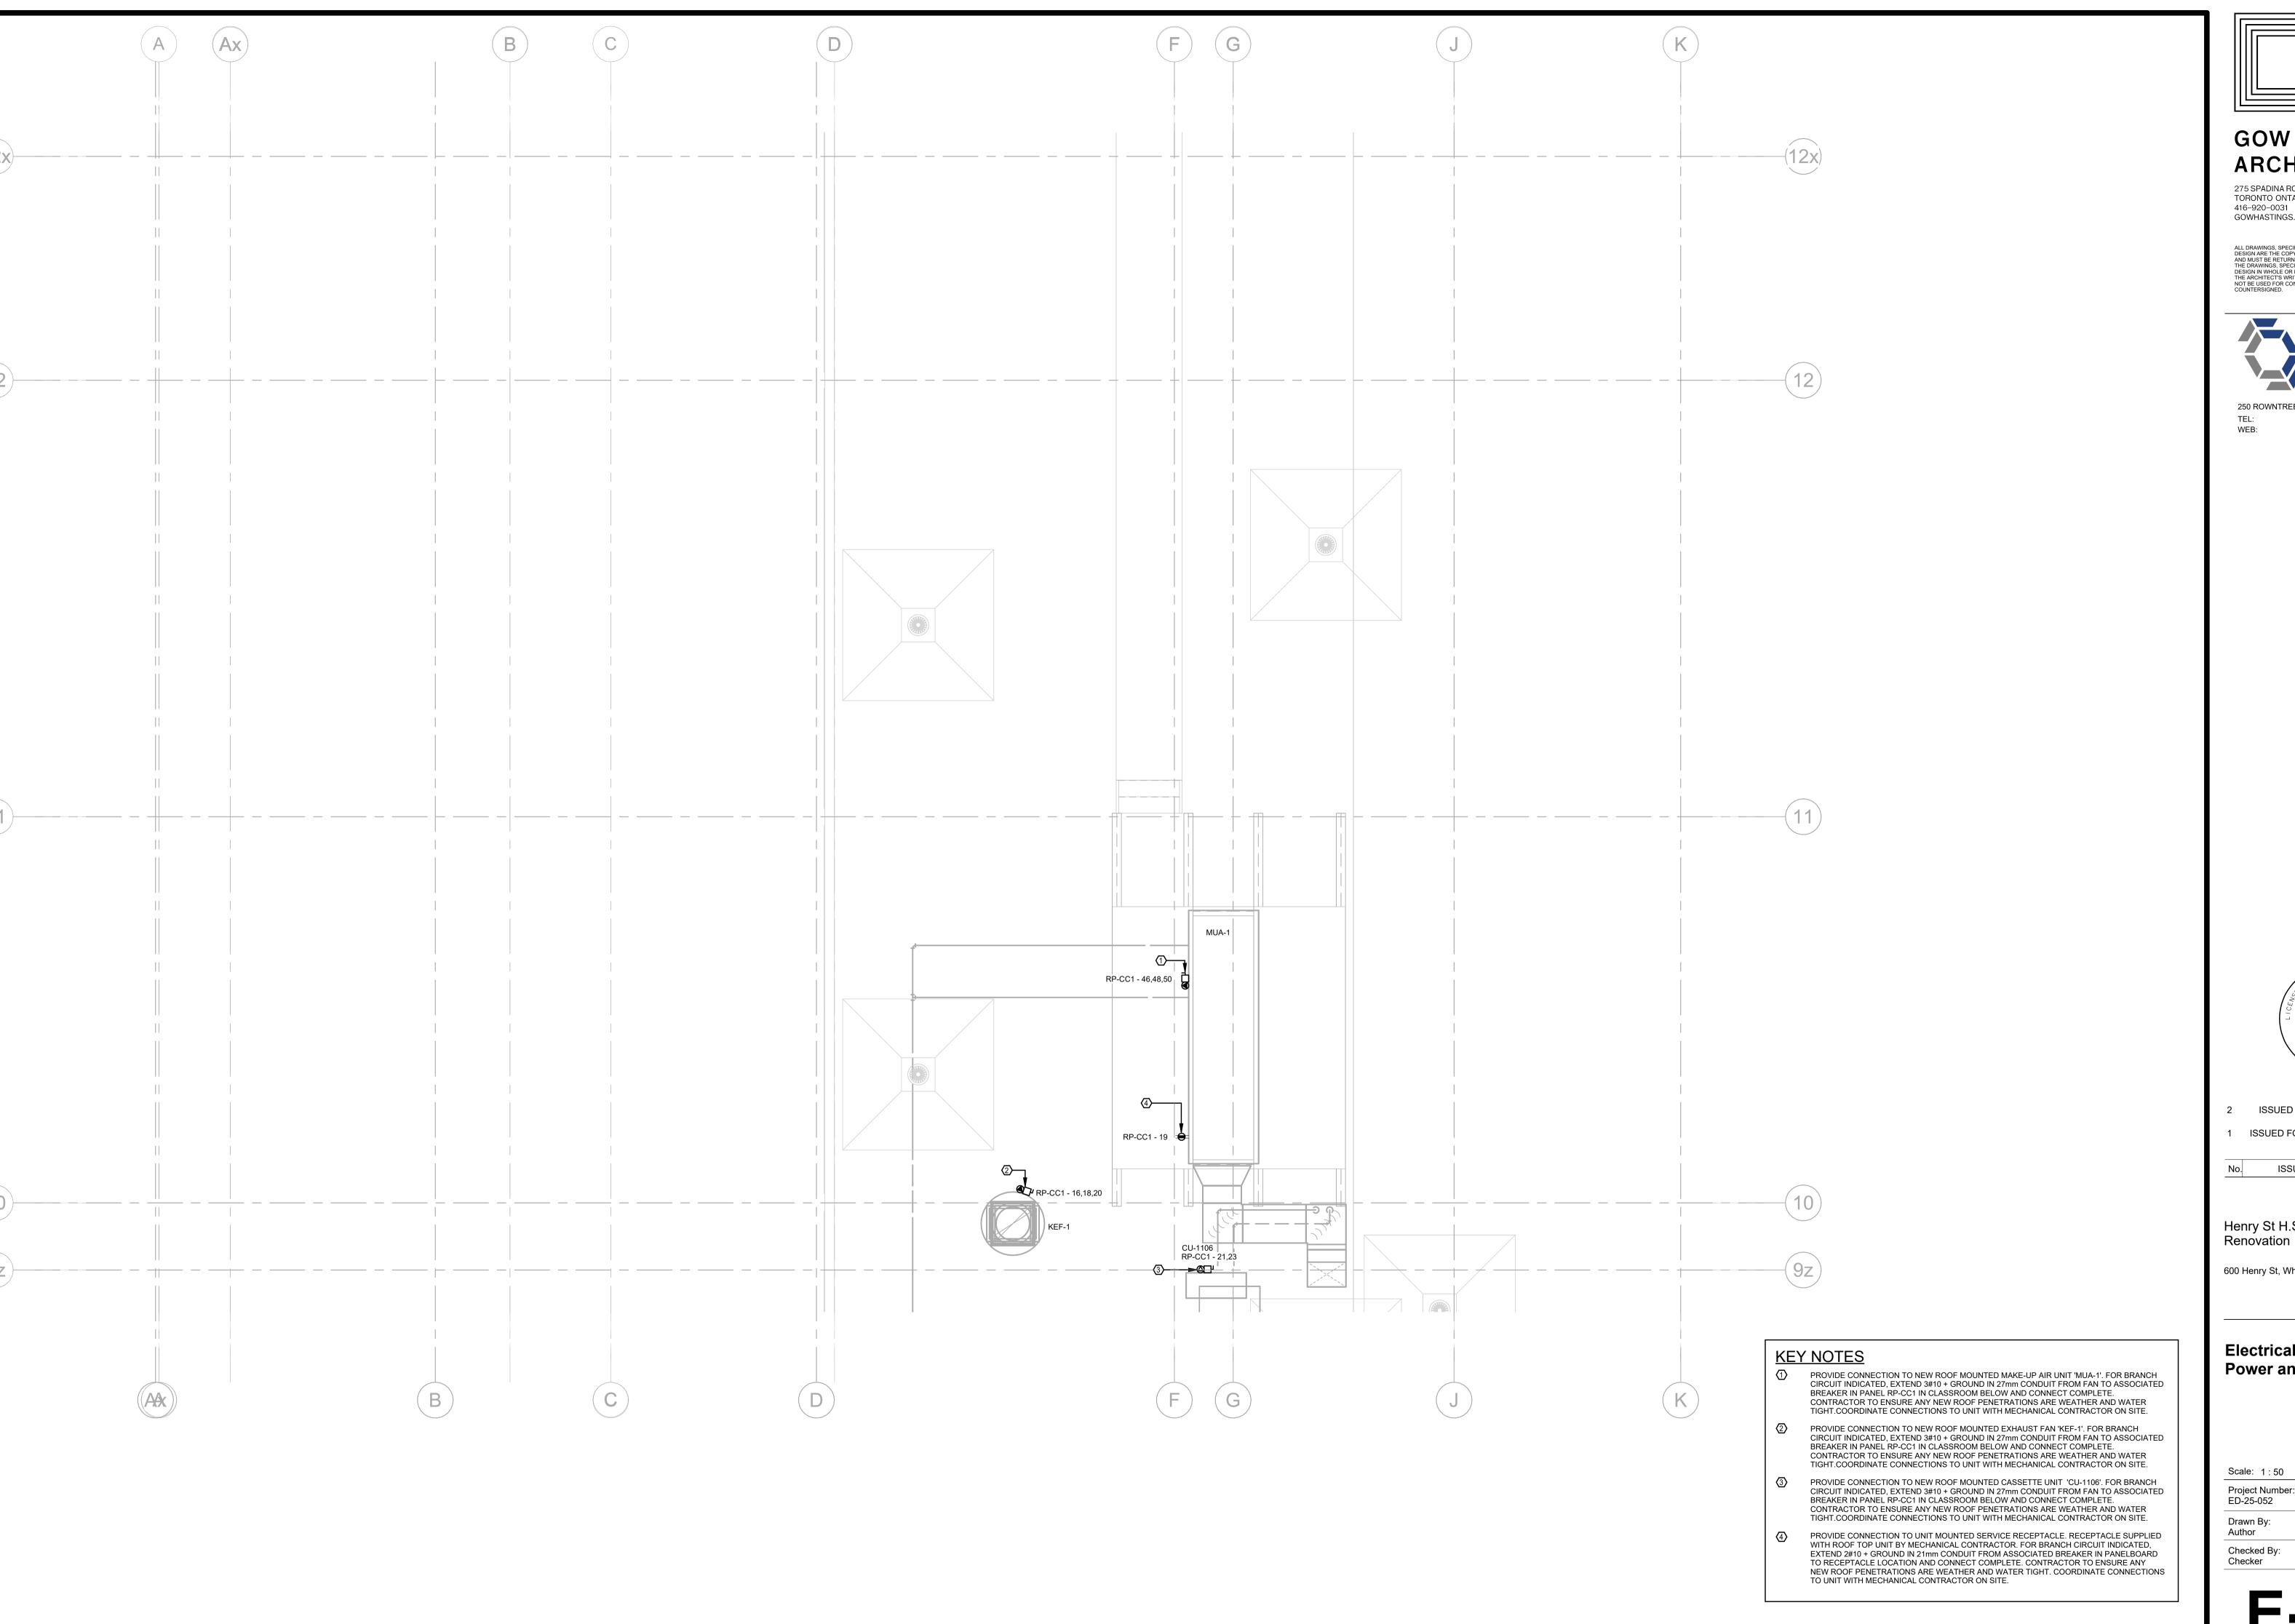

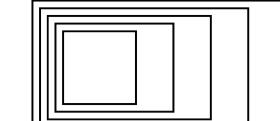

275 SPADINA ROAD TORONTO ONTARIO M5R 2V3 416–920–0031 GOWHASTINGS.COM

ALL DRAWINGS, SPECIFICATIONS, RELATED DOCUMENTS AND DESIGN ARE THE COPYRIGHT PROPERTY OF THE ARCHITECT AND MUST BE RETURNED UPON REQUEST. REPRODUCTION OF THE DRAWINGS, SPECIFICATIONS, RELATED DOCUMENTS AND DESIGN IN WHOLE OR IN PART IS STRICTLY FORBIDDEN WITHOUT THE ARCHITECT'S WRITTEN PERMISSION. THIS DRAWING SHALL NOT BE USED FOR CONSTRUCTION PURPOSES UNLESS COUNTERSIGNED.



250 ROWNTREE DAIRY RD, WOODBRIDGE, ON 905-507-0800 WWW.QUASARCG.COM




2 ISSUED FOR PERMIT AND 10/31/2025 **TENDER** 1 ISSUED FOR 90% CD - CLIENT 10/09/2025 REVIEW

> DATE ISSUED/REVISED

Henry St H.S. Culinary Classroom Renovation

600 Henry St, Whitby, ON L1N 1L4

Electrical Plans - Roof -**Power and Systems**

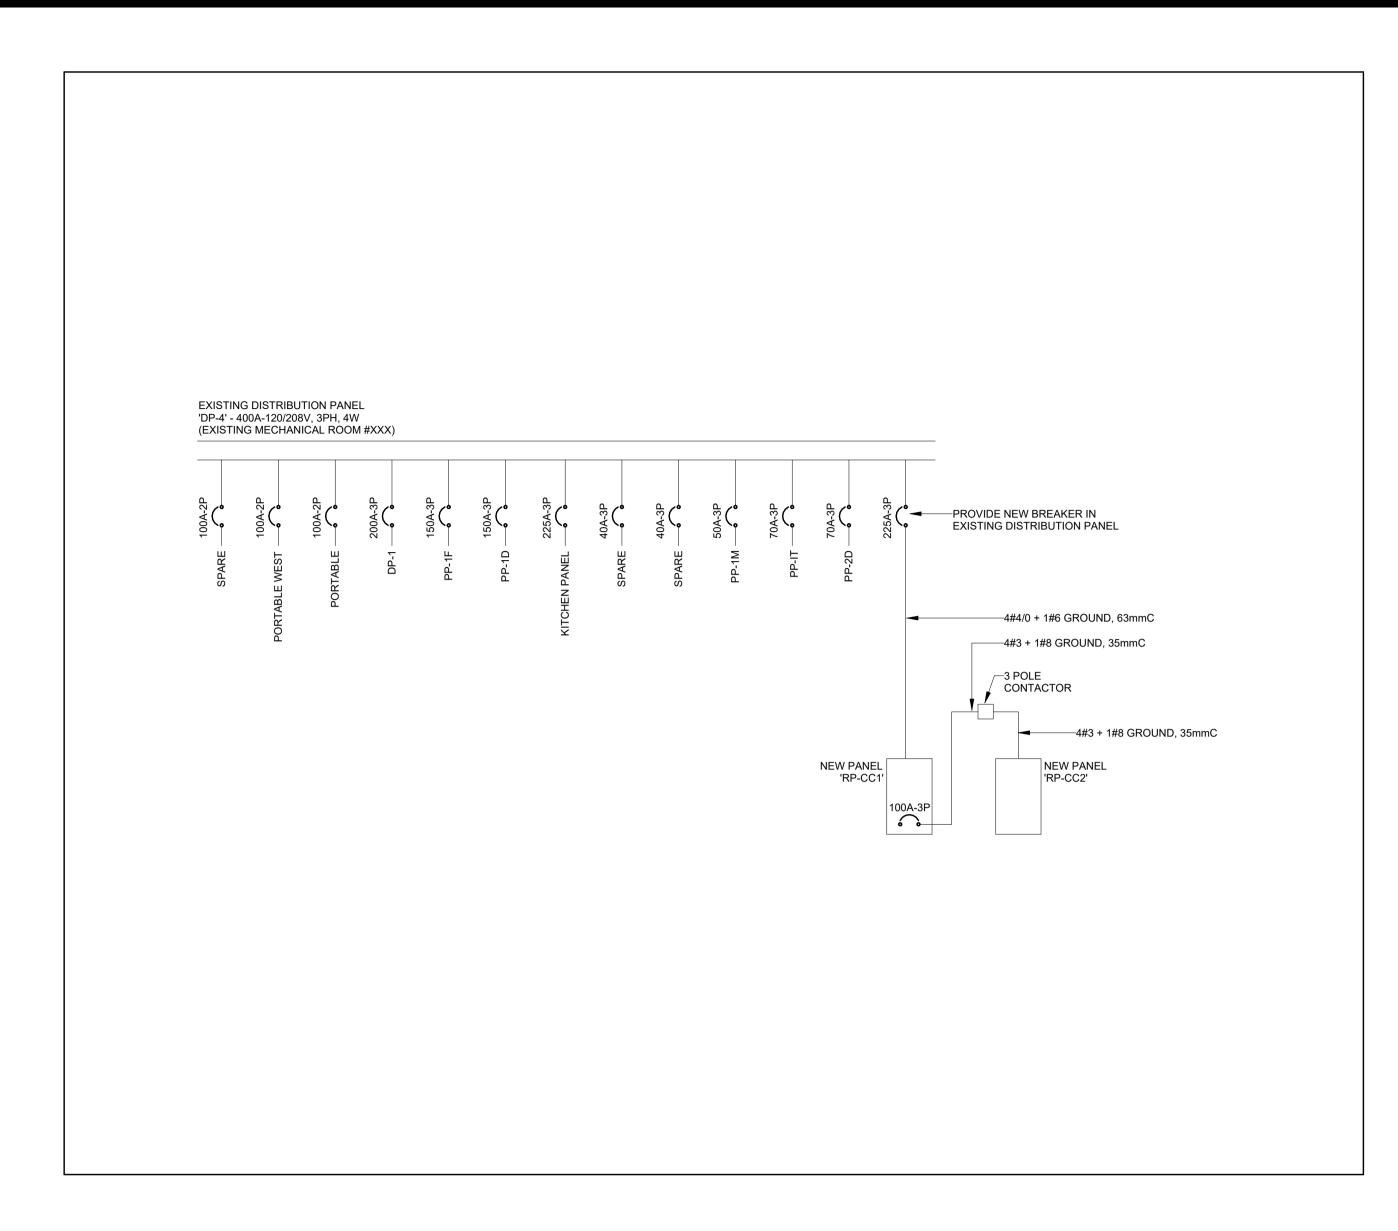

		QTY	Trip	Poles		A		В		C	Poles	Trip	QTY			
СКТ	Circuit Description	~	,p	1 0.00			•	_			0.00		٠	Circuit	Description	
1	RECEPTACLE	2	20 A	1	1920 VA	1920 VA					1	20 A	2	RECEPTACLE		
3	RECEPTACLE	2	20 A	1				1920 VA			1	20 A	2	RECEPTACLE		
5	RECEPTACLE	2	20 A	1					1920 VA	1920 VA	1	20 A	2	RECEPTACLE		
7	RECEPTACLE	2	20 A	1	1920 VA	1920 VA					1	20 A	2	RECEPTACLE		
9	RECEPTACLE	2	20 A	1			1920 VA	1920 VA			1	20 A	2	RECEPTACLE		
11	RECEPTACLE	2	20 A	1					1920 VA	1920 VA	1	20 A	2	RECEPTACLE		
13	RECEPTACLE	2	15 A	1	360 VA	500 VA					1	20 A	1	ADO		
15	RECEPTACLE - AV ROOM	1	20 A	1			1920 VA	2005 VA								
17	RECEPTACLE - AV ROOM	1	20 A	1					1920 VA	2005 VA	3	40 A	1	KEF-1		
19	RECEPTACLE	1	20 A	1	1920 VA	2005 VA										
21	CH 1106	1	20.4	2			1664 VA	1920 VA			1	20 A	1	RECEPTACLE		
23	- CU-1106	1	20 A	2					1664 VA	1440 VA	1	20 A	2	RECEPTACLE		
25	RECEPTACLE - TVs	3	15 A	1	1440 VA	700 VA					1	15 A	1	EXHAUST HOOD DIRE	ECT CONNECTION 1.B	
27	RECEPTACLE	2	15 A	1			1440 VA	1440 VA			1	15 A	1	EXHAUST HOOD DIRE	ECT CONNECTION 2.B	
29	RECEPTACLE	2	15 A	1					1440 VA	1020 VA	1	15 A	1	RECEPTACLE - CABIN	IET	
31	RECEPTACLE - CLOSET/AV ROOM	2	15 A	1	1440 VA	1440 VA					1	20 A	1	RECEPTACLE - FREE	ZER	
33	RECEPTACLE	1	15 A	1			720 VA	1440 VA			1	15 A	3	RECEPTACLE - OFFIC	E	
35	RECEPTACLE - SPLIT	1	15 A	2					2496 VA	3242 VA						
37	RECEPTAGLE - SPLIT	'	13 A		0 VA	3242 VA					3	35 A	1	DISHWASHER		
39	FIRE SUPPRESSION SYSTEM	1	15 A	1			600 VA	3242 VA								
41	EXHAUST HOOD DIRECT CONNECTION 1.A	1	15 A	1					46 VA	46 VA	1	15 A	1	EXHAUST HOOD DIRE	ECT CONNECTION 2.A	
43	- DRYER	1	30 A	2	2496 VA	180 VA					1	15 A	1	WASHER		
45	DRIER	· ·	30 A	2			2496 VA	2570 VA								
47	EF-1100	2	15 A	1					1000 VA	2570 VA	3	30 A	1	MUA-1		
49	 -FCU-1106	1	15 A	2	250 VA	2570 VA										
51	1 00-1100	'	10 /				250 VA	0 VA			1	15 A		SPARE		
53	SPARE		15 A	1					0 VA	0 VA	1	15 A		SPARE		\perp
55					11447	1200 VA					1	20 A	6	SFD		
57	RP-CC2	1	100 A	3			10967	0 VA			1	20 A		SPARE		
59									11987	0 VA	1	20 A		SPARE		\perp
				al Load:		70 VA		54 VA		55 VA						
egend:	:		Tota	l Amps:		24 A		7 A	32	1 A						
	assification			nected L		De	mand Fac	ctor	Esti	mated De				Panel	Totals	
Other				2811 VA			50.00%			16406 V						
Recepta				0568 VA			50.00%			25284 V				Total Conn. Load:		
	- Receptacles			5640 VA			80.00%			4512 VA			Total Est. Demand: 69210 VA			
RP-CC2	- Other		2	8760 VA	١		80.00%			23008 V	4			Total Conn.:		
														Total Est. Demand:	192 A	
Notes: I. PANE	L SHALL BE ABLE TO ACCEPT 300MCM CABLE T	ERMINATI	ON.													

Volts: 120/208 Wye

Phases: 3

Wires: 4

A.I.C. Rating:

Mains Type:

Mains Rating: 400 A

MCB Rating: 225 A

Branch Panel: RP-CC1


Location: Classroom 1106


Supply From: EXISTING 'DP-4'

Mounting: Recessed

Enclosure: Type 1

lotes:	Location: CI Supply From: RI Mounting: Re Enclosure: Ty	P-CC1 ecessed	3				Volts: Phases: Wires:		ve				Mair Mains	Rating: 25 kA es Type: Rating: 100 A Rating:	
СКТ	Circuit Description	QTY	Trip Pol	es	A	В	С	A	В	С	Poles	Trip	QTY	Circuit Description	скт
1	Gircuit Description			46	67 VA			420 VA			1	15 A	1	RECEPTACLE - FRIDGE	2
3	INDUCTION COOKER	1	50 A 3		707 771	4667 VA		120 171	420 VA		1	15 A	1	RECEPTACLE - FRIDGE	4
5		'				1007 171	4667 VA		.25 77	1440 VA	1	15 A	3	RECEPTACLE	6
7	RECEPTACLE	1	15 A 1	19	920 VA		1007 171	1440 VA		1110 171	1	15 A	1	GRIDDLE/RANGE	8
9	RECEPTACLE	3	15 A 1			1440 VA			1440 VA		1	15 A	. 1	GAS STOVE	10
11	GRIDDLE/RANGE	1	15 A 1				1440 VA			1440 VA	1	20 A	1	FRYER	12
13		-		30	000 VA			0 VA			1	15 A		SPARE	14
15	CONVECTION OVEN	1	30 A 3		700 771	3000 VA		•	0 VA		1	15 A		SPARE	16
17							3000 VA		U 17 (0 VA	1	15 A		SPARE	18
19	SPARE		20 A 1		0 VA		0000 171	0 VA		V 17 1	1	20 A		SPARE	20
21	SPARE		20 A 1			0 VA			0 VA		1	20 A		SPARE	22
23	SPACE		1								1			SPACE	24
25	SPACE		1								1			SPACE	26
27	SPACE		1								1			SPACE	28
29	SPACE		1								1			SPACE	30
31	SPACE		1								1			SPACE	32
33	SPACE		1								1			SPACE	34
35	SPACE		1								1			SPACE	36
37	SPACE		1								1			SPACE	38
39	SPACE		1								1			SPACE	40
41	SPACE		1								1			SPACE	42
			Total Loa	ıd:	1144	7 VA	1096	7 VA	1198	37 VA					l
			Total Amp		96	Α	91	Α	10	1 A	_				
egend:															
	assification				d Load		Demand Fac	tor		ed Demand				Panel Totals	
	- Other			28760			80.00%			08 VA					<u> </u>
P-CC2	- Receptacles			5640 \	VA		80.00%		45	12 VA				otal Conn. Load: 34400 VA	
													To	otal Est. Demand: 27520 VA	
														Total Conn.: 95 A	
													To	otal Est. Demand: 76 A	

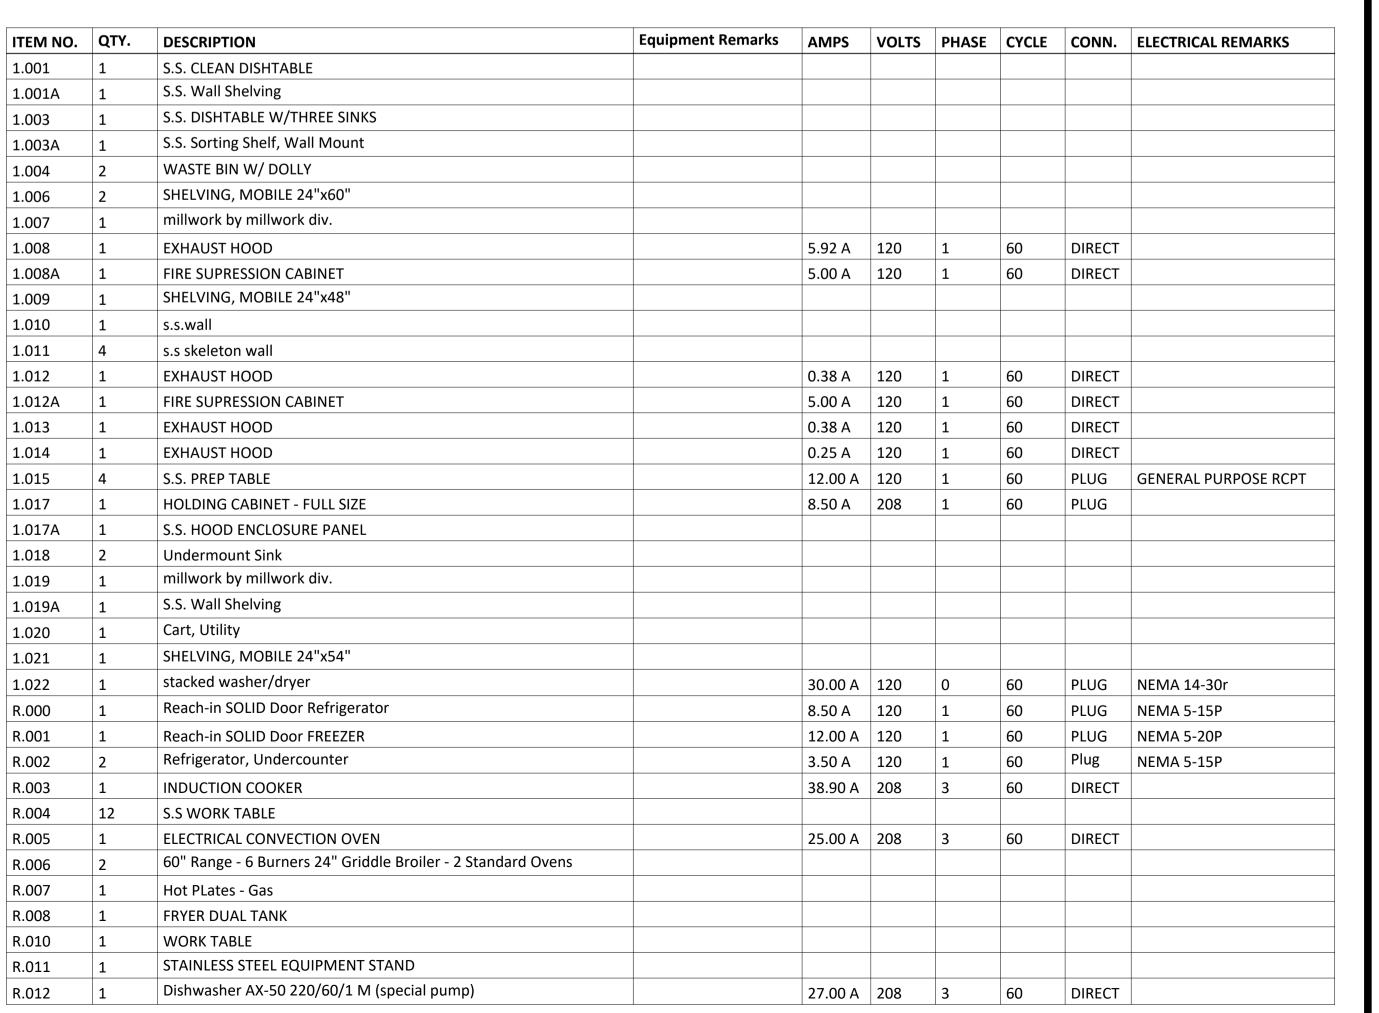

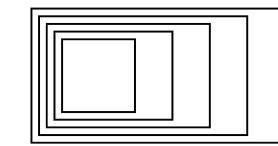

GOW HASTINGS ARCHITECTS

275 SPADINA ROAD TORONTO ONTARIO M5R 2V3 416-920-0031 GOWHASTINGS.COM

ALL DRAWINGS, SPECIFICATIONS, RELATED DOCUMENTS AND DESIGN ARE THE COPYRIGHT PROPERTY OF THE ARCHITECT AND MUST BE RETURNED UPON REQUEST. REPRODUCTION OF THE DRAWINGS, SPECIFICATIONS, RELATED DOCUMENTS AND DESIGN IN WHOLE OR IN PART IS STRICTLY FORBIDDEN WITHOUT THE ARCHITECT'S WRITTEN PERMISSION. THIS DRAWING SHALL NOT BE USED FOR CONSTRUCTION PURPOSES UNLESS COUNTERSIGNED.



250 ROWNTREE DAIRY RD, WOODBRIDGE, ON TEL: 905-507-0800
WEB: WWW.QUASARCG.COM



2 ISSUED FOR PERMIT AND 10/31/2025 TENDER 1 ISSUED FOR 90% CD - CLIENT 10/09/2025 REVIEW

ISSUED/REVISED DATE

Henry St H.S. Culinary Classroom Renovation

600 Henry St, Whitby, ON L1N 1L4

Electrical Equipment & Panel Schedules

Pro


Scale: 1:1


Project Number:
ED-25-052


Drawn By:
Author


Checked By:

Checker

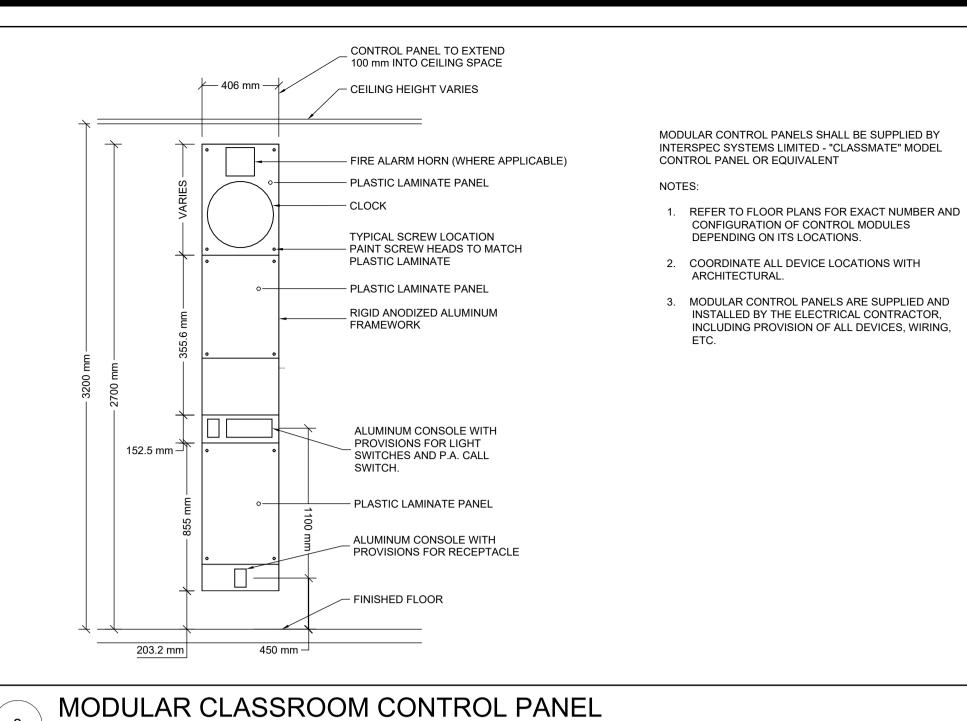

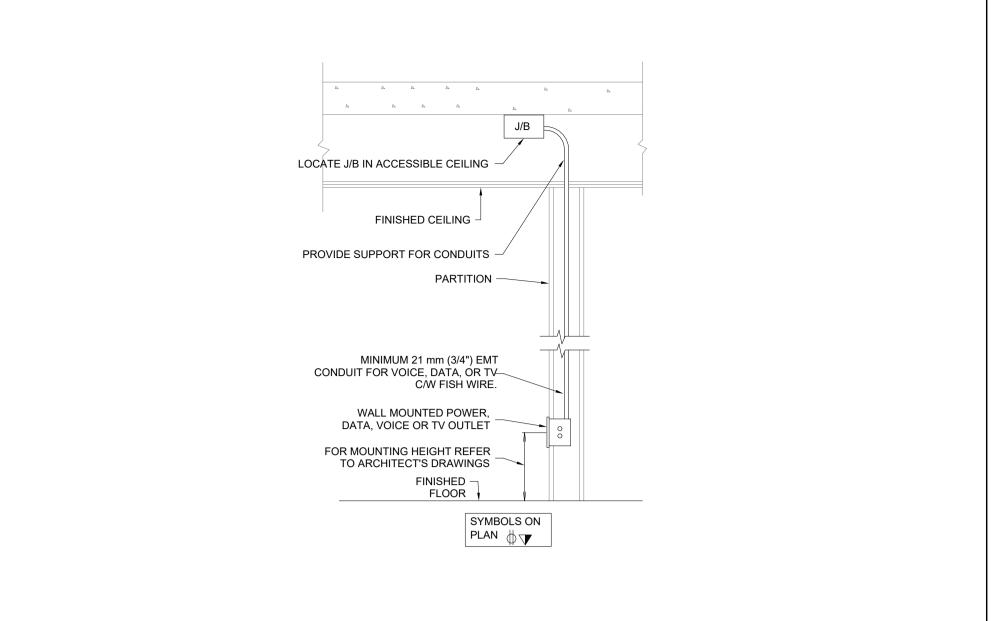

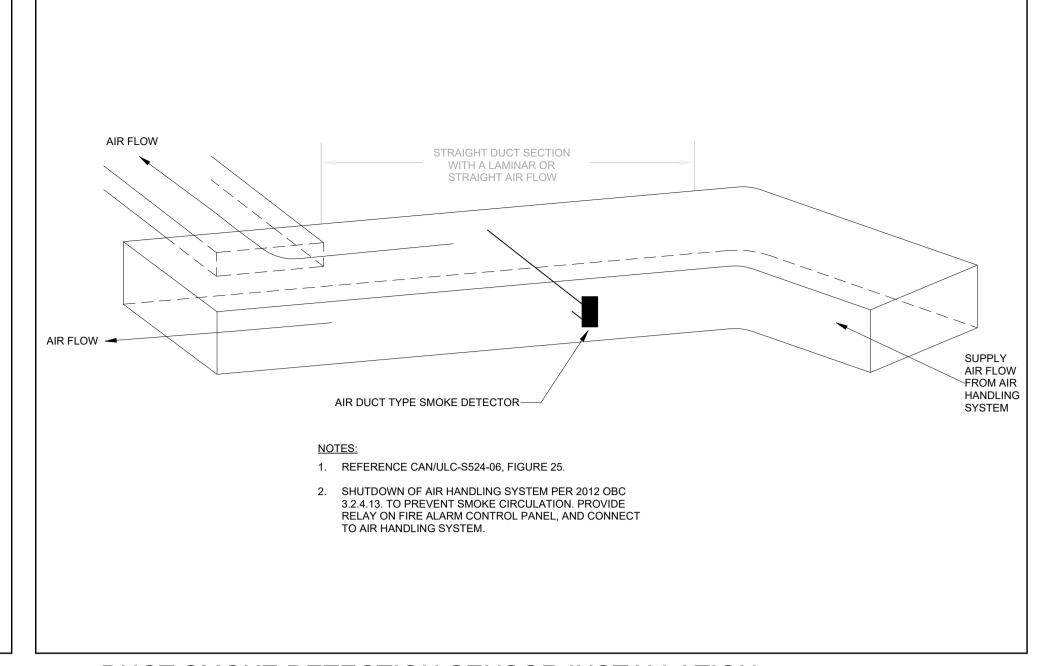

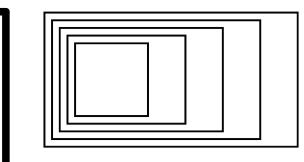


275 SPADINA ROAD TORONTO ONTARIO M5R 2V3 416-920-0031 GOWHASTINGS.COM

ALL DRAWINGS, SPECIFICATIONS, RELATED DOCUMENTS AND DESIGN ARE THE COPYRIGHT PROPERTY OF THE ARCHITECT AND MUST BE RETURNED UPON REQUEST. REPRODUCTION OF THE DRAWINGS, SPECIFICATIONS, RELATED DOCUMENTS AND DESIGN IN WHOLE OR IN PART IS STRICTLY FORBIDDEN WITHOUT THE ARCHITECT'S WRITTEN PERMISSION. THIS DRAWING SHALL NOT BE USED FOR CONSTRUCTION PURPOSES UNLESS COUNTERSIGNED.




250 ROWNTREE DAIRY RD, WOODBRIDGE, ON 905-507-0800 WWW.QUASARCG.COM


SCALE:N.T.S.

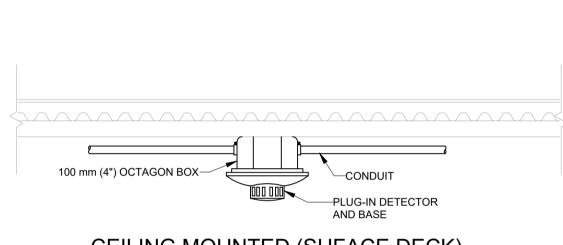

CEILING MOUNTED (SUFACE DECK)

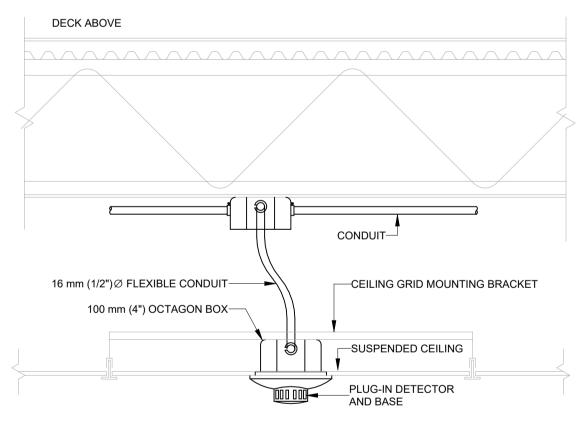


SUSPENDED CEILING MOUNTED

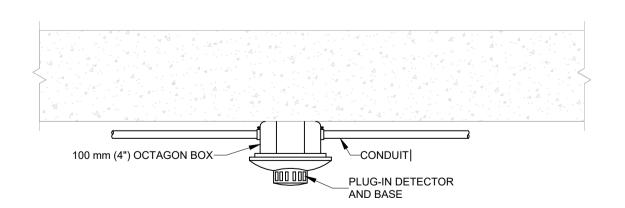

CEILING MOUNTED (SURFACE SLAB)

WALL MOUNTED OUTLET BOX WALL - RECESSED - FINISHED CEILING SCALE:N.T.S.

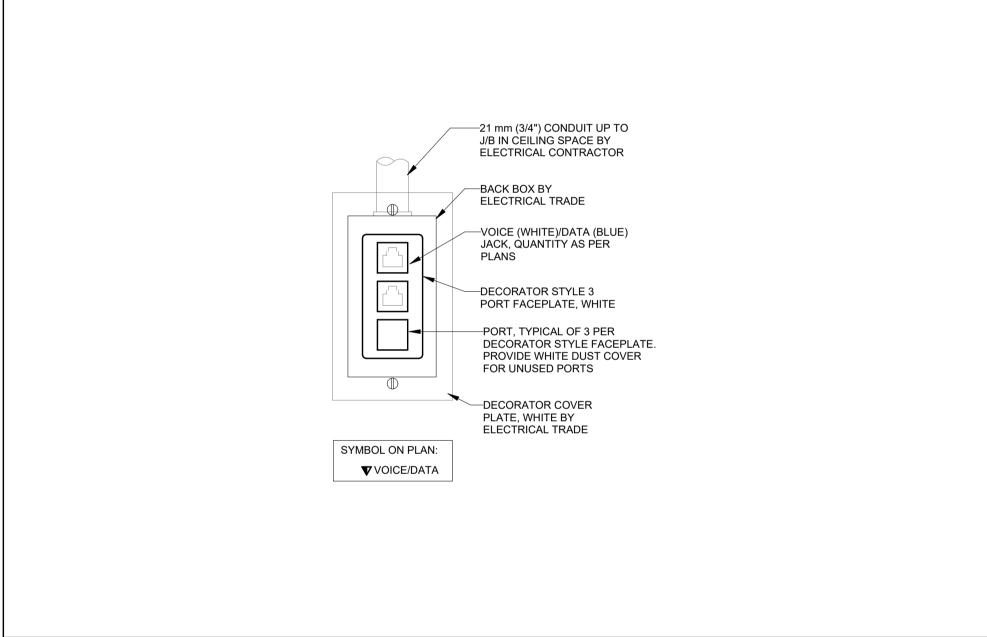


TYPICAL VOICE AND DATA OUTLET SCALE:N.T.S.


WIRE SIZE	BREAKER SIZE (AMPERES)	15	20	30	40	50	60	70	80	100
	MAX. LOAD AT 80% (AMPERES)	12	16	24	32	40	48	56	68	80
NO.12		24.4	18.3							
NO.10		38.1	29.0	19.1						
NO.8		59.4	44.2	30.5	22.9					
NO. 6		91.4	70.1	47.2	35.1	28.2	23.6			
NO. 4			109.7	73.2	54.9	42.7	38.1	32.0	27.4	
NO. 2				114.3	85.3	68.6	57.9	50.3	41.1	35.0
NO. 1					103.6	85.3	73.2	61.0	54.9	43.4
NO.1/0					128.0	102.9	85.3	73.2	64.0	48.8
NO.2/0						121.9	100.6	86.9	74.7	60.9
NO.3/0							118.1	102.1	88.4	70.1
NO.4/0								120.4	102.9	83.8
250 MCM									114.3	91.4
300 MCM										103.6

Max Branch Wiring Distance for 120 V System at 3% Voltage Drop SCALE:N.T.S.

DUCT SMOKE DETECTION SENSOR INSTALLATION SCALE:N.T.S.

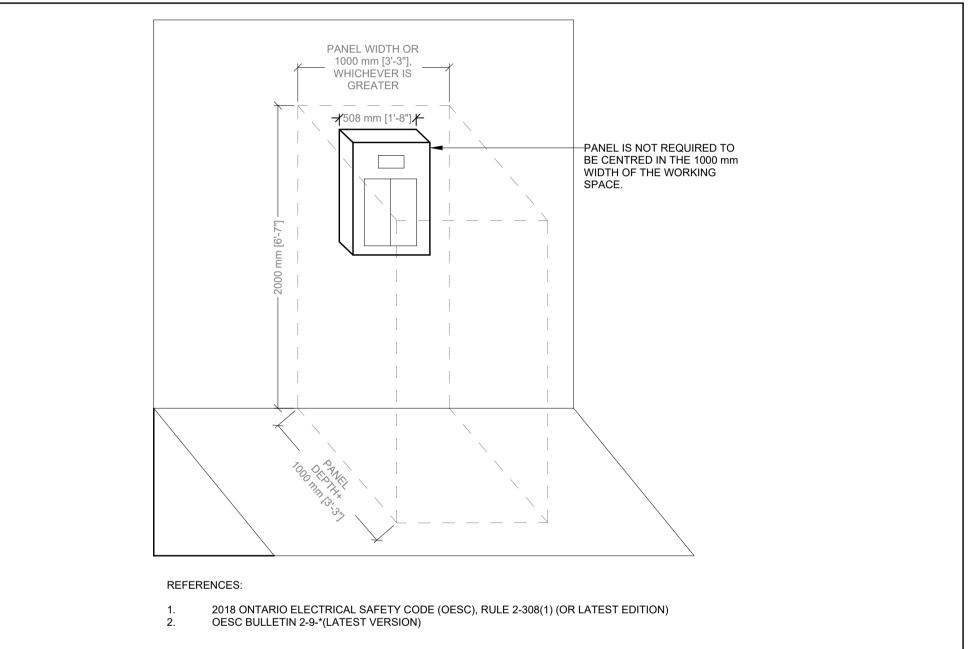

CLEAR SPACE AROUND PANELBOARDS SCALE:N.T.S.

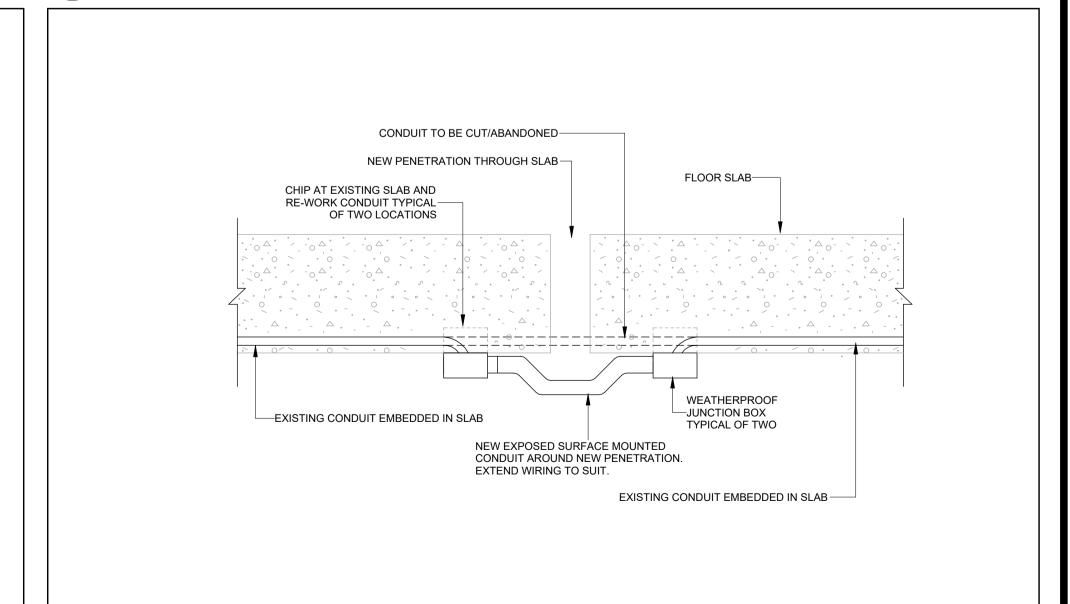

BYPASS OF RECESSED CONDUIT IN SLAB SCALE:N.T.S.

T.W. SEDORE

TENDER ISSUED FOR 90% CD - CLIENT 10/09/2025

REVIEW

ISSUED/REVISED

DATE

Henry St H.S. Culinary Classroom

600 Henry St, Whitby, ON L1N 1L4


Renovation

Checker

Electrical Detail Sheet No.


Scale: As indicated Project Number: ED-25-052 Drawn By: Checked By:


TYPICAL SMOKE DETECTOR INSTALLATIONS

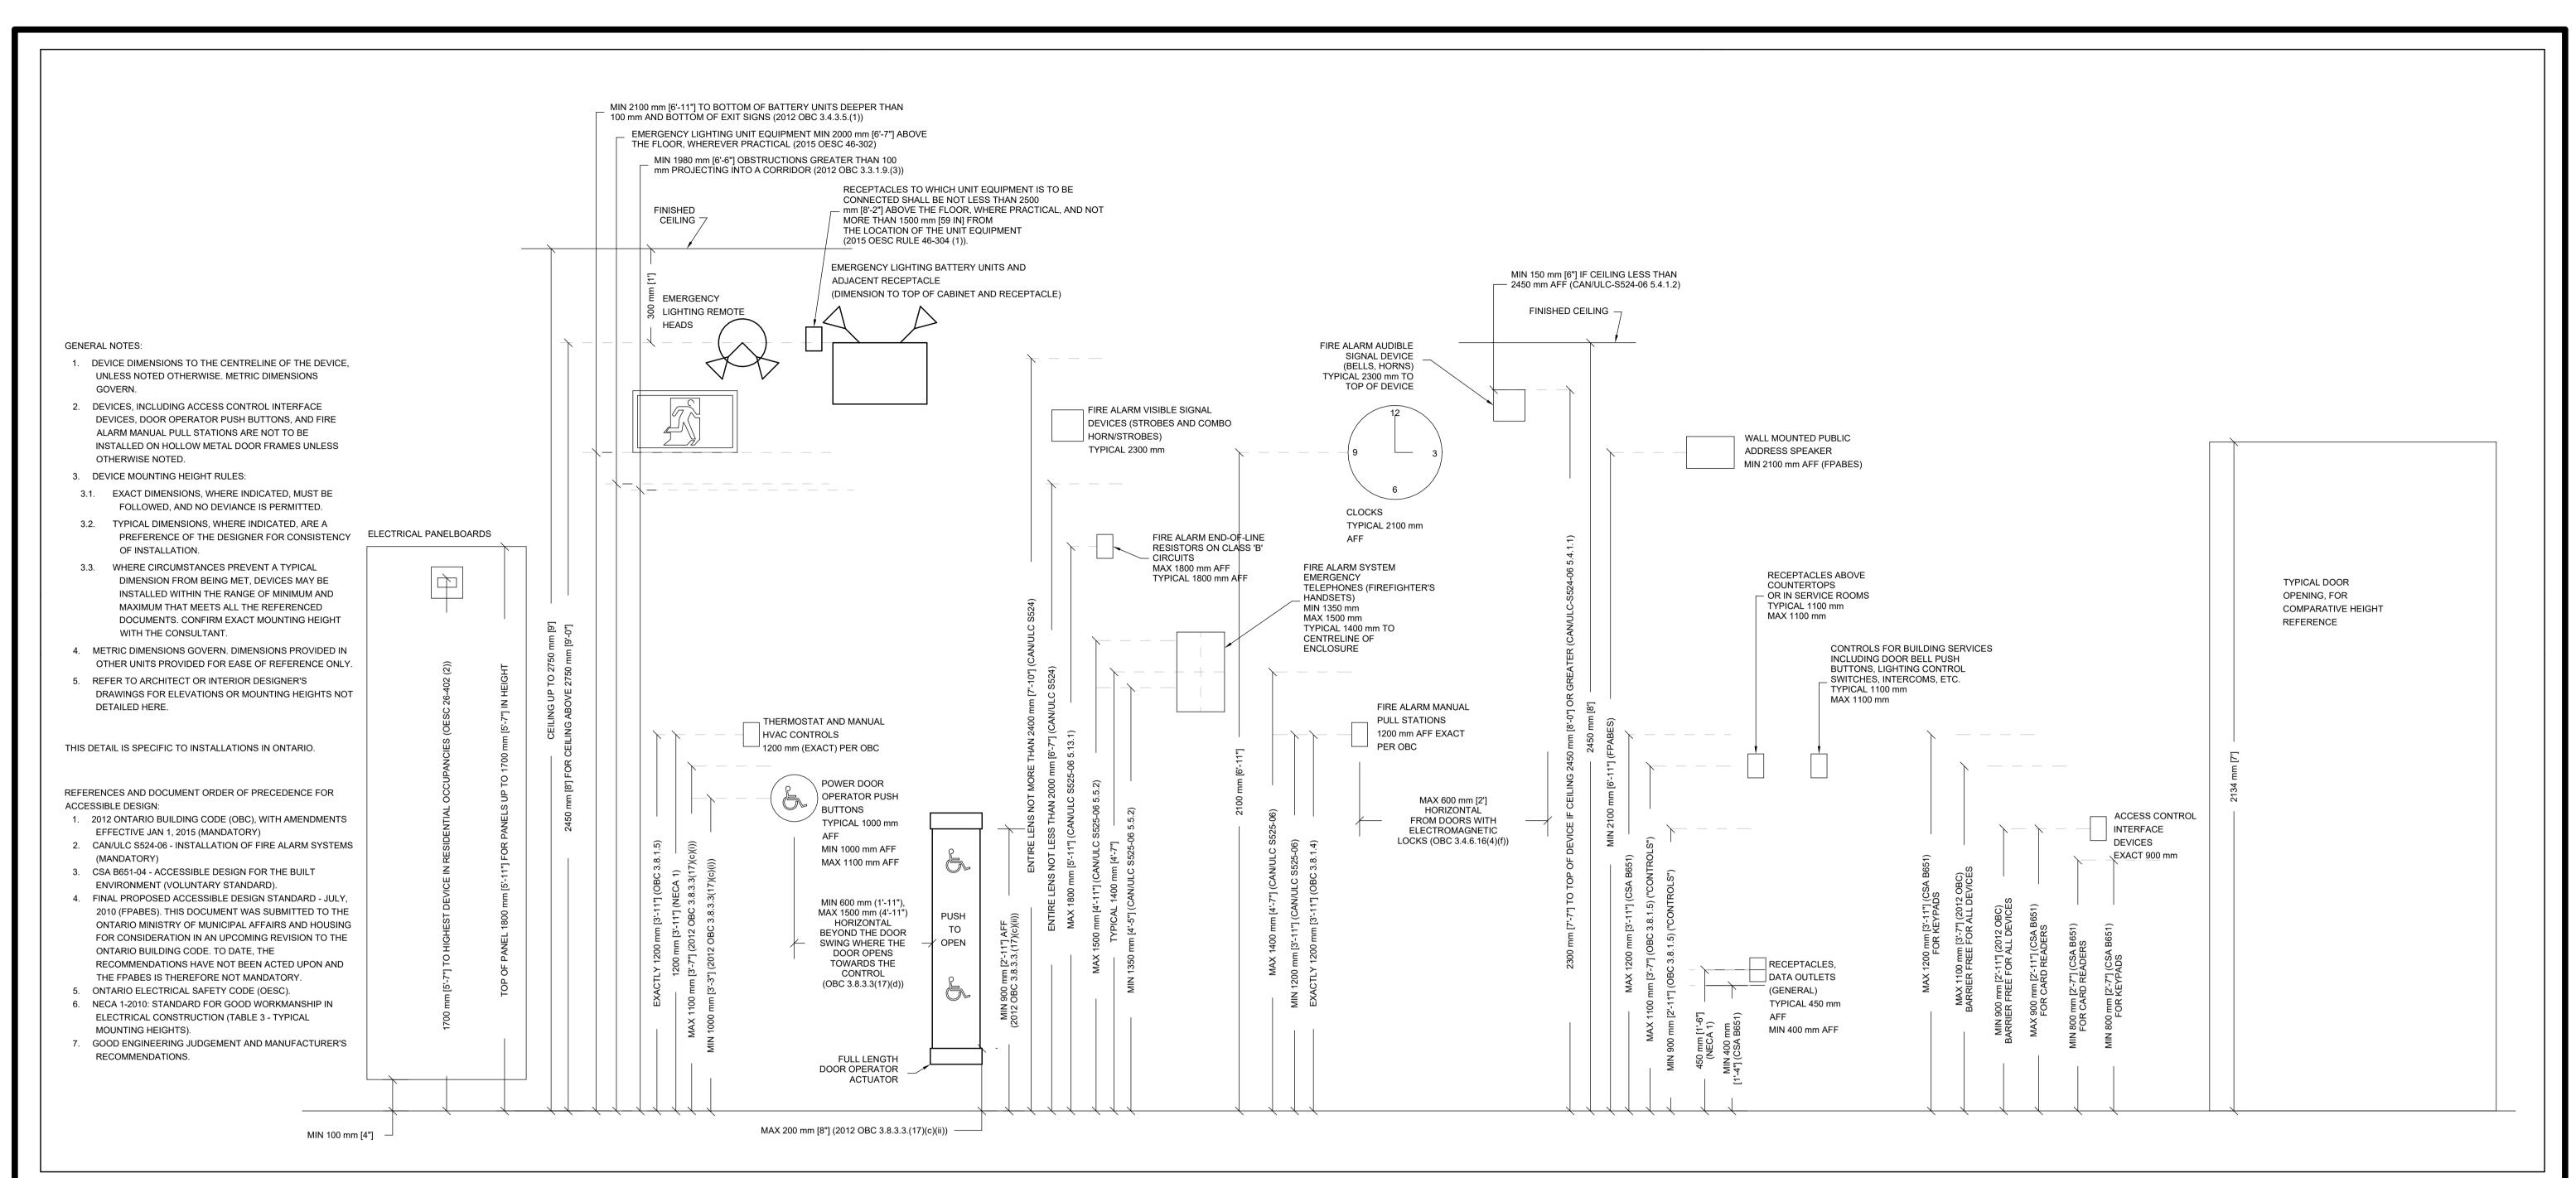

TYPICAL DEVICE MOUNTING HEIGHTS (ONTARIO)


SCALE:N.T.S.

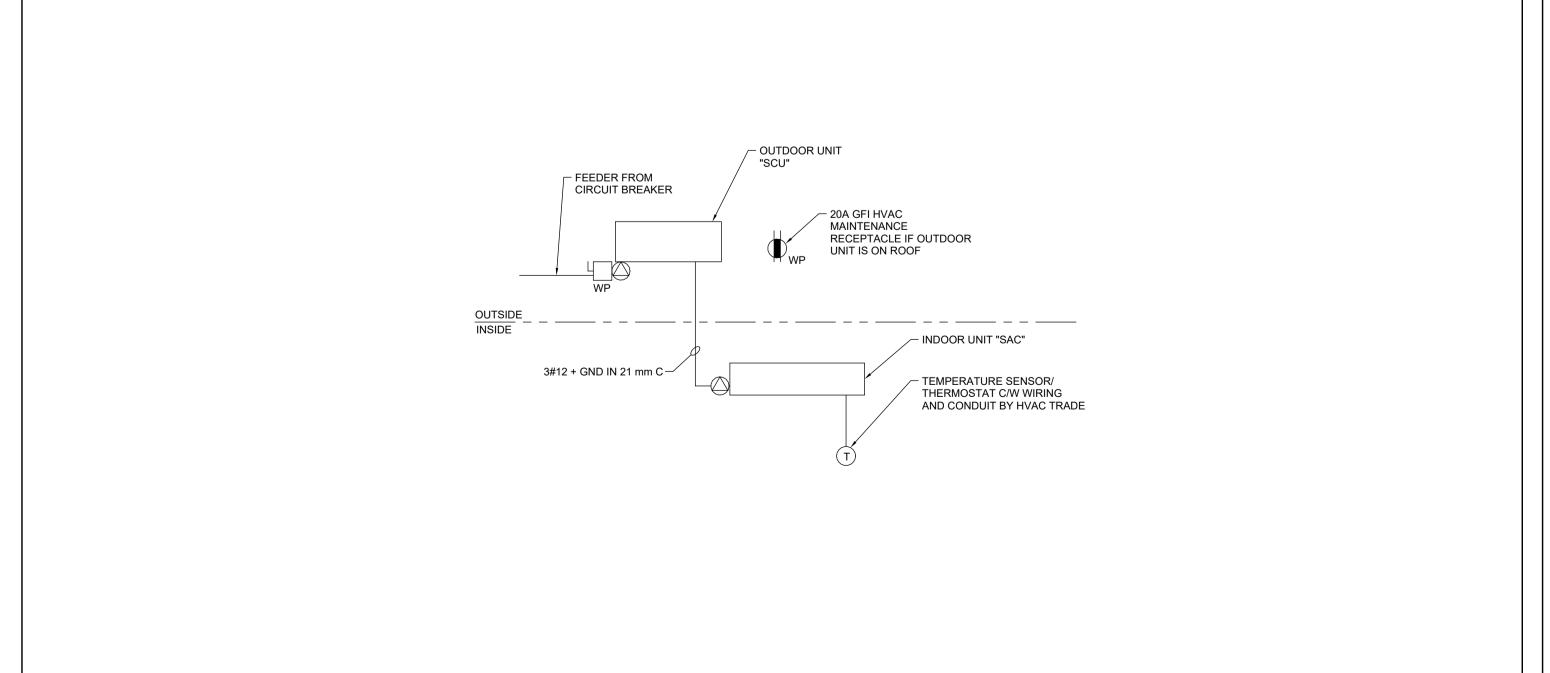

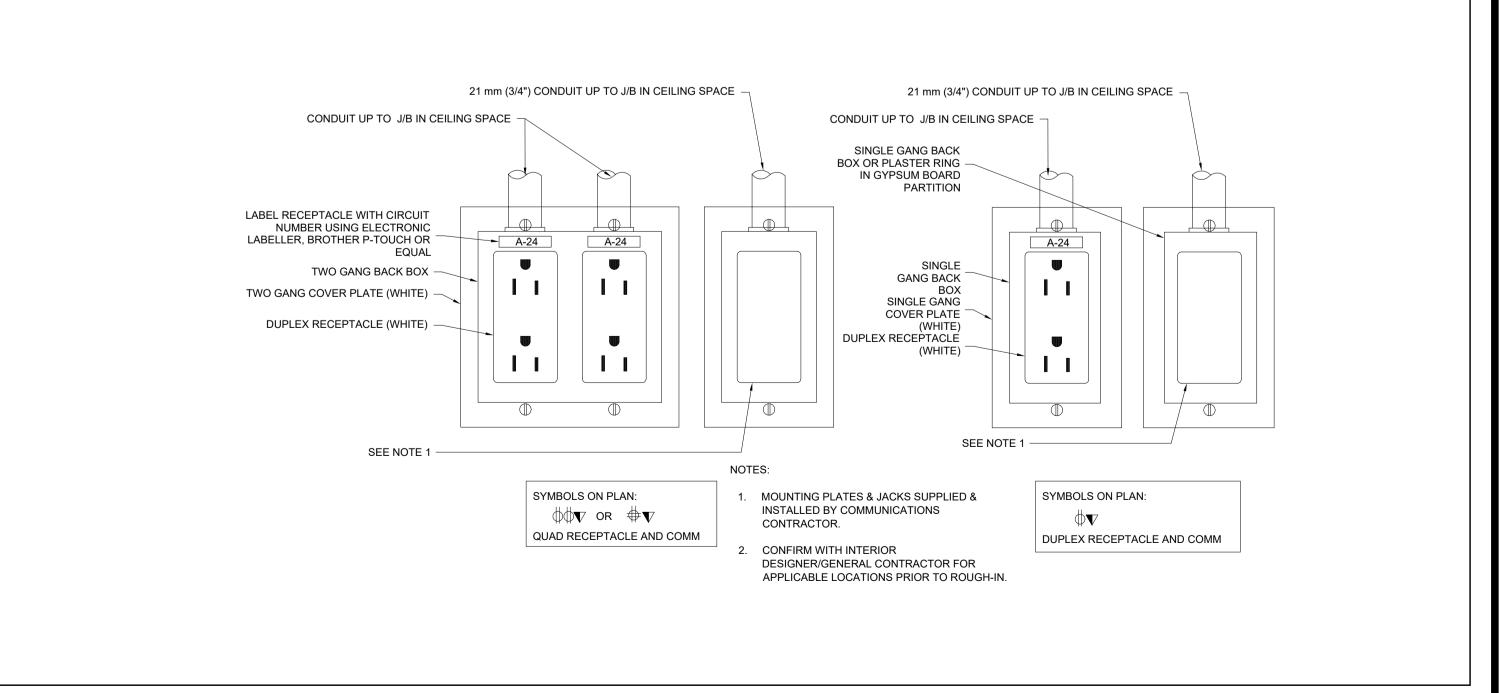

SPIT-SYSTEM AIR-CONDITIONER WIRING SCALE:N.T.S.

UNGANGED DECORATOR STYLE POWER OUTLETS AND COMM BOXES
SCALE:N.T.S.

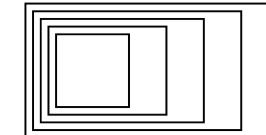

GOW HASTINGS ARCHITECTS

275 SPADINA ROAD TORONTO ONTARIO M5R 2V3 416-920-0031 GOWHASTINGS.COM

ALL DRAWINGS, SPECIFICATIONS, RELATED DOCUMENTS AND DESIGN ARE THE COPYRIGHT PROPERTY OF THE ARCHITECT AND MUST BE RETURNED UPON REQUEST. REPRODUCTION OF THE DRAWINGS, SPECIFICATIONS, RELATED DOCUMENTS AND DESIGN IN WHOLE OR IN PART IS STRICTLY FORBIDDEN WITHOUT THE ARCHITECT'S WRITTEN PERMISSION. THIS DRAWING SHALL NOT BE USED FOR CONSTRUCTION PURPOSES UNLESS COUNTERSIGNED.



250 ROWNTREE DAIRY RD, WOODBRIDGE, ON TEL: 905-507-0800
WEB: WWW.QUASARCG.COM




2 ISSUED FOR PERMIT AND 10/31/2025 TENDER 1 ISSUED FOR 90% CD - CLIENT 10/09/2025 REVIEW

No. ISSUED/REVISED DATE


Henry St H.S. Culinary Classroom Renovation


600 Henry St, Whitby, ON L1N 1L4

Electrical Detail Sheet No.

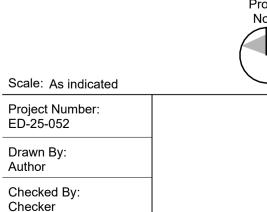

F-303

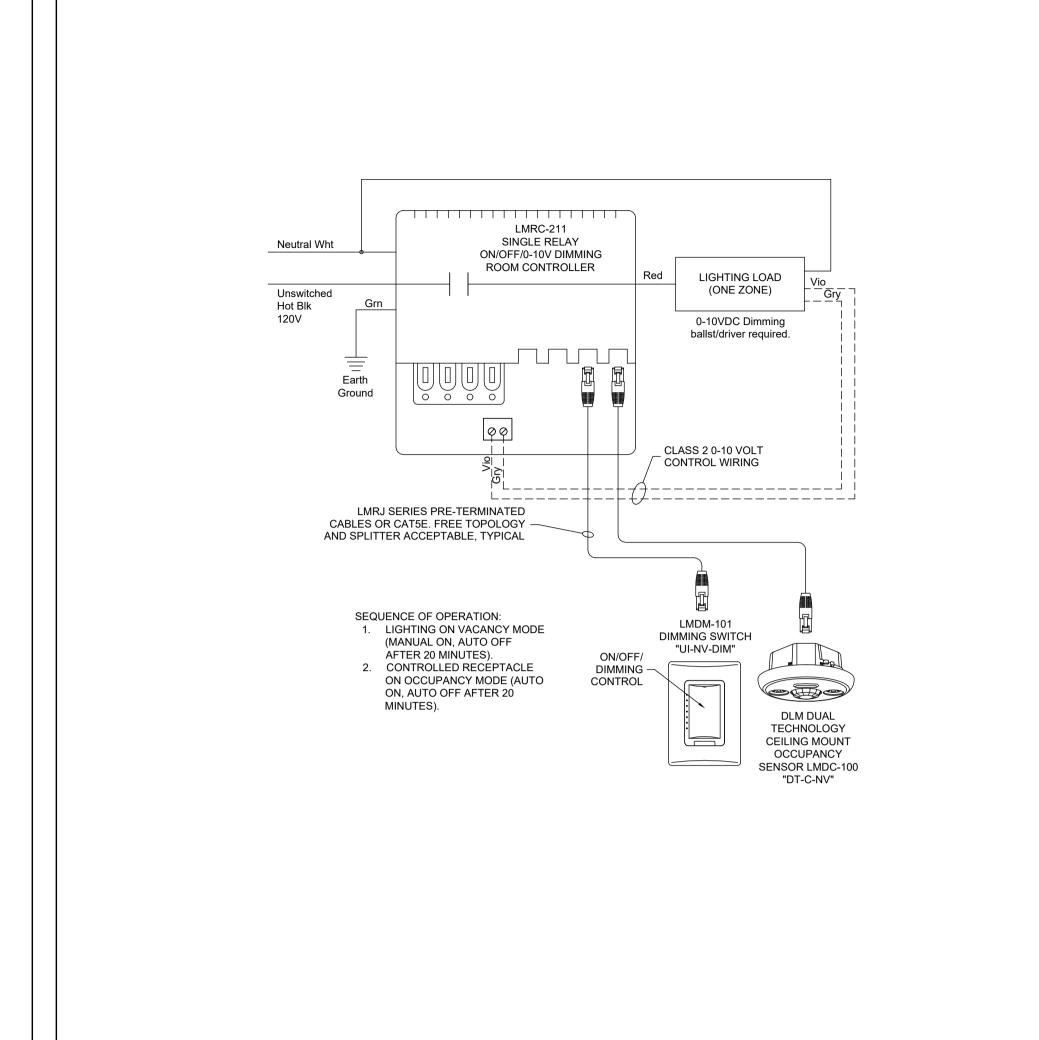

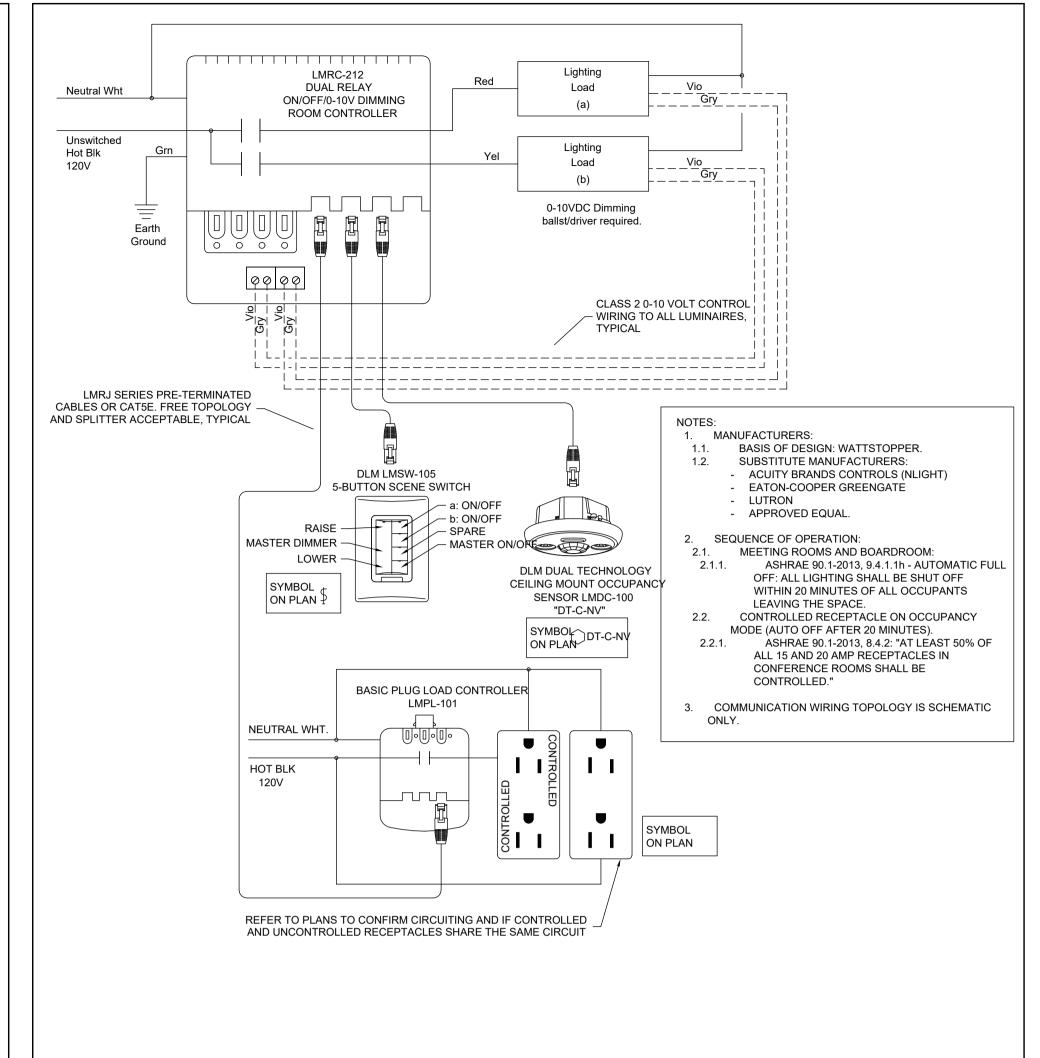




ALL DRAWINGS, SPECIFICATIONS, RELATED DOCUMENTS AND DESIGN ARE THE COPYRIGHT PROPERTY OF THE ARCHITECT AND MUST BE RETURNED UPON REQUEST. REPRODUCTION OF THE DRAWINGS, SPECIFICATIONS, RELATED DOCUMENTS AND DESIGN IN WHOLE OR IN PART IS STRICTLY FORBIDDEN WITHOUT THE ARCHITECT'S WRITTEN PERMISSION. THIS DRAWING SHALL NOT BE USED FOR CONSTRUCTION PURPOSES UNLESS COUNTERSIGNED.



250 ROWNTREE DAIRY RD, WOODBRIDGE, ON
TEL: 905-507-0800
WEB: WWW.QUASARCG.COM

1-ZONE ROOM CONTROLLER (1x0 - 10VDIM)(120V)(90.1-2013)(DLM) SCALE:N.T.S.

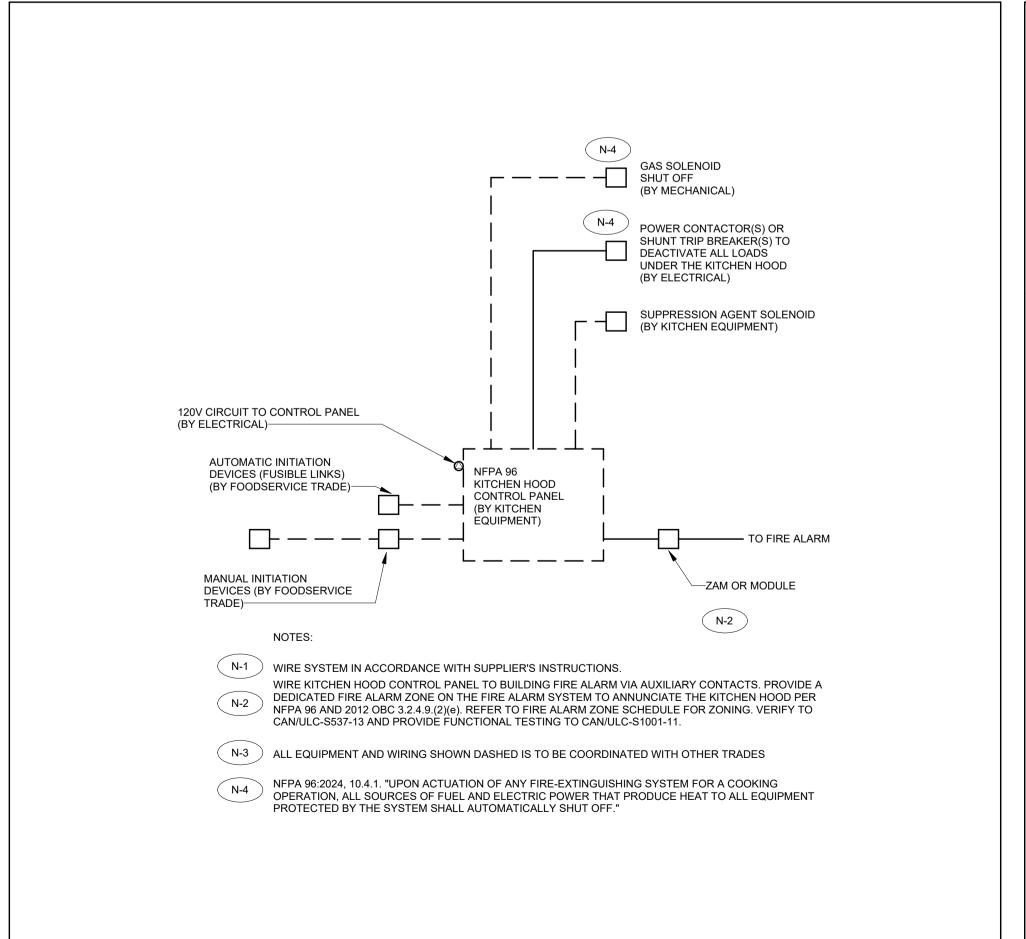

NOTES:

1. TYPICAL DIMENSIONS FOR A RECESSED SINGLE TUB RECEPTACLE
PANELBOARD WITH MAX 100A FRAME SIZE BRANCH BREAKERS:
1.1. TUB DIEPTH. 148 1 min (5.73.) ARCHITECTURAL TO ALL OW PARTITION
DEPTH NAINAM 150 om (6.7) FROM FACE TO INSIDE CLEAR.
2.2. TUB HEIGHT. VARIES BASED ON NUMBER OF BRANCH BREAKERS,
TYPICALLY FANESDS BETWEEN B MIN (3) OF DOEL, AND 72 IN ICH 42
POLE, BUT CAN ALSO BE TALLER.
4.6. BUSSES HEMELS BASED TO HEATER.

CLEAR SPACE: MINIMUM 1000 mm BY 1000 mm SQUARE BY 2000 mm HIGH.
PANEL NEED NOT BE CENTRED IN THE CLEAR SPACE (ONTARIO
ELECTRICAL SAFETY CODE RULE 2-308(1)).

WHEN INSTALLING NEW RECESSED PANELBOARD IN EXISTING PARTITION

BRANCH CIRCUIT CONDUIT QUANTITY AND SIZE TO ACCOMMODATE

3.1. UP TO 100A, 42 CIRCUIT PANELBOARD: 2 x 41 mm (1-1/2") Ø 3.2. UP TO 225A, 42 CIRCUIT PANELBOARD: 2 x 41 mm (1-1/2") Ø

MINIMUM JUNCTION BOX SIZE: 600 mm BY 600 mm BY 75 mm.


3.3. UP TO 400A, 42 CIRCUIT PANELBOARD: 2 x 53 mm (2") Ø 3.4. UP TO 600A, 42 CIRCUIT PANELBOARD: 3 x 53 mm (2") Ø

OR WALL, REINSTATE WALL AND CEILING.

CIRCUITS AS FOLLOWS:

2-ZONE ROOM CONTROLLER (2x0-10V)(RECCTRL)(DLM)


SCALE:N.T.S.

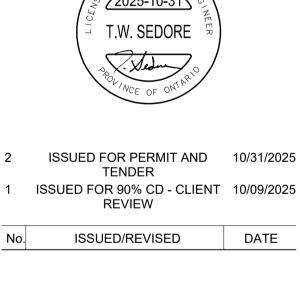

Henry St H.S. Culinary Classroom Renovation

600 Henry St, Whitby, ON L1N 1L4

Electrical Detail Sheet No. 3

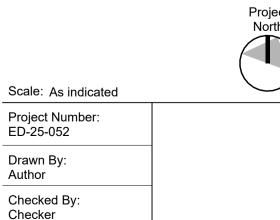

RECESSED PANELBOARD

SCALE:N.T.S.

SMOKE DAMPER CONTROLLED BY SPOT SMOKE DETECTOR SCALE:N.T.S.

—LINE OF FINISHED CEILING

[4'-11"] FROM

END OF DUCT IF

TRANSFER TYPE

AIR DUCT

120 VOLT TO

ACTUATOR.

SMOKE DAMPERS AND COMBINATION SMOKE AND FIRE DAMPERS SHALL BE CONFIGURED SO AS TO CLOSE AUTOMATICALLY UPON A SIGNAL FROM AN

"INSTALLATION OF FIRE ALARM SYSTEMS", WITHIN 1500 mm HORIZONTALLY OF THE

ADJACENT SMOKE DETECTOR LOCATED AS DESCRIBED IN CAN/ULC-S524.

DUCT OR AIR-TRANSFER OPENING IN THE FIRE SEPARATION IN THE DUCT

PROVIDE OUTPUT RELAY ON FIRE ALARM SYSTEM TO CLOSE DAMPER UPON

2. DOWNSTREAM OF THE SMOKE DAMPER OR COMBINATION SMOKE AND FIRE

PROVIDE LOCAL

SEQUENCE OF OPERATION:
 EXCEPT AS REQUIRED BY A SMOKE CONTROL SYSTEM,

DETECTION OF SMOKE BY DUCT SMOKE DETECTOR.

DAMPER. (2012 OBC 3.1.8.9A.(3)(b)).

DISCONNECT

SMOKE DAMPER OR

COMBINATION FIRE AND SMOKE DAMPER

AS NOTED ON PLANS

DAMPER IN PLANE

DIRECTION

OF AIR FLOW

OF FIRE RATED

SEPARATION

__ACTUATOR

SPOT SMOKE DETECTOR INSTALLED

TO CAN/ULC-S524.-CONNECTED TO FIRE

ALARM SYSTEM

DUCT SMOKE

DETECTOR INSTALLED

TO CAN/ULC-S524.-CONNECTED TO FIRE

ALARM SYSTEM

NOTES:

KITCHEN HOOD CONTROL PANEL INTERCONNECTIONS
SCALE:N.T.S.

SCHEDULE 26 05 50.23 - LIGHTING CONTROL DEVICE SCHEDULE SYMBOL DESCRIPTION MANUFACTURER AND PRODUCT SERIES CONTROL WIRING VOLTAGE OUTPUT MOUNTING SPEC SECTION REMARKS ACUITY BRANDS CONTROL/nLIGHT, SUBMITTAL WITH STANDARD/PROPOSED ONE BUTTON WALL STATION, ONE BUTTON ON-OFF TOGGLE nPODM-1SB SERIES UI-NV-1B ENGRAVING OPTION. ALLOW FOR CUSTOM DIGITAL WALL 26 09 43 LEGRAND/WATTSTOPPER LMSW-101 LABELLING OPTION AT OWNER'S DISCRETION. PHILIPS DYNALITE DPNA SERIES, DPNA914 DIMMING WALL STATION, MULTI-BUTTON WALL INTERFACE CONTROL C/W ENGRAVED ACUITY BRANDS CONTROLS/nLIGHT NPODM BUTTONS. UI-DIM-NV-X DIGITAL WALL 26 09 43 \$ Z1/Z2 BUTTONS: BUTTONS: EACH ZONE CONTROLLED (SEE PLANS), DIM UP, DIM DOWN, ALL OFF, ALL ON 'X' DENOTES NUMBER OF CONTROLLED ZONES PHILIPS REVOLUTION SERIES DR2PA DIMMING WALL STATION, MULTI-BUTTON WALL ACUITY BRANDS CONTROLS/nLIGHT NPODM INTERFACE CONTROL C/W ENGRAVED UI-DIM-NV-B DIGITAL 26 09 43 WALL \$ ЫМ BUTTONS: EACH ZONE CONTROLLED (SEE PLANS), DIM PHILIPS REVOLUTION SERIES DR2PA UP, DIM DOWN, ALL OFF, ALL ON CEILING MOUNTED OCCUPANCY SENSOR, 24V, LEGRAND/WATTSOPPER DT-300 SERIES **CEILING MOUNTED** DT-C-2V 24 V 26 09 23 \bigcirc DUAL TECHNOLOGY SENSOR LUTRON LOS-CDT SERIES LIGHTING CONTROL SCHEDULE NOTES:

	SCHEDULE 26 05 50.16 - LIGHTING FIXTURE SCHEDULE													
SYMBOL	TYPE	DESCRIPTION	BASIS OF DESIGN MANUFACTURER AND CAT NO. SEE NOTE 1	VOLTAGE/ INPUT WATTS	LUMEN PACKAGE (3500K CCT UNLESS NOTED OTHERWISE) MINIMUM 80 CRI	MOUNTING	REFERENCE	REMARKS						
	L1	RECESSED 2' x 4' TROFFER STYLE LED LUMINAIRE COMPLETE WITH HINGED AND LATCHED STEEL LENS FRAME AND POLYCARBONATE PRISMATIC LENS 0.125" THICK. LUMINAIRE SUITABLE FOR INSTALLATION IN T-BAR CEILINGS.	PEERLESS ELECTRIC (OMNILUMEN) LACH SERIES CAT#LACH-3-24G-40-40K-12P-347	347V 33W	4000 LUMEN 4000K	RECESSED T-BAR CEILING								
0	L2	100 mm (4 INCH) NOMINAL ROUND APERATURE RECESSED LED DOWNLIGHT COMPLETE WITH WHITE TRIM RING AND SEMI-SPECULAR REFLECTOR	PRESCOLITE LIGHTING (OMNILUMEN) LTR-R4D SERIES CAT #LTR-4RD-H-SL15L-34	347V 18.6W	1500 LUMEN 4000K	RECESSED DRYWALL CEILING								
Ø	L3	100 mm (4 INCH) NOMINAL ROUND APERATURE RECESSED LED DOWNLIGHT COMPLETE WITH WHITE TRIM RING AND SEMI-SPECULAR REFLECTOR	PRESCOLITE LIGHTING (OMNILUMEN) LTR-R4D SERIES CAT #LTR-4RD-H-SL14H-34	347V 18.6W	1500 LUMEN 4000K	RECESSED T-BAR CEILING								
IGHTING FIXTU	IRE SCHEDULE	E NOTES:				•	•	'						

1. UNLESS NOTED OTHERWISE, ACCEPTED ALTERNATE MANUFACTURERS AND SUPPLIERS: ACUITY BRANDS LIGHTING, CREE CANADA, HUBBELL LIGHTING, PEERLESS ELECTRIC, SIGNIFY (FORMERLY PHILIPS LIGHTING), VISCOR/VISIONEERING. 2. WHEERE AN INCOMPLETE MODEL/CAT NO. IS LISTED, MANUFACTURERS/SUPPLIERS MUST CONFIRM THE PROPOSED FIXTURE WITH THE CONSULTANT A MINIMUM OF ONE WEEK PRIOR TO TENDER CLOSE.
3. SUBMIT SHOP DRAWINGS FOR CONSULTANT'S REVIEW PRIOR TO PLACING ANY ORDER.

2. ALTERNATE MANUFACTURERS: ACUITY BRNADS LIGHTING (SENSORSWITCH, nLIGHT), COOPER LIGHTING SOLUTIONS, DOUGLAS LIGHTING CONTROLS, LUTRON, SIGNIFY (FORMERLY PHILIPS LIGHTING), WATTSTOPPER-LEGRAND.

3. DUAL TECHNOLOGY SENSORS: PASSIVE INFRARED/ULTRASONIC, OR PASSIVE INFRARED/MICROPHONIC, DEPENDING ON MANUFACTURER, MICROPHONIC SENSORS ACCEPTABLE IN LIEU OF ULTRASONIC. 4.POSITION CEILING MOUNTED OCCUPANCY SENSORS A MINIMUM 1200 mm (4'-0") FROM NEAREST DIFFUSER, HVAC OUTLETS, HEATING BLOWERS, ETC.

	SCHEDULE 26 05 50.19 - EMERGENCY LIGHTING FIXTURE SCHEDULE												
SYMBOL	TYPE	DESCRIPTION	MANUFACTURER AND PRODUCT SERIES	VOLTAGE	LAMPS	MOUNTING	SPEC SECTION	REMARKS					
v	EM1	MICRO SIZE DOUBLE RMEOTE HEAD COMPLETE WITH POLYCARBONATE IMPACT RESISTANT LENS	-LUMACELL MQM-1NC-LD10-CSA SERIES -EMERGILITE EF40 SERIES -STANPRO SMC SERIES -BEGHELLI BOLLA REMOTE SERIES	12V	1x6W MR16 LED	WALL SURFACE	26 52 13.13						

EMERGENCY LIGHTING FIXTURE SCHEDULE NOTES:

1. WHERE AN INCOMPLETE MODEL/CAT NO. IS LISTED, MANUFACTURERS/SUPPLIERS MUST CONFIRM THE PROPOSED FIXTURE WITH THE CONSULTANT A MINIMUM OF ONE WEEK PRIOR TO TENDER CLOSE.

2. SUBMIT SHOP DRAWINGS FOR CONSULTANT'S REVIEW PRIOR TO PLACING ANY ORDER. 3. ACCEPTABLE MANUFACTURERS AS NOTED IN SECTION 26 52 13.13 [OR]

3. ACCEPTABLE MANUFACTURERS: AIMLITE, BEGHELLI, EMERGILITE, LUMACELL, STANPRO. 4. REMOTE HEADS CERTIFIED TO CSA C22.2 No. 141.

5. CBCB - "CENTRE BEAM CANDLE POWER." 6 CONFIRM RECOMMENDED SPACING WITH EMERGENCY LIGHTING MANUFACTURER PRIOR TO START OF ROUGH-IN.

LIGHTING CONTROLS OF ONE MANUFACTURER THROUGH PROJECT TO ENSURE PRODUCT COMPATABILITY

5. CONFIRM INSTALLATION REQUIREMENTS, WIRING DIAGRAMS, ETC. WITH MANÚFACTURER'S DETAILS.

6. SUBMIT SHOP DRAWINGS FOR CONSULTANT'S REVIEW PRIOR TO PLACING ANY ORDER.

7. CONFIRM FINISH COLOUR WITH CONSULTANT DURING SUBMITTAL REVIEW.

GOW HASTINGS ARCHITECTS

275 SPADINA ROAD TORONTO ONTARIO M5R 2V3 416-920-0031 GOWHASTINGS.COM

ALL DRAWINGS, SPECIFICATIONS, RELATED DOCUMENTS AND DESIGN ARE THE COPYRIGHT PROPERTY OF THE ARCHITECT AND MUST BE RETURNED UPON REQUEST. REPRODUCTION OF THE DRAWINGS, SPECIFICATIONS, RELATED DOCUMENTS AND DESIGN IN WHOLE OR IN PART IS STRICTLY FORBIDDEN WITHOUT THE ARCHITECT'S WRITTEN PERMISSION. THIS DRAWING SHALL NOT BE USED FOR CONSTRUCTION PURPOSES UNLESS COUNTERSIGNED.



250 ROWNTREE DAIRY RD, WOODBRIDGE, ON 905-507-0800 WEB: WWW.QUASARCG.COM



2 ISSUED FOR PERMIT AND 10/31/2025 TENDER 1 ISSUED FOR 90% CD - CLIENT 10/09/2025 REVIEW

DATE ISSUED/REVISED

Henry St H.S. Culinary Classroom Renovation

600 Henry St, Whitby, ON L1N 1L4

Lighting Schedules

Scale: 1:1 Project Number: ED-25-052 Drawn By:

Checked By:

Checker