
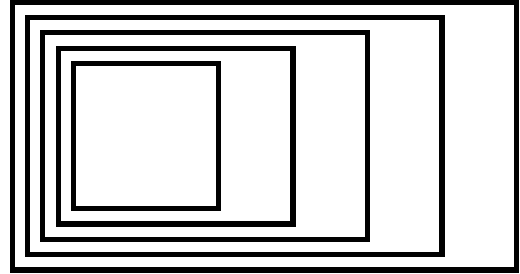


Henry St H.S. - Culinary Classroom Renovation

600 Henry St, Whitby, ON L1N 1L4

Issued for Permit & Tender

October 31, 2025

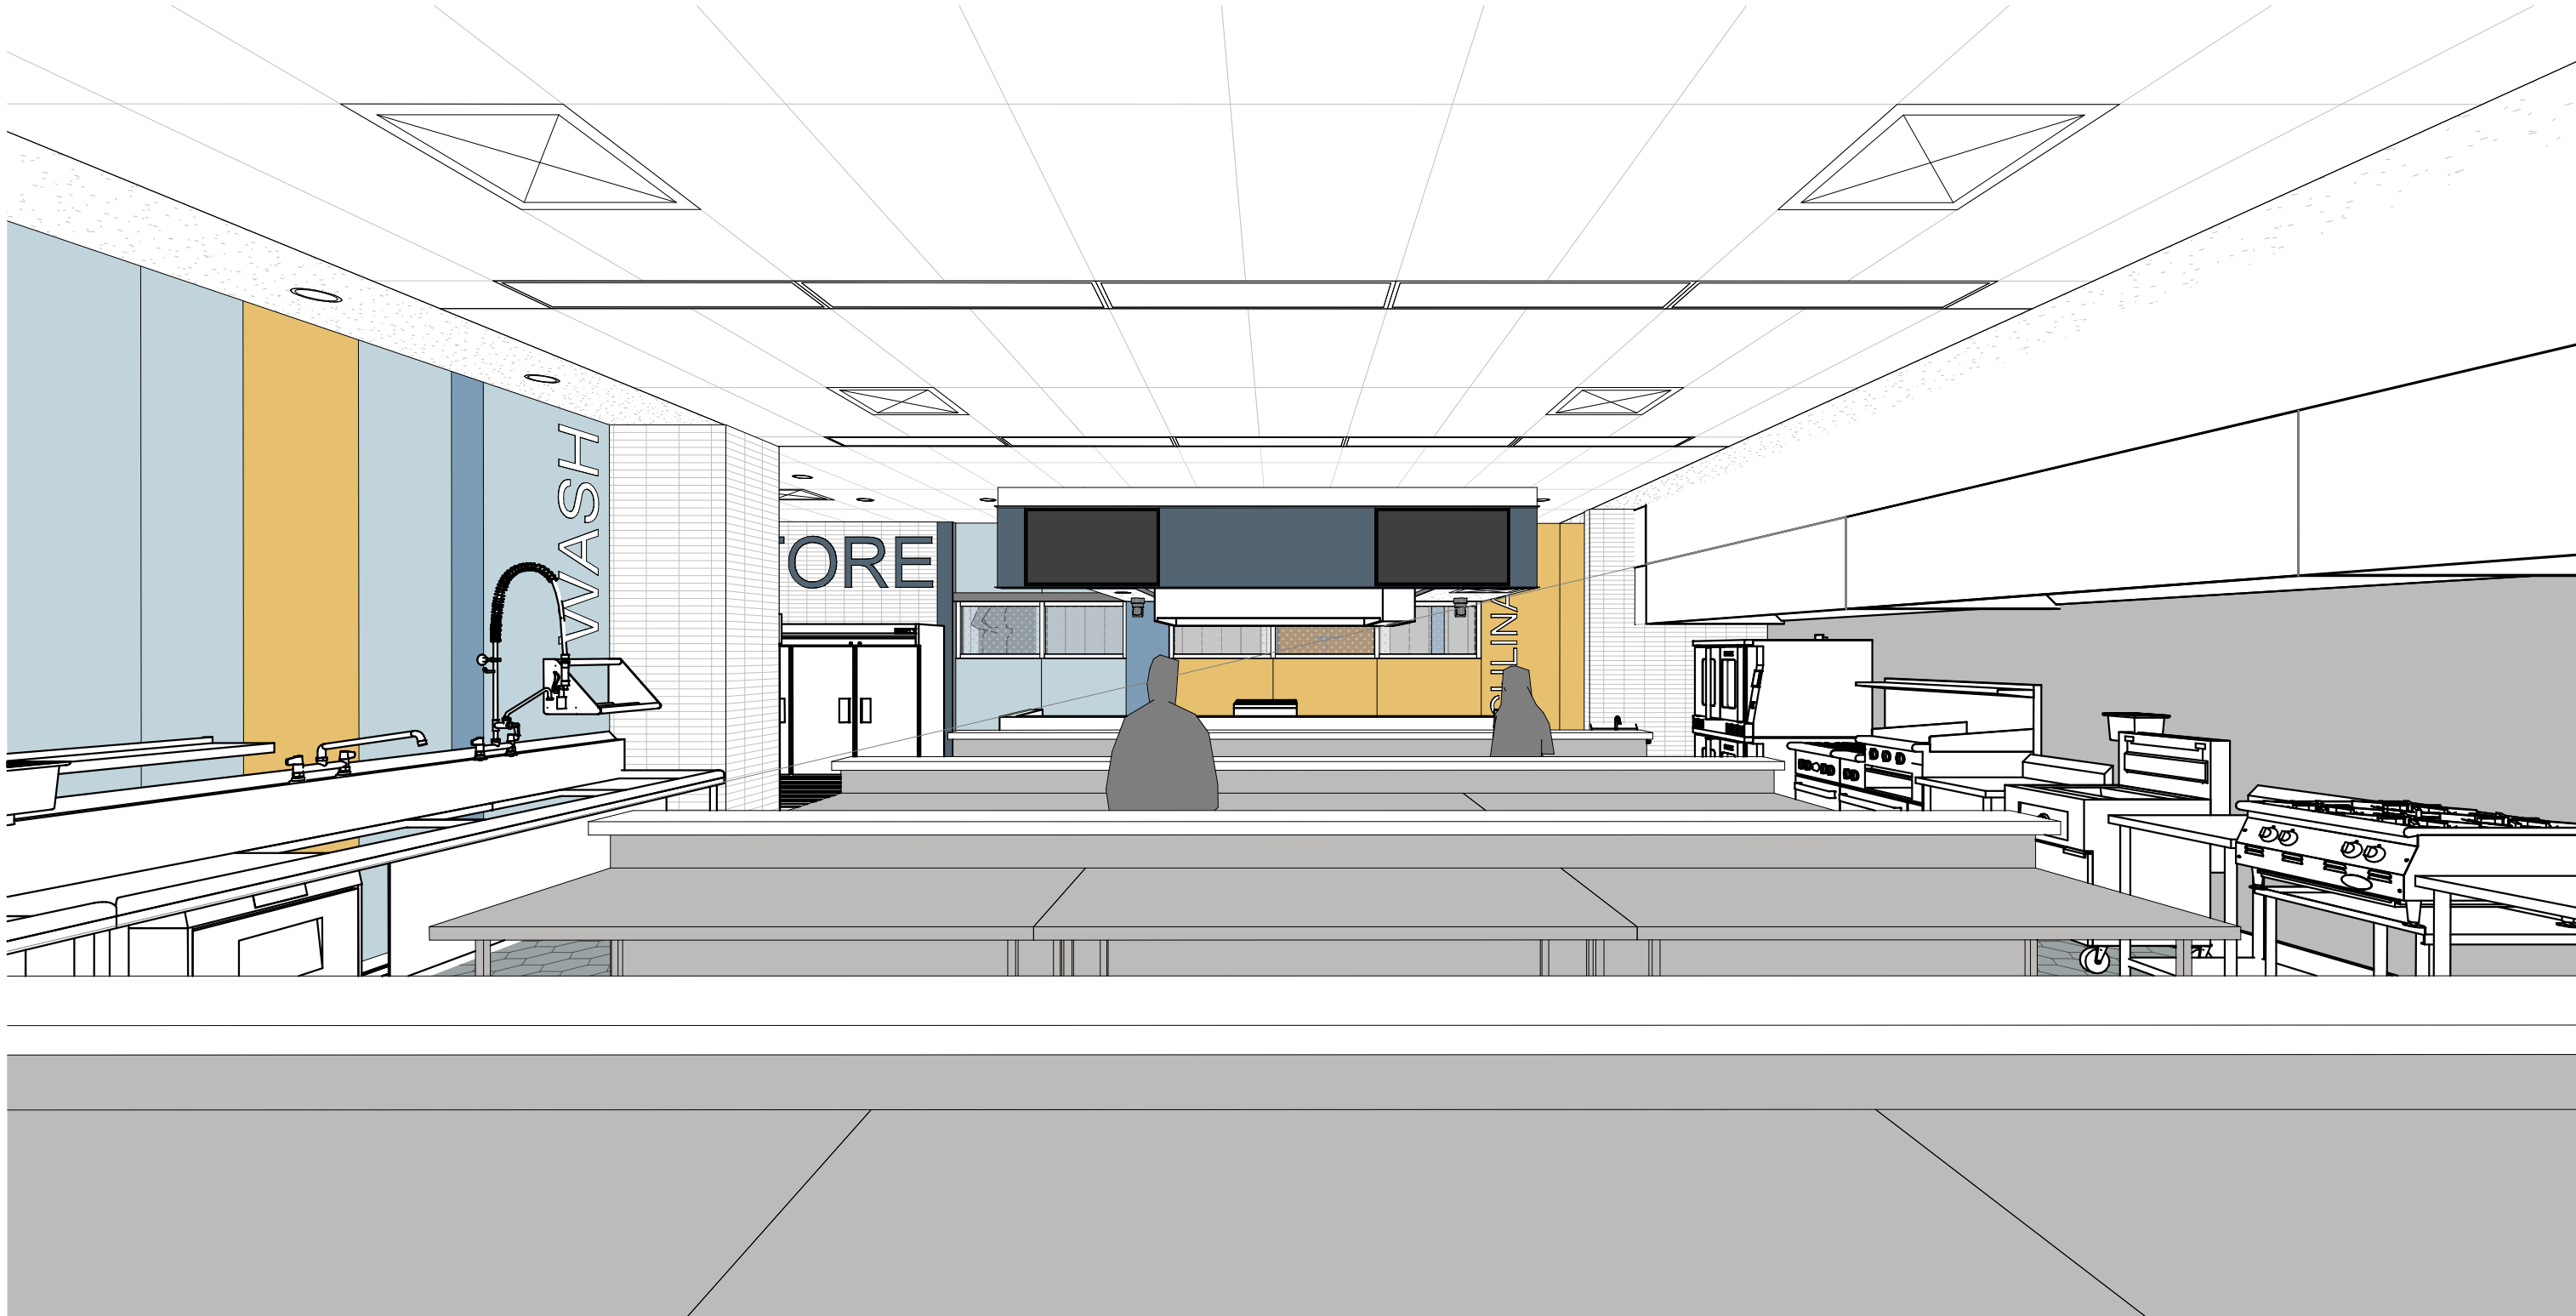

GOW HASTINGS  
ARCHITECTS

275 SPADINA ROAD  
TORONTO ONTARIO M5R 2V3  
416-920-0031  
GOWHASTINGS.COM

ALL DRAWINGS, SPECIFICATIONS, RELATED DOCUMENTS AND DESIGN ARE THE COPYRIGHT PROPERTY OF THE ARCHITECT AND MUST BE RETURNED UPON REQUEST. REPRODUCTION OF THE DRAWINGS, SPECIFICATIONS, RELATED DOCUMENTS AND DESIGN IN WHOLE OR IN PART IS STRICTLY FORBIDDEN WITHOUT THE ARCHITECT'S WRITTEN PERMISSION. THIS DRAWING SHALL NOT BE USED FOR CONSTRUCTION PURPOSES UNLESS COUNTERSIGNED.

ARCHITECTURAL

Gow Hastings Architects  
275 Spadina Rd, Toronto, ON M5R 2V3  
(416) 920-0031

Sheet List - Architectural	
Sheet Number	Sheet Name
A000	Cover, Consultant List, Drawing Lists
A001	OBC Matrix, Life Safety Plan, Key Plan
A002	Assembly Types, Legends & Notes, Door Schedule & Details
A010	Demolition Plan - Level 1
A011	Demolition RCP - Level 1
A012	Demolition Plan & Demolition RCP - Level 2
A101	Floor Plan - Level 1
A102	Floor Plan - Level 2
A103	Floor Plan - Roof Plan
A201	RCP - Level 1
A202	RCP - Level 2
A300	Building Sections
A400	Interior Elevations
A500	Interior Plan and Section Details
A501	Interior Section Details
A502	Exterior Section Details and Typical Details
A600	Stage Stair
A700	Finishes Plan

STRUCTURAL

CIMA+  
415 Baseline Road West, Bowmanville, ON L1C 5M2  
(905) 697-4464

Sheet List - Structural	
Sheet Number	Sheet Name
S001	General Notes
S002	Partial Existing Ground Plan
S003	Partial Existing Second Framing Plan
S004	Partial Existing Roof Framing Plan
S005	Lintel Schedule, Typical Details and Sections
S006	Sections
S007	Sections

MECHANICAL

QUASAR Consulting Group  
250 Rowntree Dairy Rd, Woodbridge, ON L4L 9J7  
(905) 507-0800

Sheet List - Mechanical	
Sheet Number	Sheet Name
M-001	Mechanical Legend & Sheet List
M-101	Mechanical Level 1 Demolition Plan - Plumbing
M-151	Mechanical Level 1 New Construction Plan - Plumbing
M-201	Mechanical Level 1 Demolition Plan - HVAC
M-202	Mechanical Level 2 - Demolition Plan - HVAC
M-251	Mechanical Level 1 New Construction Plan - HVAC
M-252	Mechanical Level 2 New Construction Plan - HVAC
M-253	Mechanical Roof New Construction Plan - HVAC & PLUMBING
M-301	Mechanical Detail Sheet No. 1
M-302	Mechanical Detail Sheet No. 2
M-303	Exhaust Hood Details
M-304	Exhaust Hood Details & Wiring Diagrams
M-305	Mechanical Control Sequences
M-306	Mechanical Control Sequences
M-307	Mechanical Equipment Schedules

ELECTRICAL

QUASAR Consulting Group  
250 Rowntree Dairy Rd, Woodbridge, ON L4L 9J7  
(905) 507-0800

Sheet List - Electrical	
Sheet Number	Sheet Name
E-001	Electrical Legend & Sheet List
E-101	Electrical Demolition Plan - Lighting
E-151	Electrical New Work Plan - Lighting
E-201	Electrical Demolition Plan - Level 1 - Power & Systems
E-251	Electrical New Work Plan - Level 1 - Power & Systems
E-252	Electrical Plans - Level 2 - Power & Systems
E-253	Electrical Plans - Roof - Power & Systems
E-301	Electrical Equipment & Panel Schedules
E-302	Electrical Detail Sheet No. 1
E-303	Electrical Detail Sheet No. 2
E-304	Electrical Detail Sheet No. 3

FOOD SERVICE

KAIZEN  
1525 Cornwall Rd, Oakville, ON L6J 0B2  
(905) 338-3222

Sheet List - Food Services	
Sheet Number	Sheet Name
QF-000	Cover Sheet
QF-100	Overall Plan
QF-101	Enlarged Equipment Plan & List
QF-102	Mechanical, Electrical & Plumbing Schedule
QF-200	Special Conditions & Wall Protection Plan
QF-201	Mechanical Connection Points
QF-202	Electrical Connection Points
QF-203	Reflected Ceiling Plan
QF-300	Elevations
QF-301	Isometric & Perspective Views
QF-400	Exhaust Hood Details
QF-401	Exhaust Hood Details
QF-402	Exhaust Hood Details
QF-500	Standard Details & Sections
QF-501	S.S. Metal Frame Walls

2	Issued for Permit & Tender	10/31/2025
1	Issued for 90% CD - Client Review	10/09/2025

No.	ISSUED/REVISED	DATE
-----	----------------	------

Henry St H.S.  
Culinary Classroom Renovation

600 Henry St, Whitby, ON L1N 1L4

Cover, Consultant List,  
Drawing Lists


Scale:

Project Number:  
25-102




A000


# A001

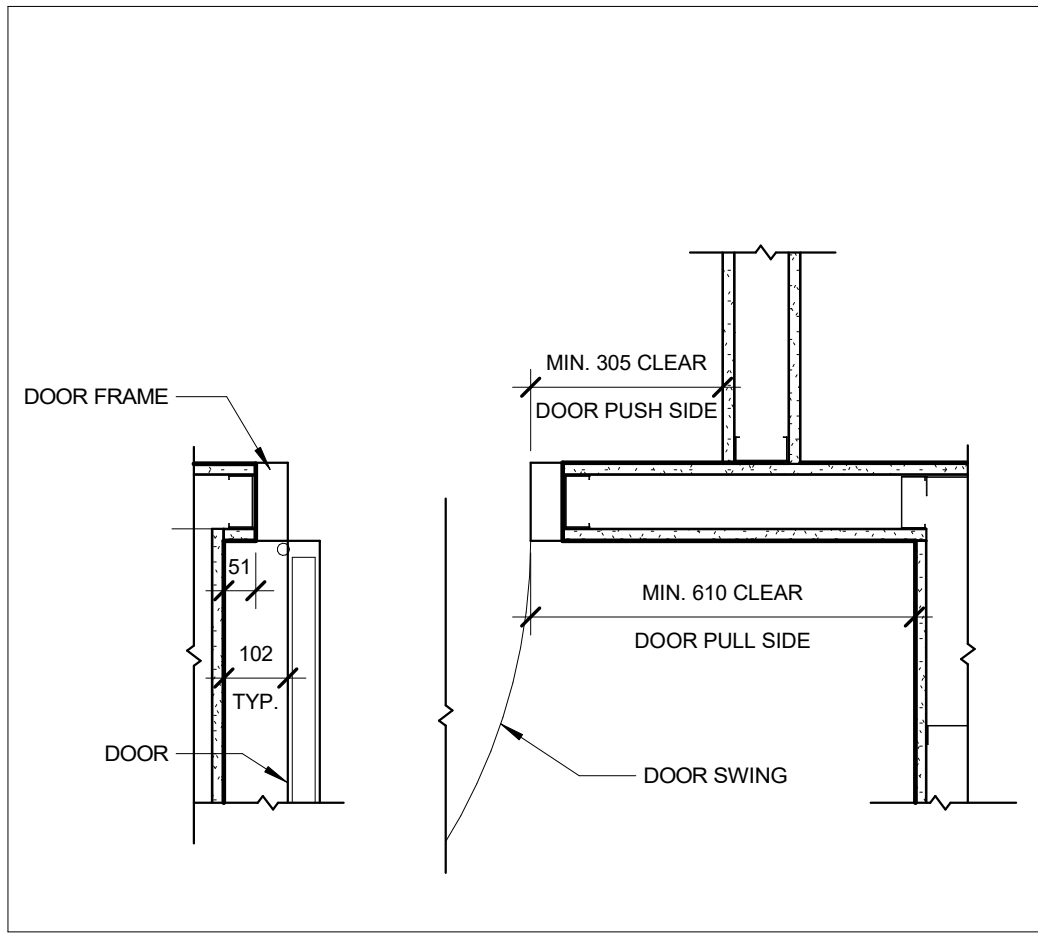

6 Plan Detail - Typical Door Clearance  
1 : 12

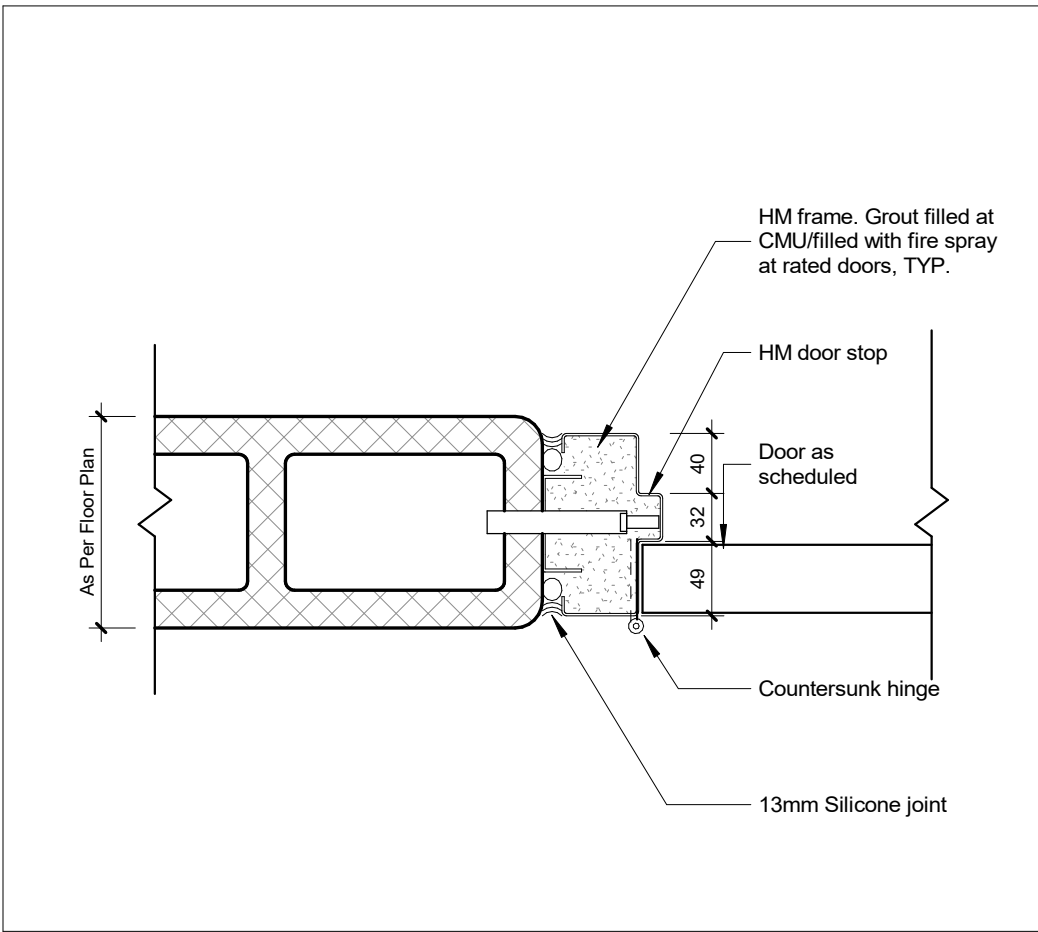


4 Plan Detail - HM Door Frame at CMU Partition  
1 : 5

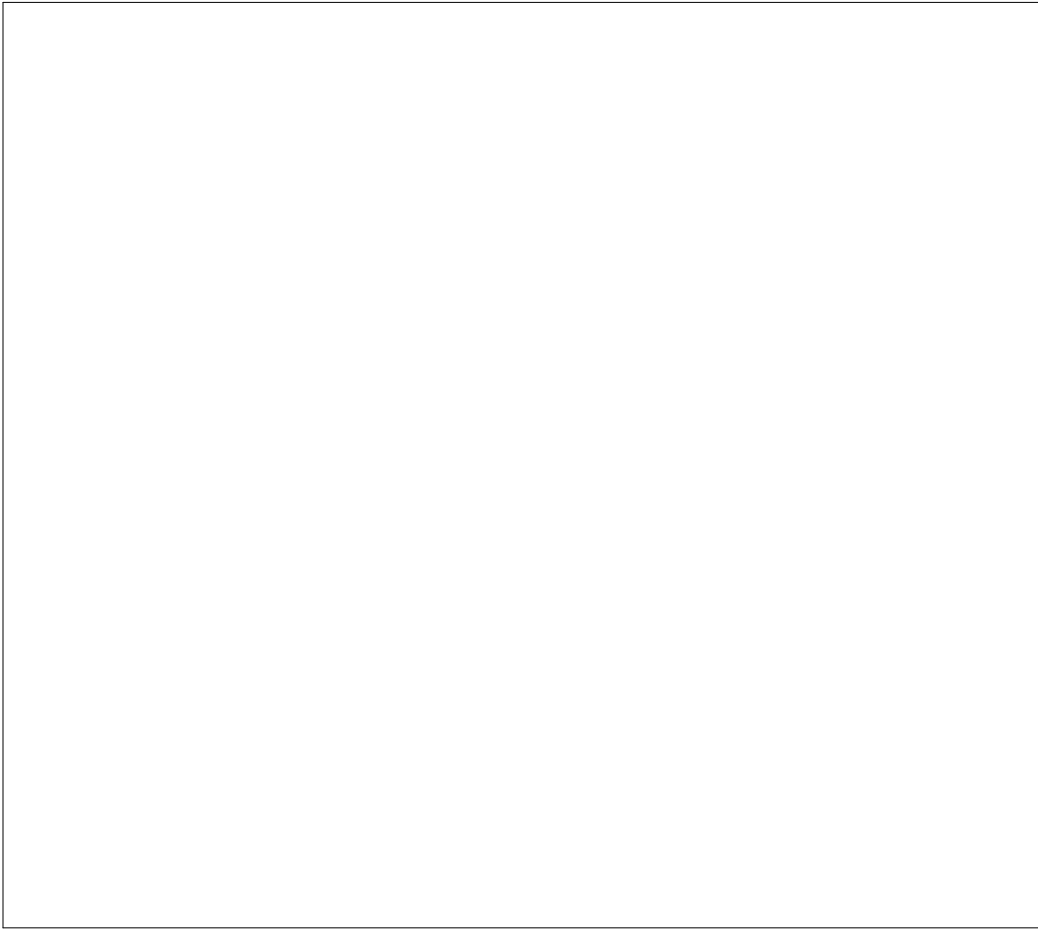

## DOOR SCHEDULE


### DOOR TYPE SCHEDULE NOTES

- All glazing to be tempered
- All fire rated assemblies to be Fire rated glass
- All HM frames to be 2" profile unless noted otherwise
- Refer to hardware schedule in specifications

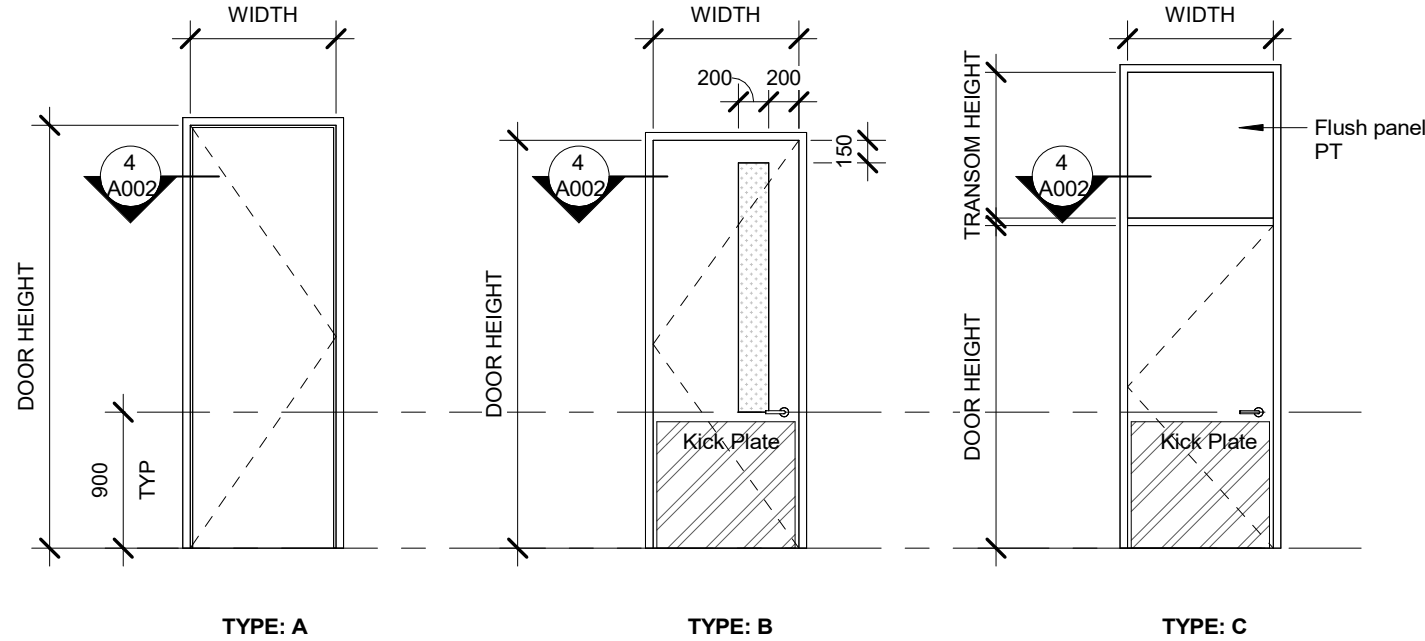


Door Schedule												
Door No.	From Room: Name	To Room: Name	To Room: Number	Type	Door Height	Transom Height	Width	Door Mat'l	Door Finish	Frame Mat'l	Frame Finish	Glazing Type
D1100B	Corridor	AV Room	1100B	A	2135		965	HM	PT1	HM	PT1	
D1106A	Cafetorium	Culinary Classroom	1106	B	2135	1200	1200	HM	PT1	HM	PT1	GL1
D1106B	Closet	Culinary Classroom	1106	C	2135	965	915	HM	PT1	HM	PT1	
D1142	Corridor	Office	1142	A	2135		965	HM	PT1	HM	PT1	
D3318	Science Lab (NIC)	Prep. Room	3318	A	2135		915	HM	PT1	HM	PT1	
EX-D1106	Culinary Classroom	Corridor	1100	EX-A	EX-VIF		EX-VIF	EX-HM	PT1	EX-HM	PT1	EX-45 MIN

Reserved

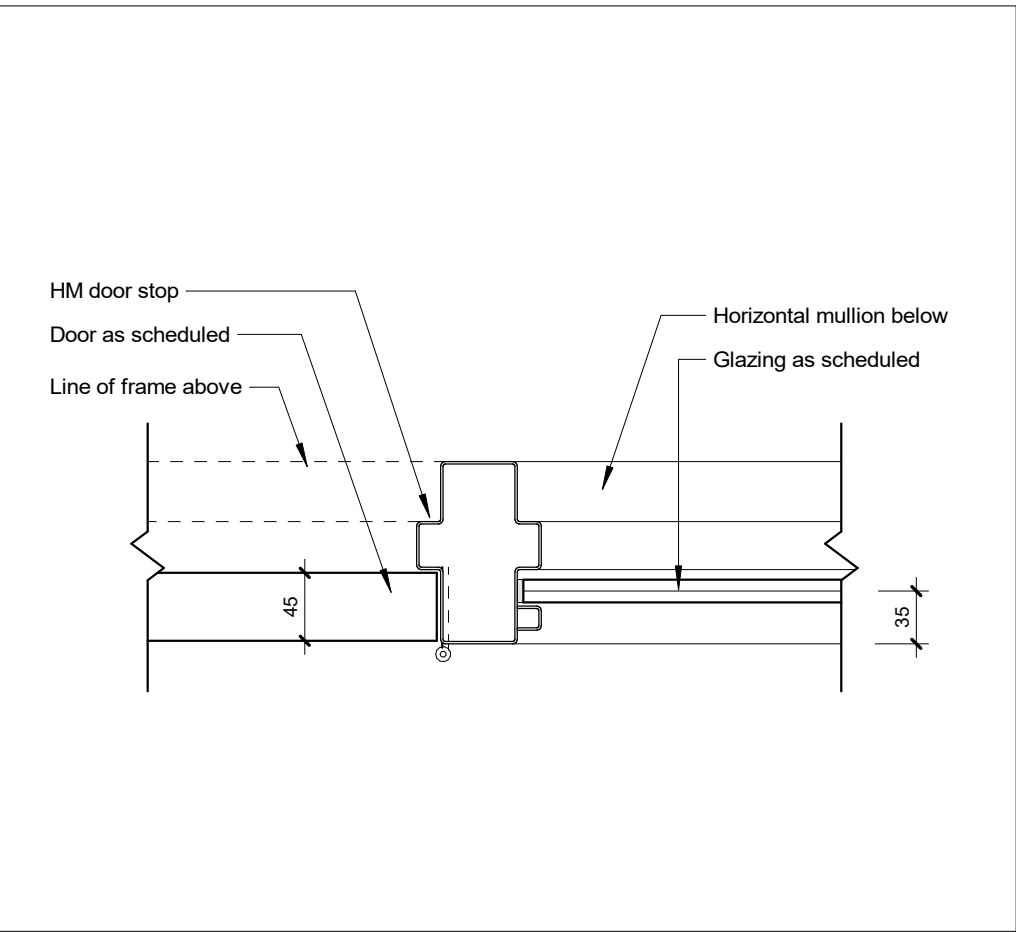

3 Plan Detail - HM Door Frame w/ Sidelight, TYP.  
1 : 5

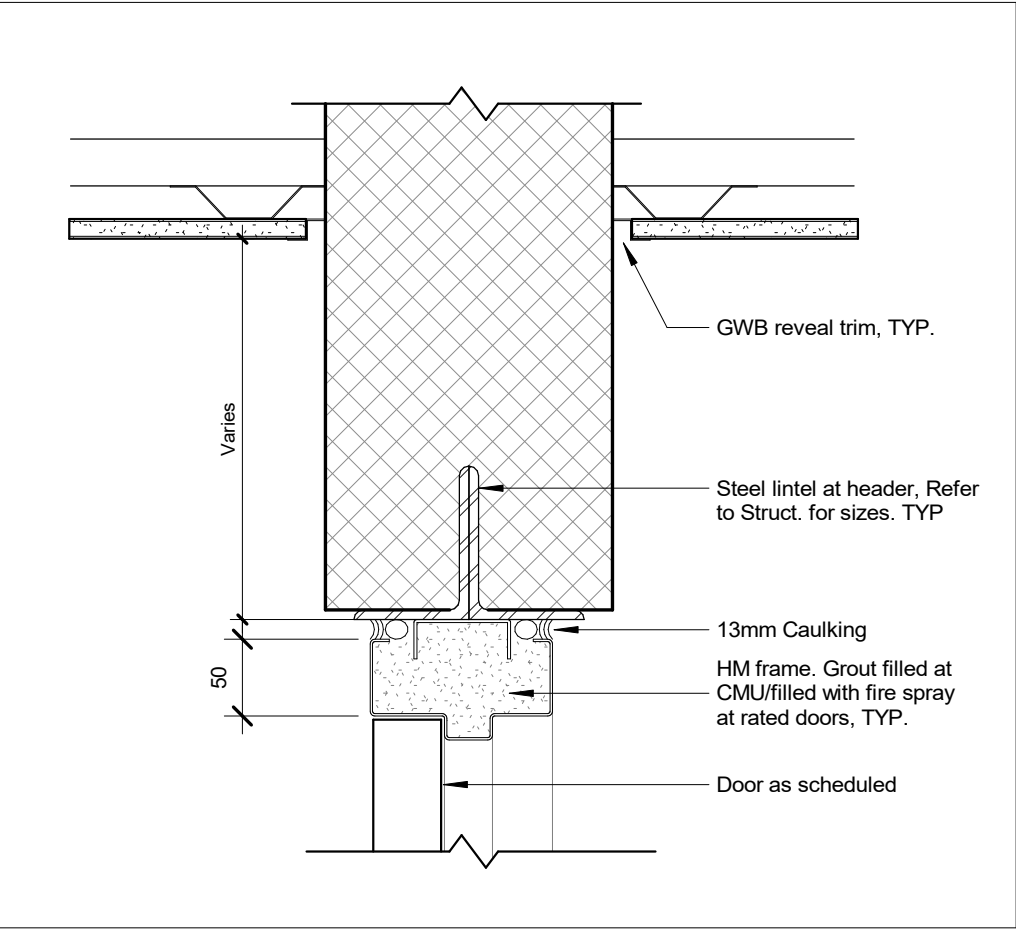

1 Section Detail - HM Door Header @ CMU, TYP.  
1 : 5

## Ceiling Types

Type	FRR	S.T.C.	Construction	Description
C1	-	-		DRYWALL CEILING - FOR KITCHENS Carrying channel (per supplier) 22mm Furring channel 13mm GWB
C2	-	-		DRYWALL CEILING Carrying channel (per supplier) 22mm Furring channel 13mm GWB
C3	-	-		ACOUSTIC CEILING TILE - FOR KITCHENS T-Grid framing 2 x 4 ft Square Lay-In Acoustic Ceiling Tile (ACT1)
C4	-	-		ACOUSTIC CEILING TILE T-Grid framing 2 x 4 ft Square Lay-In Acoustic Ceiling Tile (ACT2)

## Glazing Screen Types

Type	FRR	S.T.C.	Construction	Description
SC1	1HR	-		50mm x 120mm HM Frame GL1 - 8mm thick laminated glass ceramic with 45 minute fire rating EX CMU partition above, refer to details
SC2	1HR	-		50mm x 120mm HM Frame Designed to meet guard loads as per OBC 4.1.5.14. GL2 - 8mm thick laminated glass ceramic with 60 minute fire rating R63 partition above, refer to details

## Shaft Wall Types

Type	FRR	S.T.C.	Construction	Description
S105	2HR	-		Horizontal Shaft Type: OBMEC #89-1-118 25mm Gypsum Liner Panel 102mm CH Studs @ 610mm OC 3 x 13 mm Type X GWB
S94	1HR	42		Vertical Shaft Type: ULC U469 16 mm Type X GWB 102mm CH Studs @ 610mm OC 25mm Gypsum Liner Panel Shaft to U/S of slab/structure above UNO

### Standard Abbreviations

ADJ	Adjustable
AFF	Above Finished Floor
BLDG	Building
BLK	Block
CL	Center Line
CLG	Ceiling
CONT	Continuous
DIA	Diameter
DIM	Dimension
DWG	Drawing
ELEV	Elevator
EQ	Equal
EX/EXIST	Existing
EXP	Exposed
FLR	Floor
F/O	Face of
FRR	Fire Resistance Rating
FPR	Fire Protection Rating
FS	Food Service
HR	Hour
HT	Height
MAX	Maximum
MIN	Minimum
NIC	Not in Contract
NTS	Not to Scale
OC	On Centre
O/H	Overhead
OSCI	Owner Supplied Contractor Installed
RAD	Radius
RCP	Reflected Ceiling Plan
REQ'D	Required
REV	Reverse
RM	Room
RQMT(S)	Requirement(s)
SD	Similar
SPEC(S)	Specification(s)
S.T.C.	Sound Transmission Class
STD	Stud
T&G	Tongue & Groove
T/O	Top of
TYP	Typical
UNO	Unless Noted Otherwise
U/S	Underside of
VIF	Verify in Field

### Material Abbreviations

ACT	Acoustic Ceiling Tile
ALUM	Aluminum
CT	Ceramic Tile
CTB	Ceramic Tile Base
CMU	Concrete Masonry Unit
CONC	Concrete
CPT	Drinking Fountain
DF	Diameter
EPO	Epoxy Paint
EPX	Epoxy Flooring
FIRE	Fire Rated Glass
FGL	Frosted Glass
FLM	Glazing Surface Film
FP	Felt Panel
GL	Glass
GRG	Glass Reinforced Gypsum
GWB	Gypsum Wallboard
HM	Hollow Metal
HS	Heat Strengthened
HWP	Hygienic Wall Panel
MIR	Mirror
MDF	Medium Density Fiberboard
MP	Metal Ceiling Panel
PLY	Fire Rated Plywood
POR	Porcelain Tile
PC	Polished Concrete
PLAM	Plastic Laminate
PT	Paint Finish
PTX	Intumescent Paint
PVB	Polyvinyl Butyral
QTZ	Quartz
RB	Rubber Base
RES	Resilient Sheet Flooring
SO	Solid Polymer Fabrications
SPI	SentryGlas Plus Ionoplast
SS	Stainless Steel
SSG	Structural Silicone Glazing
STL	Steel
STD	Stud
TGL	Tempered Glass
VPT	Vinyl Plank Tile
WB	Dry Gypsum Whiteboard
WD	Solid Wood
WP	Wood Panel
WV	Wood Veneer

### Equipment and Specialties Abbreviations

AP	Access Panel
ADO	Automatic Door Operator
CG	Corner Guard
CH	Coat Hook
CP	Control Panel
DW	Dishwasher
FHC	Fire Hose Cabinet
FR	Refrigerator
FS	Floor Sink
FTS	Floor Transition Strip
HWS	Hand Washing Sink
HS	Hydration Station
LOC	Locker
PB	Push Button
PL	Plate
RS	Roller Shade
S	Speaker
TV	Television
WBF	Water Bottle Filler

### Interior Partition & Furring General Notes

- User water-resistant drywall in all wet areas. See specifications.
- Provide continuous plywood blocking behind all millwork cabinets, suspended items, televisions, etc.
- Where infilling walls, use metal furring and additional GWB to align to adjacent wall surfaces.
- Extend all partitions and furring to underside of floor slab, deck, or structure above unless otherwise noted.
- Refer to Life Safety Plans & Sections for location of all fire-rated partitions.
- Where wall finish is ceramic wall tile, provide cement tile backer board.
- At fire-rated partitions, provide fire-rated sealant at the top and bottom of partition, and at tight-fitting penetrations. Firestop as req'd at U/S of metal deck & large gaps per ULC/cUL firestop design. Refer to M&E documents for firestopping at M&E penetrations.
- All interior CMU infill walls are to be bolted and bonded into the existing masonry where infilling an existing opening is required.

## Interior Masonry - CMU

Type	FRR	S.T.C.	Construction	Description
C12	1HR	48		140mm Reinforced Hollow Concrete Masonry Unit Refer to Structural Partition to U/S of slab/structure above UNO
C13	2HR	48		140mm Hollow Concrete Masonry Unit Grouted Solid Partition to U/S of slab/structure above UNO
C14	1.5HR	50		190mm Reinforced Hollow Concrete Masonry Unit Refer to Structural Partition to U/S of slab/structure above UNO

## Interior Partition Types - Metal Stud


Type	FRR	S.T.C.	Construction	Description
P21	---	35		16 mm Type X GWB 64mm Steel Studs @ 610 OC 16 mm Type X GWB Partition to U/S of slab/structure above UNO

## Interior Partition Types - Metal Stud, Fire Rated

Type	FRR	S.T.C.	Construction	Description
R63	1HR	45		ULC W453 2 x 16 mm Type X GWB 203mm Steel Studs @ 610 OC 150mm Acoustic Fibre Batt 16 mm Type X GWB Continuous Bead of 1HR Fire Rated Caulking at Header and Base Partition to U/S of slab/structure above UNO

## Furring Types

Type	FRR	S.T.C.	Construction	Description
F01	---	---		16 mm GWB 22mm Furring Channel Substrate (Refer to Drawings)
F11	---	---		16 mm GWB 42mm Furring Channel Substrate (Refer to Drawings)
F41	---	---		16 mm GWB 92mm Steel Studs Substrate (Refer to Drawings)
F61	---	---		16 mm GWB 152mm Steel Studs Substrate (Refer to Drawings)

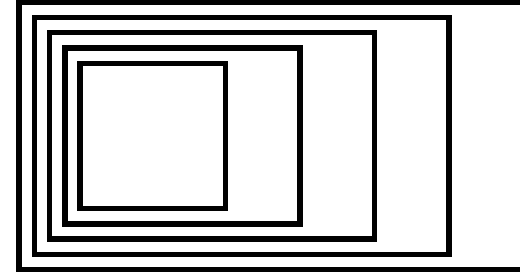

## GOW HASTINGS ARCHITECTS

275 SPADINA ROAD  
TORONTO ONTARIO M5R 2Y3  
416-920-0031  
GOWHASTINGS.COM

ALL DRAWINGS, SPECIFICATIONS, RELATED DOCUMENTS AND DESIGN ARE THE COPYRIGHT PROPERTY OF THE ARCHITECT AND MAY BE RE-USED OR REPRODUCED WITHOUT THE ARCHITECT'S WRITTEN PERMISSION. THIS DRAWING SHALL NOT BE USED FOR CONSTRUCTION PURPOSES UNLESS COUNTERSIGNED.

2 Issued for Permit & Tender 10/31/2025  
1 Issued for 90% CD - Client Review 10/09/2025

No. ISSUED/REVISED DATE

Henry St H.S.  
Culinary Classroom Renovation

600 Henry St, Whitby, ON L1N 1L4


## Assembly Types, Legends & Notes, Door Schedule & Details

Scale: As indicated

Project Number: 25-102




# A002

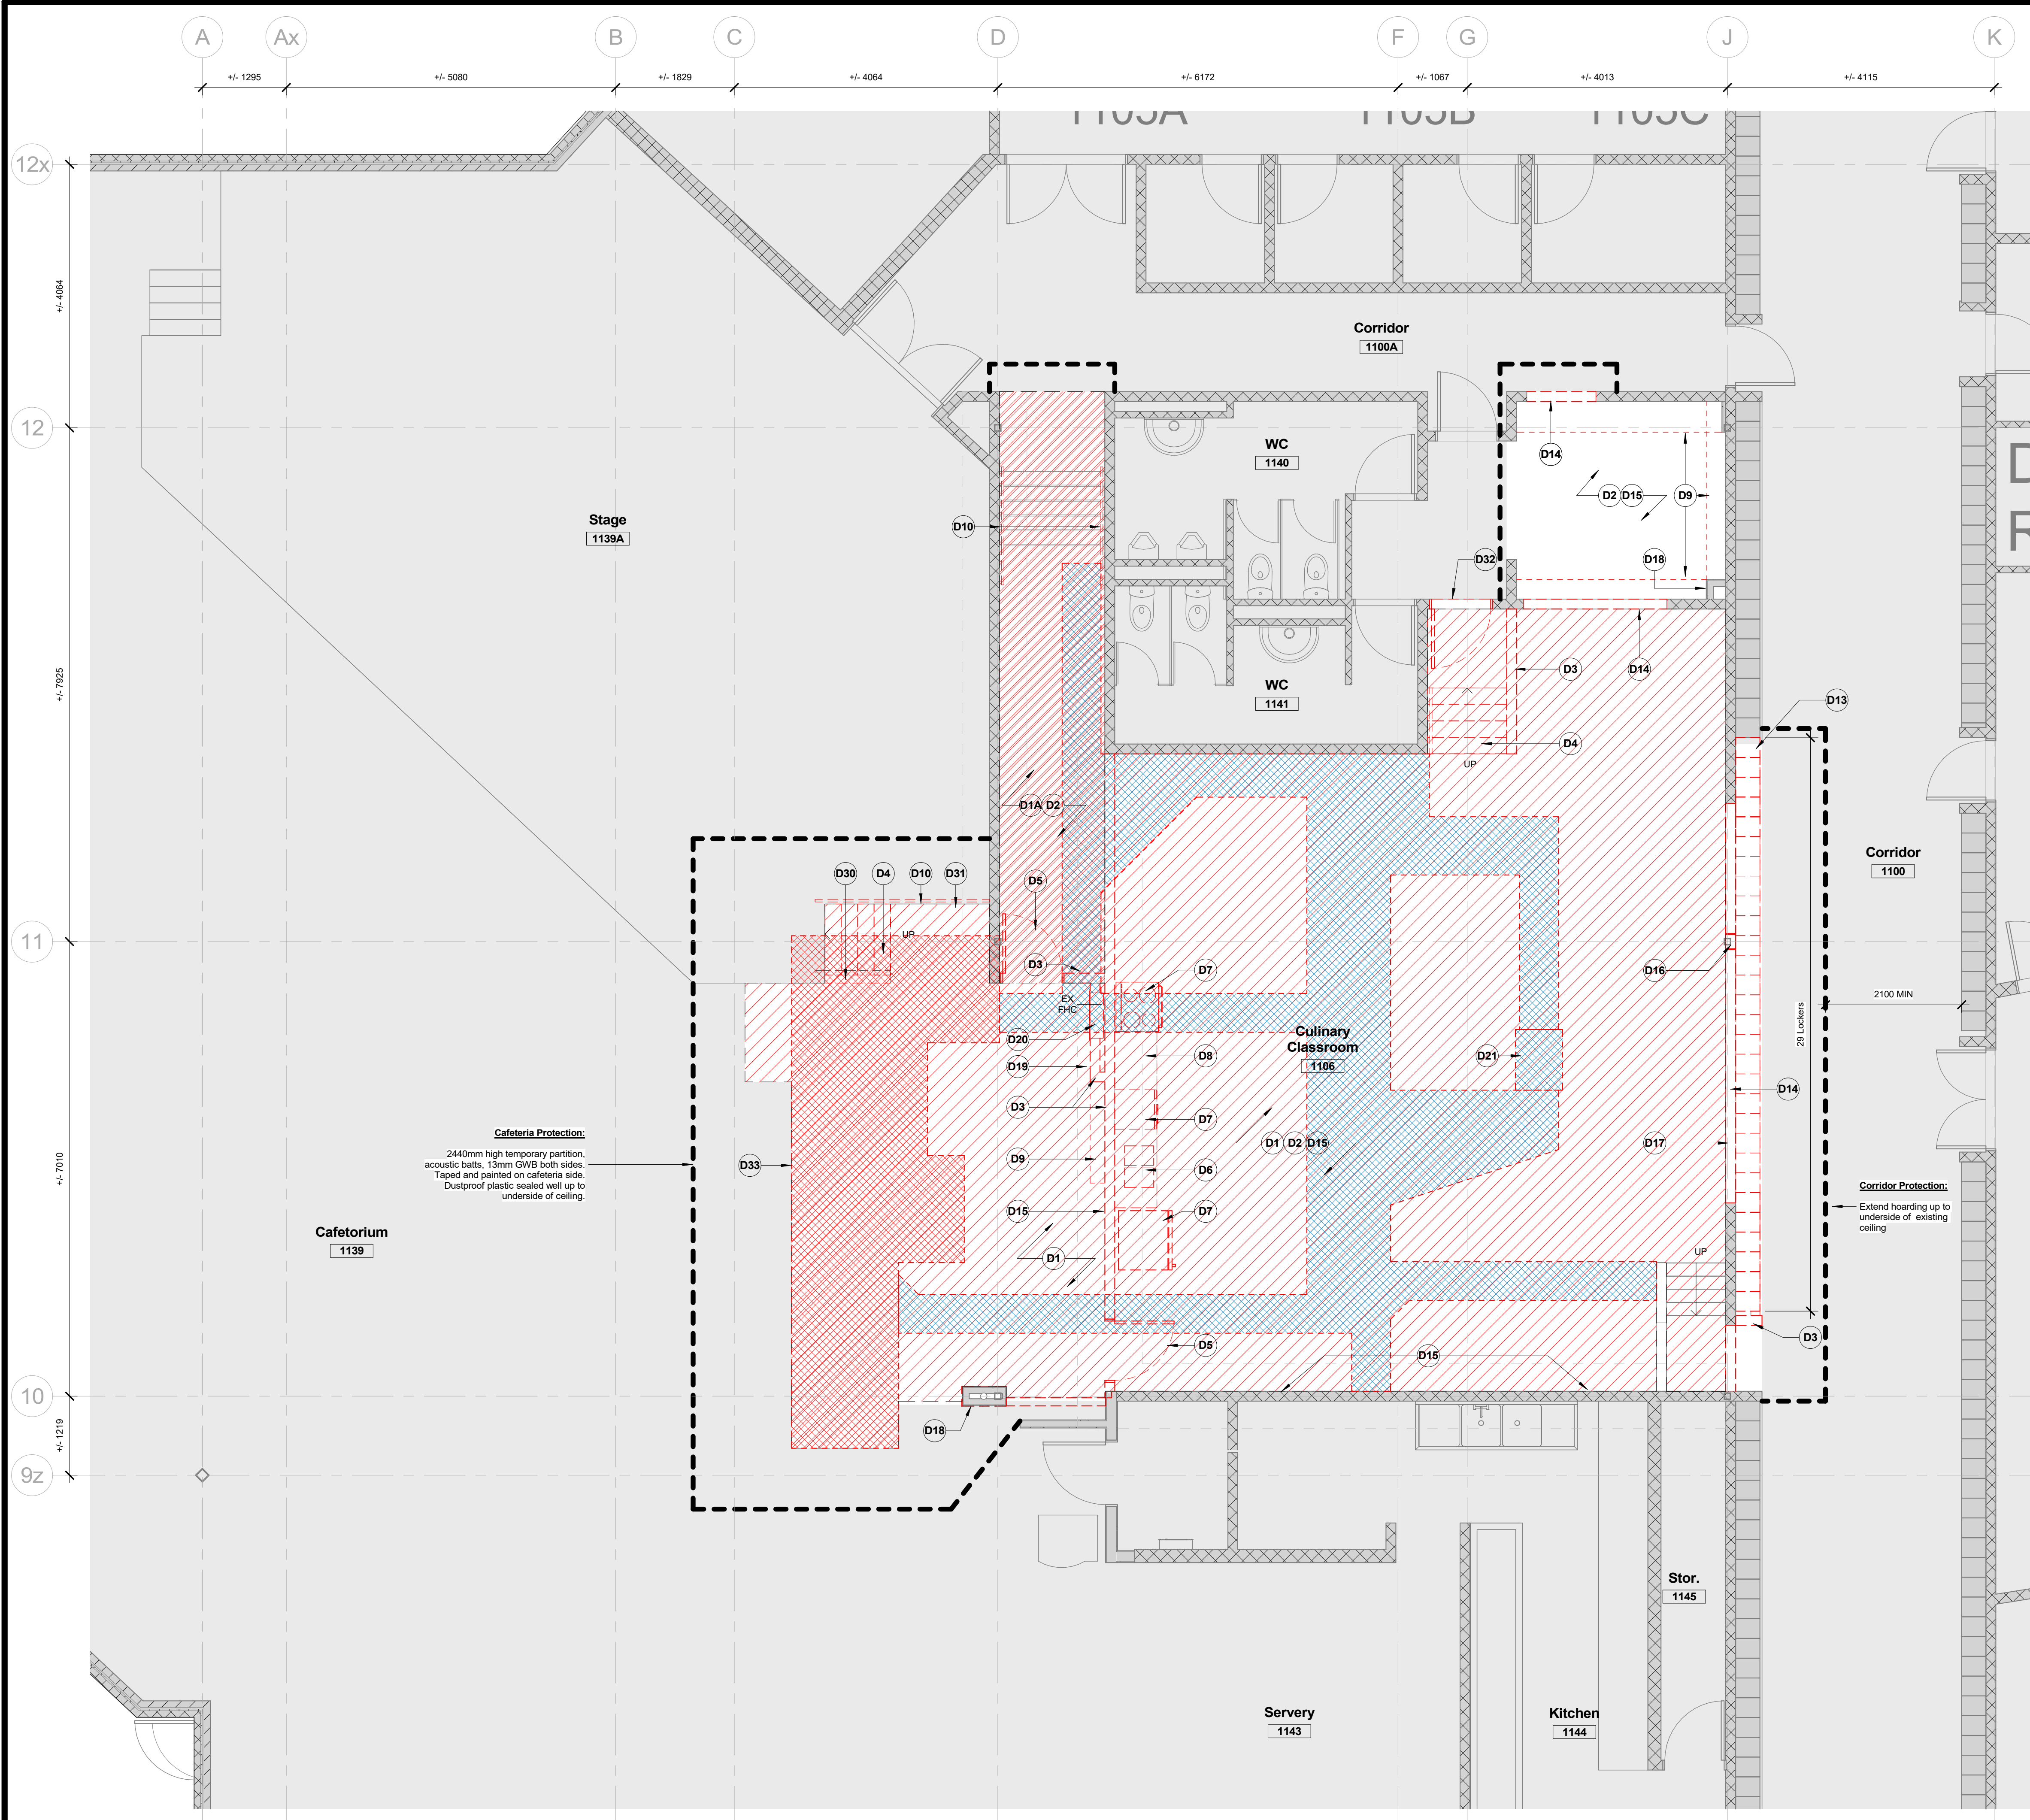

Demolition Plan Notes - Level 1	
Note	Description
D1	Demolish and remove existing VCT floor finish.
D1A	Demolish and remove existing terrazzo floor finish.
D2	Demolish and remove existing base trim.
D3	Demolish and remove existing concrete masonry wall. Salvage Imperial BLK for reuse at door infill areas noted. Patch and make good EX with CONC infill, parging perpendicular wall joints to match existing. Hand tool horizontal mortar joints in parging where infill is visible, TYP.
D4	Demolish and remove existing steel platform, stairs, and railings. Patch and make good.
D5	Demolish and remove existing door & frame.
D6	Demolish existing sink. Refer to Mechanical.
D7	Remove existing appliances, including burner, dishwasher, refrigerator, and microwave. Salvage and hand over to owner.
D8	Demolish and remove existing millwork, metal supports, shelving and hooks. Patch and make good floor as required for new finish.
D9	Demolish and remove existing shelf and associated brackets. Store for re-use or handover to Owner at end of project.
D10	Demolish and remove existing railings and guard railings.
D13	Remove existing 29 lockers and associated steel framing including poured curb to extent of new partition location. Patch and make good floor as required for new finish. Salvage for relocation. Future location to be determined at a later date.
D14	Demolish portion of concrete block wall to allow for new opening location.
D15	Remove existing wall mounted accessories including pin up board, whiteboard, projectors, shelves, clock, paper towel dispenser, soap dispenser, and signage. Patch, make good, and store for re-use or handover to Owner at end of project.
D16	Existing column to remain. Strip finishes back to expose column and make good to receive new work.
D17	Remove existing speaker and its associated accessories.
D18	Remove existing metal panel. Patch and make good.
D19	Remove, retain and handover existing water fountain to Owner.
D20	Demolish and remove existing slab for new grease interceptor. Refer to Mechanical and Structural for details.
D21	Existing column to remain. Strip finishes back to expose column and make good to receive new work.
D30	Demolish and remove existing stage front paneling.
D31	Demolish and remove existing return air grill. Refer to mech.
D32	Remove EX door and frame for BLK wall infill. Remove alternate courses of Imperial BLK at opening for toothing back in with salvage BLK. Patch and make good wall and floor to match EX and as required for new finishes.
D33	Hatch area denotes extent of existing VCT floor finish, floor base, concrete slab and subbase to be sawcut and removed as required for thickening of slab for new concrete wall. Refer to Structural drawings for extent and depth of removal. Infill with new concrete slab and subbase and feather into existing slab. Prepare surface for new finishes. Refer to Finish Schedule.


NOTE: This drawing is to be viewed in colour.

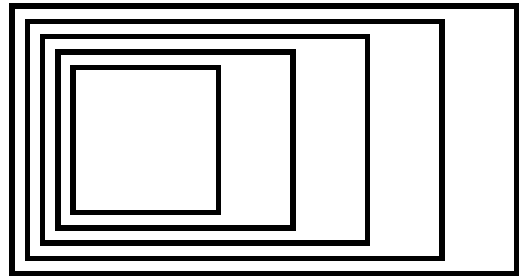

## GOW HASTINGS ARCHITECTS

275 SPADINA ROAD  
TORONTO ONTARIO M5R 2Y3  
416-920-0031  
GOWHASTINGS.COM

ALL DRAWINGS, SPECIFICATIONS, RELATED DOCUMENTS AND DESIGN ARE THE COPYRIGHT PROPERTY OF THE ARCHITECT. NO PART MAY BE REPRODUCED OR TRANSMITTED IN ANY FORM OR BY ANY MEANS, ELECTRONIC OR MECHANICAL, WITHOUT THE ARCHITECT'S WRITTEN PERMISSION. THIS DRAWING SHALL NOT BE USED FOR CONSTRUCTION PURPOSES UNLESS COUNTERSIGNED.

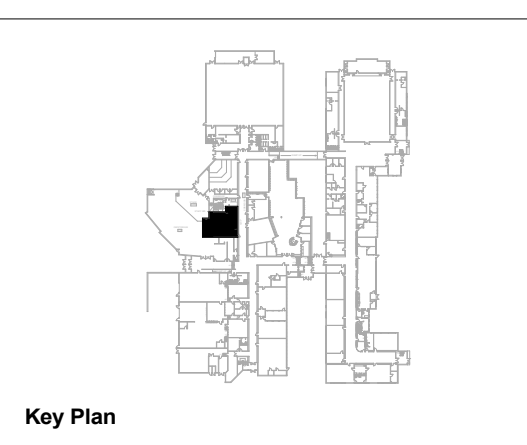

### DEMOLITION LEGEND

- Existing element to remain
- Existing element to be demolished
- Extent of hoarding
- Approximate extent of VCT flooring to be removed
- Approximate extent of terrazzo flooring to be removed
- Approximate extent of ceiling to be removed, retain light fixtures
- ACT tiles to be removed and handed over to college for re-use where noted
- Approximate extent of concrete slab removal required for slab thickening. Provide new concrete slab infill to match the extent of the slab demolition. Refer to Floor Plan for CMU (C14) partition locations and Structural for details.
- Approximate extent of trenching work. Provide new slab infill to match the extent of slab demolition. Refer to Mechanical and Structural for details.
- Existing door leaf/frame/ hardware to be salvaged - refer to door schedule for eligible locations of re-use

### DEMOLITION NOTES:

- Make good all existing ceiling, wall and floor surfaces damaged by demolition.
- See also mechanical and electrical drawings for further scope of demolition.
- Prepare existing floor smooth for new flooring. Add topping as required and grind smooth where floor variance exceeds 6mm vertically in 2000mm horizontally.
- Review all existing site conditions before starting work and advise architect of any discrepancies between drawings and existing site conditions.
- Cut back all existing, to be demolished, mechanical and electrical services to source and cap off as required. Refer to Mechanical and Electrical Consultant's drawings for further details. Protect all Mechanical and Electrical services to remain from damage.
- All work to be supervised by an experienced foreman at all times.
- Carry out all demolition work in a systematic manner as necessary to accommodate construction of all new work as shown herein and elsewhere in construction documents, as well as within the consultant's documents.
- Take measures to control and contain all dust and debris within the construction area. Ensure dust does not migrate into adjacent occupied spaces.
- All material required to be demolished is to be removed from the site and disposed of as per the regulations and requirements of all authorities having jurisdiction, unless noted otherwise.
- At end of each day's work, leave site in a safe condition so that no part is in danger of collapse. Do not stack salvaged material or debris unable to overload or make unstable any part of the structure.
- Remove back to source all power, data and voice infrastructure from walls that are to be demolished prior to demolition.
- Refer to reflected ceiling plan for details on areas of existing ceiling tiles to be removed/re-used.
- During demolition refer to and co-ordinate with information on both partition plan and reflected ceiling plan.
- Reserved.
- Reserved.
- Retain all existing ceiling tiles in good condition to be re-used or handed over to building landlord.
- Clean all existing window mullions and glazing. Remove all existing tape and make good.
- All work to conform to the requirements of specification drawings
  - 01 73 00 Execution
  - 01 74 19 Construction Waste Management and Disposal
  - 02 41 19 Selective Demolition
- Grind concrete slab where existing masonry walls have been removed. Make surface smooth and ready for new floor finish.
- Block off and provide signage around area of work during demolition and construction. Coordinate with Owner Representative for access to and to perform work in occupied areas.

2	Issued for Permit & Tender	10/31/2025
1	Issued for 90% CD - Client Review	10/09/2025

No.	ISSUED/REVISED	DATE
-----	----------------	------


Henry St H.S.  
Culinary Classroom Renovation

600 Henry St, Whitby, ON L1N 1L4


### Demolition Plan - Level 1

Scale: As indicated

Project Number:  
25-102

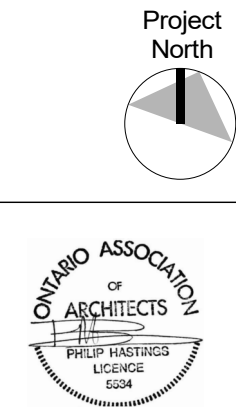


# A010

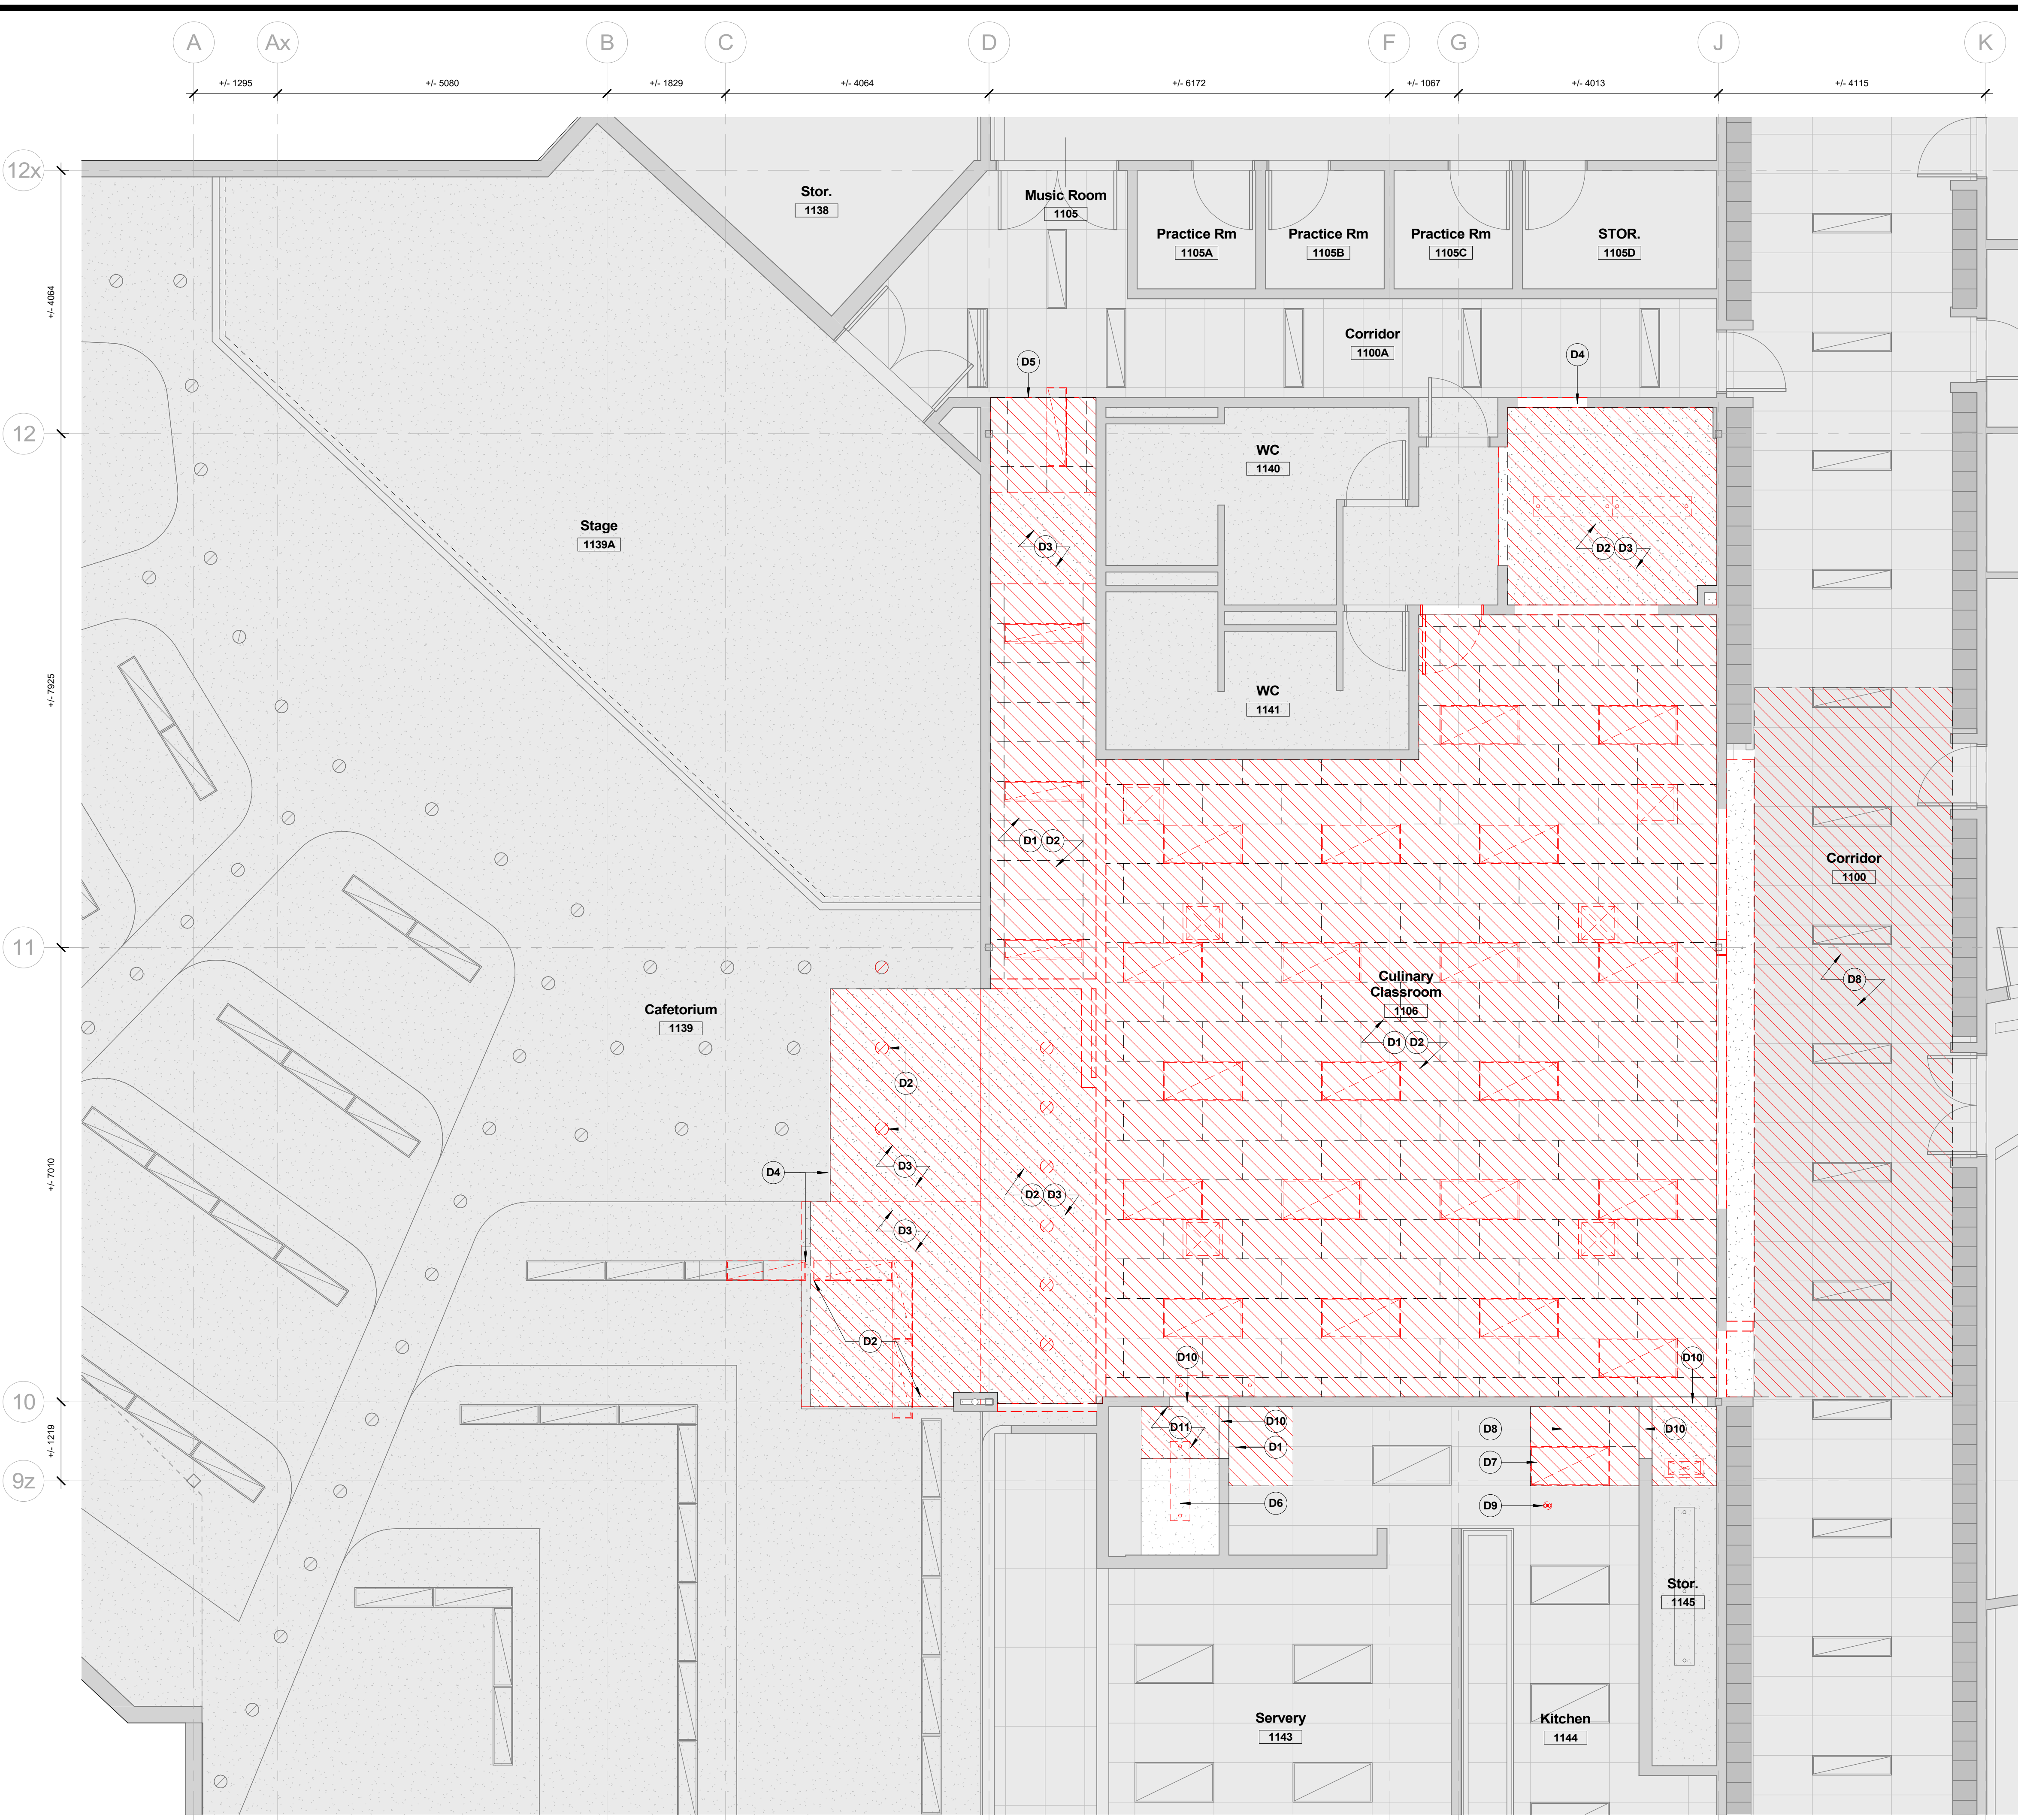

Demolition RCP Notes - Level 1	
Note	Description
D1	Demolish and remove all acoustic tile ceiling suspension grid, accessories and hanging system.
D2	Remove all existing light fixtures and all associated supports.
D3	Demolish and remove drywall ceiling and framing and associated assemblies.
D4	Repair and make good any damages to the existing ceiling resulting from demolition. All repairs to match existing ceiling finish and quality, TYP.
D5	Remove acoustic ceiling tiles as required. Provide new suspension grid to match existing at extent of removal, and make good to receive new work.
D6	GC to remove, store and re-install fixture to facilitate new mechanical work. Patch and make good.
D7	GC to remove and retain existing light fixtures. Store and protect until reinstall.
D8	Remove, store, and reinstall new ACT ceiling tiles and grids to facilitate new mechanical HVAC work.
D9	GC to remove, store and re-install EX Strobe at new location.
D10	Demolish and remove portion of existing CMU above to facilitate new mechanical HVAC work.
D11	Demolish and remove drywall ceiling and framing and associated assemblies to facilitate new mechanical HVAC work. Patch and repair.


NOTE: This drawing is to be viewed in colour.

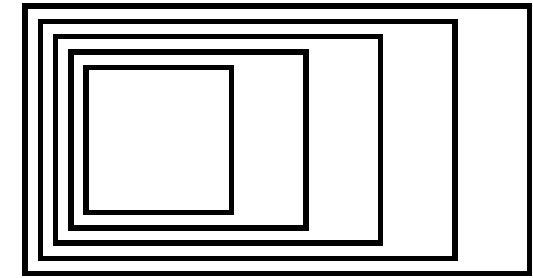

## GOW HASTINGS ARCHITECTS

275 SPADINA ROAD  
TORONTO ONTARIO M5R 2Y3  
416-920-0031  
GOWHASTINGS.COM

ALL DRAWINGS, SPECIFICATIONS, RELATED DOCUMENTS AND DESIGN ARE THE COPYRIGHT PROPERTY OF THE ARCHITECT. AND MAY BE RE-USED OR REPRODUCED WITHOUT THE ARCHITECT'S WRITTEN PERMISSION. THIS DRAWING SHALL NOT BE USED FOR CONSTRUCTION PURPOSES UNLESS COUNTERSIGNED.

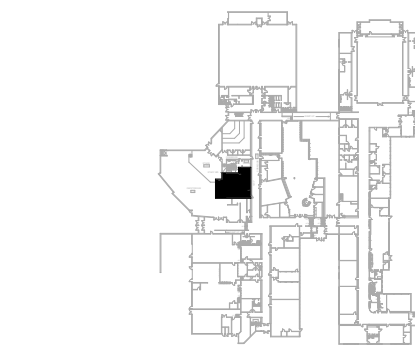

Key Plan

### DEMOLITION LEGEND

- Existing element to remain
- Existing element to be demolished
- Extent of hoarding
- Approximate extent of VCT flooring to be removed
- Approximate extent of terrazzo flooring to be removed
- Approximate extent of ceiling to be removed, retain light fixtures ACT tiles to be removed and handed over to college for re-use where noted
- Approximate extent of concrete slab removal required for slab thickening. Provide new concrete slab infill to match the extent of the slab demolition. Refer to Floor Plan for CMU (C14) partition locations and Structural for details.
- Approximate extent of trenching work. Provide new slab infill to match the extents of slab demolition. Refer to Mechanical and Structural for details.
- Existing door leaf/frame/ hardware to be salvaged - refer to door schedule for eligible locations of re-use


2	Issued for Permit & Tender	10/31/2025
1	Issued for 90% CD - Client Review	10/09/2025

No.	ISSUED/REVISED	DATE
-----	----------------	------

Henry St H.S.  
Culinary Classroom Renovation

600 Henry St, Whitby, ON L1N 1L4

### Demolition RCP - Level 1

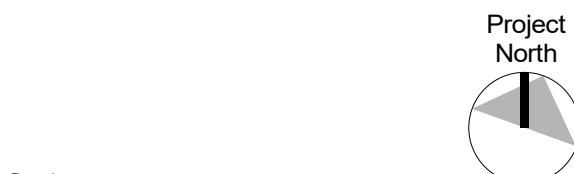

Scale: As indicated

Project Number:  
25-102



# A011



ALL DRAWINGS, SPECIFICATIONS, RELATED DOCUMENTS AND DESIGN ARE THE COPYRIGHT PROPERTY OF THE ARCHITECT AND MUST BE RETURNED UPON REQUEST. REPRODUCTION OF THE DRAWINGS, SPECIFICATIONS, RELATED DOCUMENTS AND DESIGN IN WHOLE OR IN PART IS STRICTLY FORBIDDEN WITHOUT THE ARCHITECT'S WRITTEN PERMISSION. THIS DRAWING SHALL NOT BE USED FOR CONSTRUCTION PURPOSES UNLESS COUNTERSIGNED.



EXX XX Existing door leaf/frame/ hardware to be salvaged - refer to door schedule for eligible locations of re-use

b.	ISSUED/REVISED	DATE
----	----------------	------


0 Henry St, Whitby, ON L1N 1L4




ONTARIO ASSOCIATION  
OF  
ARCHITECTS  
PHILIP HASTINGS  
LICENCE  
5534

# A012



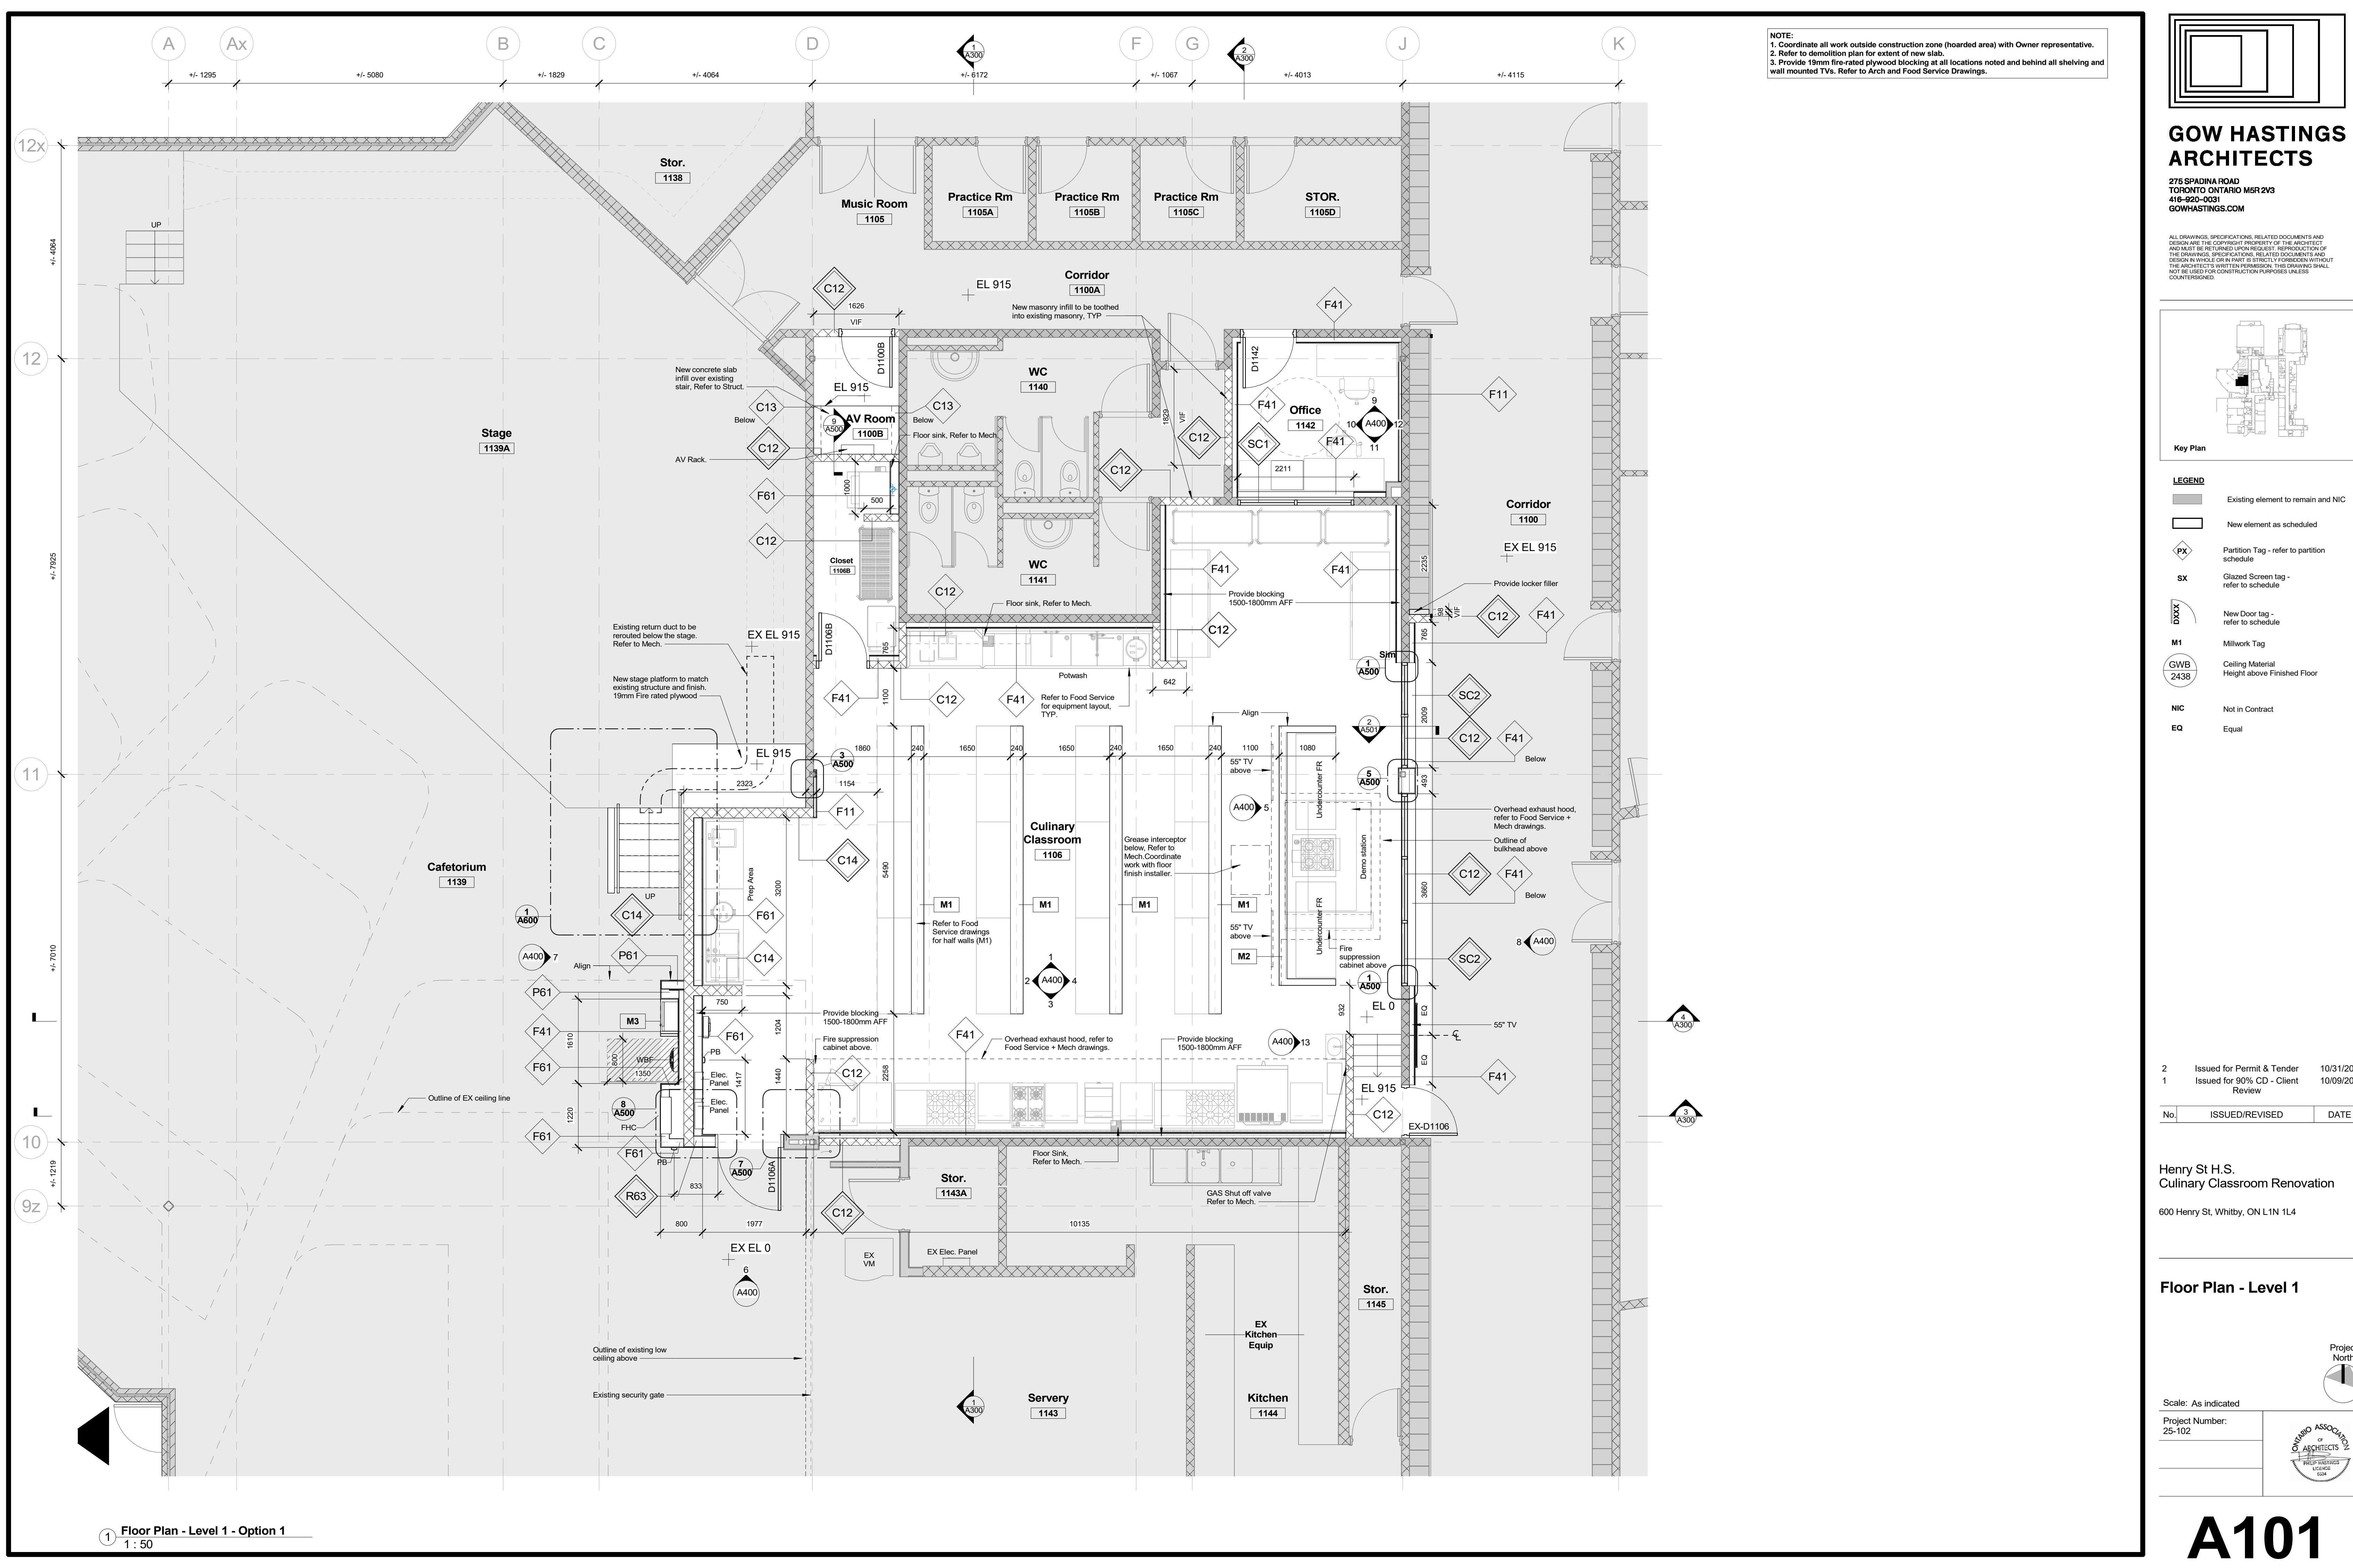


NOTE:  
1. Coordinate all work outside construction zone (hoarded area) with Owner representative.  
2. Refer to demolition plan for extent of new slab.  
3. Provide 19mm fire-rated plywood blocking at all locations noted and behind all shelving and wall mounted TVs. Refer to Arch and Food Service Drawings.

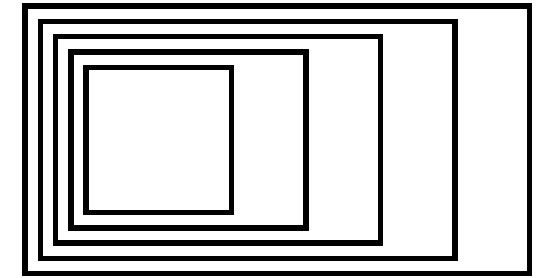

## GOW HASTINGS ARCHITECTS

275 SPADINA ROAD  
TORONTO ONTARIO M5R 2V3  
416-920-0031  
GOWHASTINGS.COM

ALL DRAWINGS, SPECIFICATIONS, RELATED DOCUMENTS AND DESIGN ARE THE COPYRIGHT PROPERTY OF THE ARCHITECT AND MAY BE REPRODUCED OR TRANSMITTED IN ANY FORM OR BY ANY MEANS, ELECTRONIC OR MECHANICAL, INCLUDING PHOTOCOPYING, RECORDING, OR BY ANY INFORMATION STORAGE AND RETRIEVAL SYSTEM, WITHOUT THE ARCHITECT'S WRITTEN PERMISSION. THIS DRAWING SHALL NOT BE USED FOR CONSTRUCTION PURPOSES UNLESS COUNTERSIGNED.

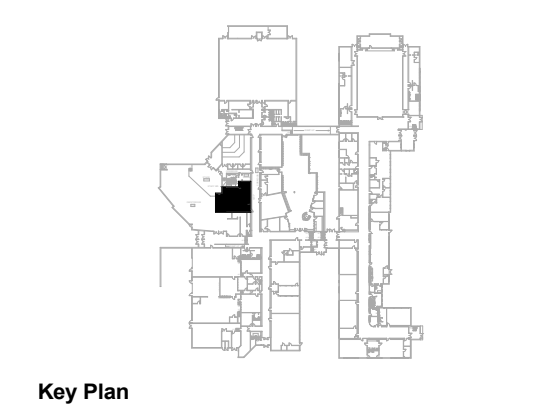

Key Plan

### LEGEND

- Existing element to remain and NIC
- New element as scheduled
- Partition Tag - refer to partition schedule
- Glazed Screen tag - refer to schedule
- New Door tag - refer to schedule
- Millwork Tag
- Ceiling Material Height above Finished Floor
- Not in Contract
- Equal

2 Issued for Permit & Tender 10/31/2025  
1 Issued for 90% CD - Client Review 10/09/2025

No.	ISSUED/REVISED	DATE
-----	----------------	------


Henry St H.S.  
Culinary Classroom Renovation

600 Henry St, Whitby, ON L1N 1L4


### Floor Plan - Level 1



Scale: As indicated  
Project Number: 25-102

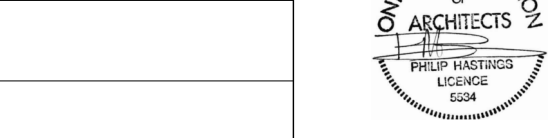

# A101

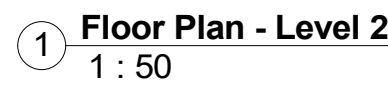

# A102




ALL DRAWINGS, SPECIFICATIONS, RELATED DOCUMENTS AND DESIGN ARE THE COPYRIGHT PROPERTY OF THE ARCHITECT AND MUST BE RETURNED UPON REQUEST. REPRODUCTION OF THE DRAWINGS, SPECIFICATIONS, RELATED DOCUMENTS AND DESIGN IN WHOLE OR IN PART IS STRICTLY FORBIDDEN WITHOUT THE ARCHITECT'S WRITTEN PERMISSION. THIS DRAWING SHALL NOT BE USED FOR CONSTRUCTION PURPOSES UNLESS COUNTERSIGNED.

b.	ISSUED/REVISED	DATE
----	----------------	------

0 Henry St, Whitby, ON L1N 1L4

---

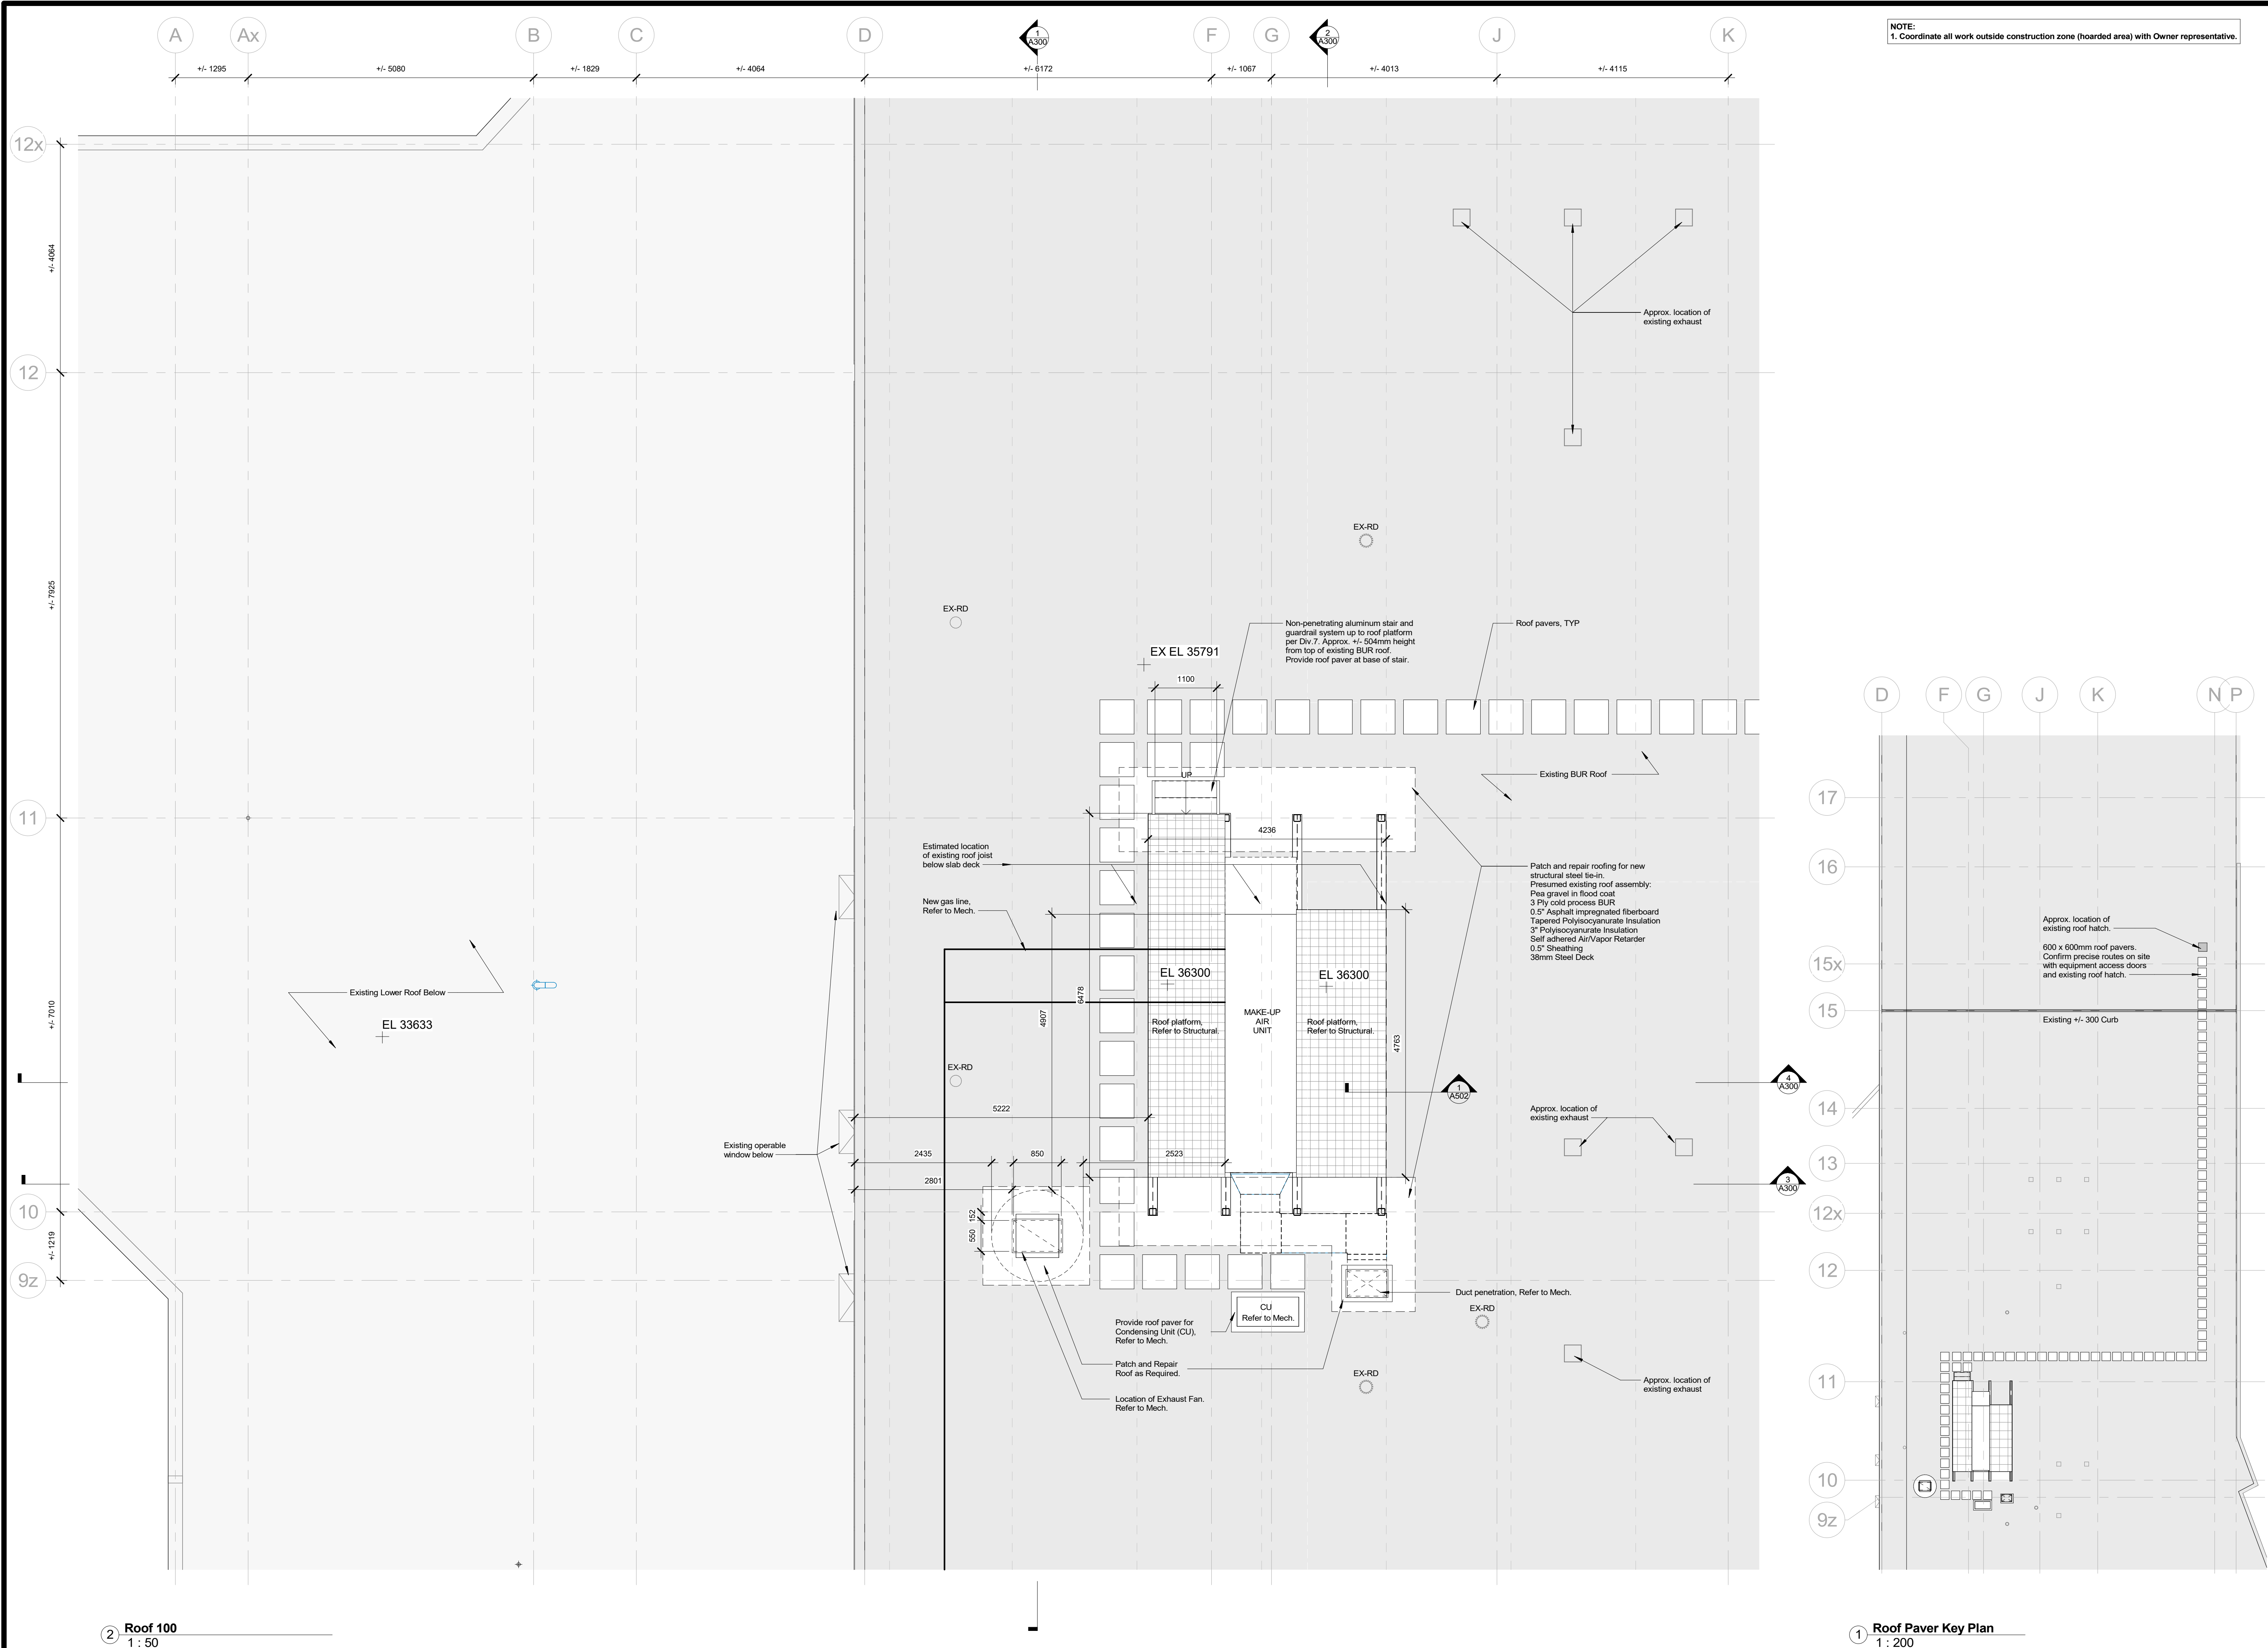






**GOW HASTINGS  
ARCHITECTS**

275 SPADINA ROAD  
TORONTO ONTARIO M5R 2V3  
416-920-0031  
GOWHASTINGS.COM

ALL DRAWINGS, SPECIFICATIONS, RELATED DOCUMENTS AND DESIGN ARE THE COPYRIGHT PROPERTY OF THE ARCHITECT AND MAY BE REPRODUCED OR TRANSMITTED IN ANY FORM OR BY ANY MEANS, ELECTRONIC OR MECHANICAL, INCLUDING PHOTOCOPYING, RECORDING, OR BY ANY INFORMATION STORAGE AND RETRIEVAL SYSTEM, WITHOUT THE ARCHITECT'S WRITTEN PERMISSION. THIS DRAWING SHALL NOT BE USED FOR CONSTRUCTION PURPOSES UNLESS COUNTERSIGNED.

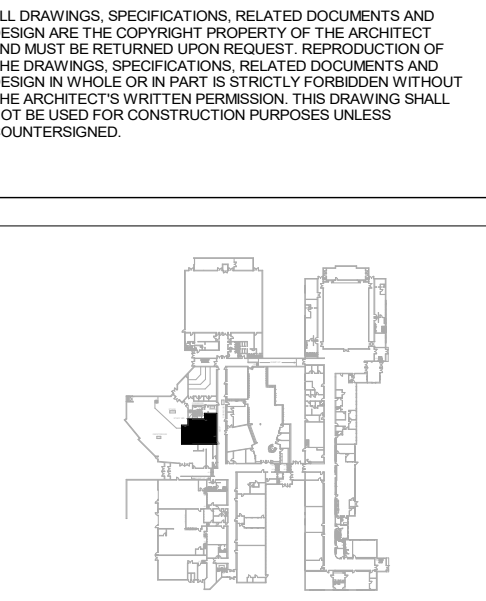

Key Plan

**RCP LEGEND**

GWB 2438 Ceiling Material  
Height above Finished Floor

Linear Pendant fixture - see electrical

Potlight - see electrical

Pendant - see electrical

Recessed lighting fixture - see electrical

Strip light fixture - see electrical

Transfer grille

Supply air diffuser

Overhead projector

2	Issued for Permit & Tender	10/31/2025
1	Issued for 90% CD - Client Review	10/09/2025
No.	ISSUED/REVISED	DATE

Henry St H.S.  
Culinary Classroom Renovation

600 Henry St, Whitby, ON L1N 1L4

**RCP - Level 1**


Scale: As indicated

Project Number: 25-102


Project North

Ontario Association of Architects

1 Reflected Ceiling Plan - Level 1  
1:50

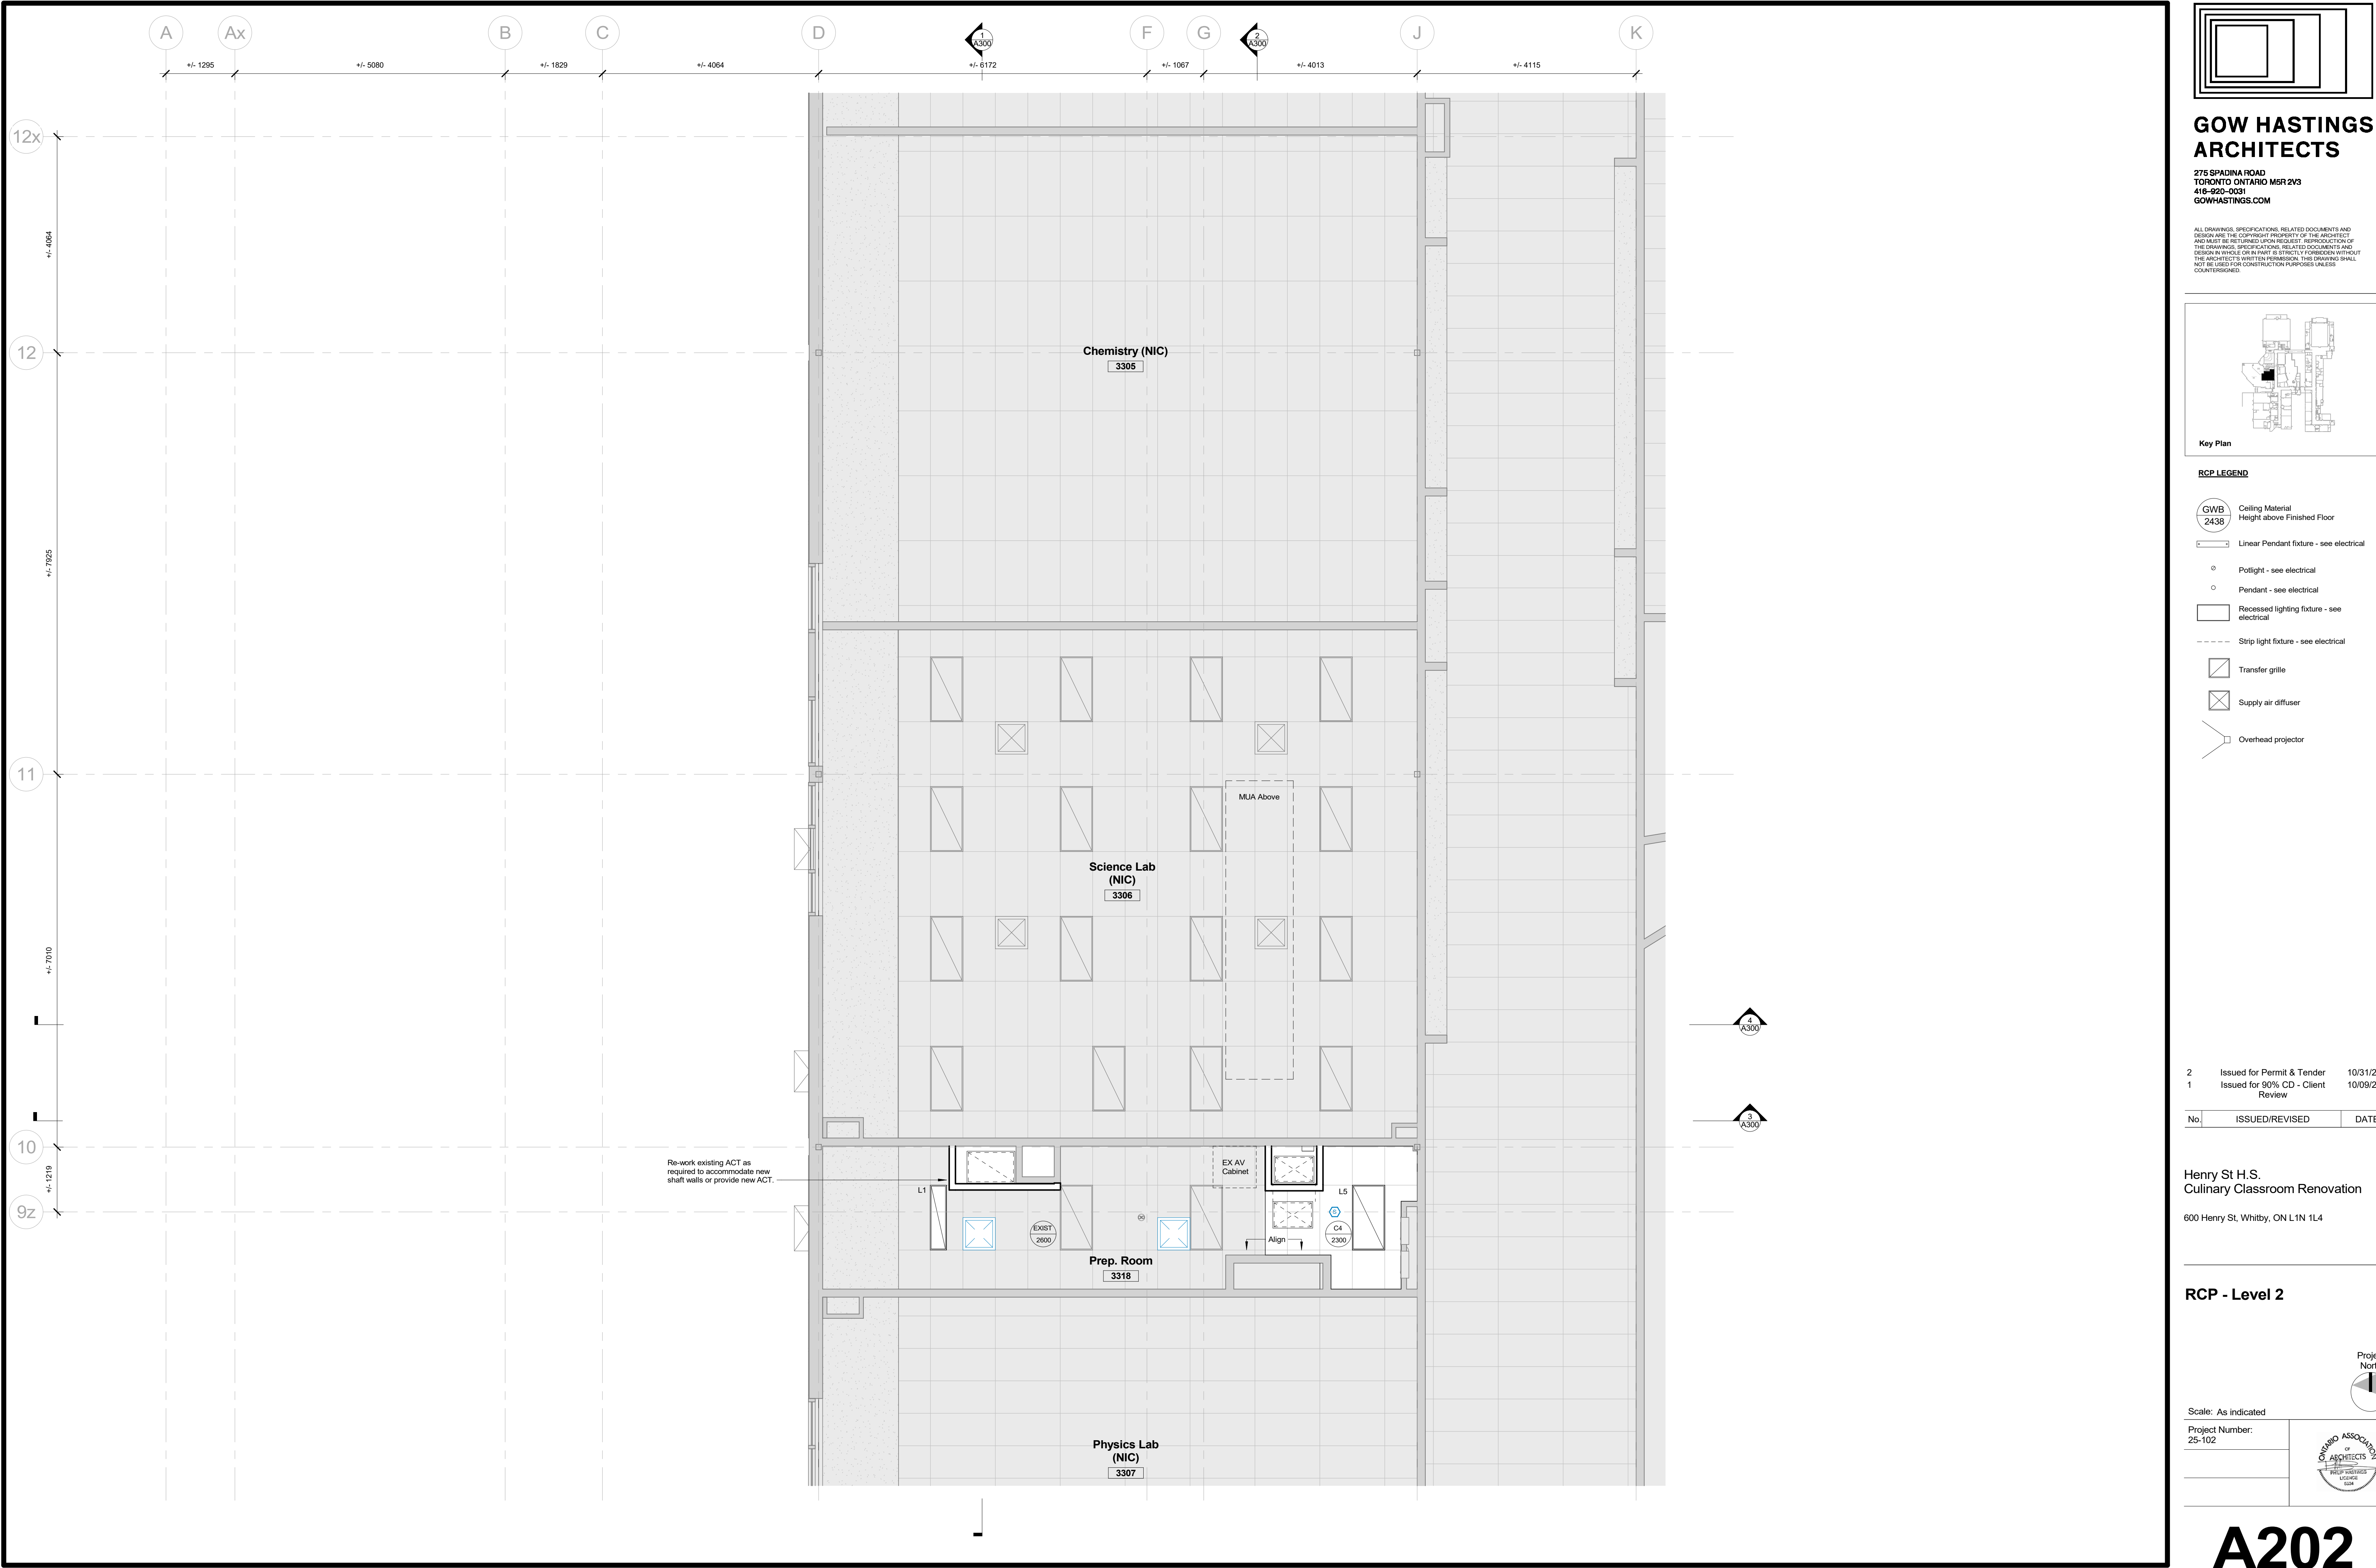


NOTE: This drawing is to be viewed in colour.

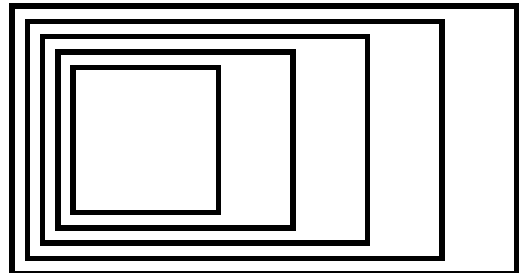


GOW HASTINGS  
ARCHITECTS

275 SPADINA ROAD  
TORONTO ONTARIO M5R 2Y3  
416-920-0031  
GOWHASTINGS.COM


ALL DRAWINGS, SPECIFICATIONS, RELATED DOCUMENTS AND DESIGN ARE THE COPYRIGHT PROPERTY OF THE ARCHITECT AND MAY BE RE-USED UPON REQUEST. REPRODUCTION OF THE DRAWINGS, SPECIFICATIONS, RELATED DOCUMENTS AND DESIGN IN WHOLE OR IN PART IS STRICTLY FORBIDDEN WITHOUT THE ARCHITECT'S WRITTEN PERMISSION. THIS DRAWING SHALL NOT BE USED FOR CONSTRUCTION PURPOSES UNLESS COUNTERSIGNED.

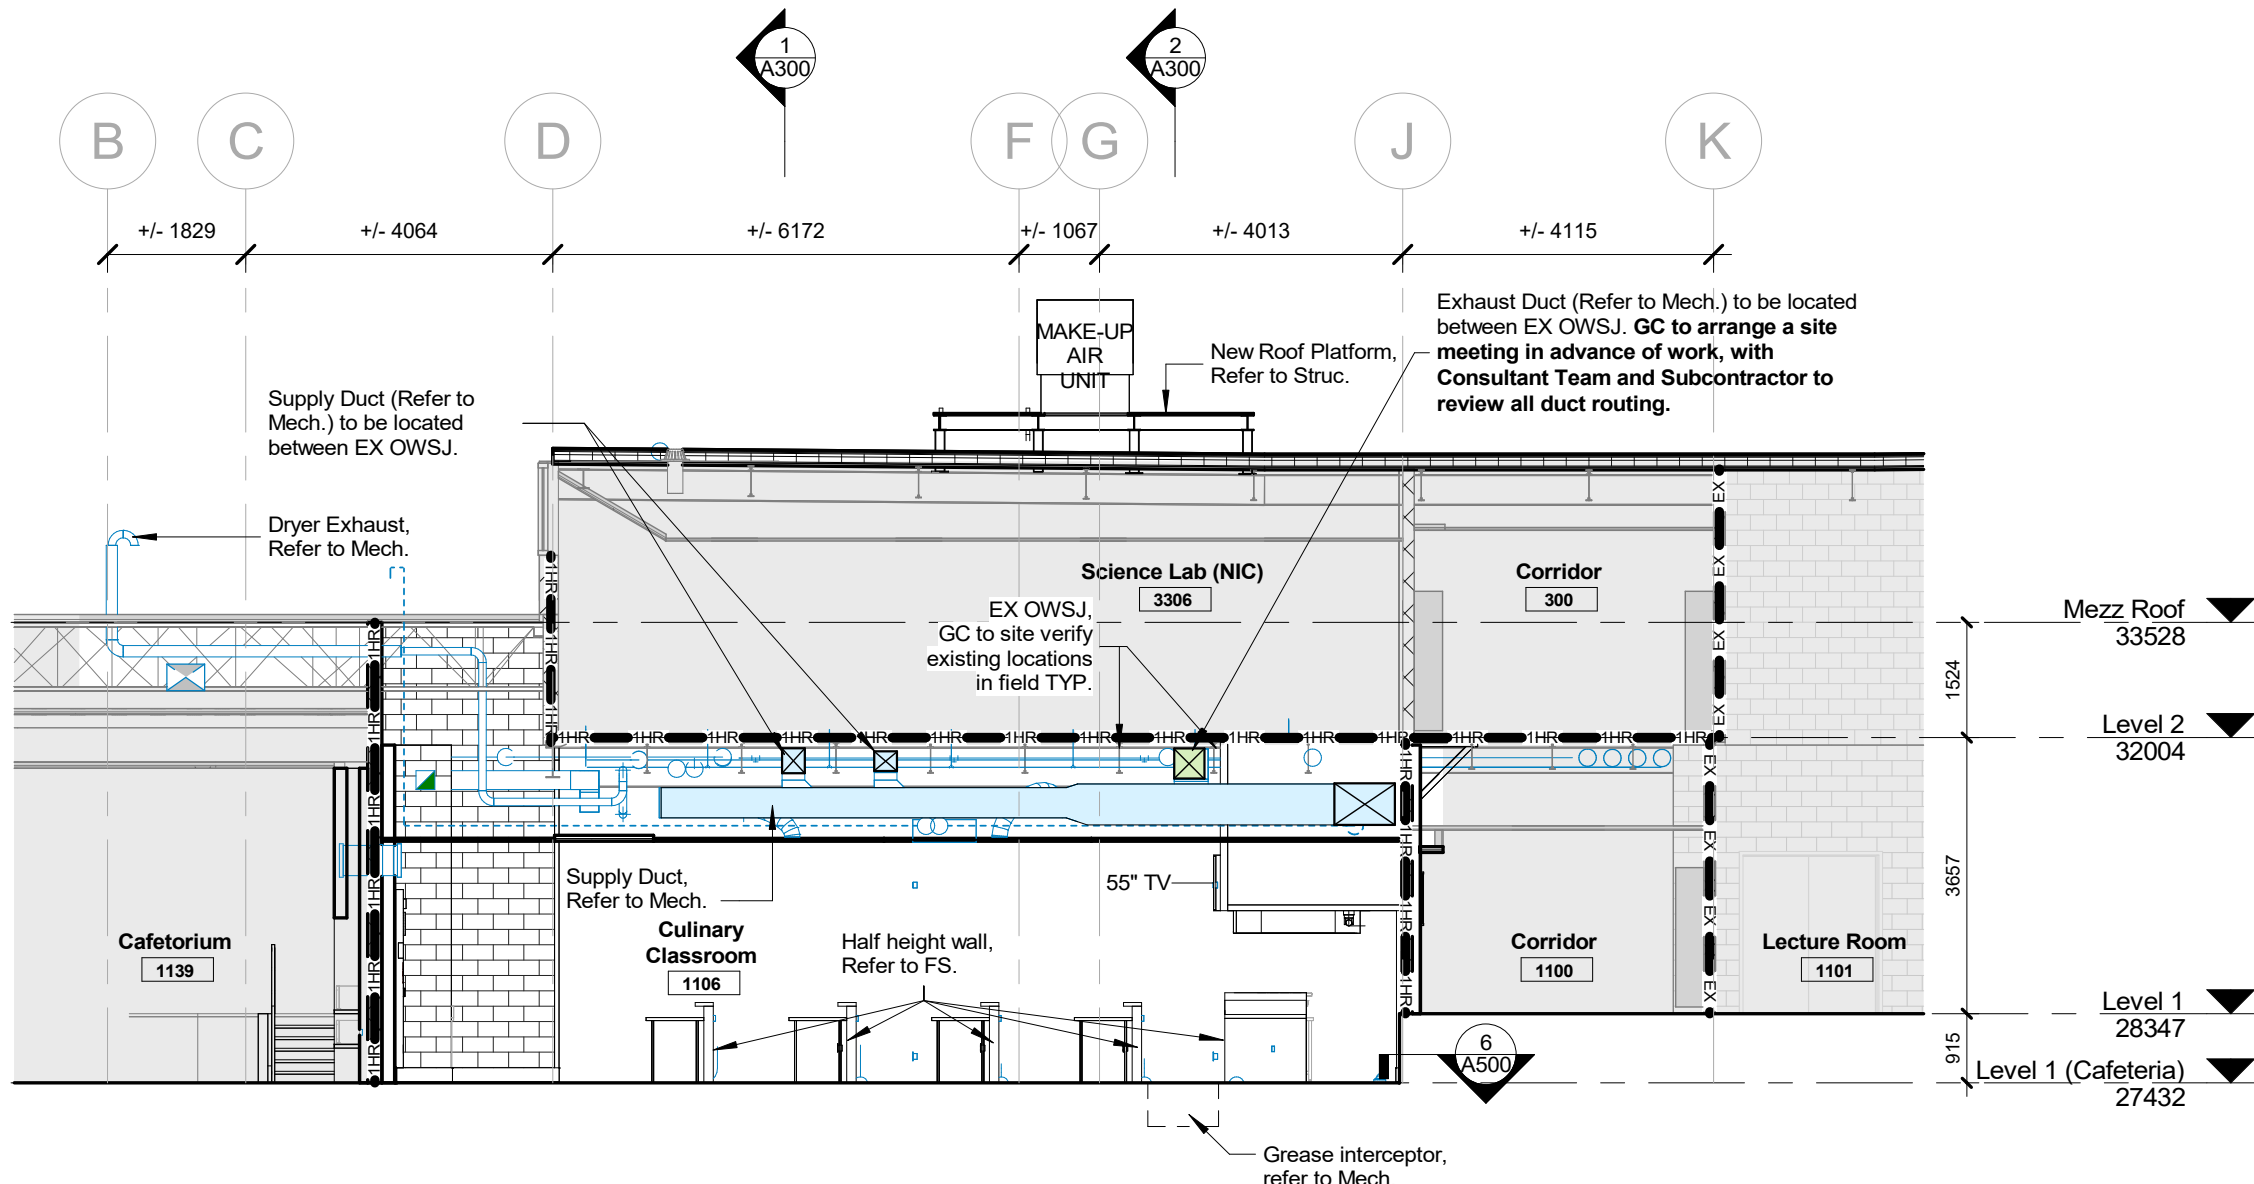


4 Building Section - East/West @ Supply Air Duct  
1 : 100

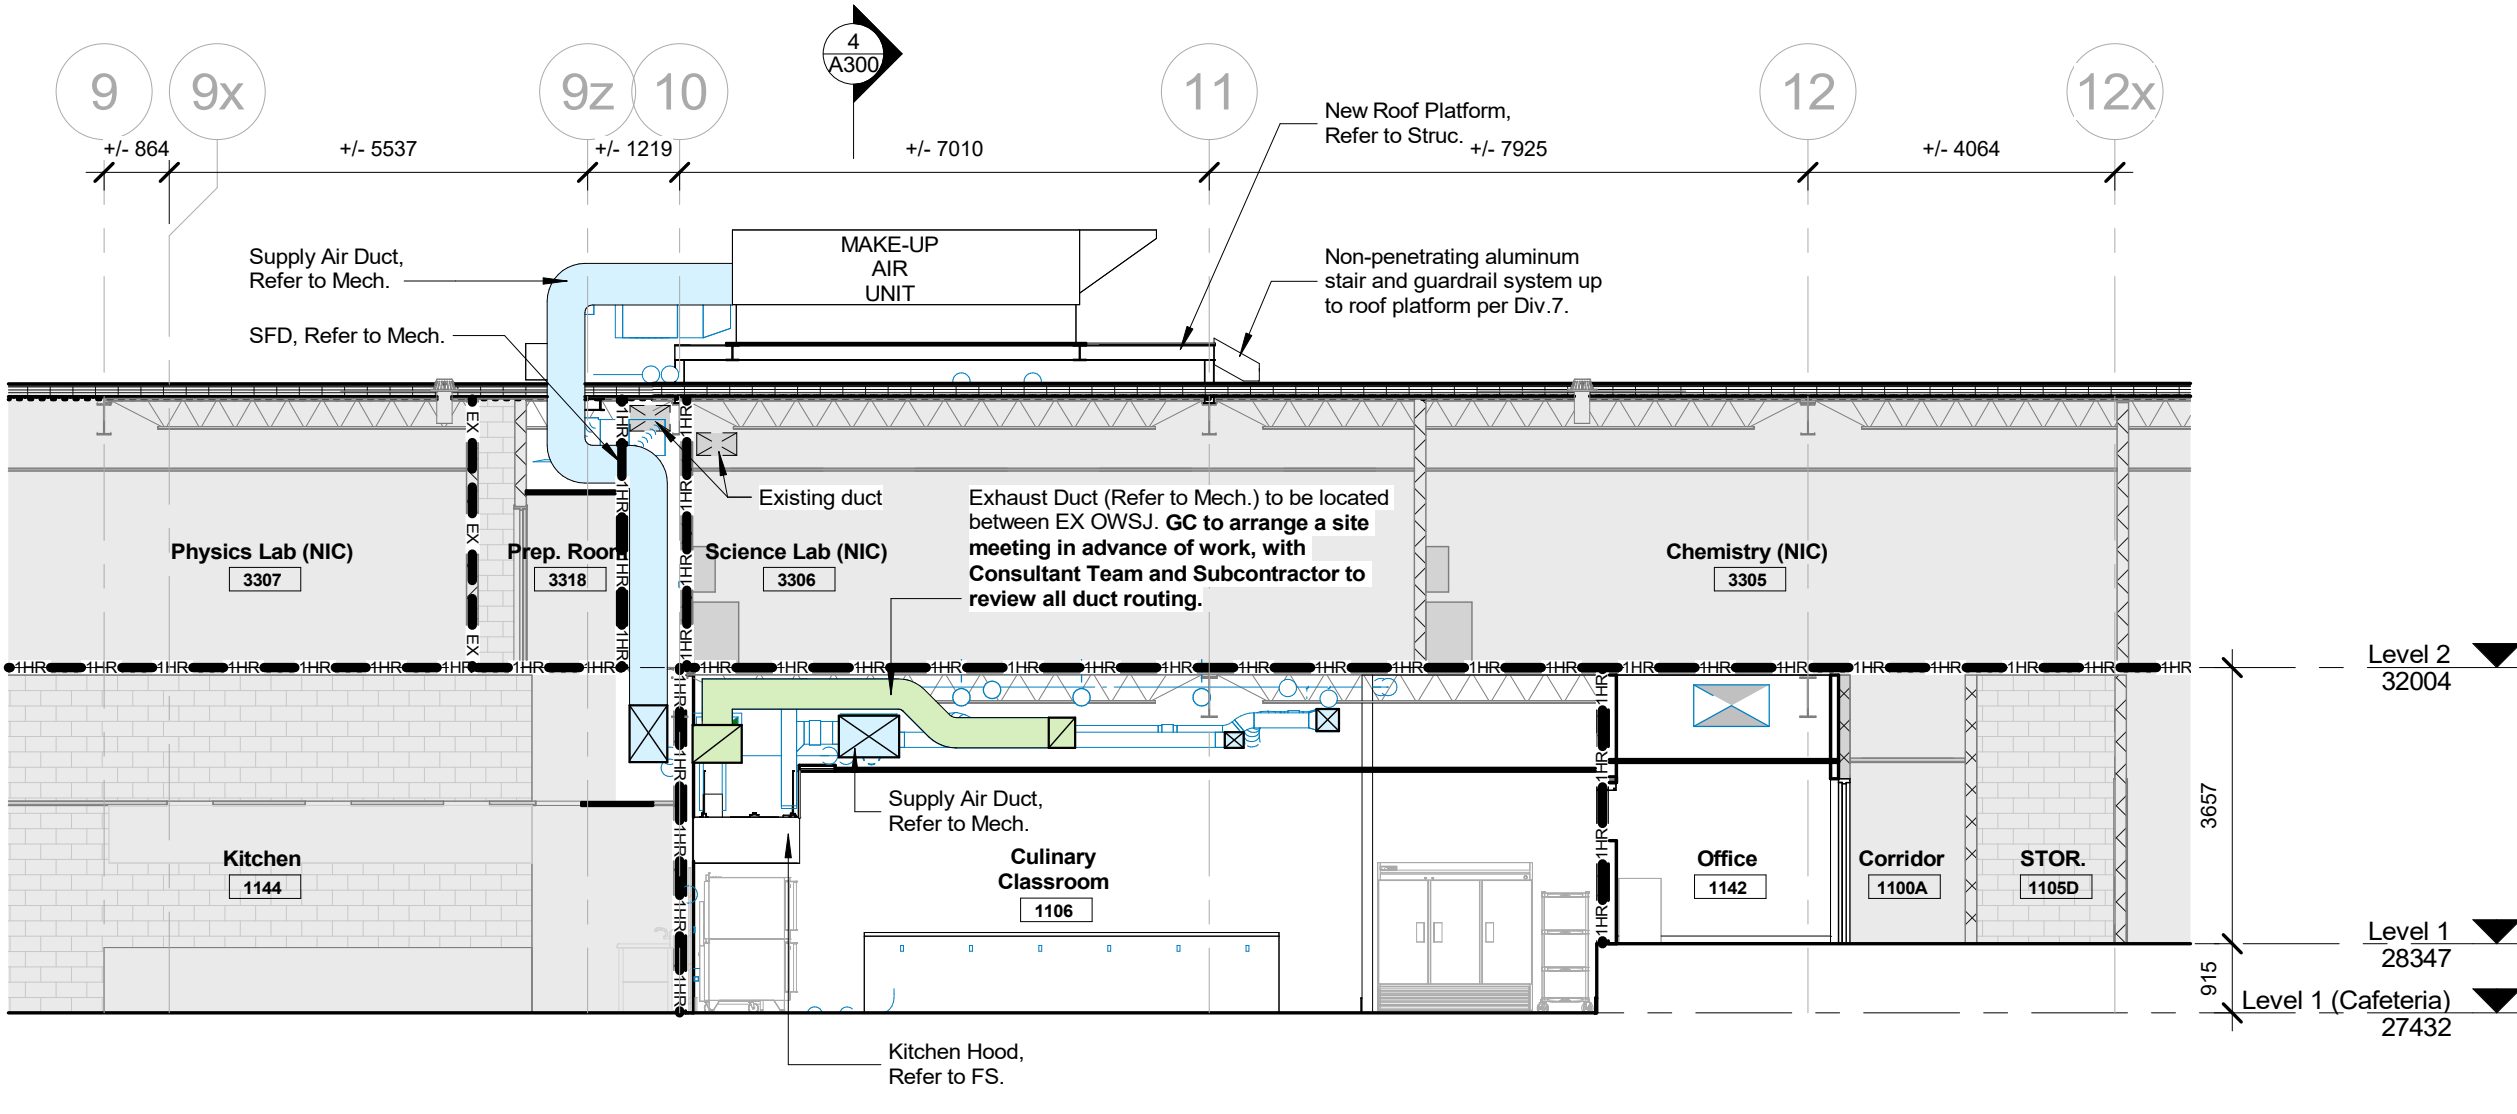

2 Building Section - North/South @ Supply Air Duct to MUA Unit  
1 : 100

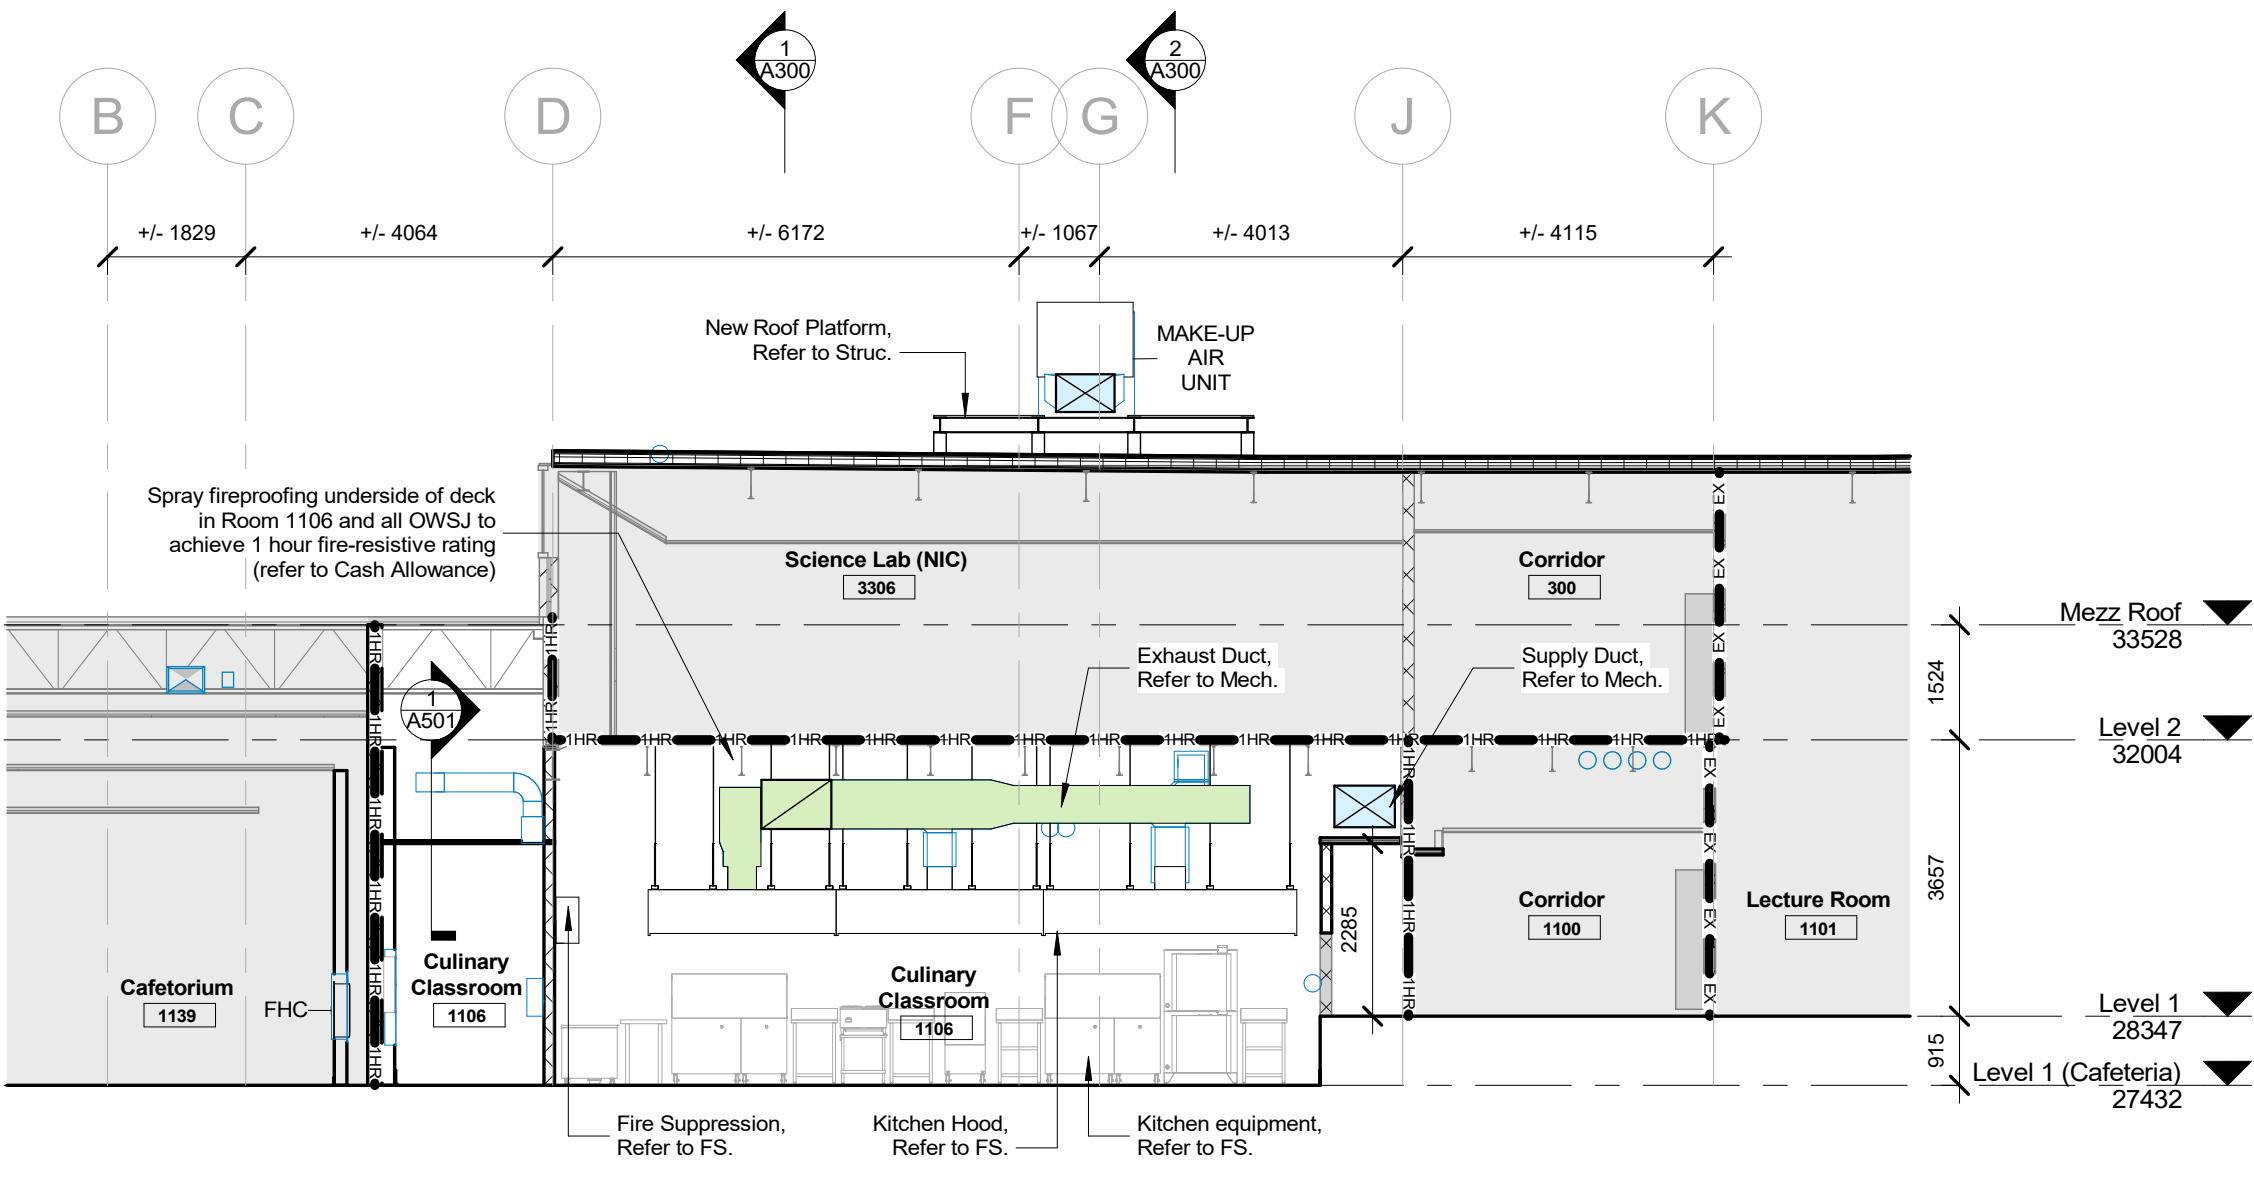

3 Building Section - East/West @ Exhaust Duct  
1 : 100

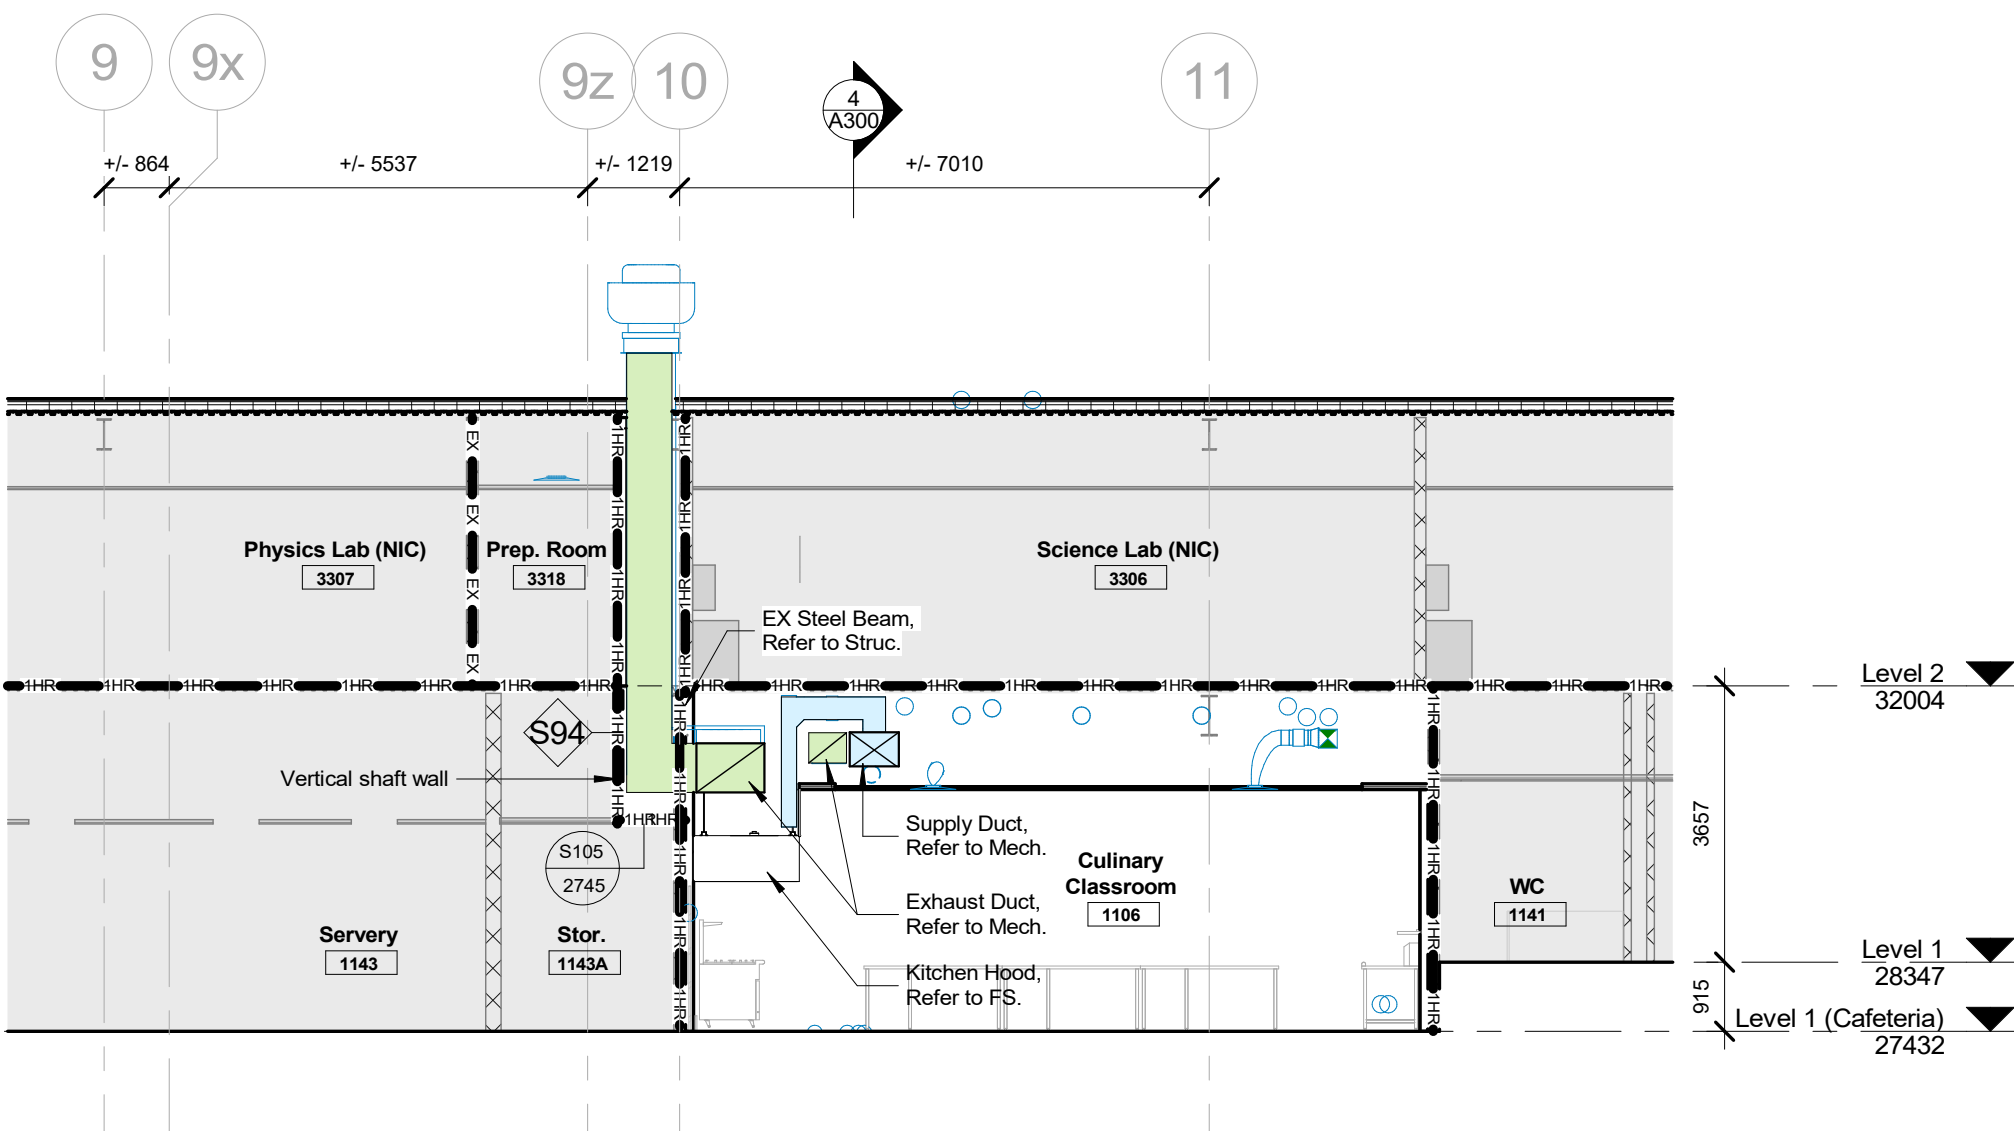

1 Building Section - North/South @ Exhaust Duct  
1 : 100

2 Issued for Permit & Tender 10/31/2025  
1 Issued for 90% CD - Client Review 10/09/2025

No. ISSUED/REVISED DATE

Henry St H.S.  
Culinary Classroom Renovation

600 Henry St, Whitby, ON L1N 1L4


Building Sections

Scale: 1 : 100

Project Number:  
25-102



A300

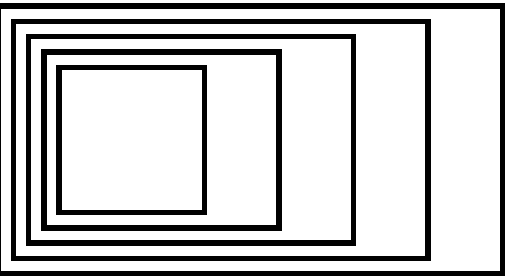

GOW HASTINGS  
ARCHITECTS

275 SPADINA ROAD  
TORONTO ONTARIO M5R 2Y3  
416-920-0031  
GOWHASTINGS.COM

ALL DRAWINGS, SPECIFICATIONS, RELATED DOCUMENTS AND DESIGN ARE THE COPYRIGHT PROPERTY OF THE ARCHITECT AND MAY BE RETURNED UPON REQUEST. REPRODUCTION OF THE DRAWINGS, SPECIFICATIONS, RELATED DOCUMENTS AND DESIGN IN WHOLE OR IN PART IS STRICTLY FORBIDDEN WITHOUT THE ARCHITECT'S WRITTEN PERMISSION. THIS DRAWING SHALL NOT BE USED FOR CONSTRUCTION PURPOSES UNLESS COUNTERSIGNED.

WALL MATERIAL LEGEND

- Brick
- Concrete
- CMU
- Glass
- Ceramic Tile
- Wood
- Existing element to remain

Note: Pattern is to show extent only and does not represent the actual layout.

CER1 - 2x8 Ceramic Tile  
HWP1 - Hygienic Wall Panel  
HWP2 - Hygienic Wall Panel  
HWP3 - Hygienic Wall Panel  
HWP4 - Hygienic Wall Panel  
HWP5 - Hygienic Wall Panel  
HWP6 - Hygienic Wall Panel  
PT - Paint

Surface Film  
FLM2 - Transparent coloured film  
FLM3 - Transparent coloured film  
FLM4 - Transparent coloured film  
FLM5 - Vinyl wallpaper  
FLM6 - Vinyl wallpaper

Floor Base  
SF1 - Safety Flooring Cove Base  
RB - Rubber Base

2 Issued for Permit & Tender 10/31/2025  
1 Issued for 90% CD - Client Review 10/09/2025

No. ISSUED/REVISED DATE

Henry St H.S.  
Culinary Classroom Renovation


600 Henry St, Whitby, ON L1N 1L4

Interior Elevations


Scale: As indicated  
Project Number:  
25-102




A400

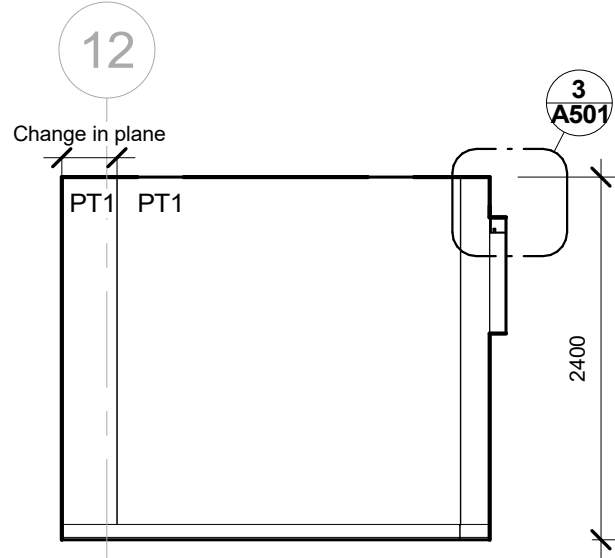


12 Interior Elevation - Office 1142 - East  
1 : 50

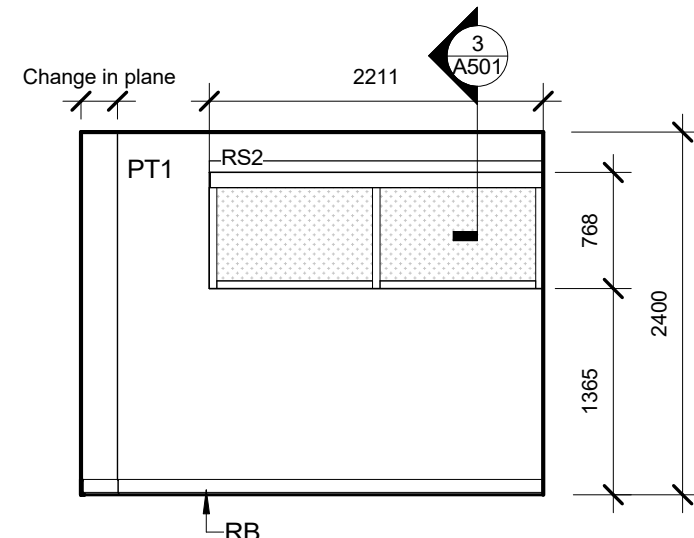


11 Interior Elevation - Office 1142 - South  
1 : 50

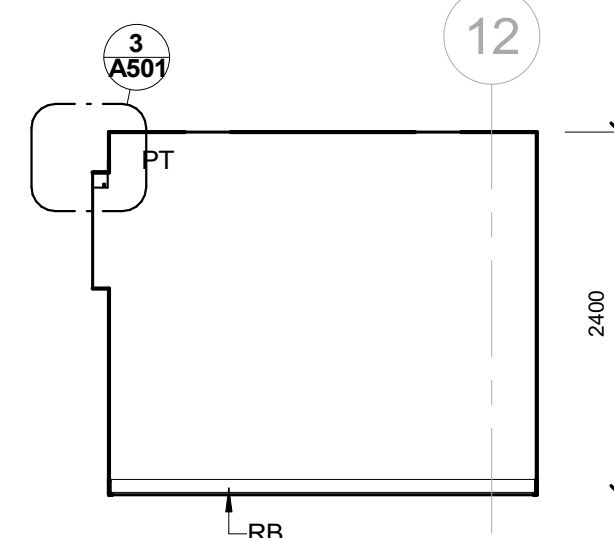


10 Interior Elevation - Office 1142 - West  
1 : 50

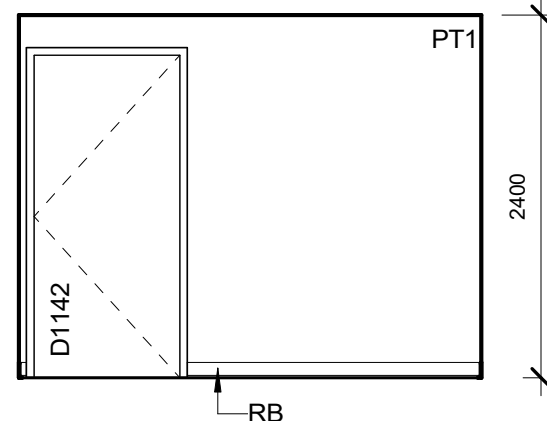


9 Interior Elevation - Office 1142 - North  
1 : 50

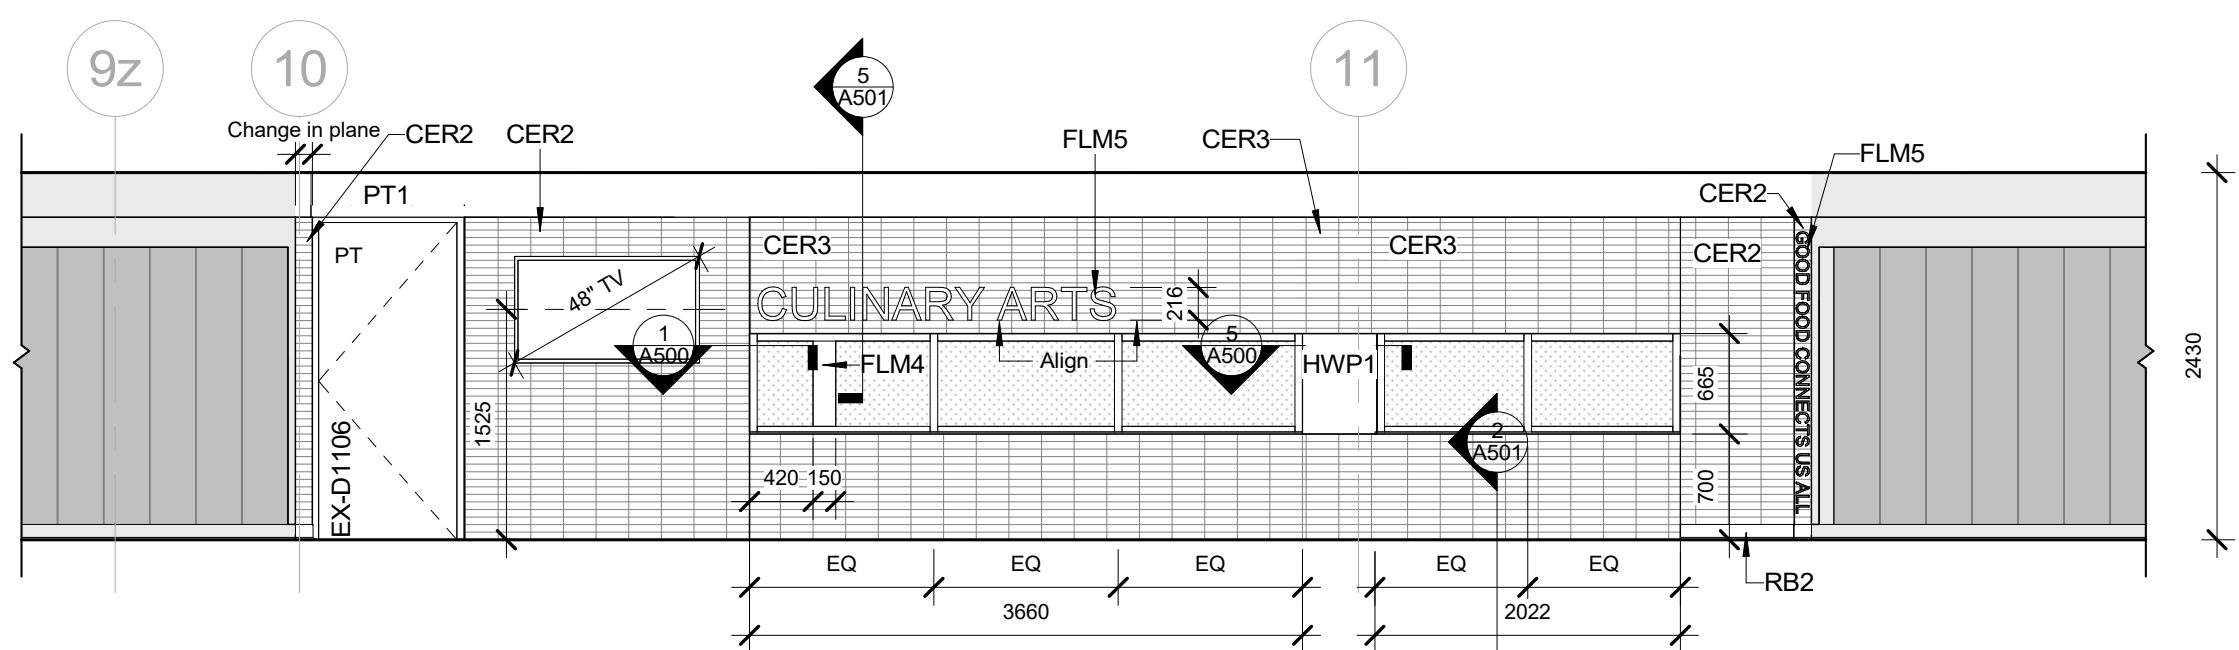


8 Interior Elevation - Corridor 1100 - West  
1 : 50

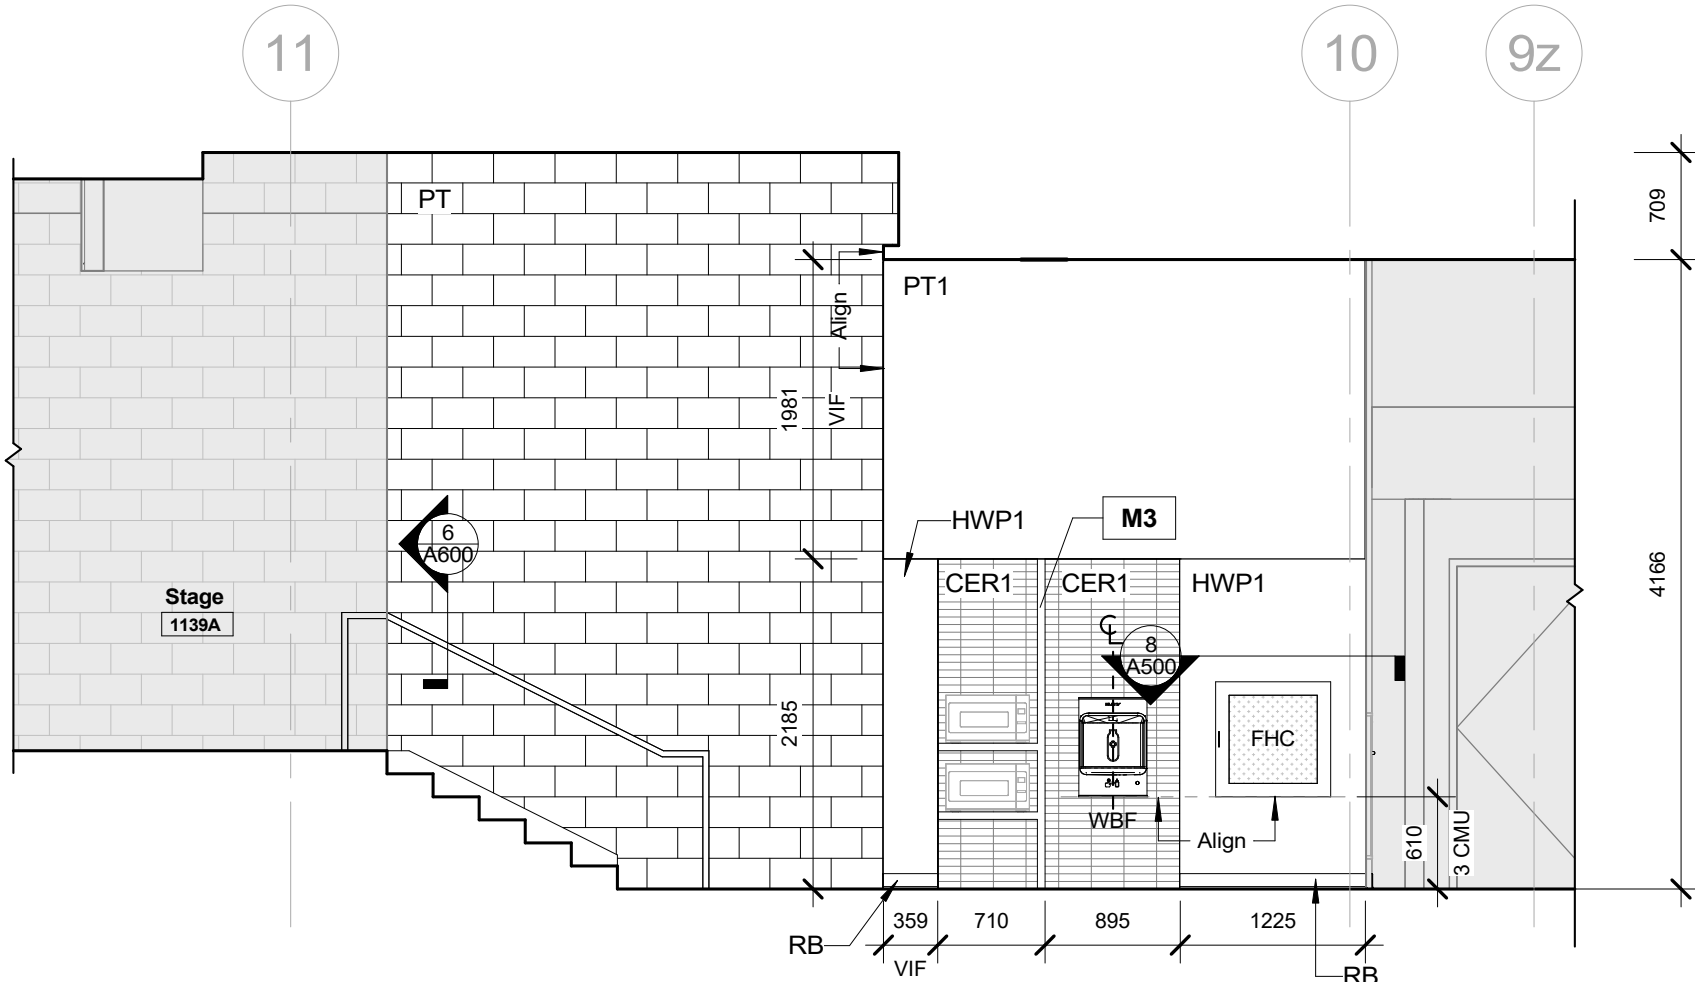


7 Interior Elevation - Cafetorium 1139 - East  
1 : 50

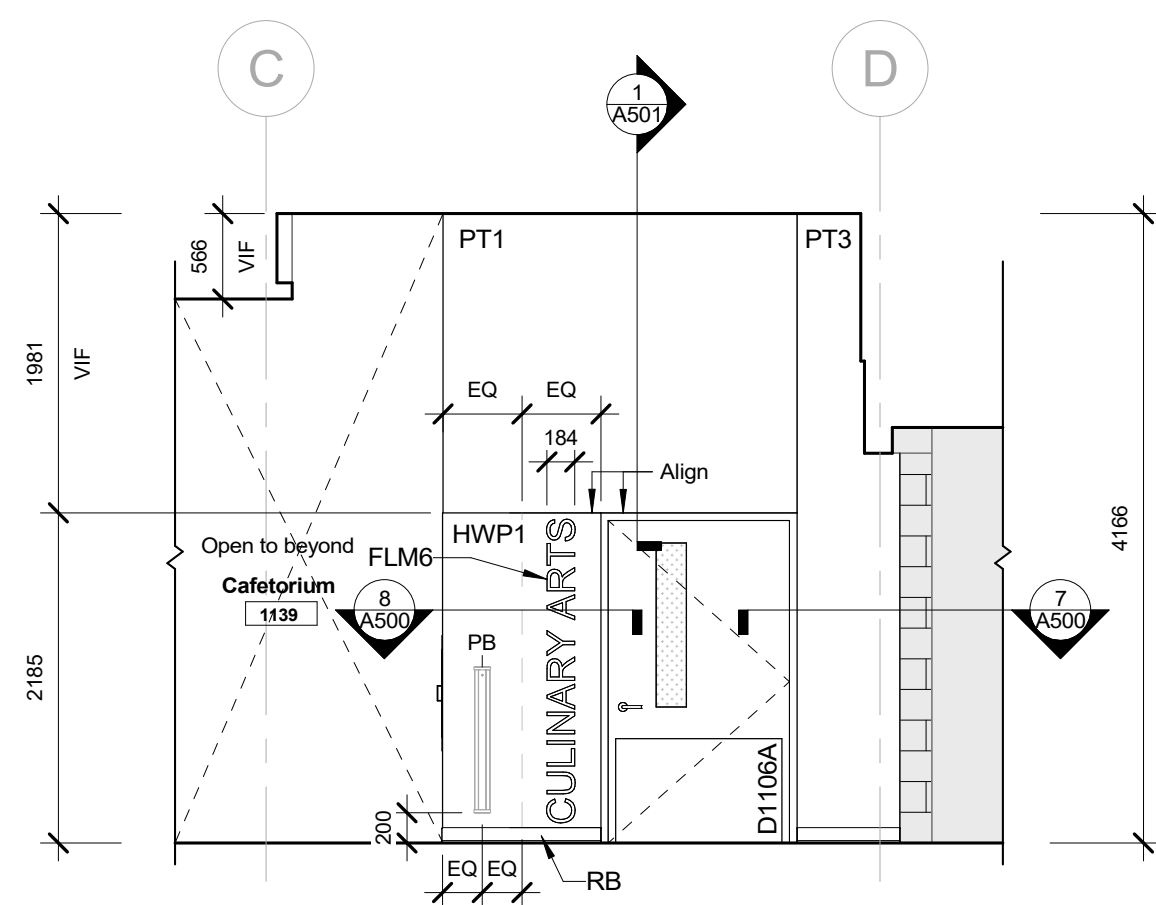


6 Interior Elevation - Cafetorium 1139 - North  
1 : 50

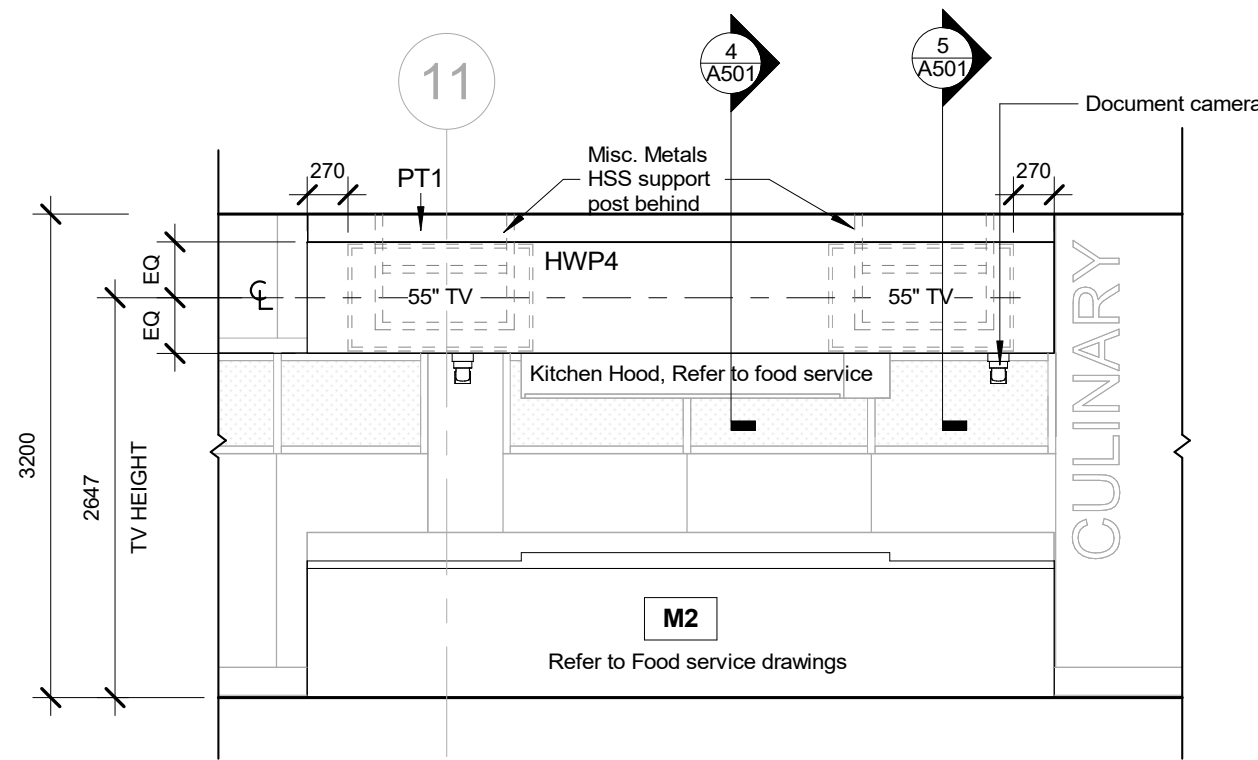


5 Interior Elevation - Classroom 1108 - East - Demo Station  
1 : 50

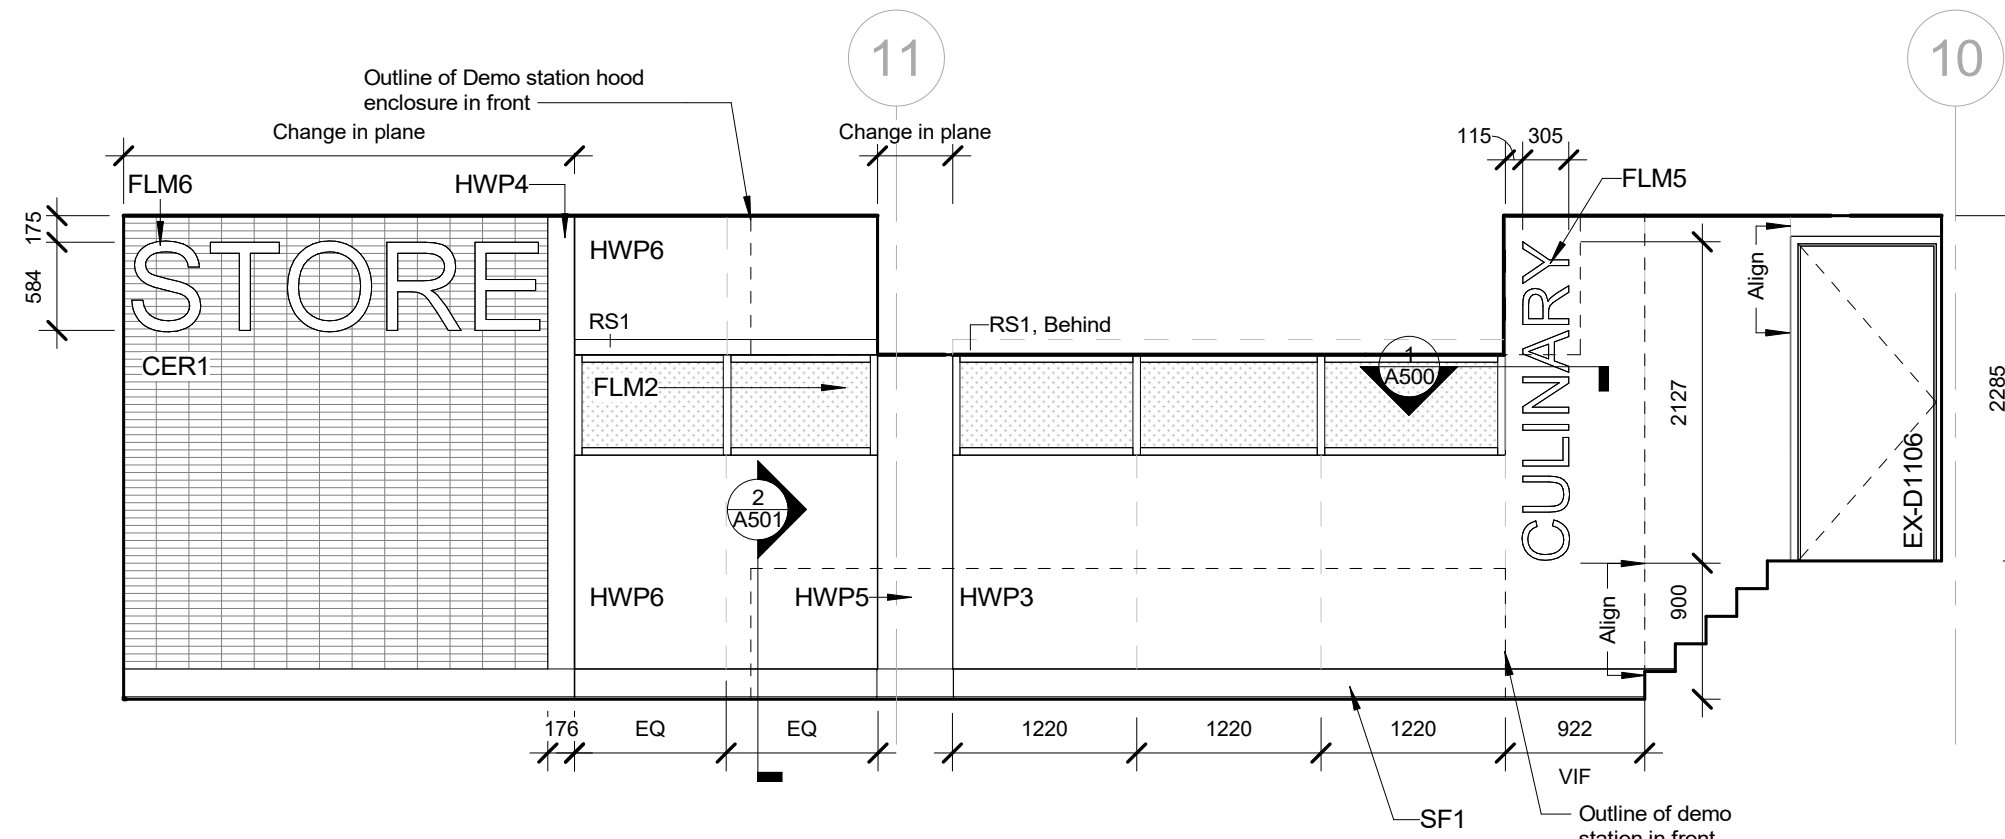


4 Interior Elevation - Classroom 1108 - East  
1 : 50

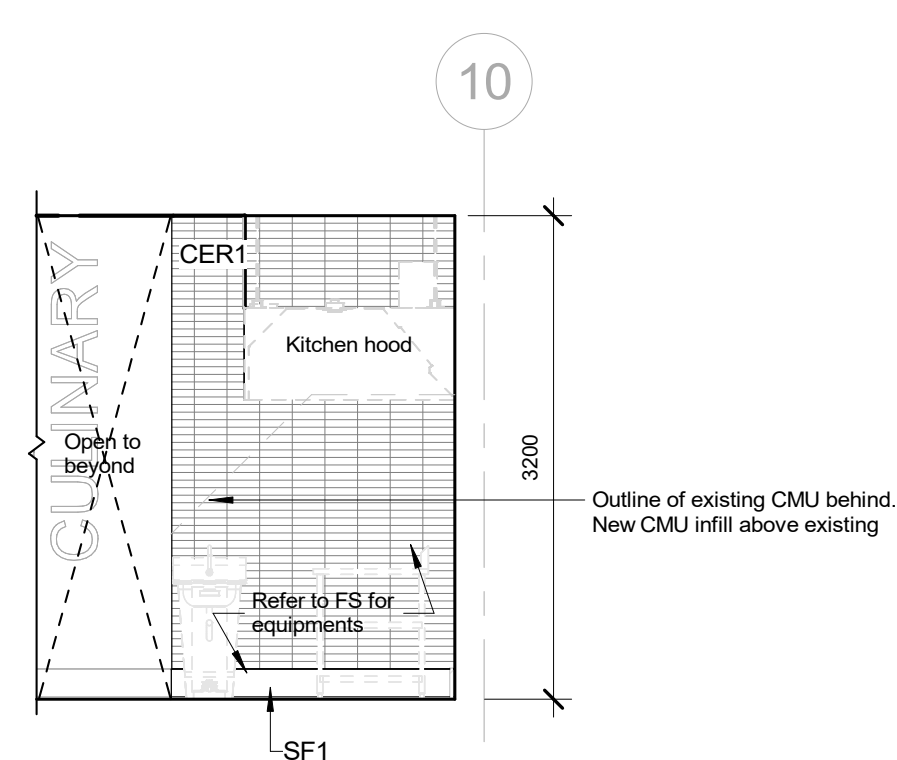


13 Interior Elevation - Classroom 1108 - East Nib Wall  
1 : 50

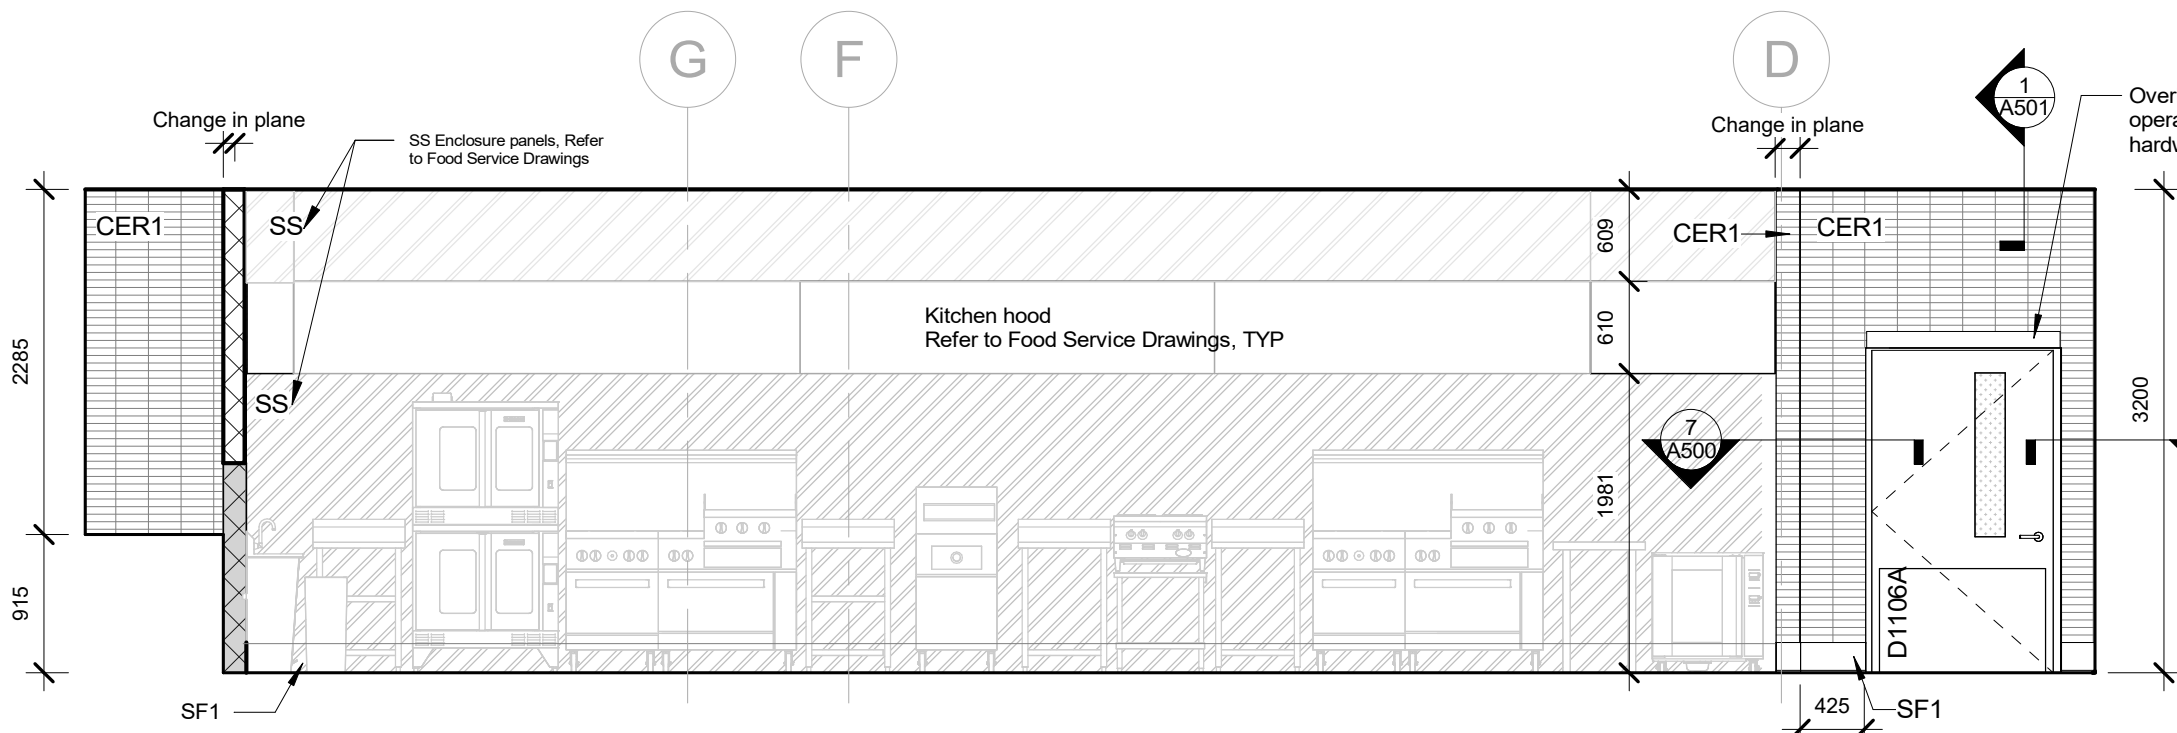


3 Interior Elevation - Classroom 1108 - South  
1 : 50

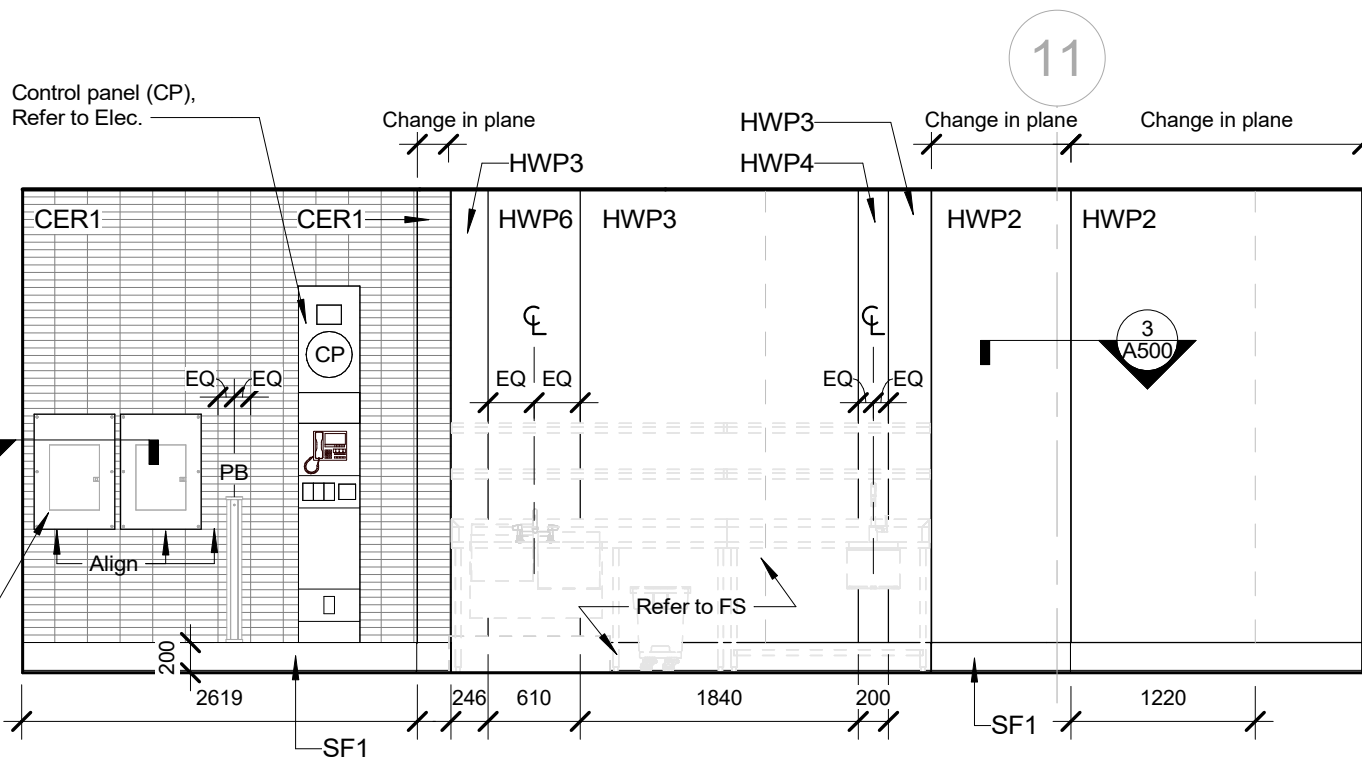

2 Interior Elevation - Classroom 1108 - West  
1 : 50

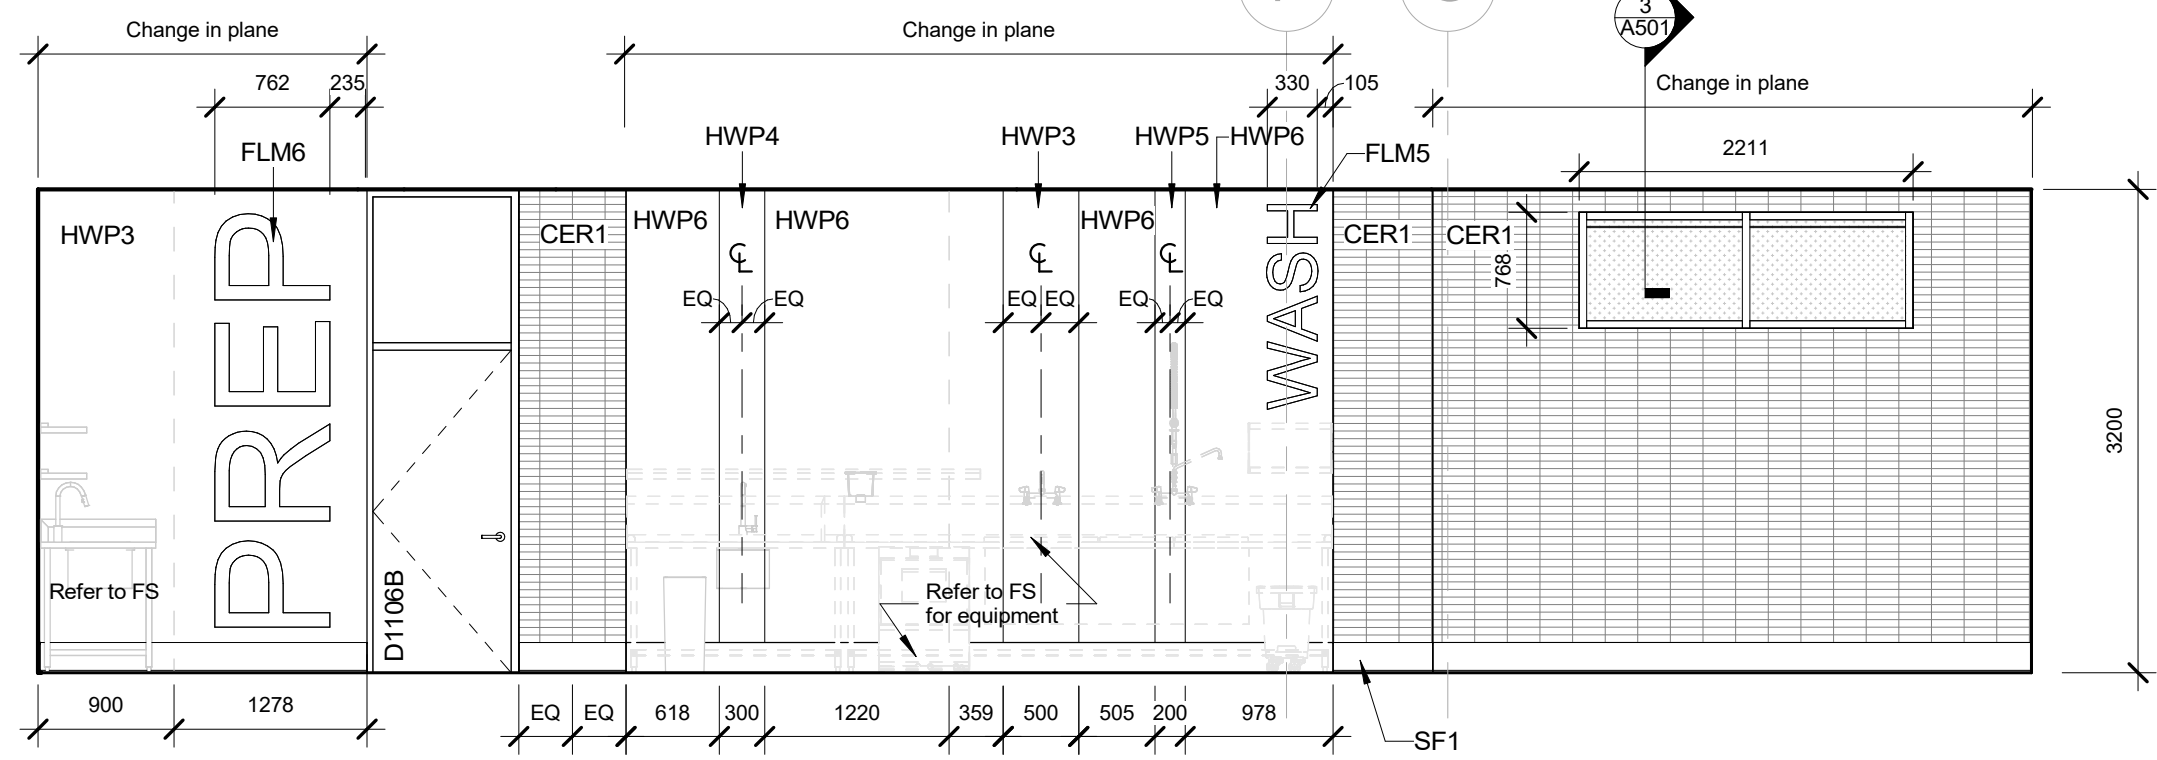


1 Interior Elevation - Classroom 1108 - North  
1 : 50

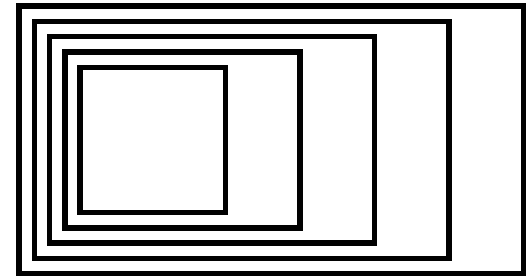


GOW HASTINGS  
ARCHITECTS

275 SPADINA ROAD  
TORONTO ONTARIO M5R 2Y3  
416-920-0031  
GOWHASTINGS.COM


ALL DRAWINGS, SPECIFICATIONS, RELATED DOCUMENTS AND DESIGN ARE THE COPYRIGHT PROPERTY OF THE ARCHITECT AND MAY BE RE-USED UPON REQUEST. REPRODUCTION OF THE DRAWINGS, SPECIFICATIONS, RELATED DOCUMENTS AND DESIGN IN WHOLE OR IN PART IS STRICTLY FORBIDDEN WITHOUT THE ARCHITECT'S WRITTEN PERMISSION. THIS DRAWING SHALL NOT BE USED FOR CONSTRUCTION PURPOSES UNLESS COUNTERSIGNED.

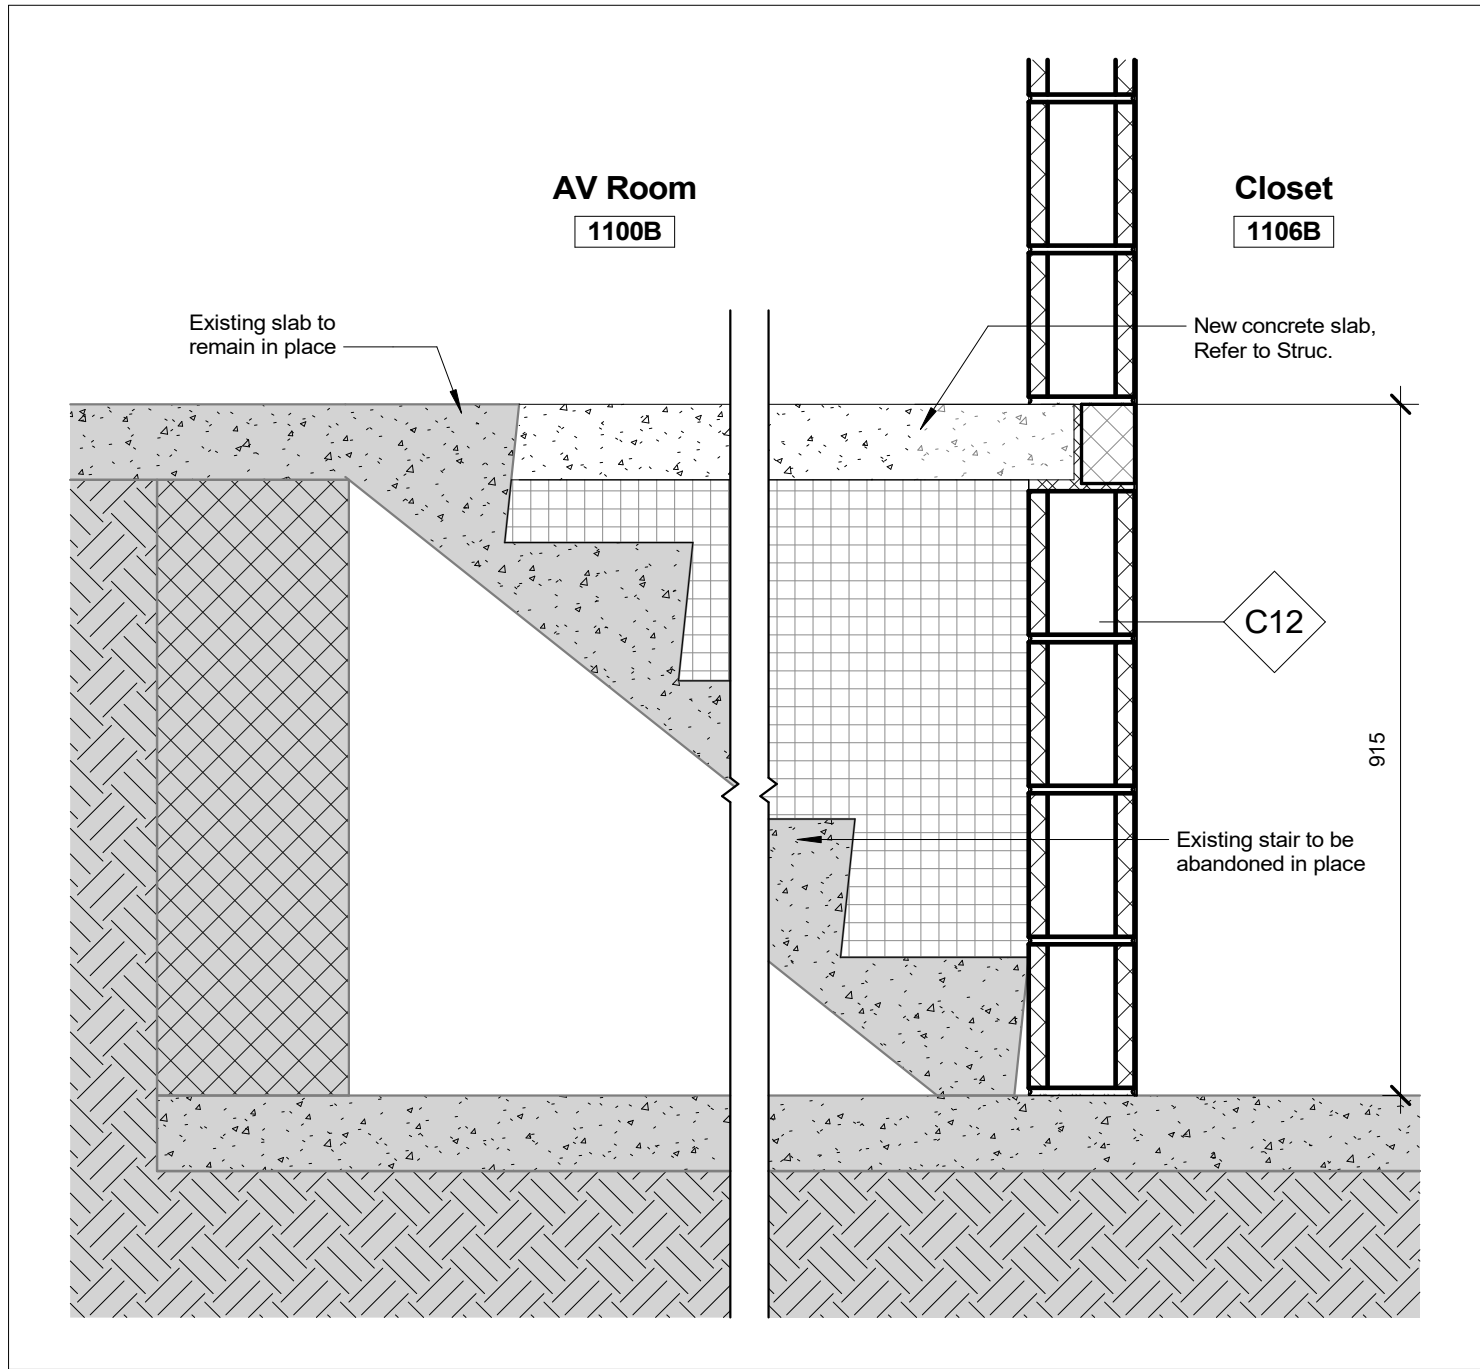


9 Section Detail - Existing Stair Infill @ AV Rm 1100B  
1 : 10

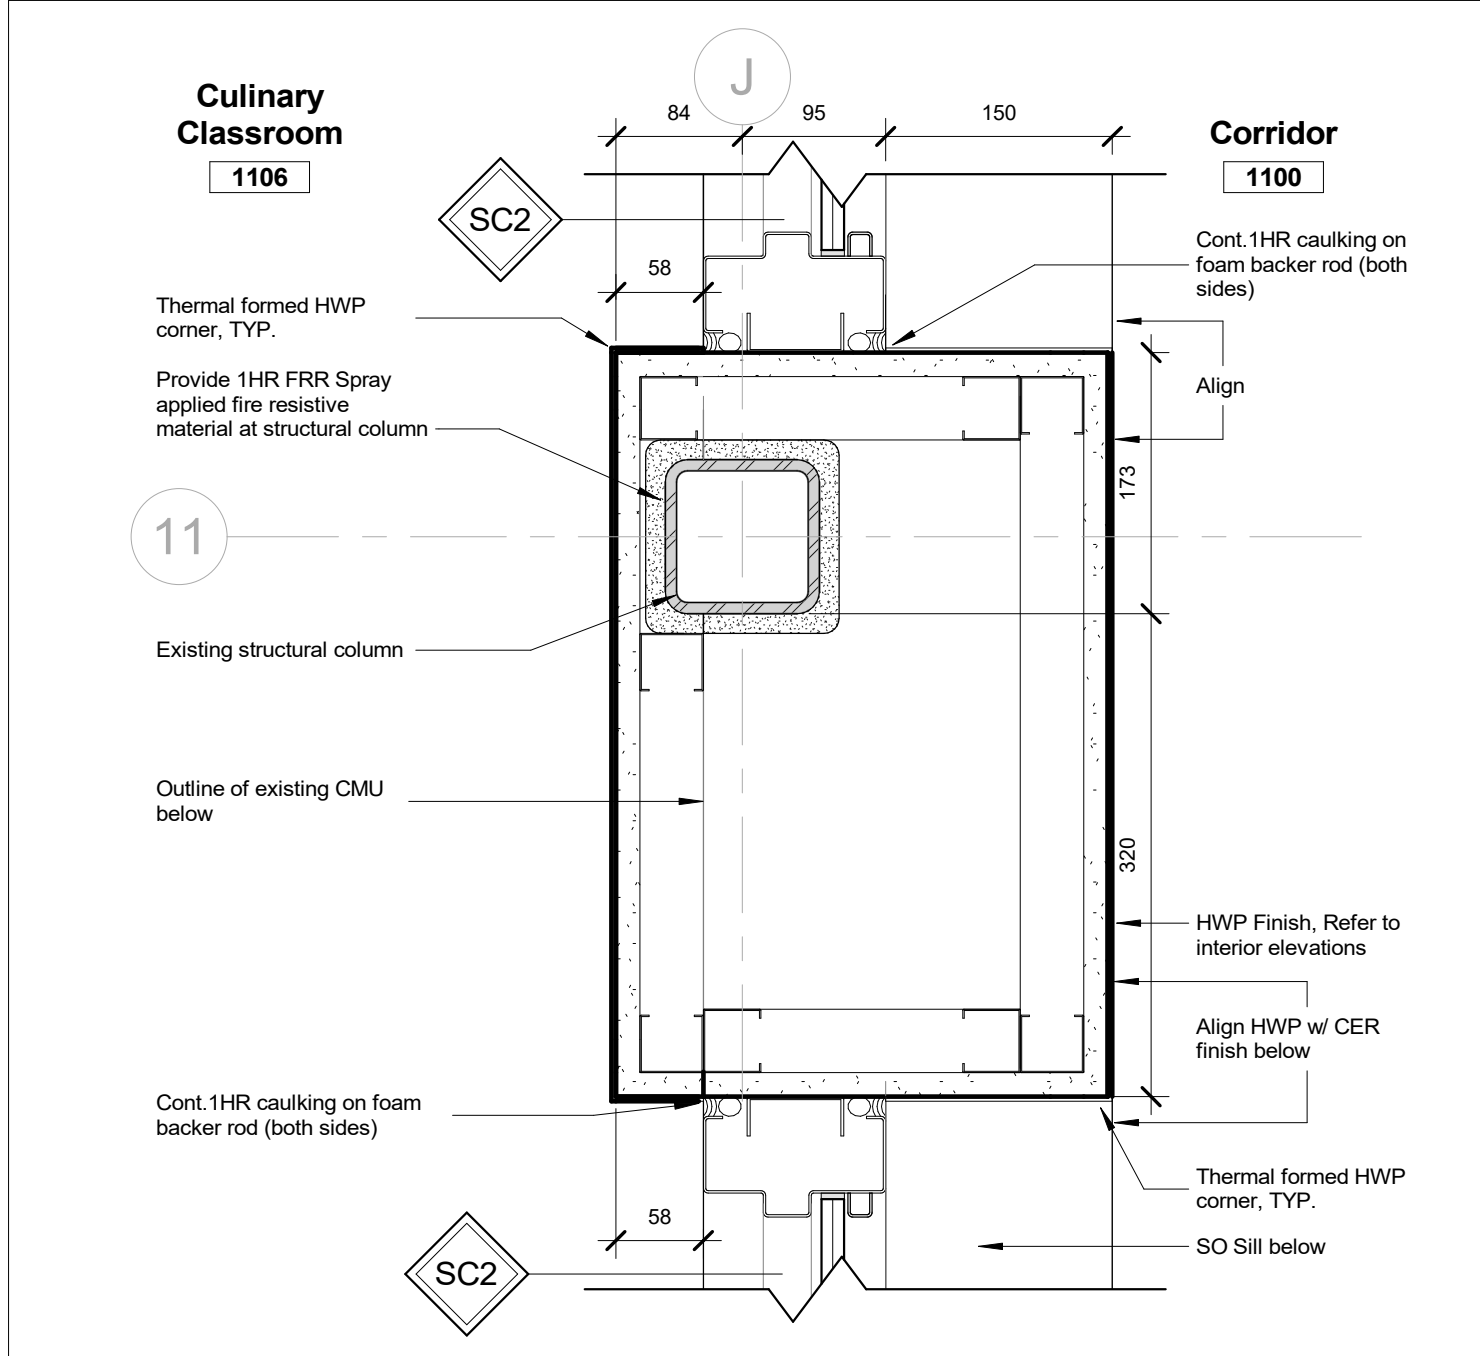


5 Plan Detail - Level 1 - Column @ J11  
1 : 5

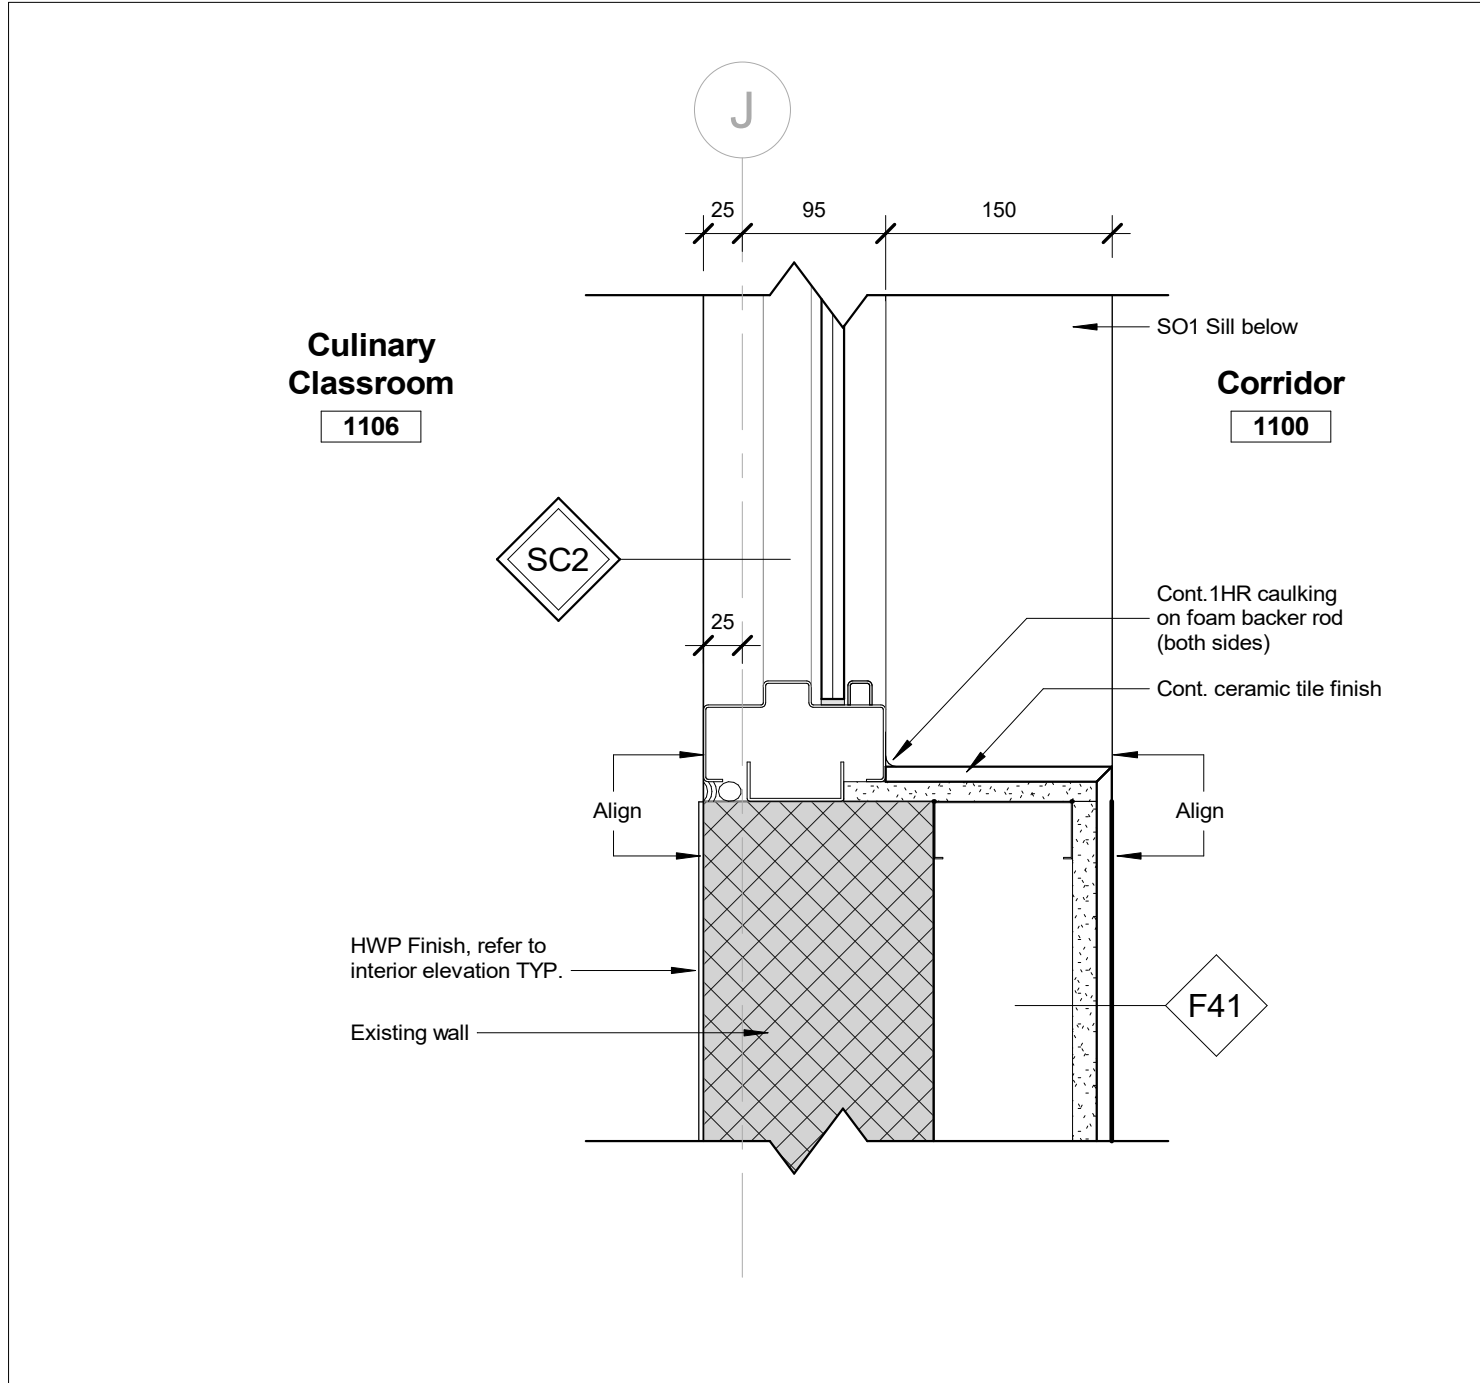

1 Plan Detail - CMU to SC1  
1 : 5

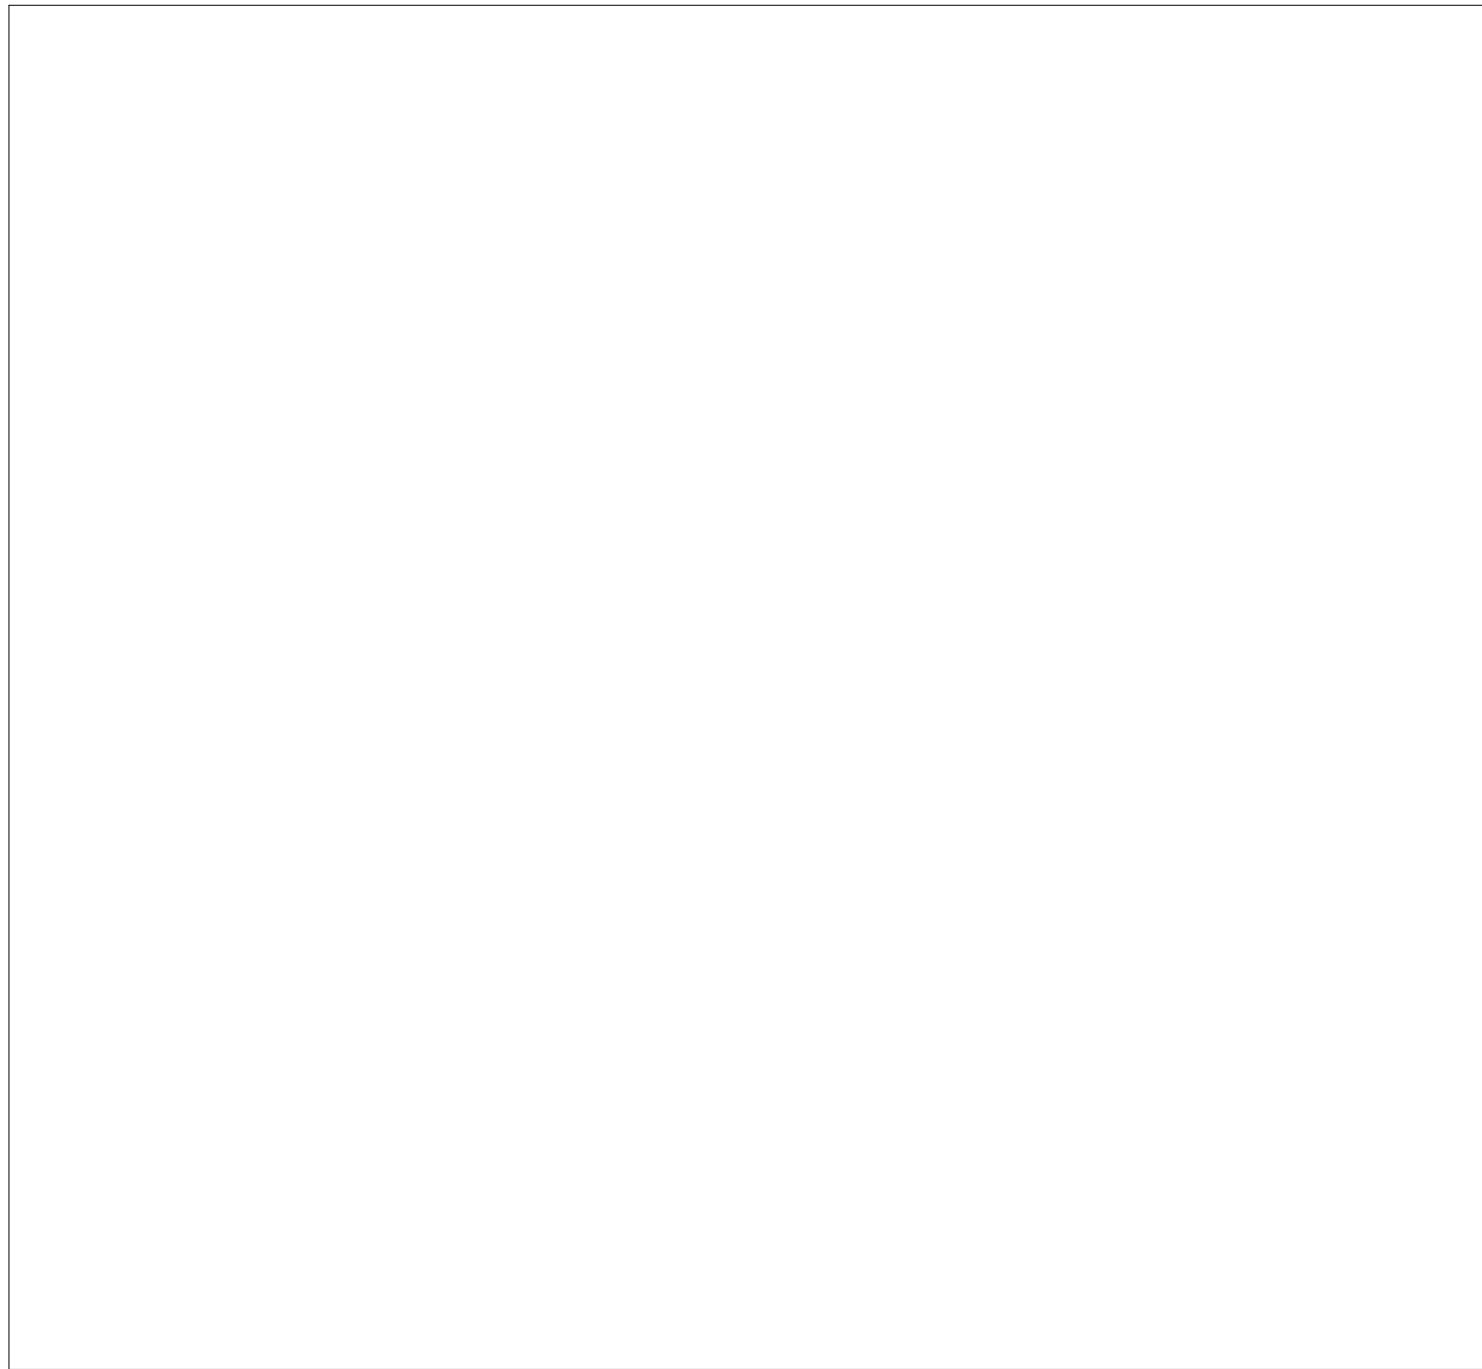


RESERVED

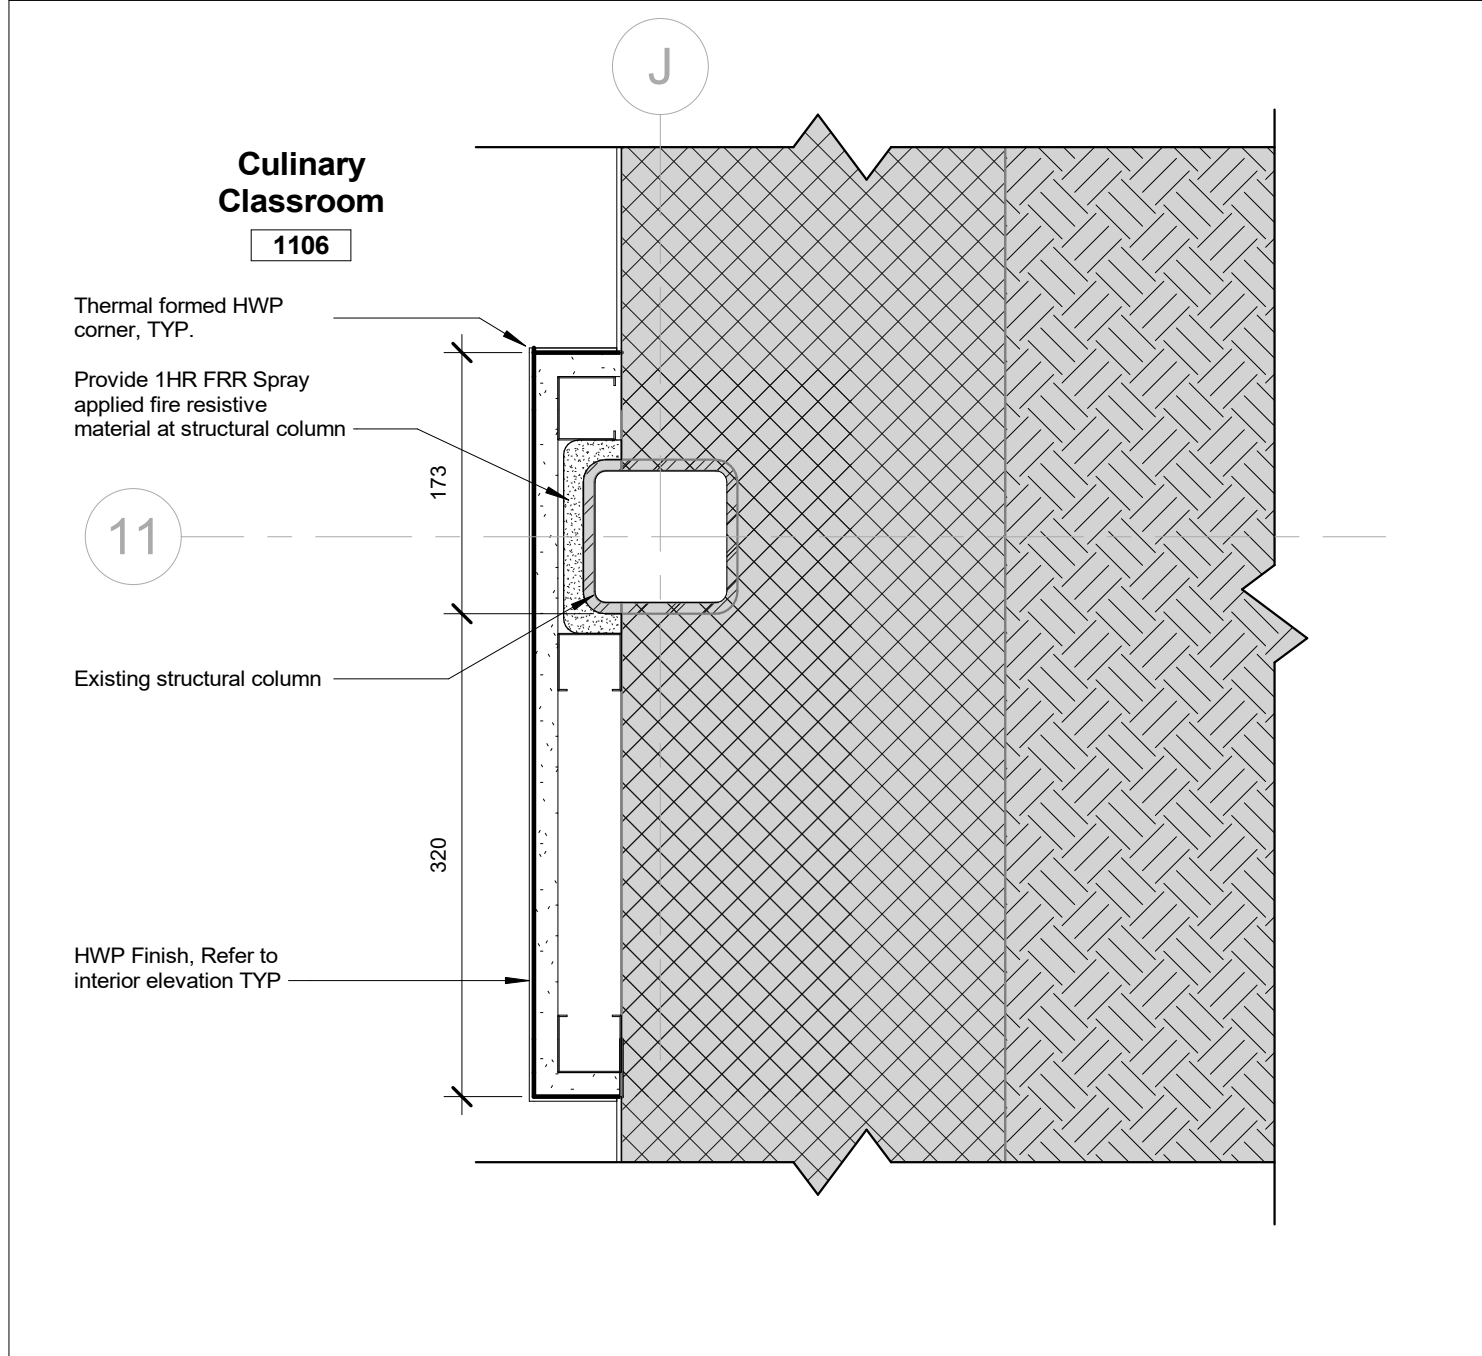


6 Plan Detail - Grade Level - Column @ J11  
1 : 5




RESERVED

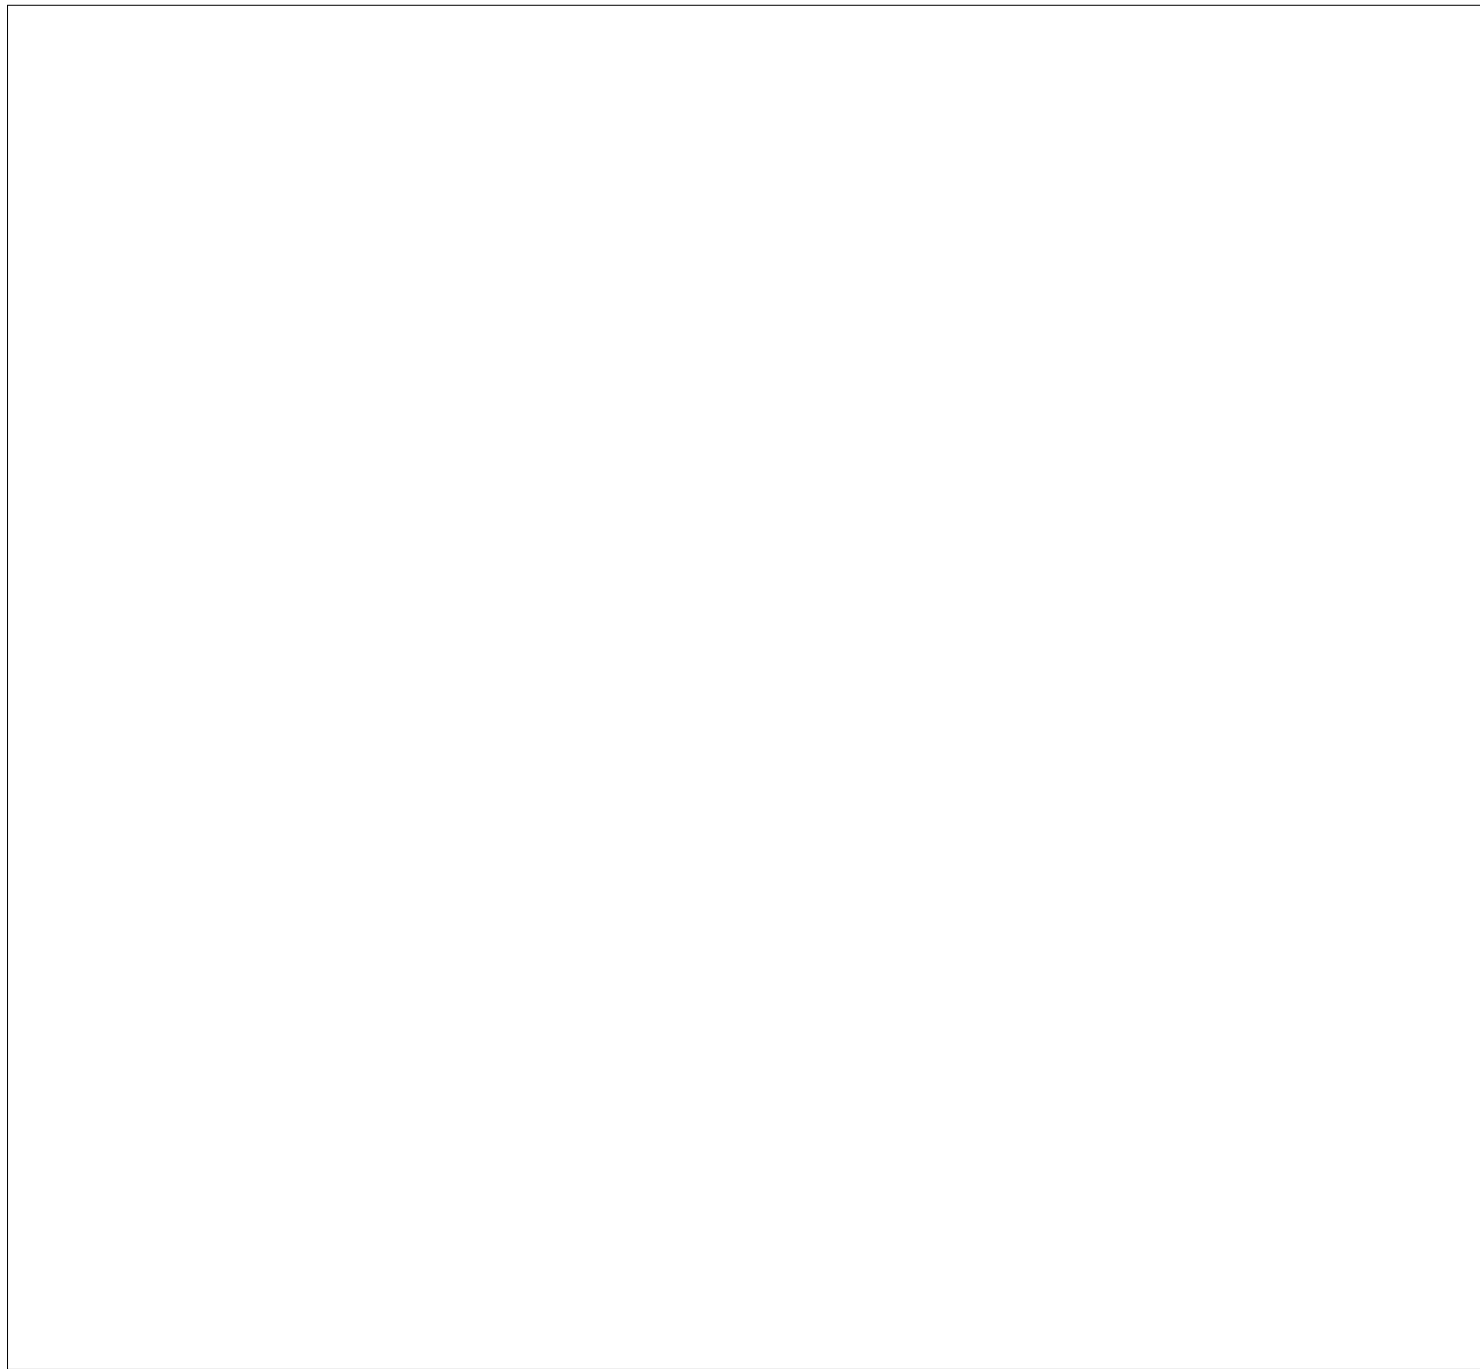


RESERVED

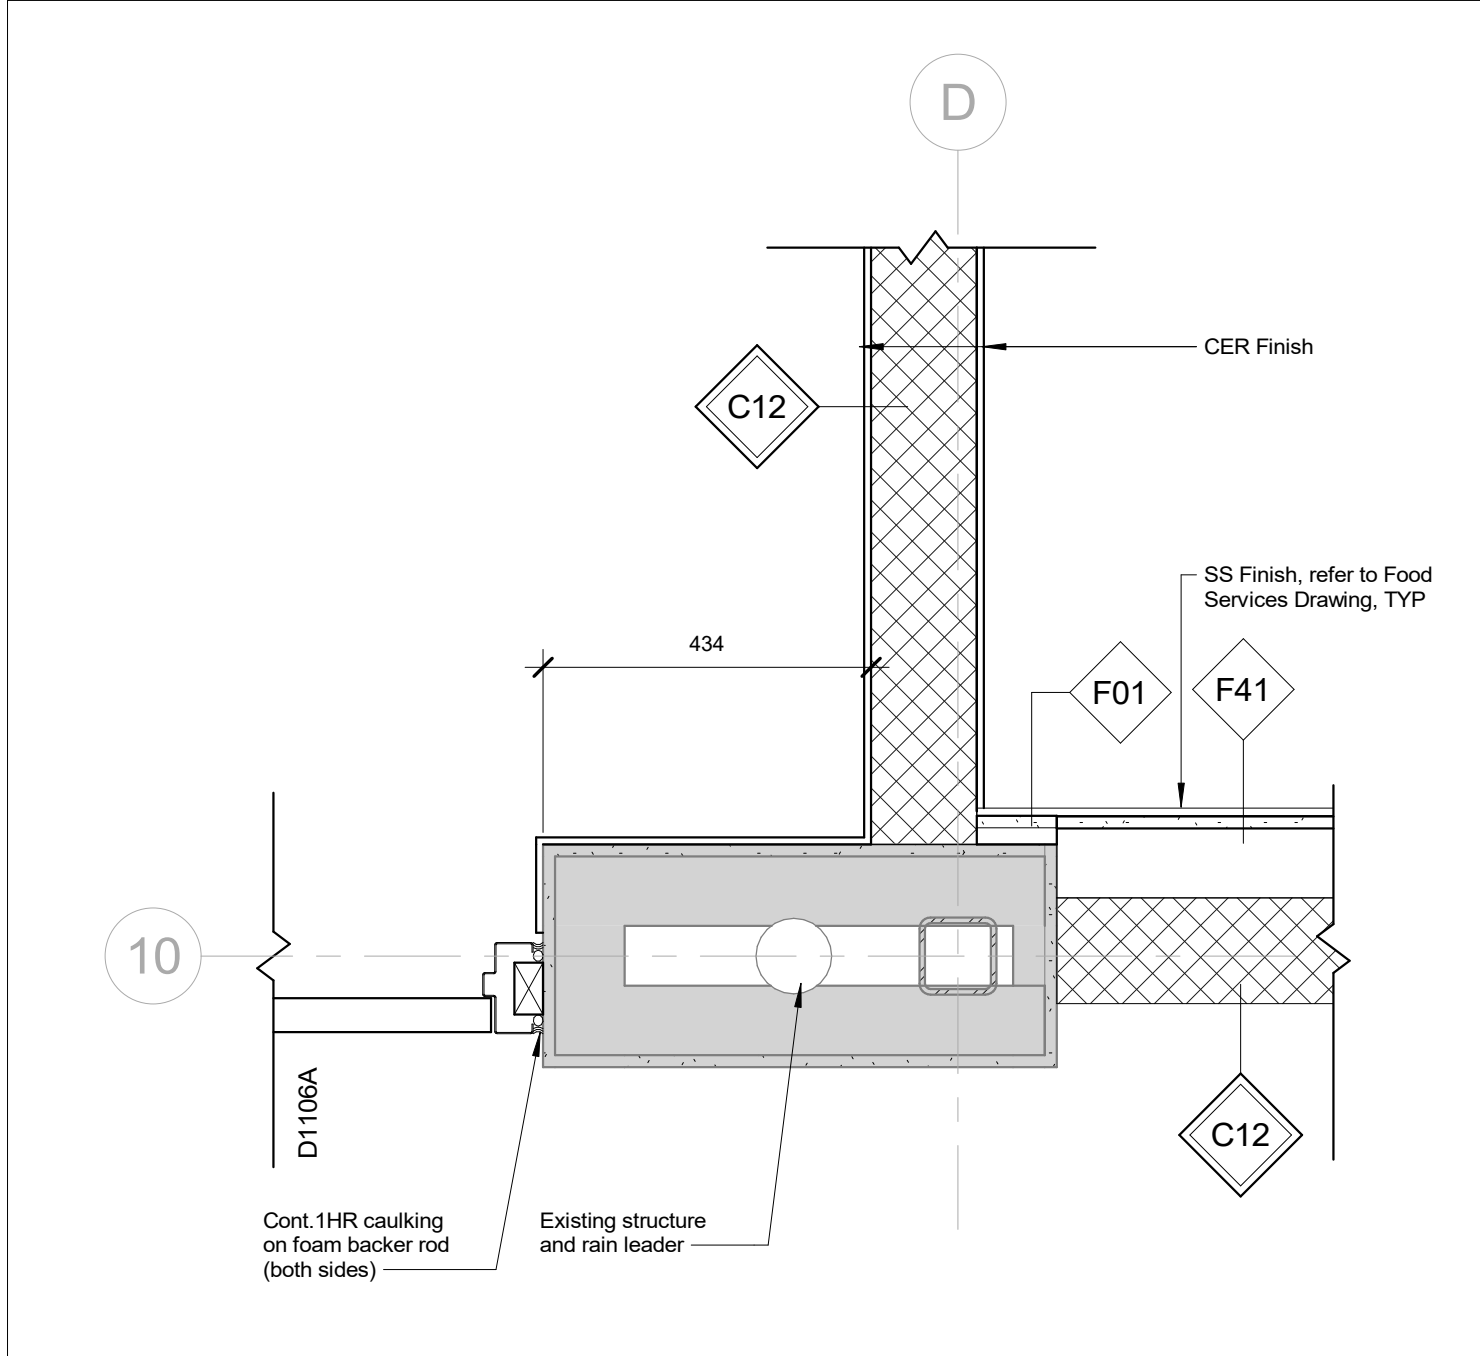


7 Plan Detail - CMU to R63 Corner @ D1106A1  
1 : 10

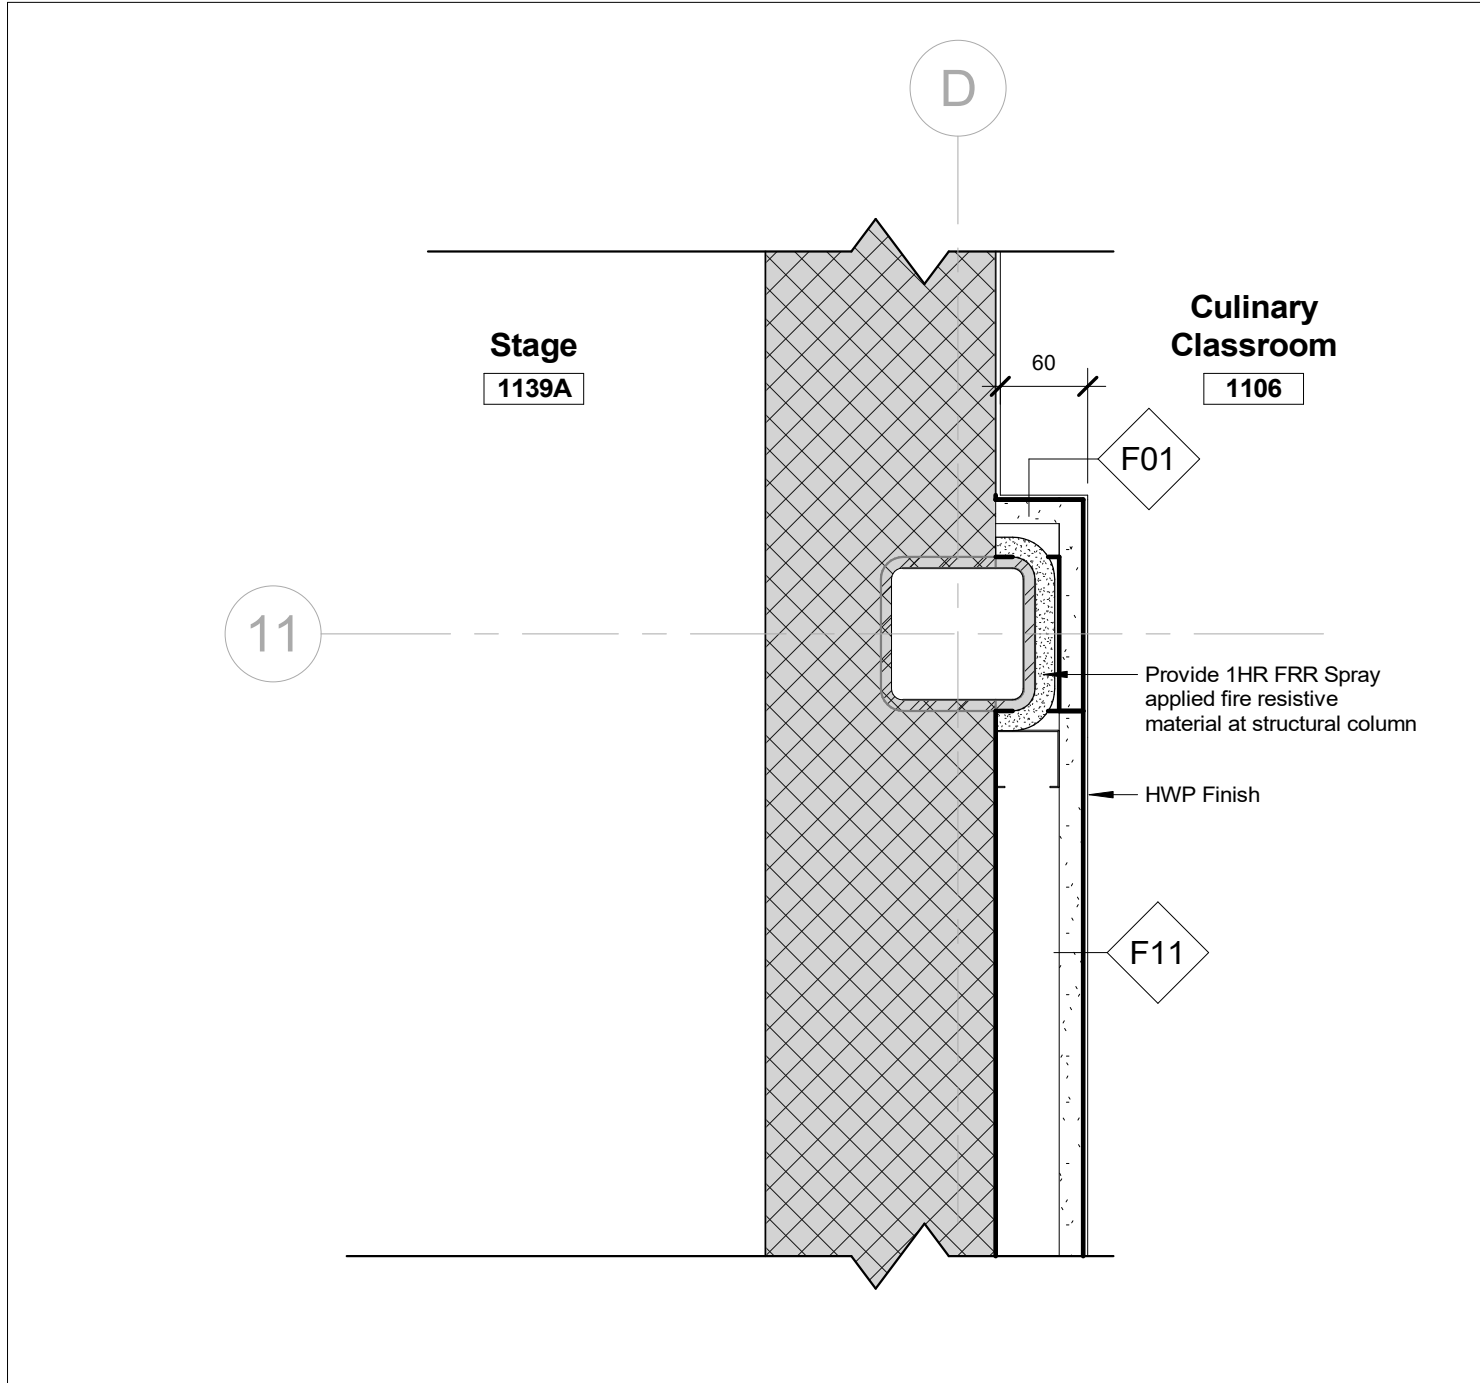

3 Plan Detail - Column @ D11  
1 : 5

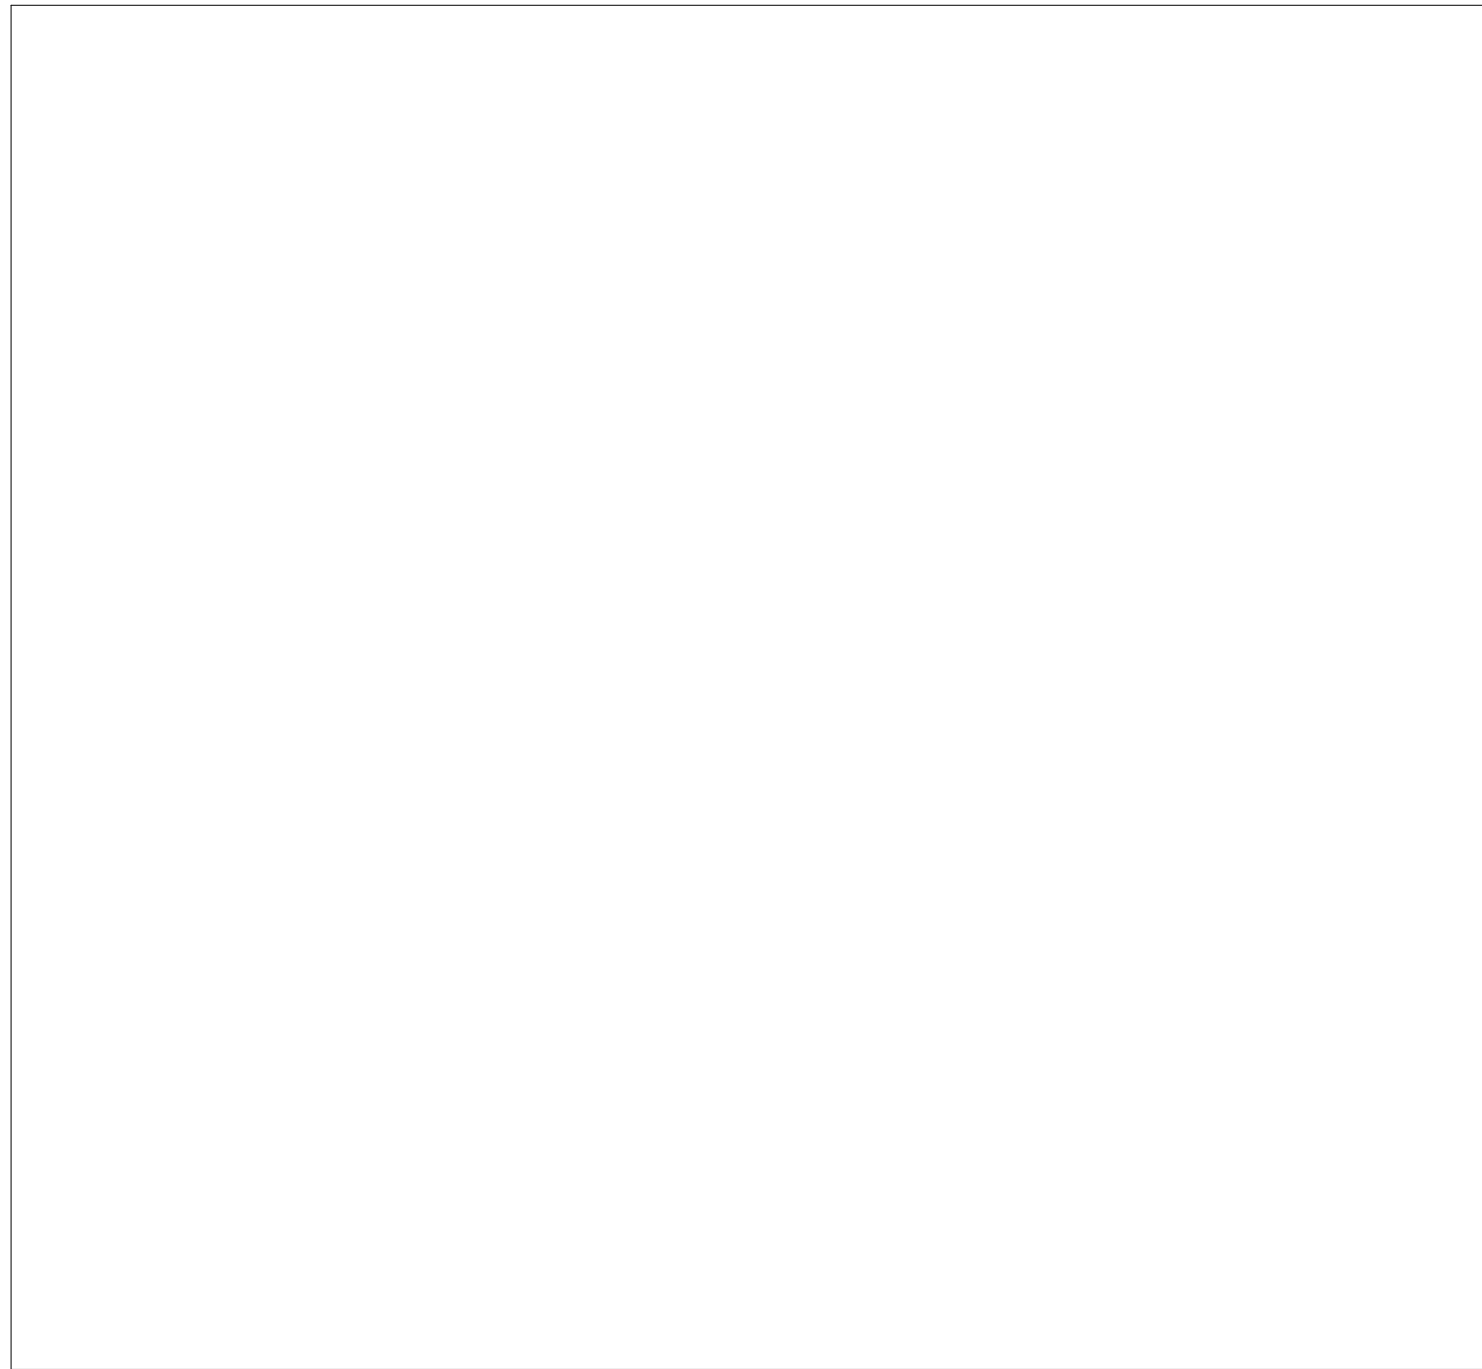

RESERVED

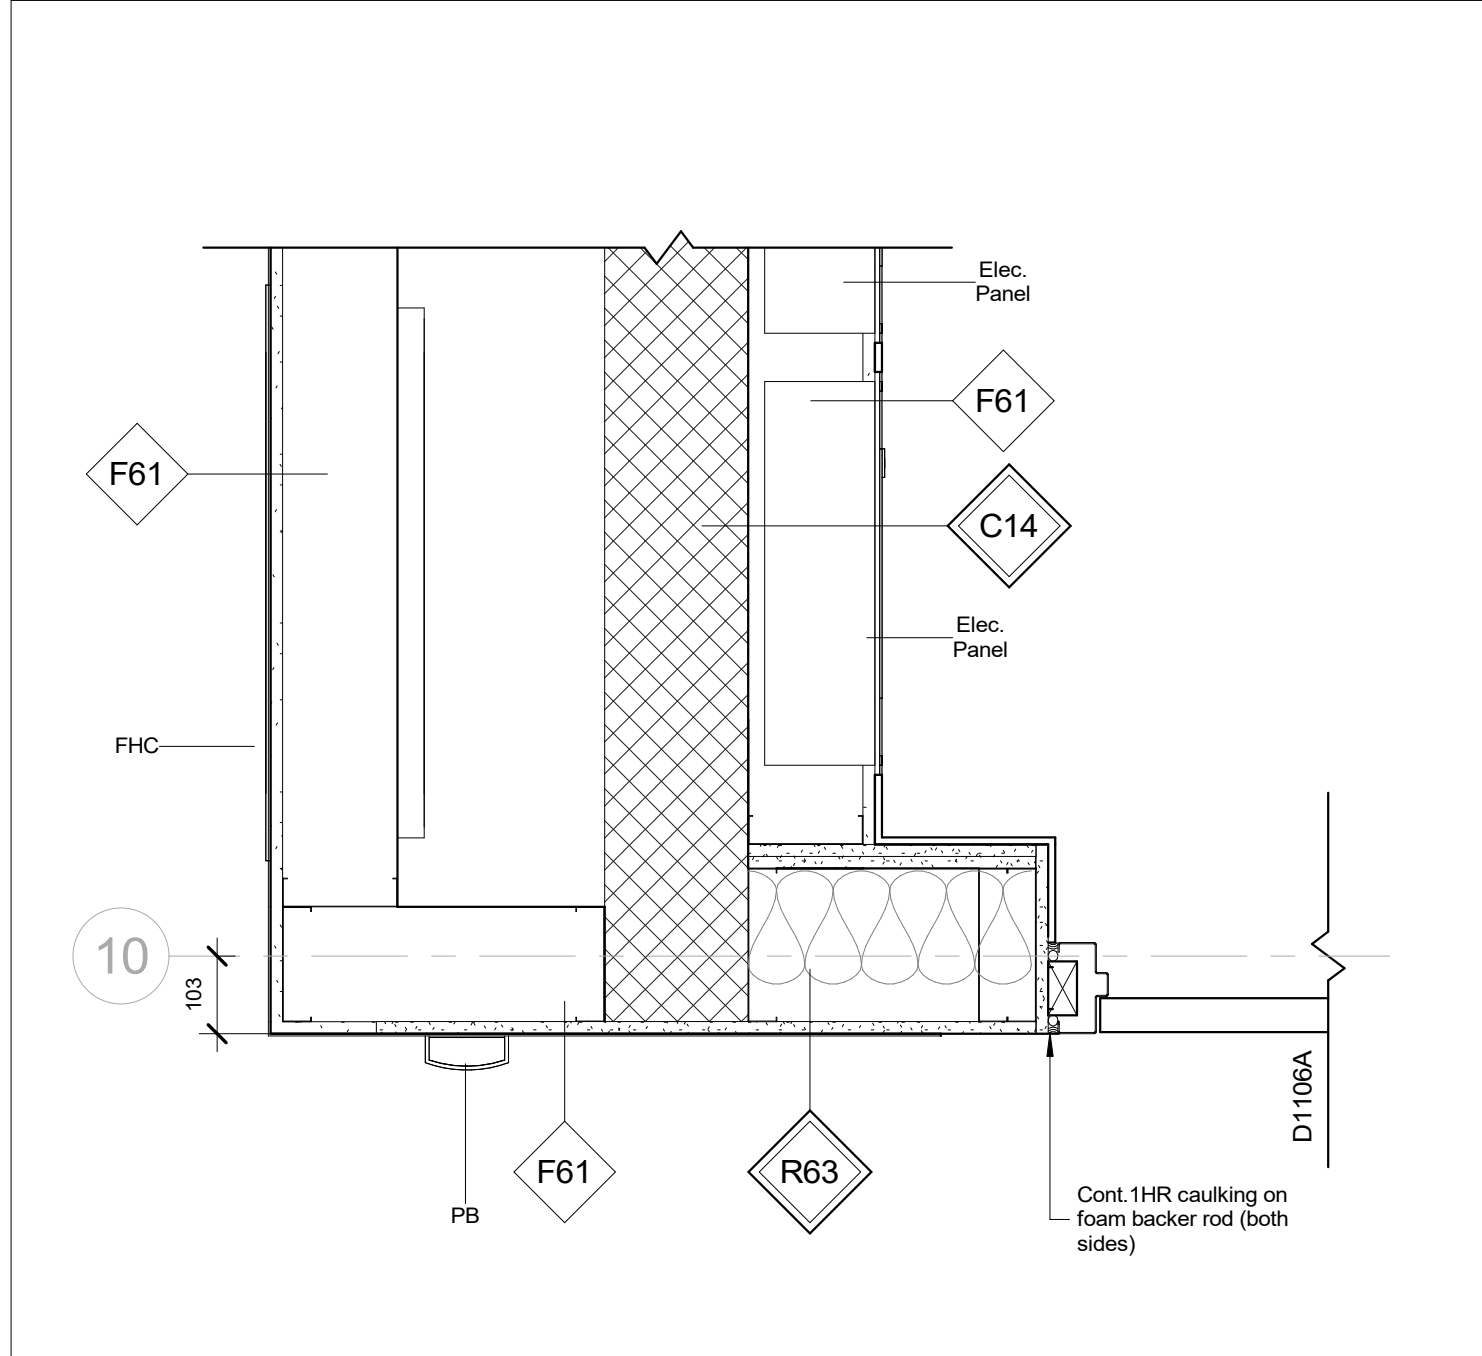

8 Plan Detail - CMU to R63 Corner @ D1106A  
1 : 10



RESERVED

2	Issued for Permit & Tender	10/31/2025
1	Issued for 90% CD - Client Review	10/09/2025

No.	ISSUED/REVISED	DATE
-----	----------------	------

Henry St H.S.  
Culinary Classroom Renovation

600 Henry St, Whitby, ON L1N 1L4


Interior Plan and Section  
Details

Scale: As indicated

Project Number:  
25-102




A500

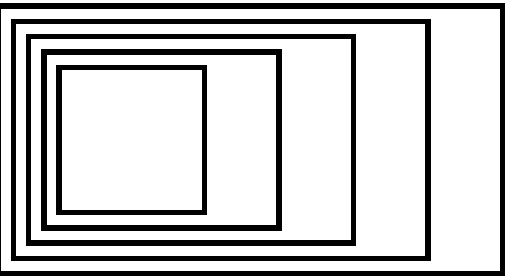


GOW HASTINGS  
ARCHITECTS

275 SPADINA ROAD  
TORONTO ONTARIO M5R 2V3  
416-920-0031  
GOWHASTINGS.COM


ALL DRAWINGS, SPECIFICATIONS, RELATED DOCUMENTS AND DESIGN ARE THE COPYRIGHT PROPERTY OF THE ARCHITECT AND MAY BE RETURNED UPON REQUEST. REPRODUCTION OF THE DRAWINGS, SPECIFICATIONS, RELATED DOCUMENTS AND DESIGN IN WHOLE OR IN PART IS STRICTLY FORBIDDEN WITHOUT THE ARCHITECT'S WRITTEN PERMISSION. THIS DRAWING SHALL NOT BE USED FOR CONSTRUCTION PURPOSES UNLESS COUNTERSIGNED.

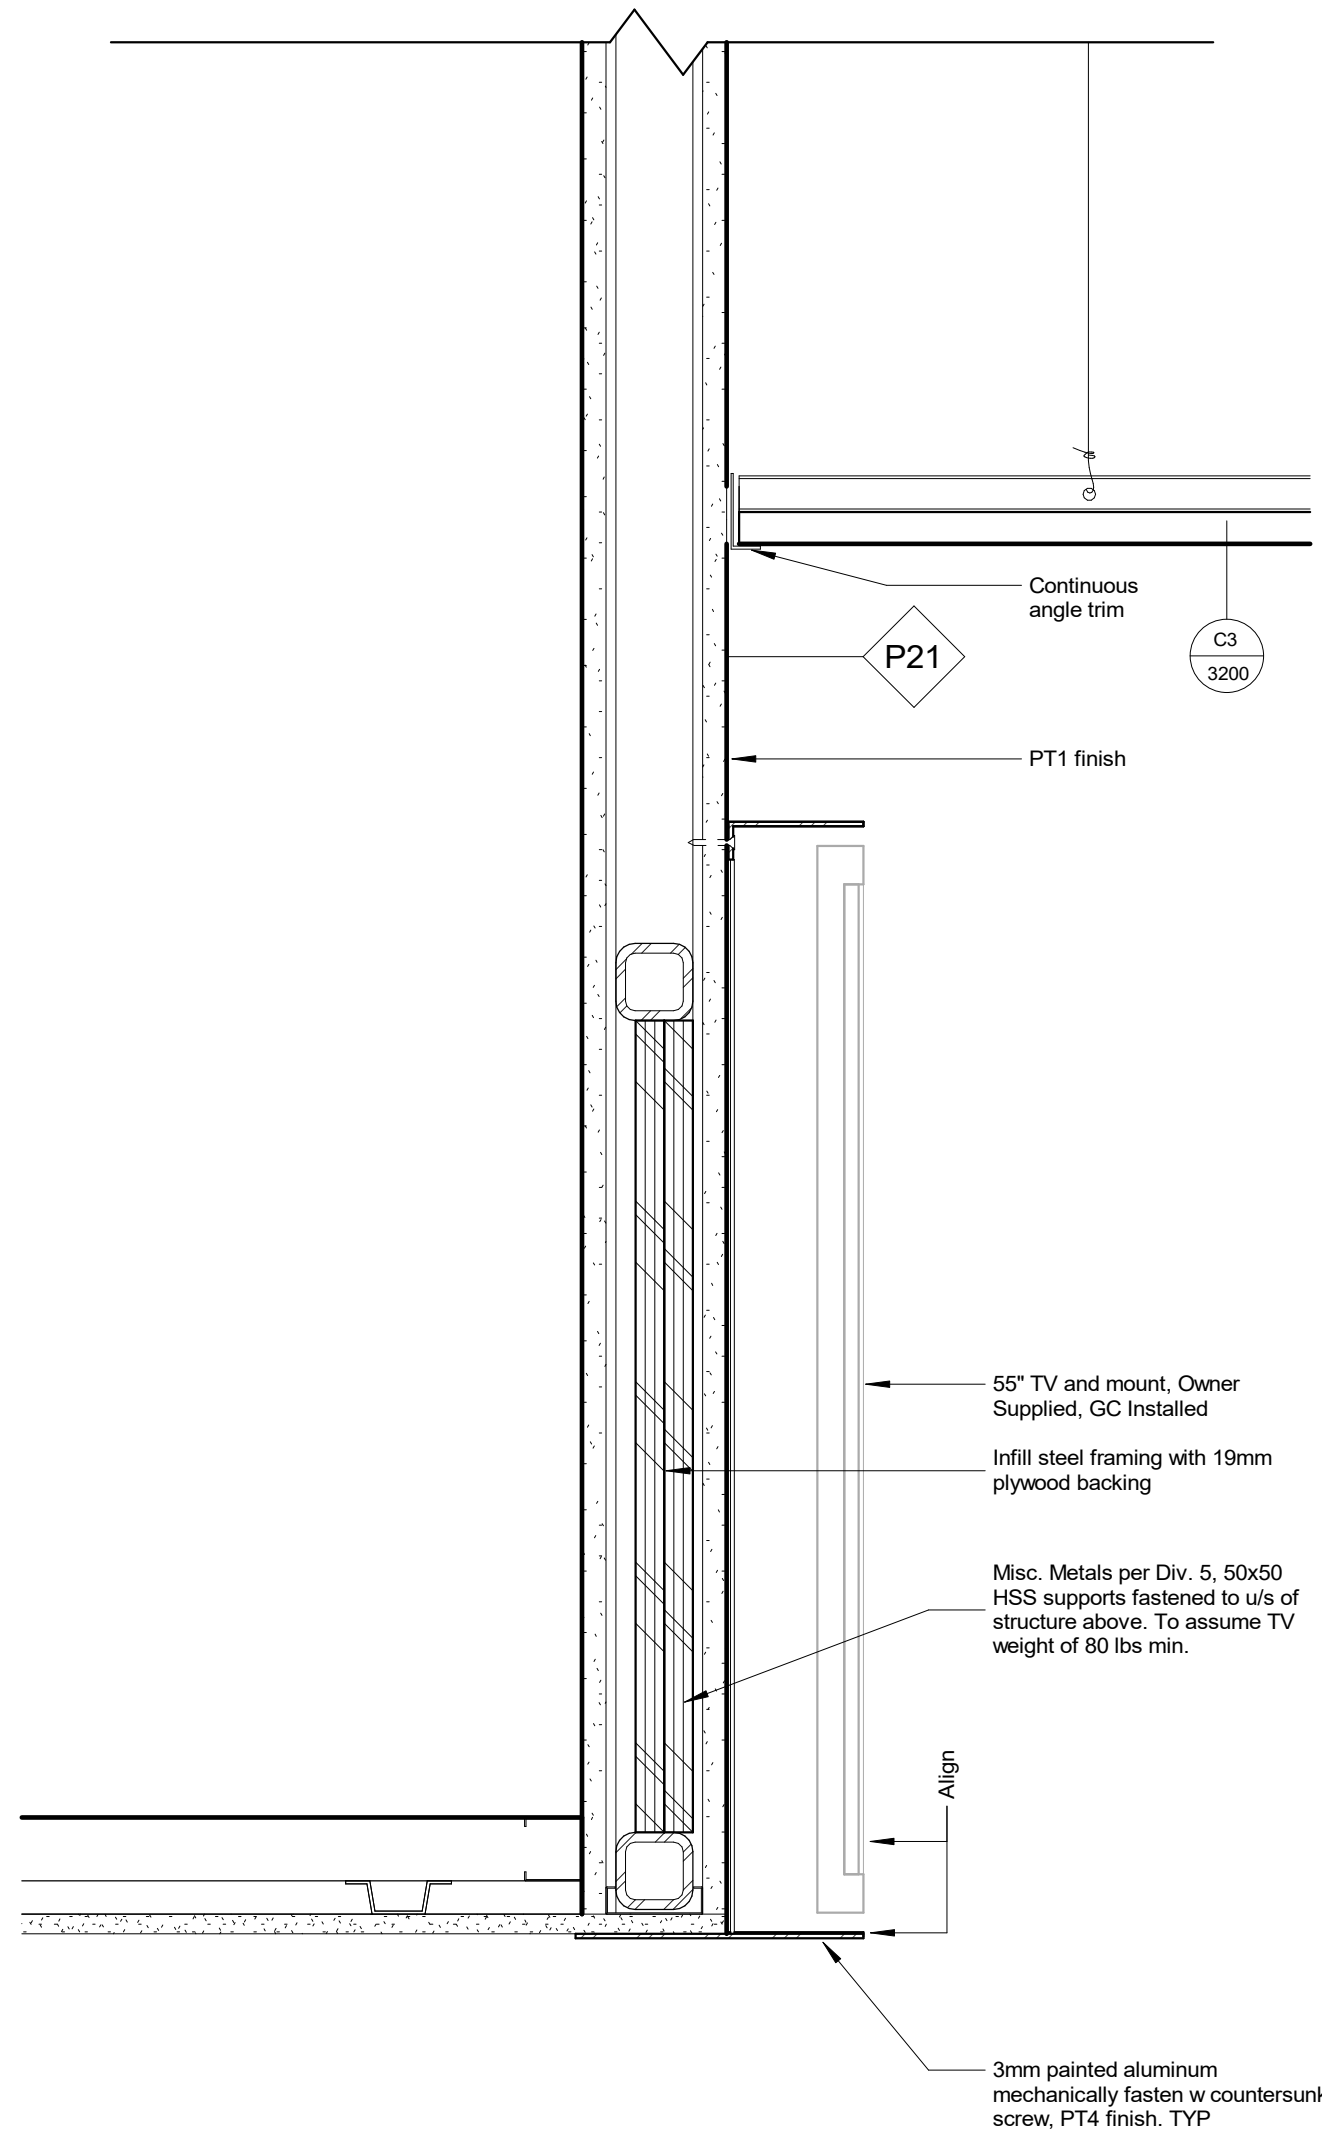


5 Section Detail - TV Support @ Bulkhead  
1 : 5

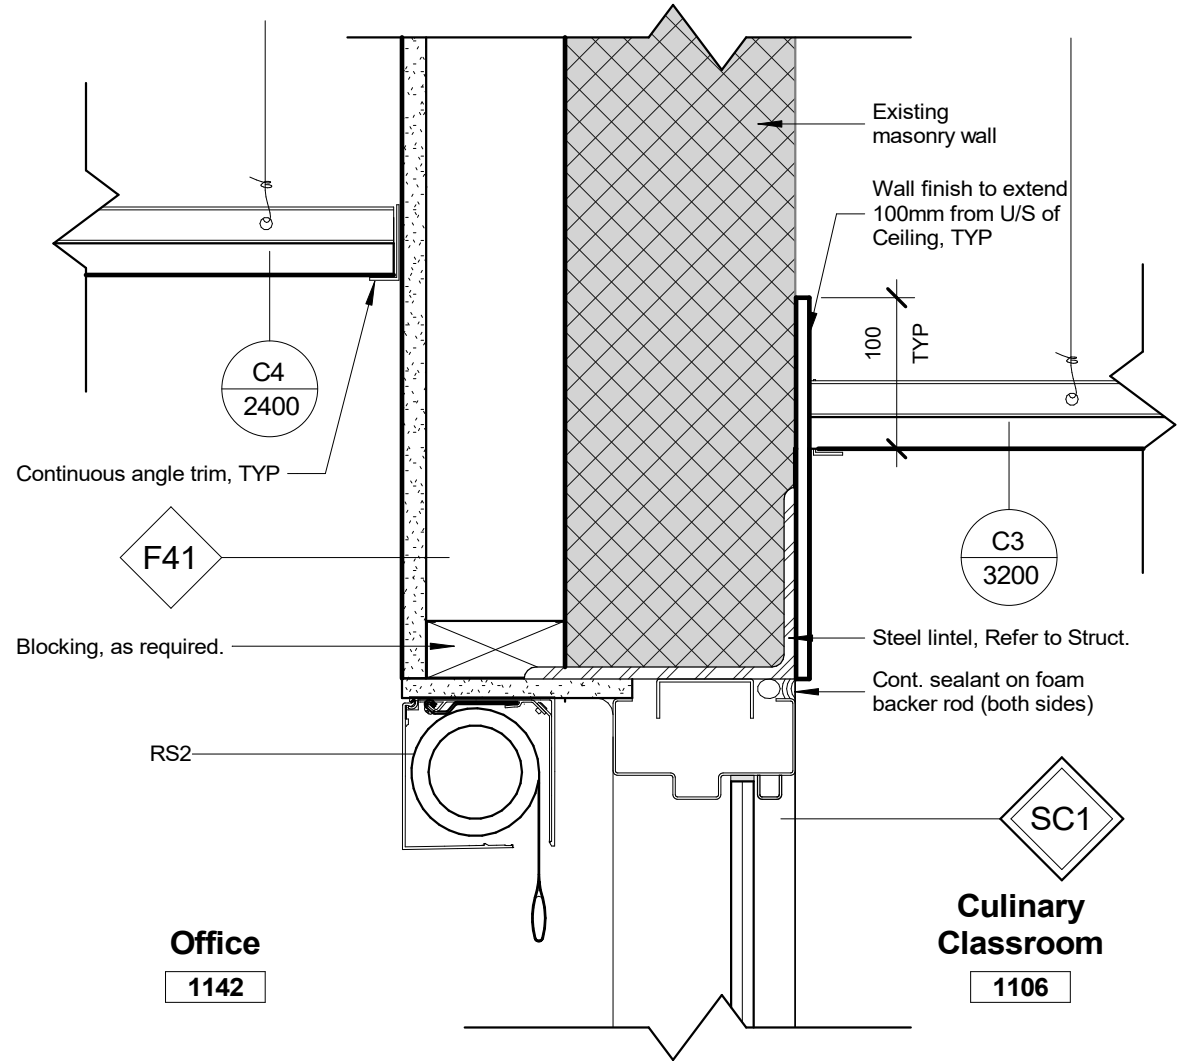


3 Section Detail - SC3 @ Office 1142  
1 : 5

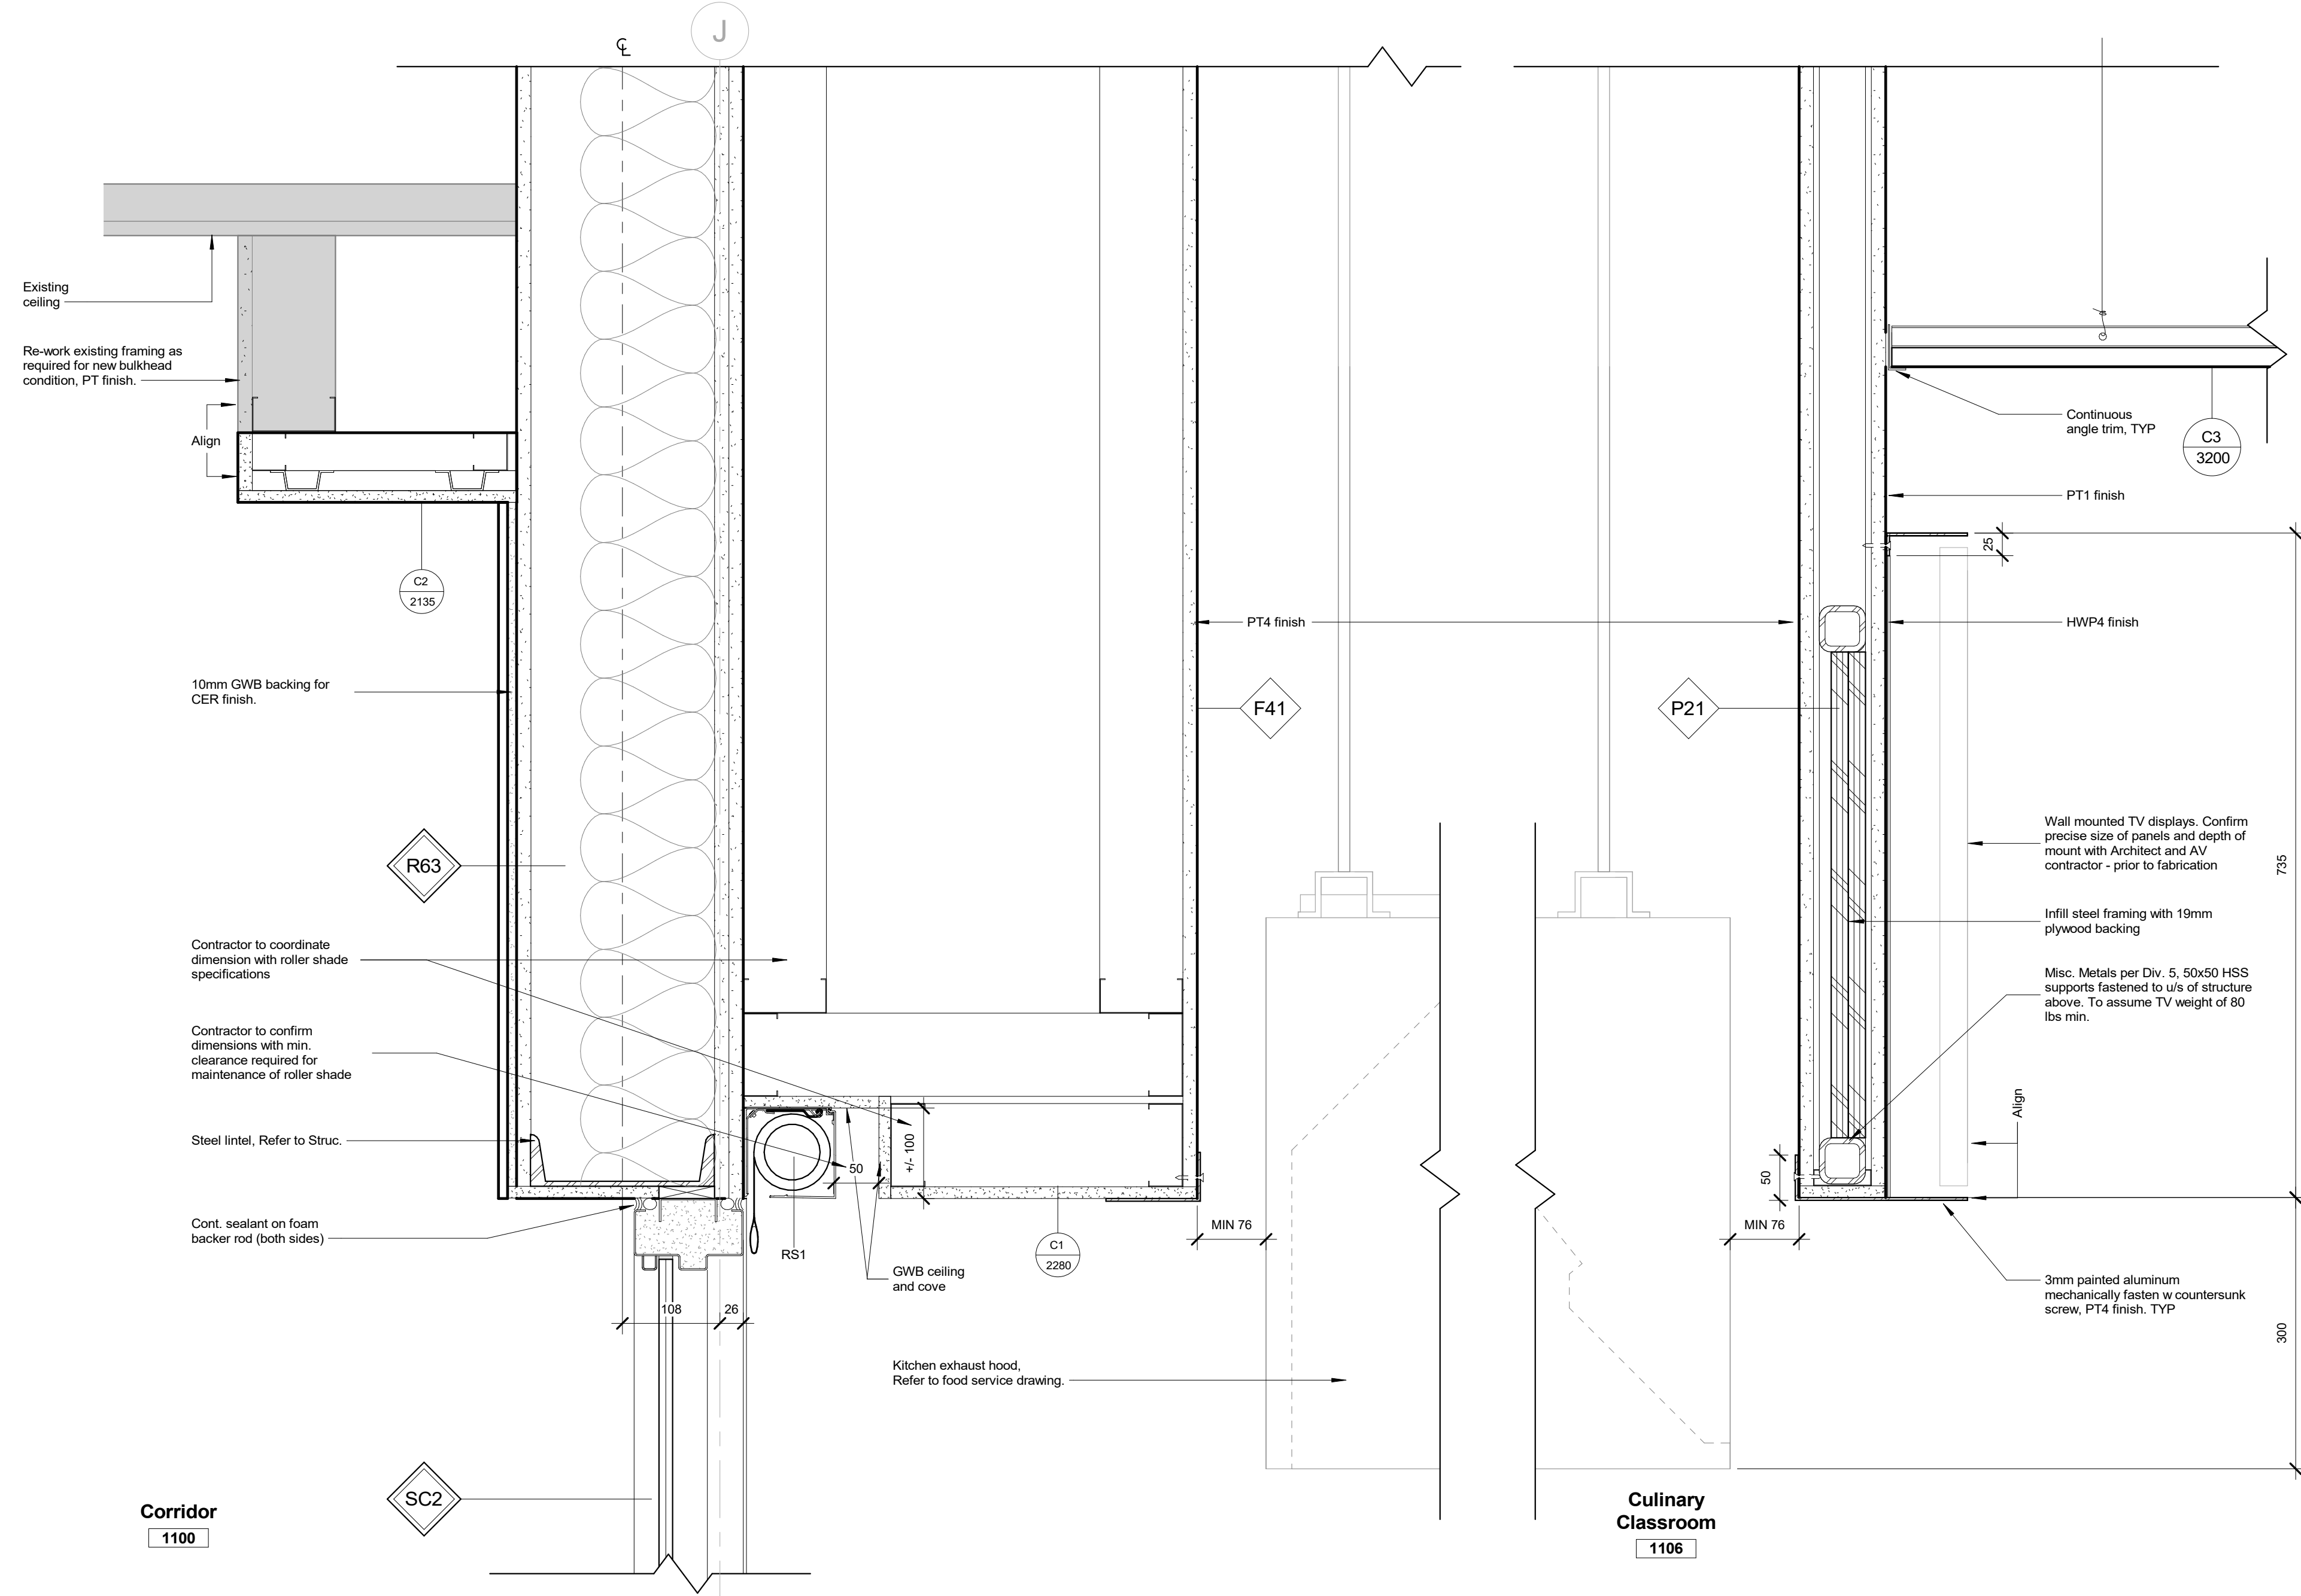

4 Section Detail - Demo Station Hood Enclosure  
1 : 5

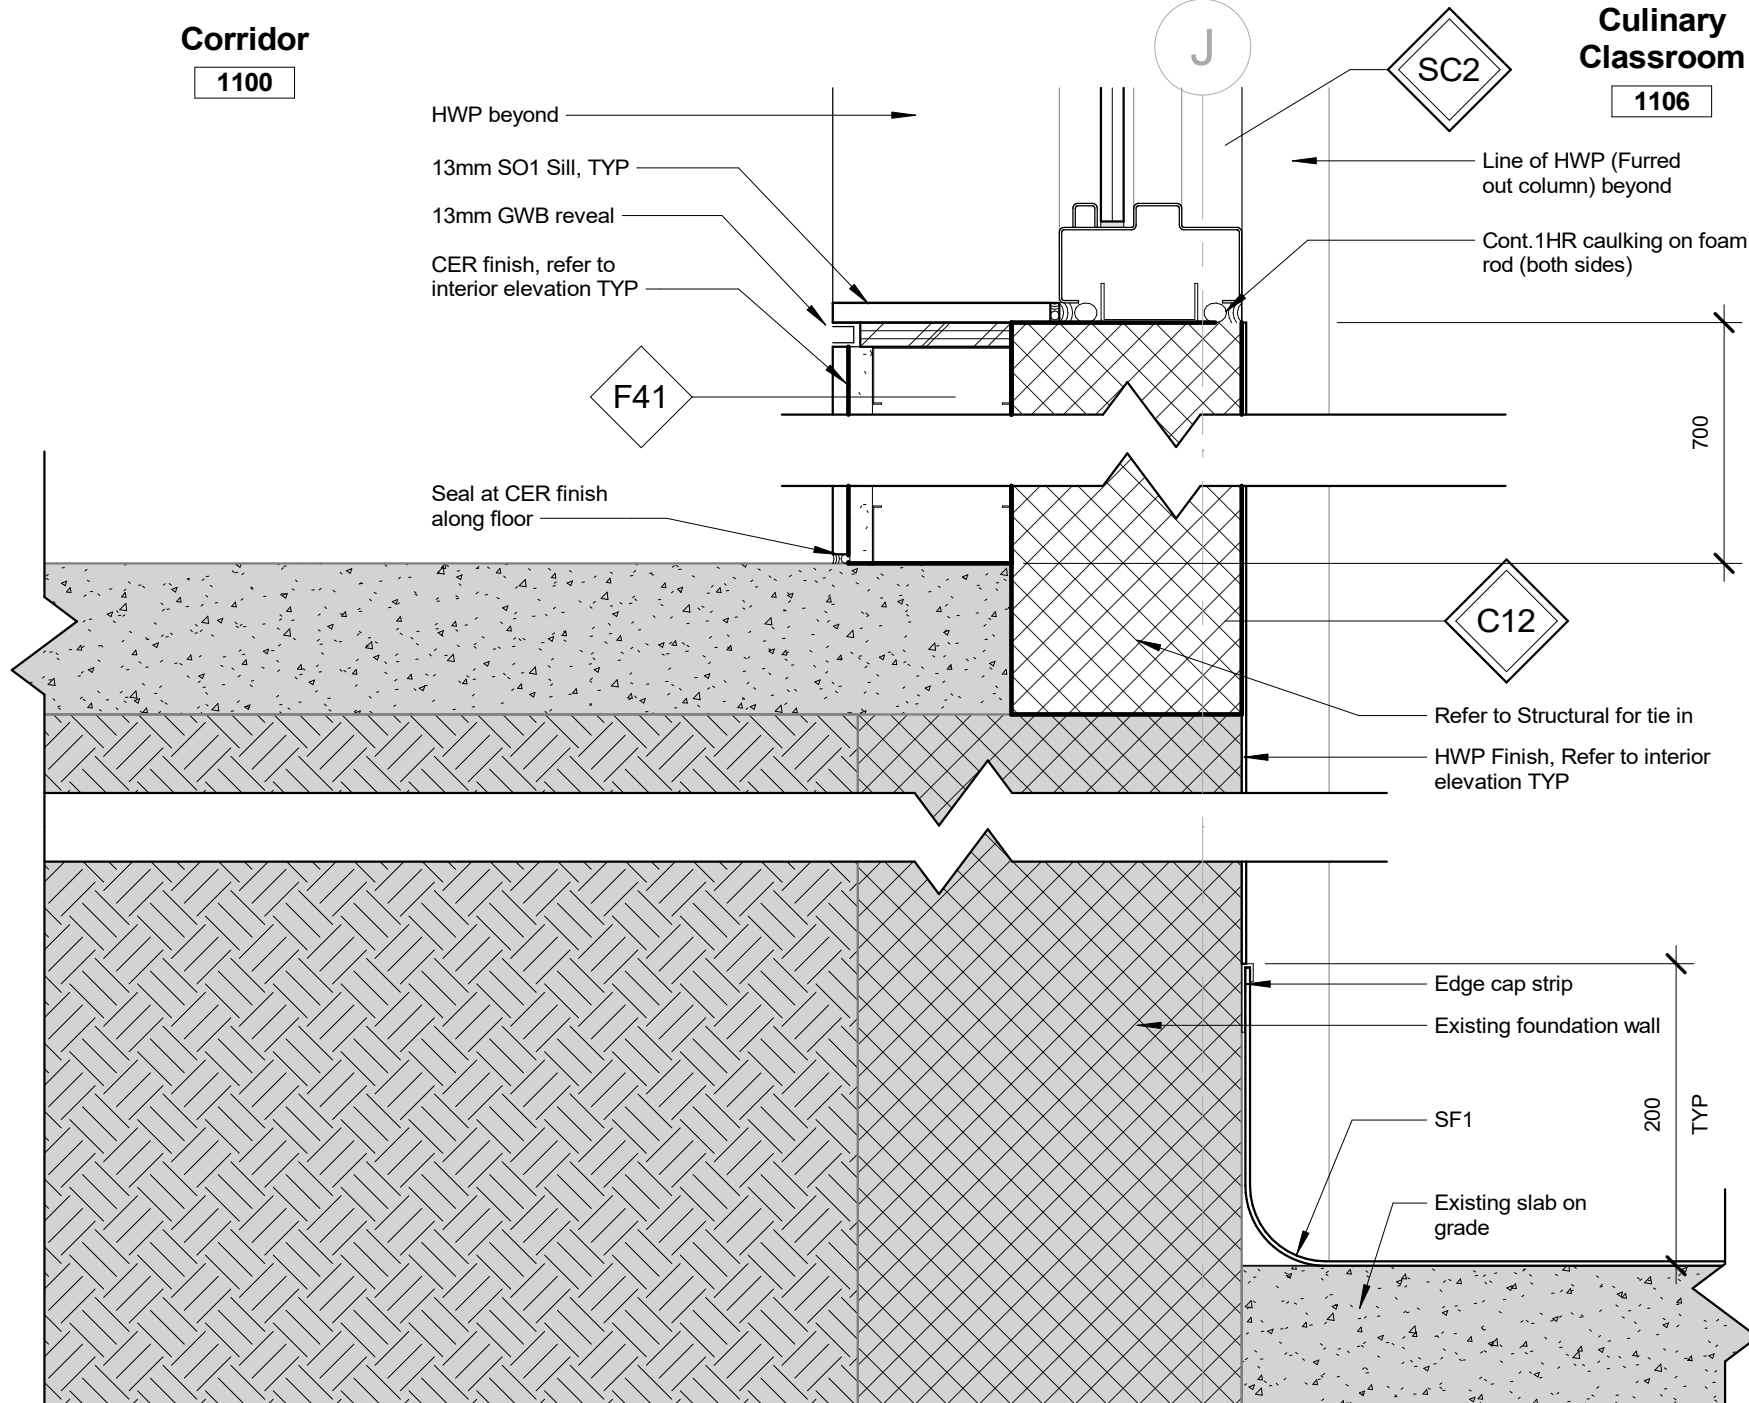

2 Section Detail - Existing Foundation Wall @ Classroom 1106 to Corridor 1100  
1 : 5

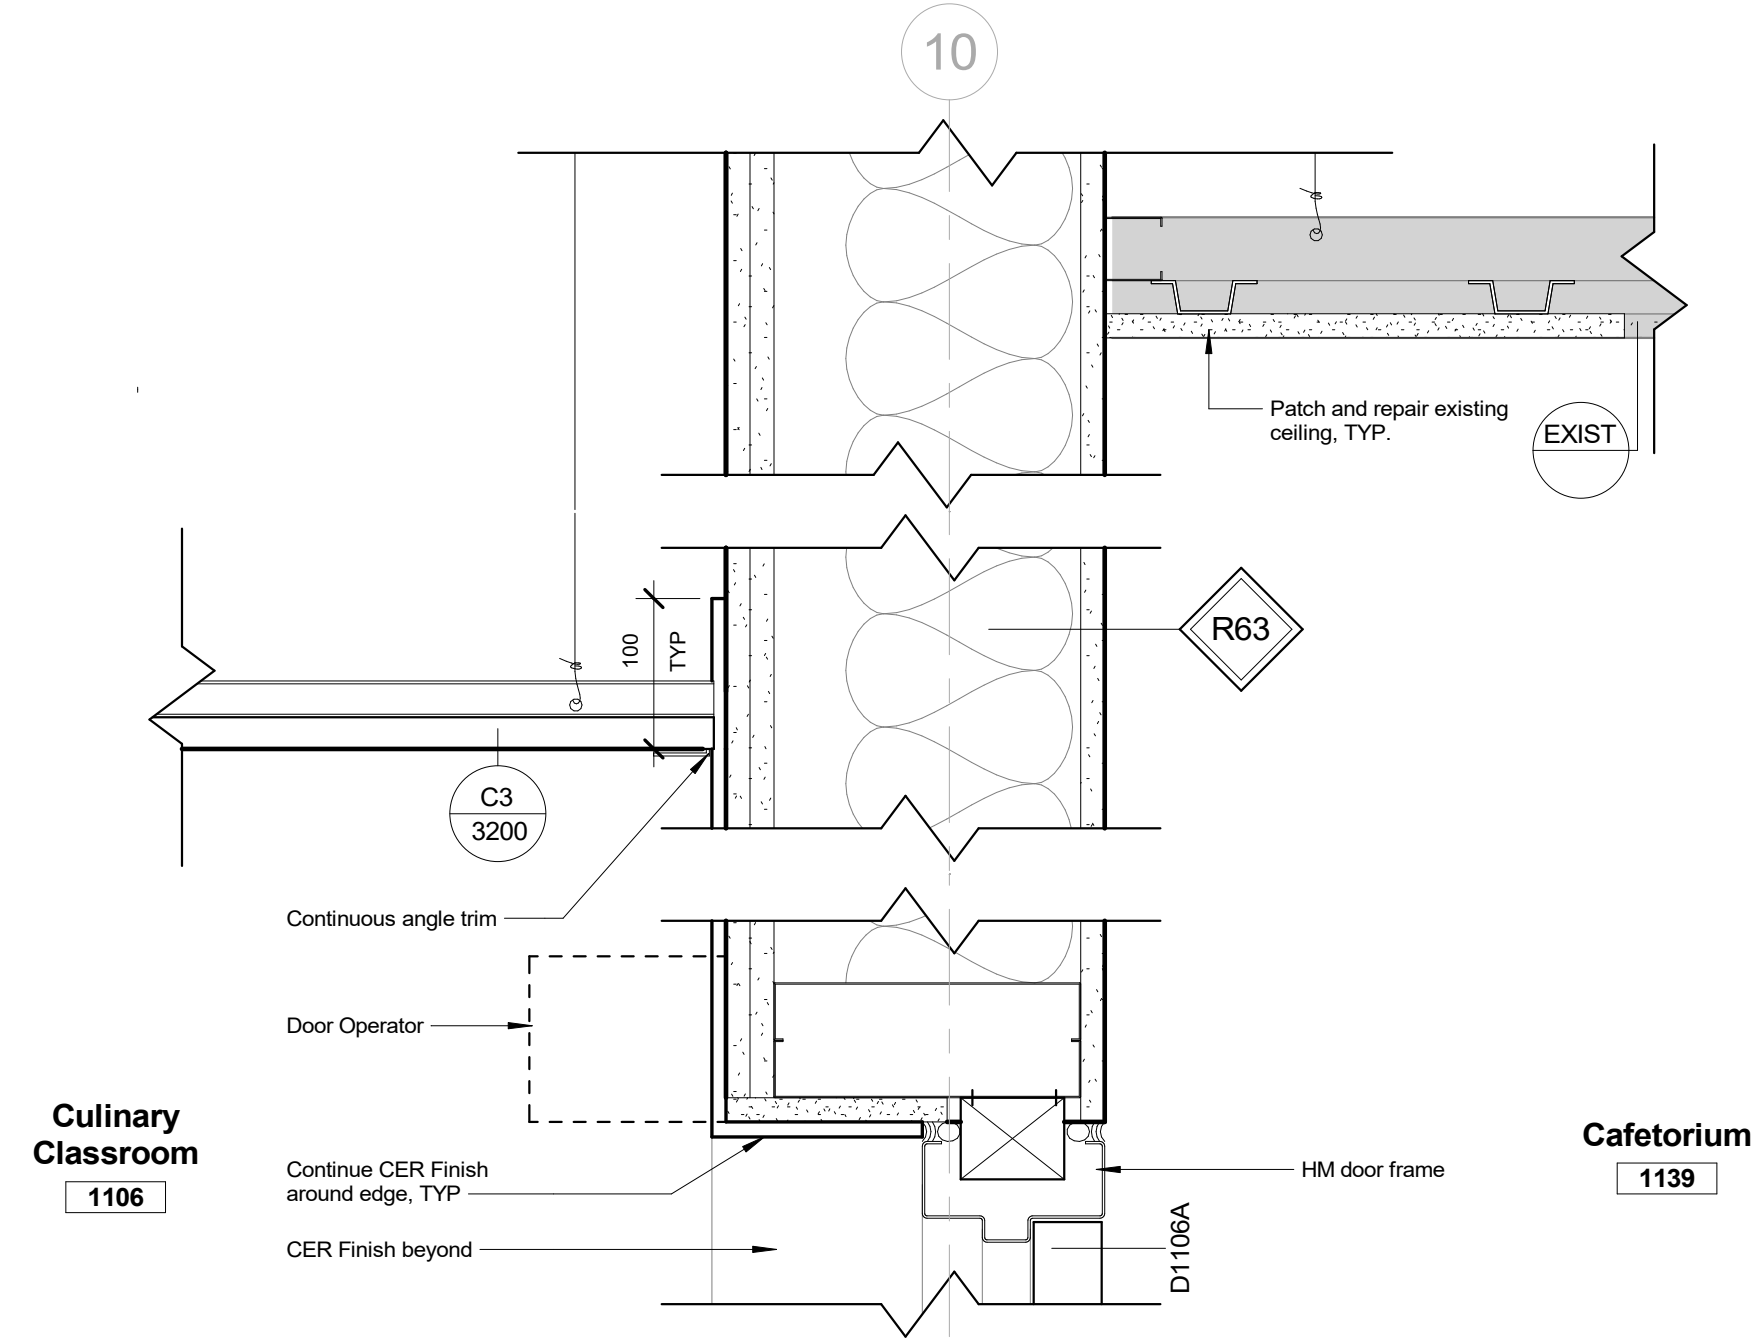

1 Section Detail - Existing  
1 : 5

2 Issued for Permit & Tender 10/31/2025  
1 Issued for 90% CD - Client Review 10/09/2025

No. ISSUED/REVISED DATE

Henry St H.S.  
Culinary Classroom Renovation

600 Henry St, Whitby, ON L1N 1L4


Interior Section Details

Scale: 1 : 5


Project Number:  
25-102




A501

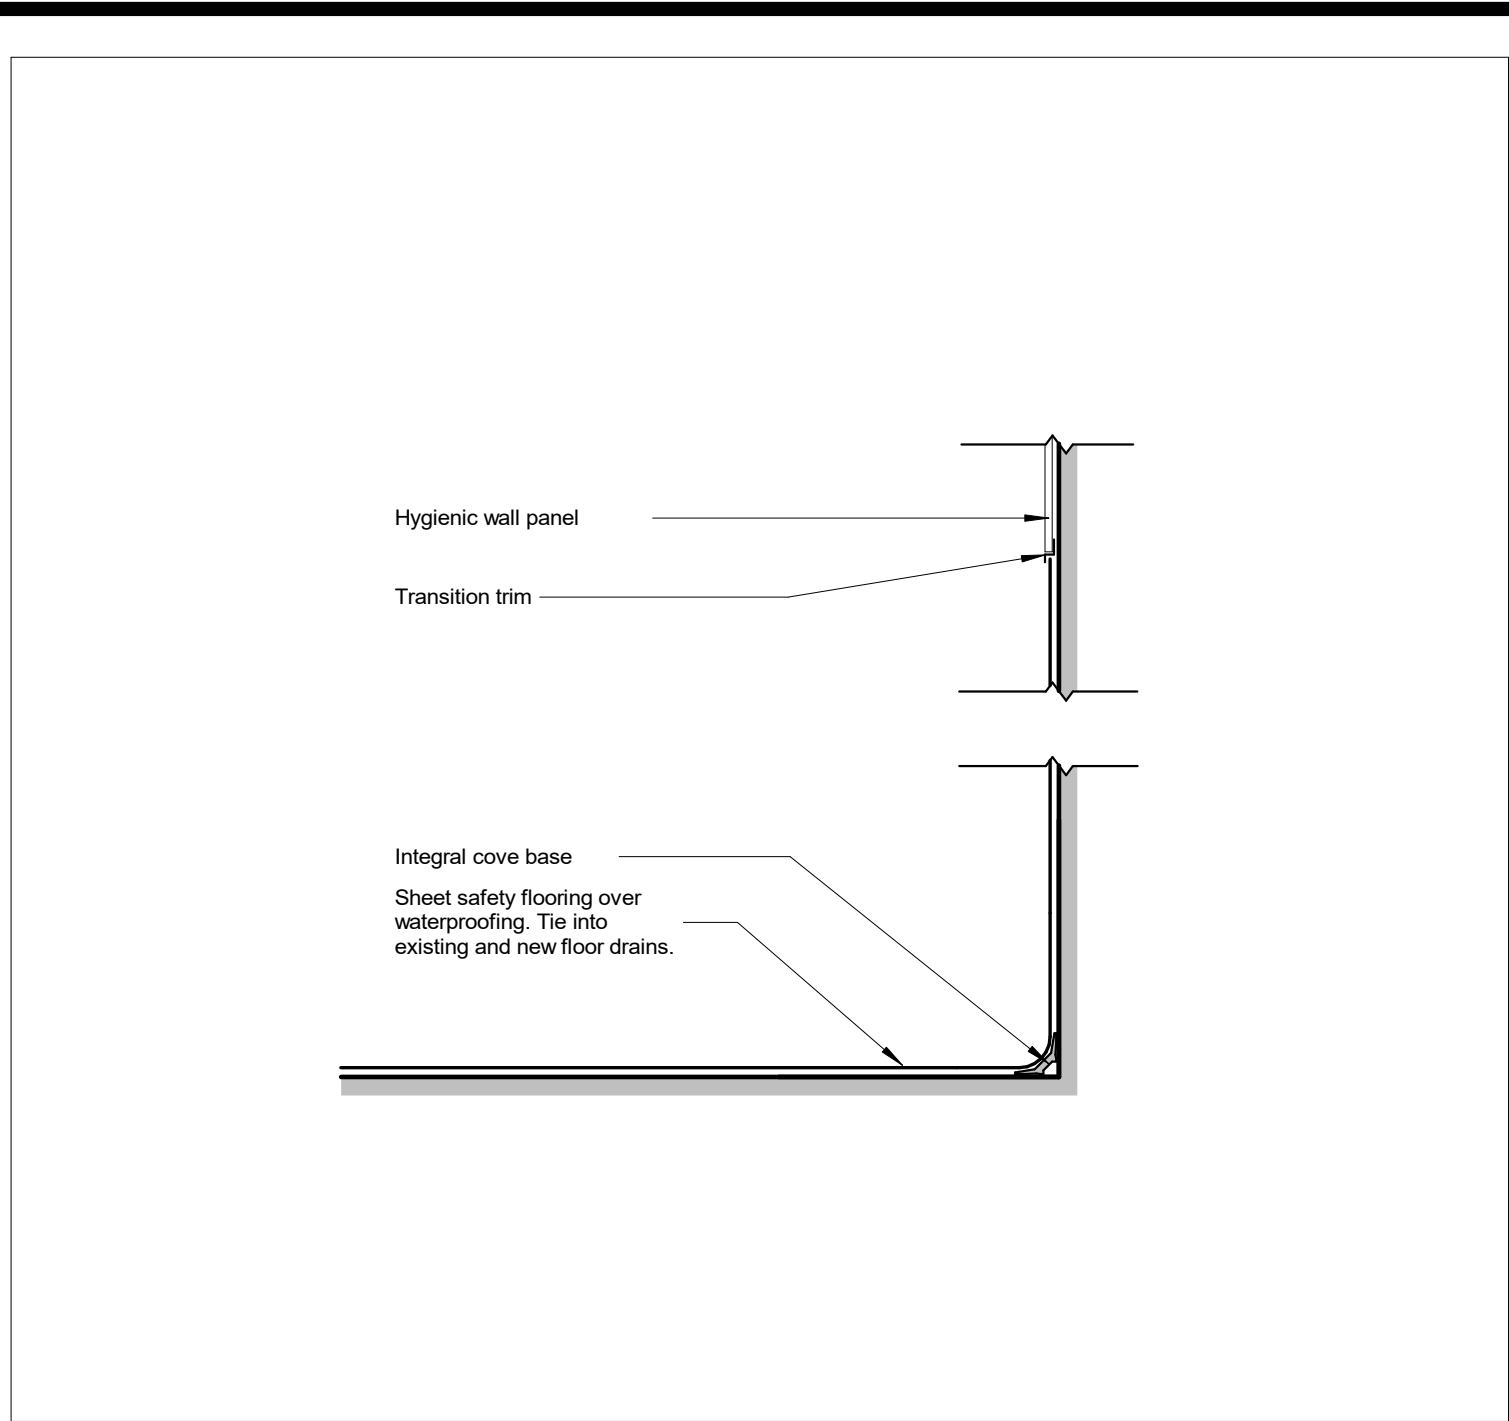


7 Floor Base Section - Flashcove and Wall Trim  
1 : 5

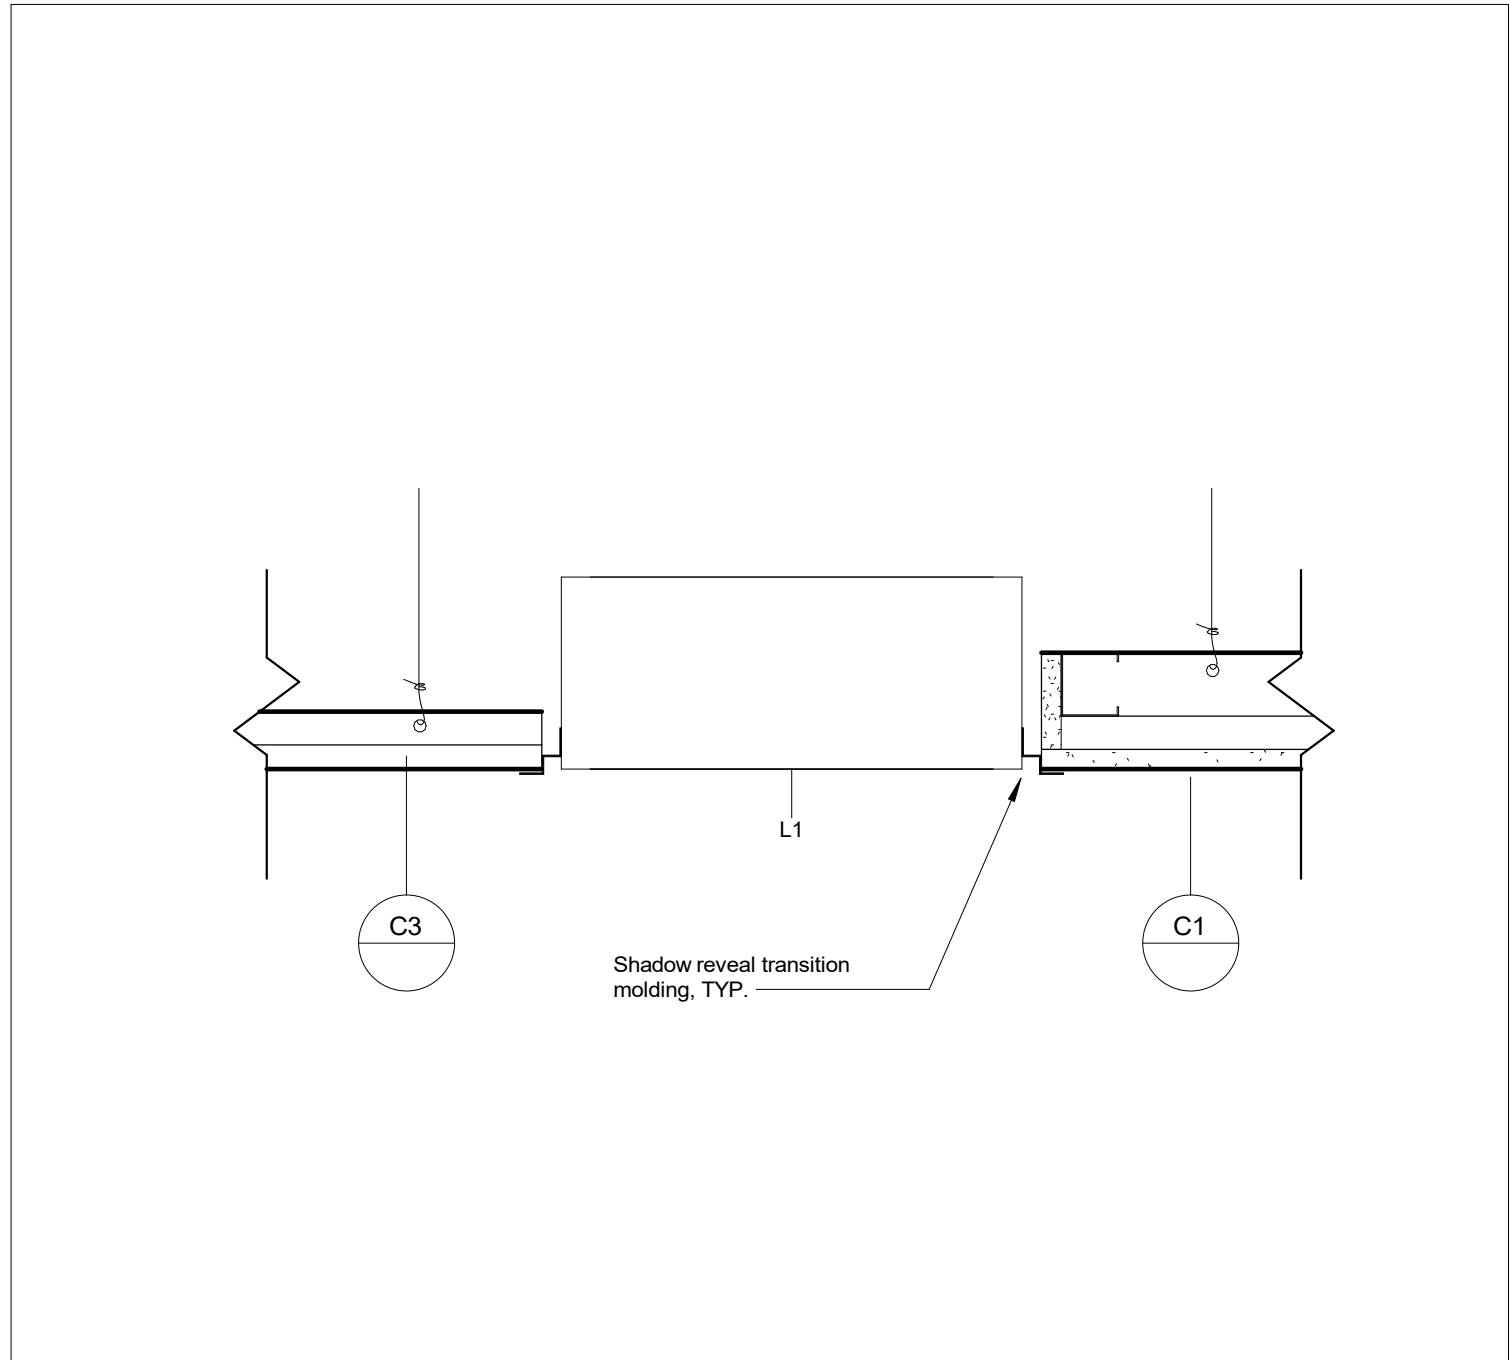


4 Section Detail - Typical L1 to C3 and C1  
1 : 5

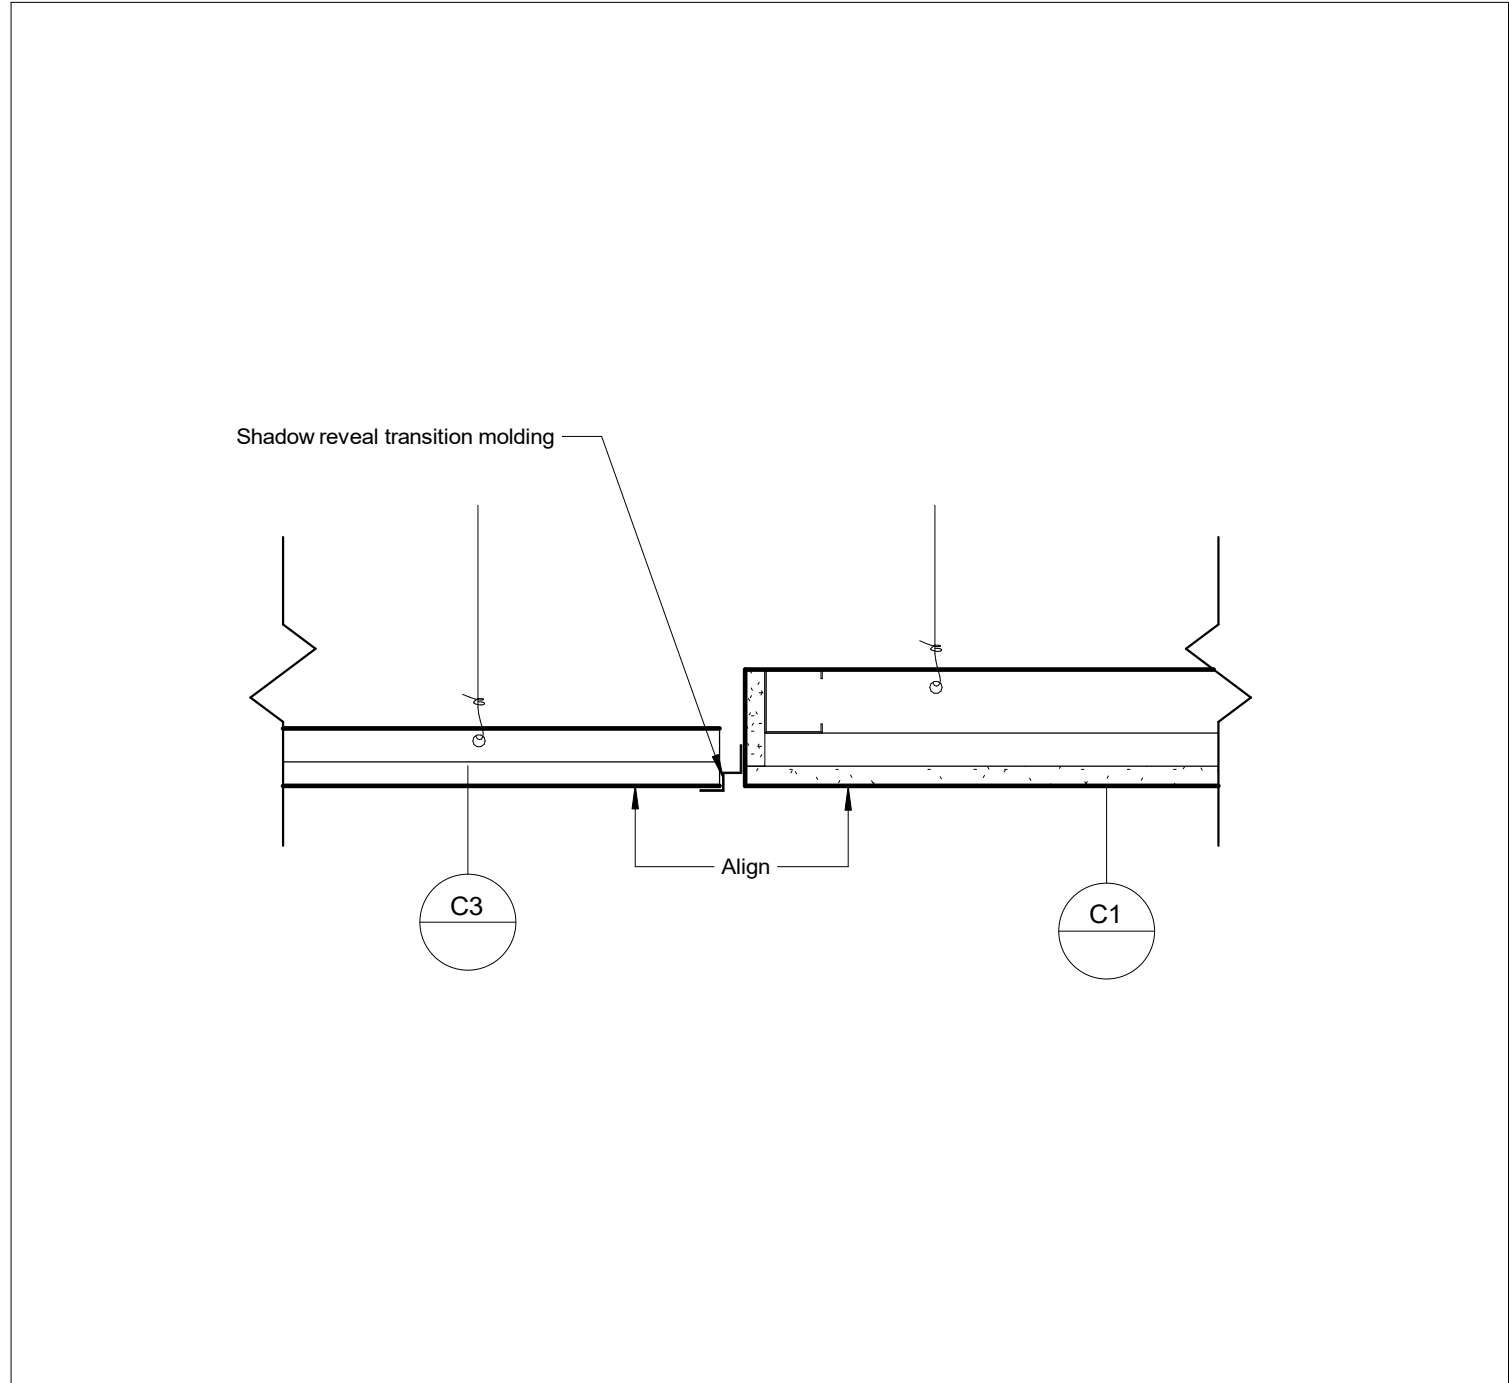


3 Section Detail - Typical C3 to C1  
1 : 5

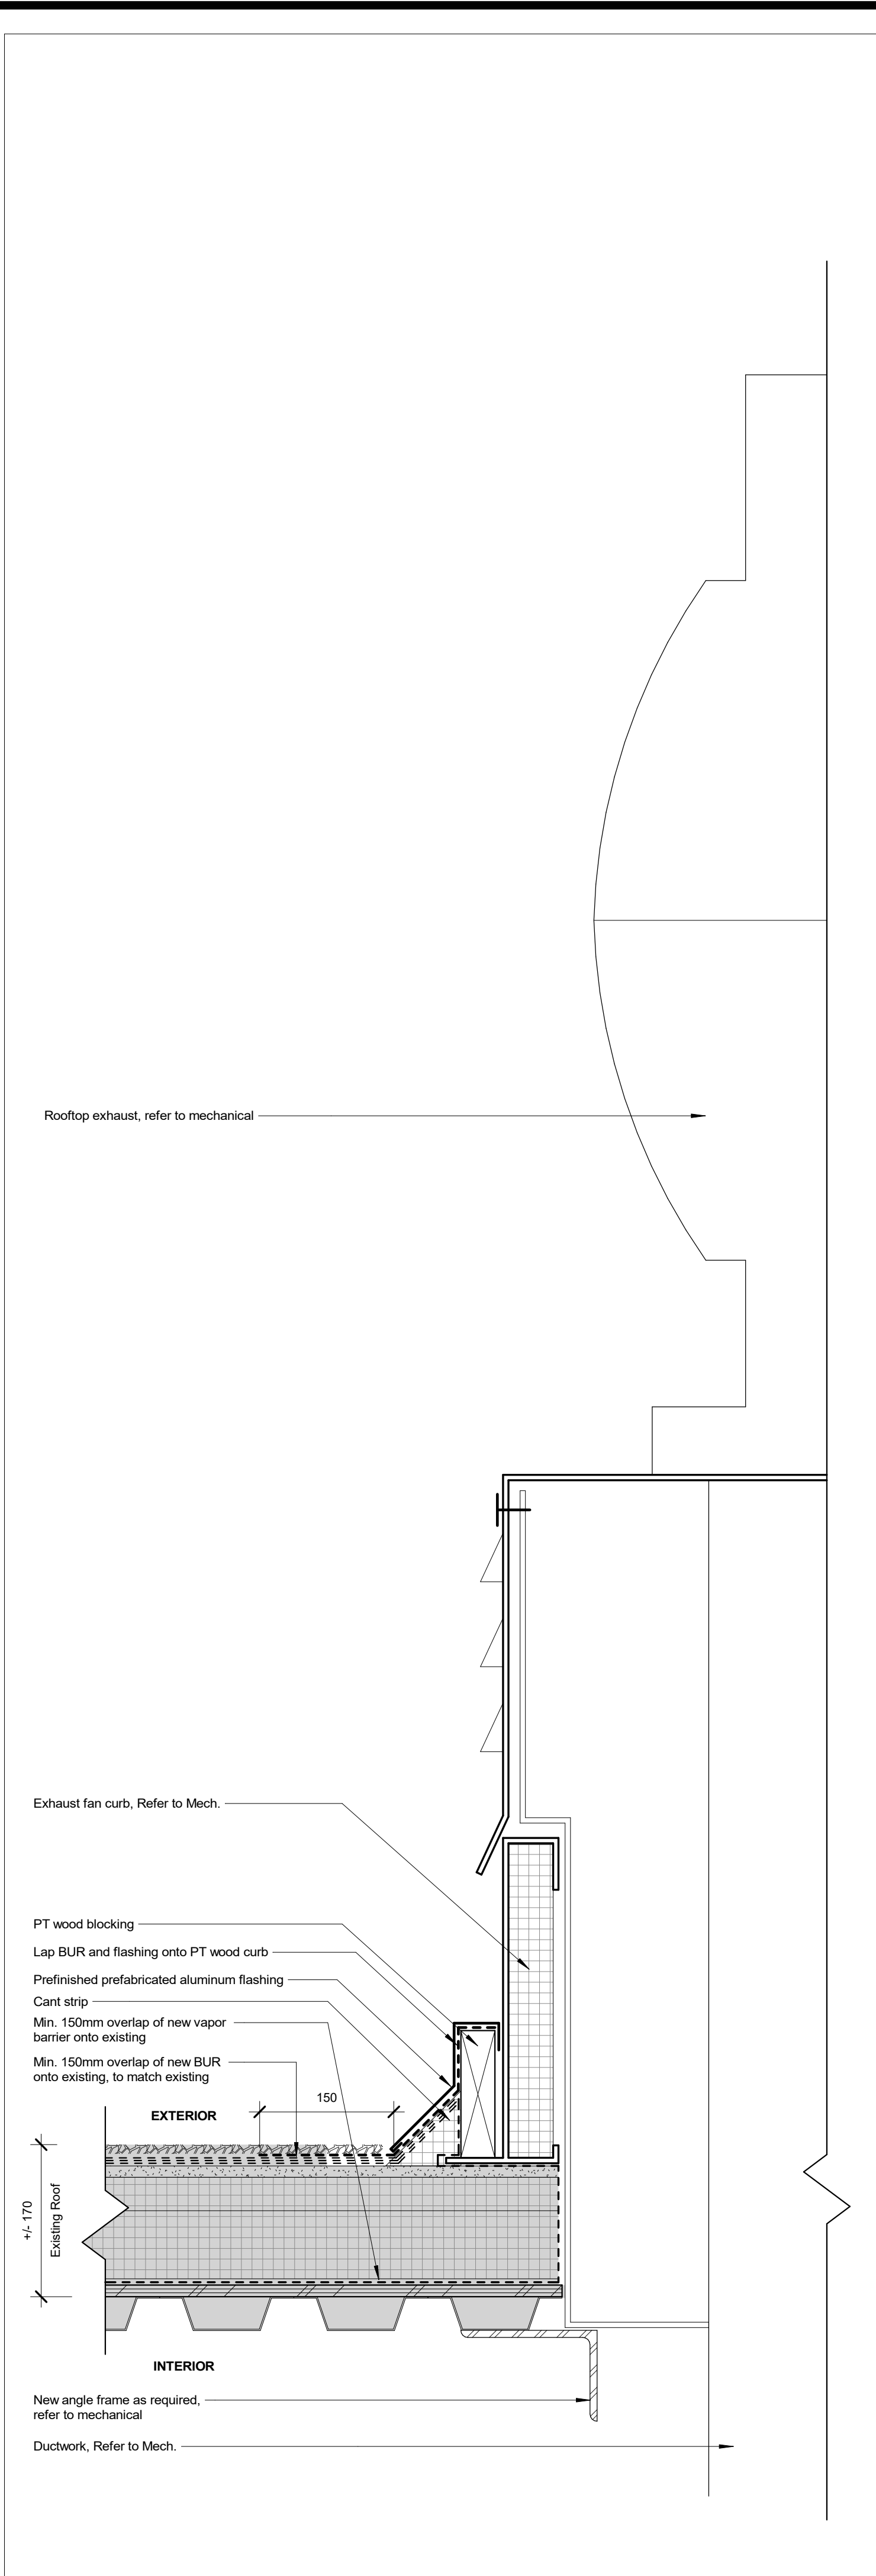


2 Roof Detail Section - Typical New or Enlarged Roof Penetration  
1 : 5

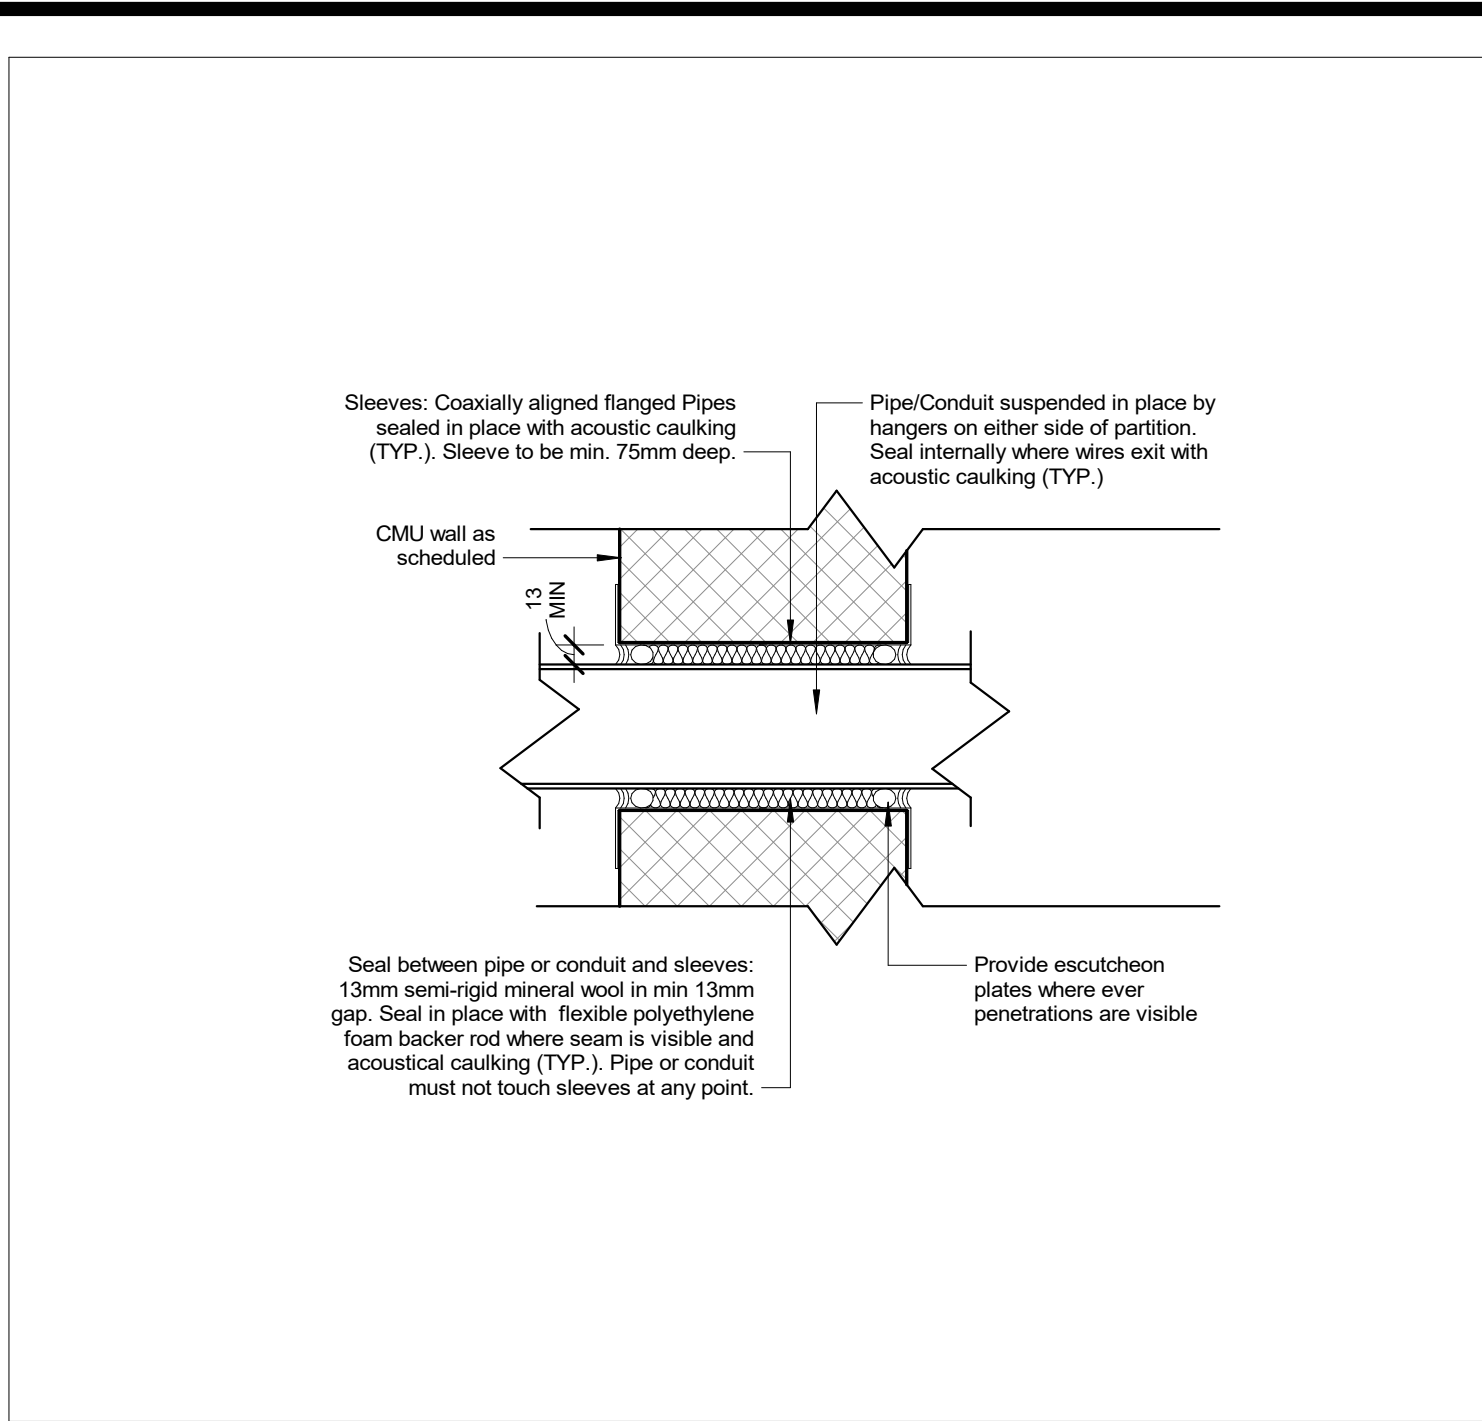


6 Section Detail - Pipe/Conduit Seal @ CMU  
1 : 5

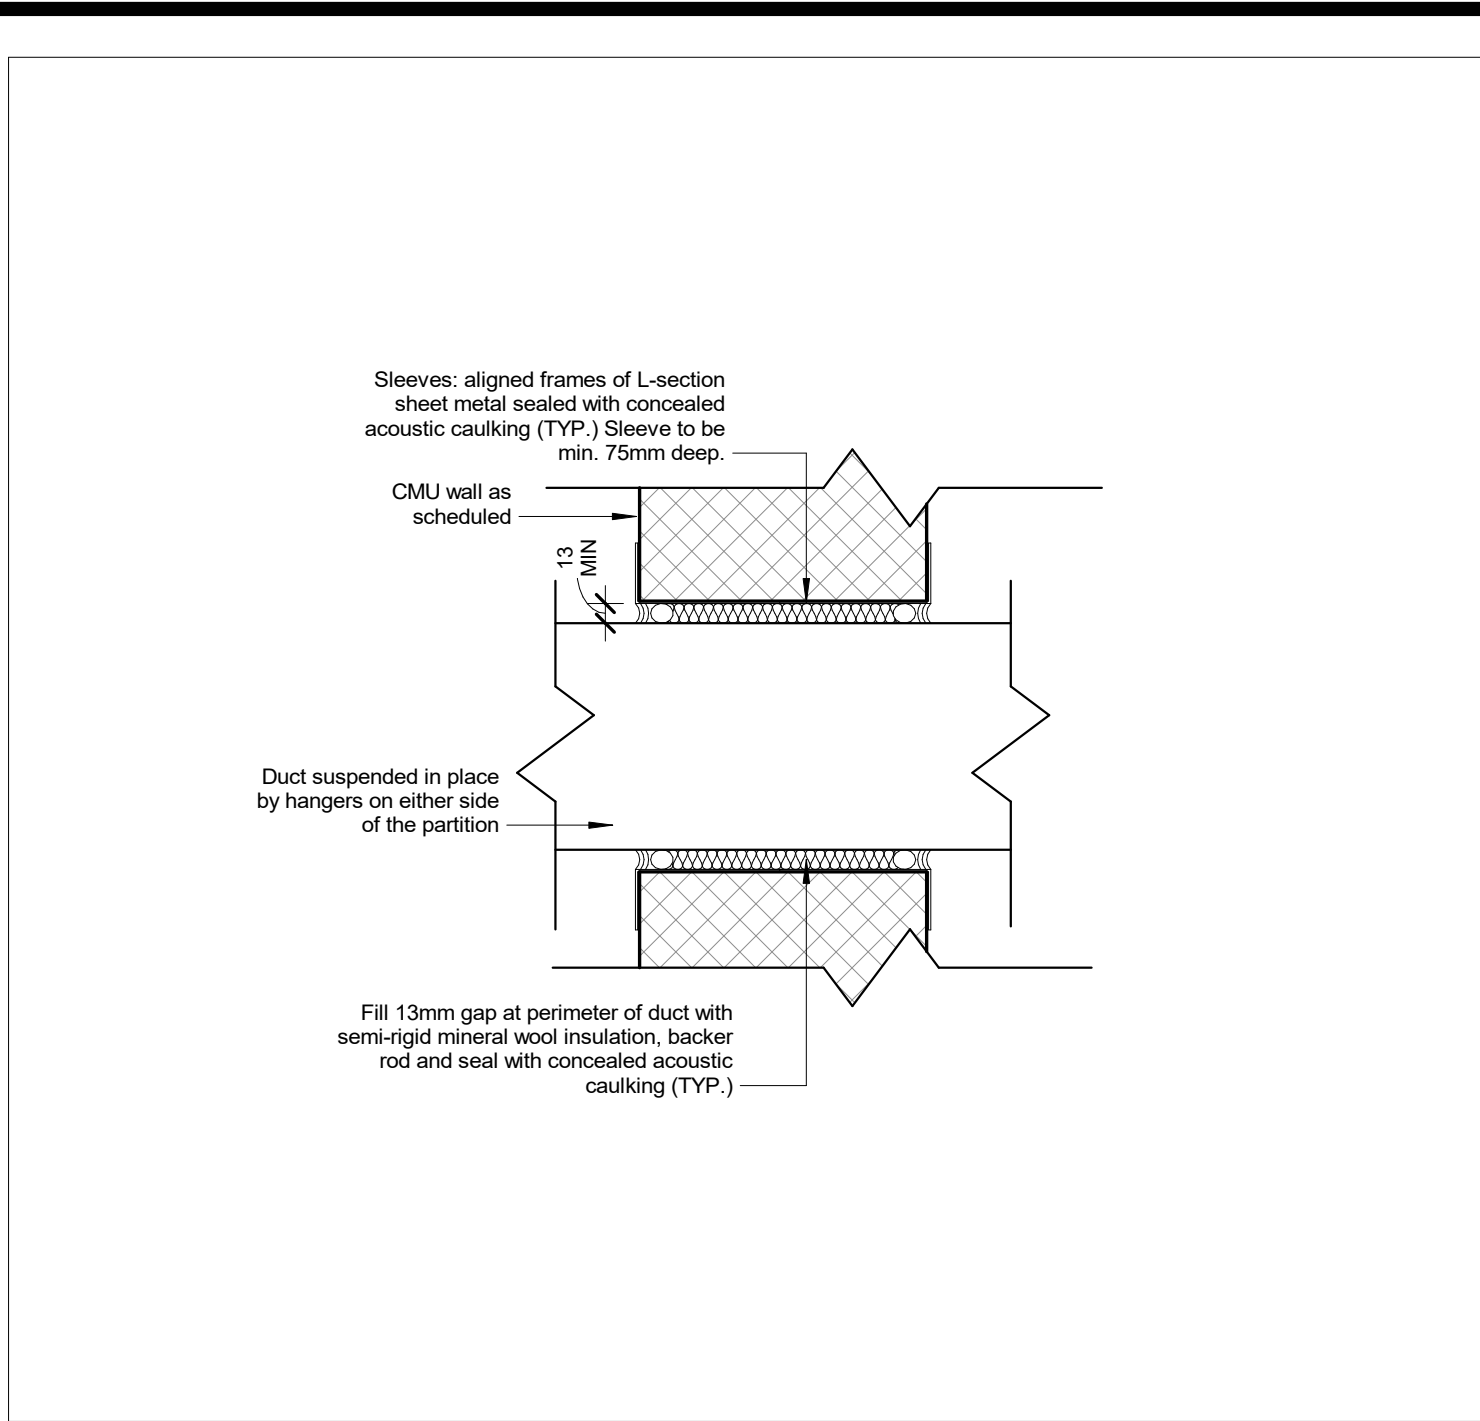

5 Section Detail - Duct Deal @ CMU  
1 : 5

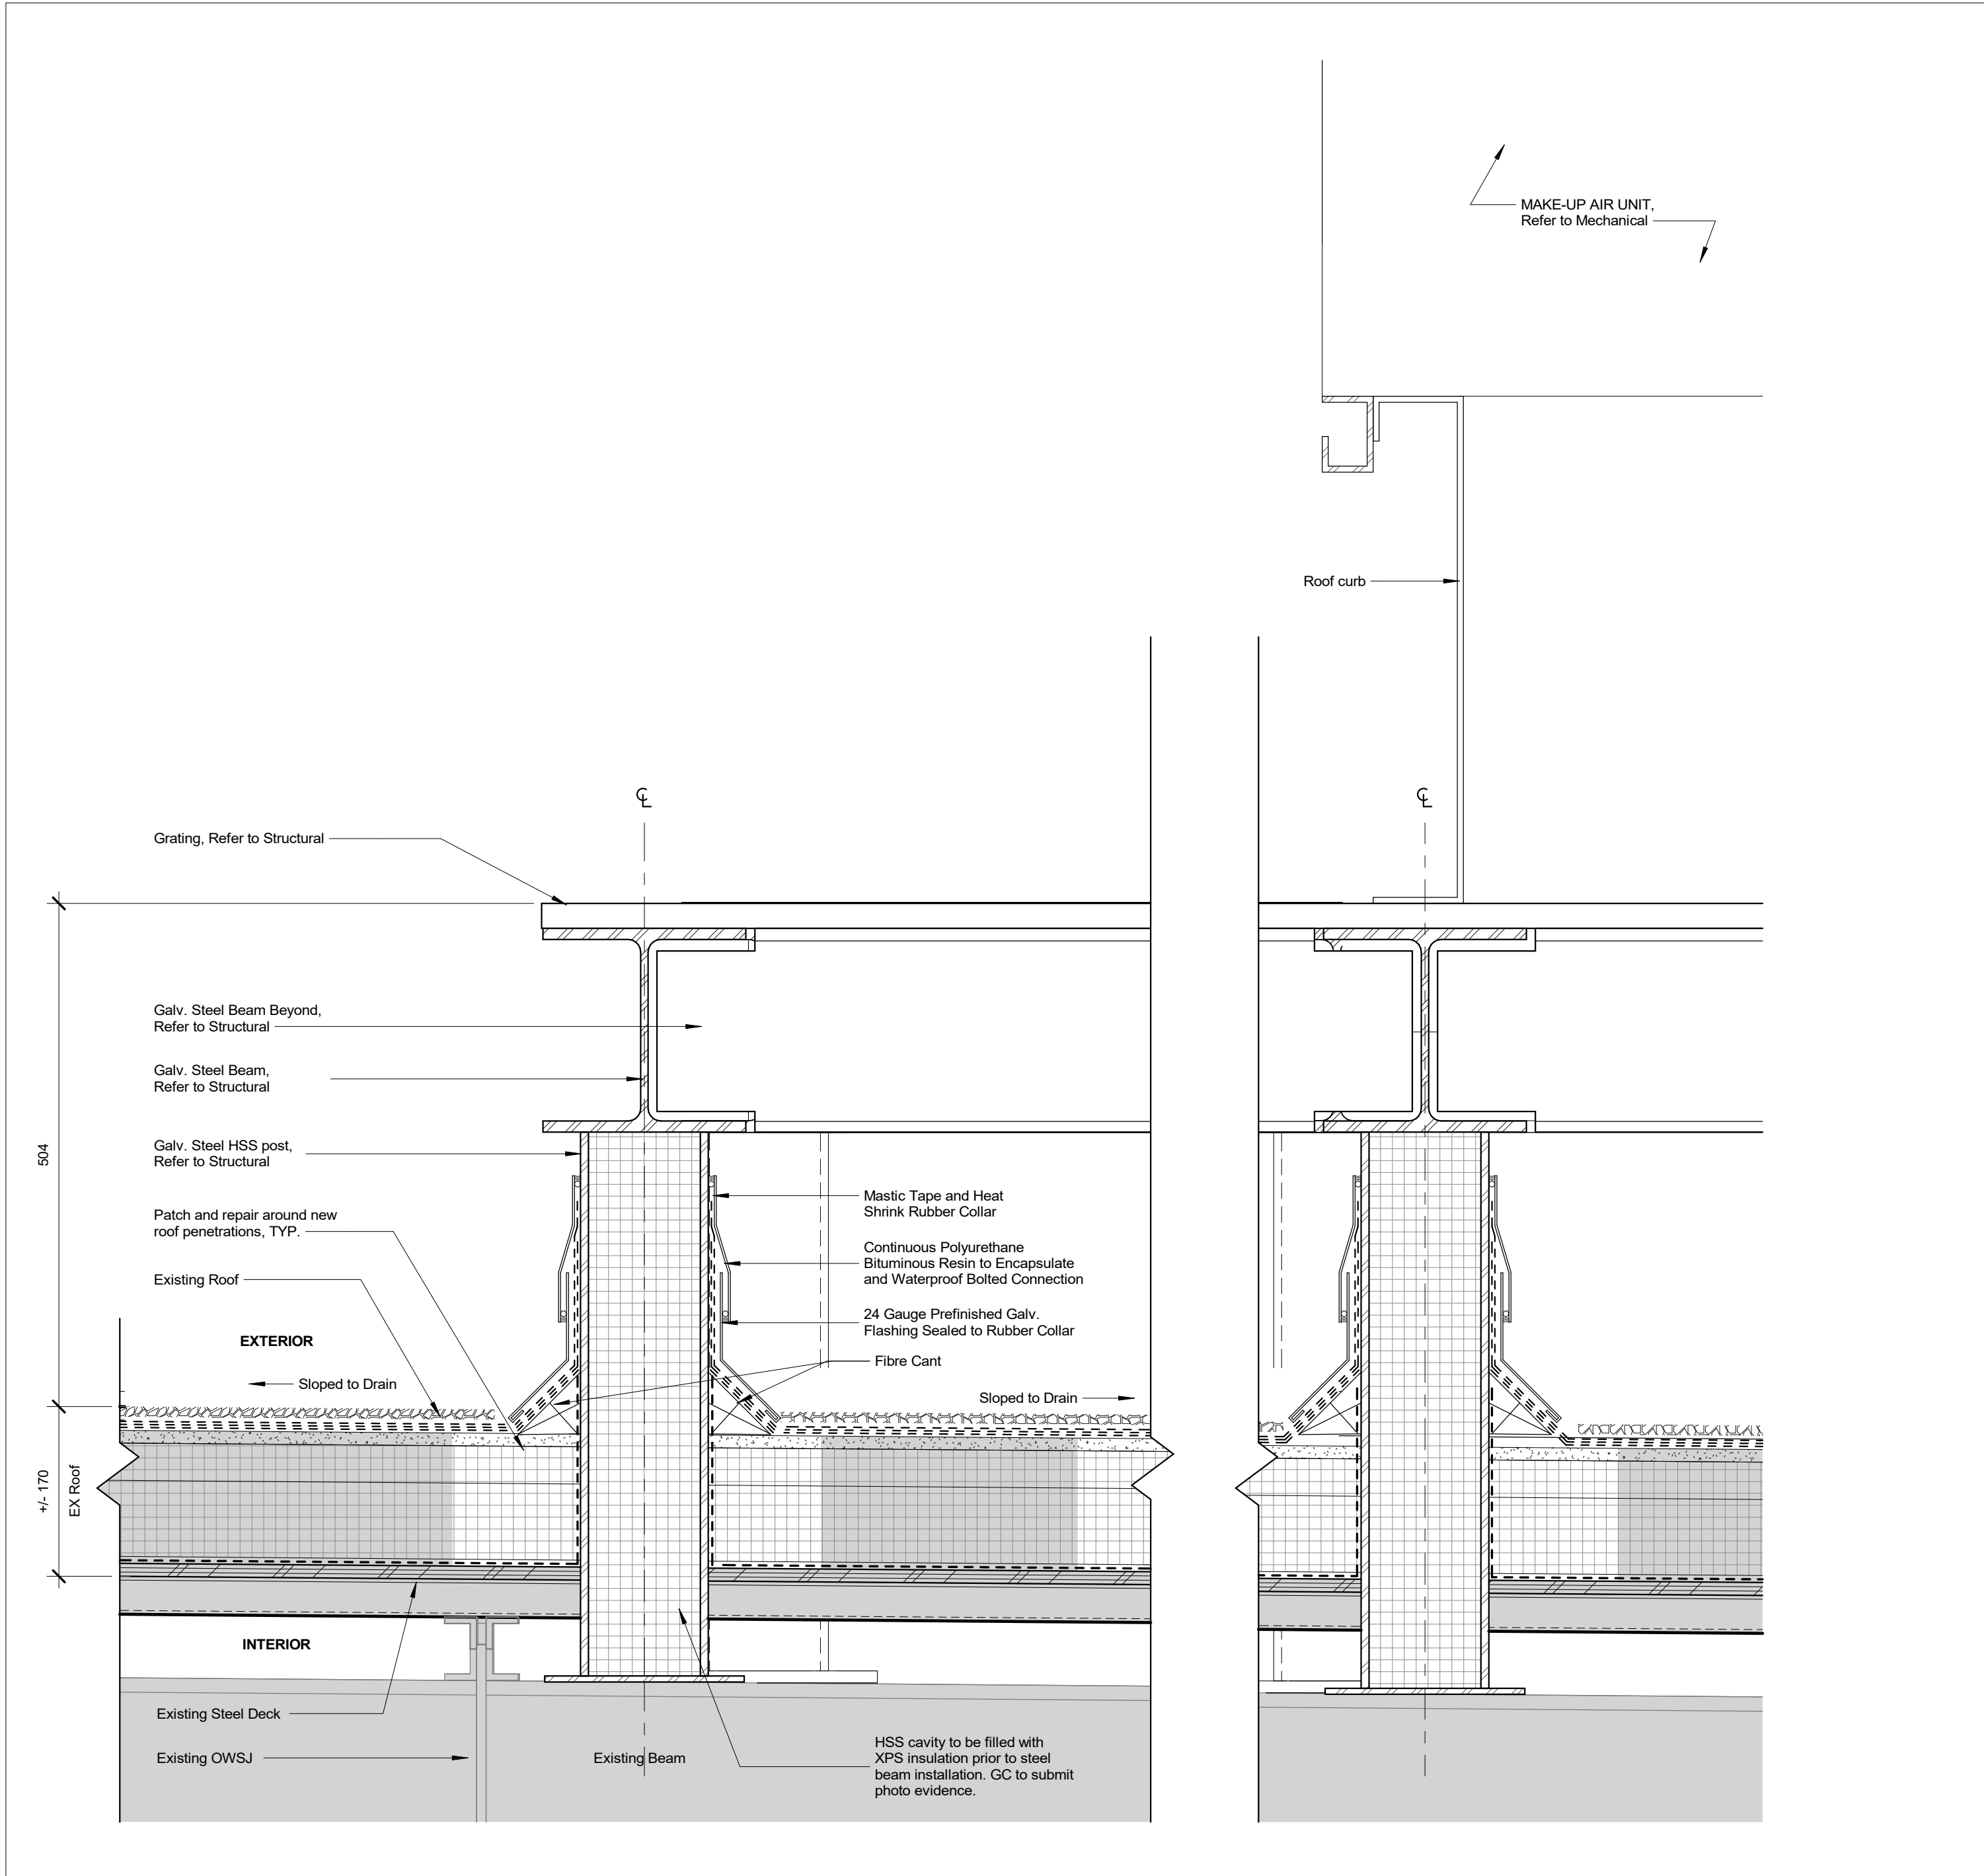

1 Typical Section Detail - Roof Platform and MUA Curb  
1 : 5

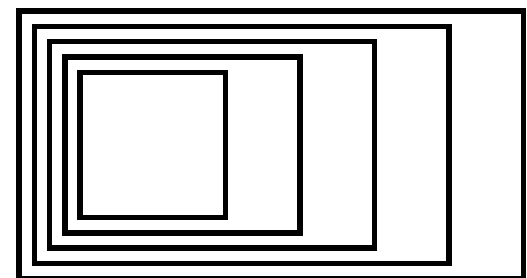

## GOW HASTINGS ARCHITECTS

275 SPADINA ROAD  
TORONTO ONTARIO M5R 2Y3  
416-920-0031  
GOWHASTINGS.COM

ALL DRAWINGS, SPECIFICATIONS, RELATED DOCUMENTS AND DESIGN ARE THE COPYRIGHT PROPERTY OF THE ARCHITECT AND MAY BE RE-USED UPON REQUEST. REPRODUCTION OF THE DRAWINGS, SPECIFICATIONS, RELATED DOCUMENTS AND DESIGN IN WHOLE OR IN PART IS STRICTLY FORBIDDEN WITHOUT THE ARCHITECT'S WRITTEN PERMISSION. THIS DRAWING SHALL NOT BE USED FOR CONSTRUCTION PURPOSES UNLESS COUNTERSIGNED.

2 Issued for Permit & Tender 10/31/2025  
1 Issued for 90% CD - Client Review 10/09/2025

No.	ISSUED/REVISED	DATE

Henry St H.S.  
Culinary Classroom Renovation

600 Henry St, Whitby, ON L1N 1L4


### Exterior Section Details and Typical Details

Scale: 1 : 5

Project Number:  
25-102




# A502

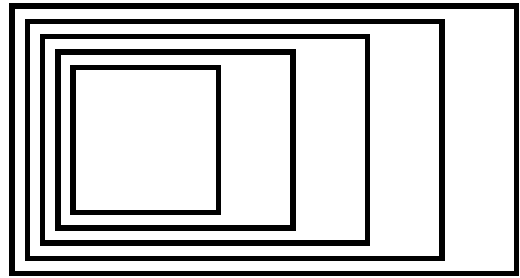

GOW HASTINGS  
ARCHITECTS

275 SPADINA ROAD  
TORONTO ONTARIO M5R 2Y3  
416-920-0031  
GOWHASTINGS.COM

ALL DRAWINGS, SPECIFICATIONS, RELATED DOCUMENTS AND DESIGN ARE THE COPYRIGHT PROPERTY OF THE ARCHITECT AND MAY BE RE-USED UPON REQUEST. REPRODUCTION OF THE DRAWINGS, SPECIFICATIONS, RELATED DOCUMENTS AND DESIGN IN WHOLE OR IN PART IS STRICTLY FORBIDDEN WITHOUT THE ARCHITECT'S WRITTEN PERMISSION. THIS DRAWING SHALL NOT BE USED FOR CONSTRUCTION PURPOSES UNLESS COUNTERSIGNED.

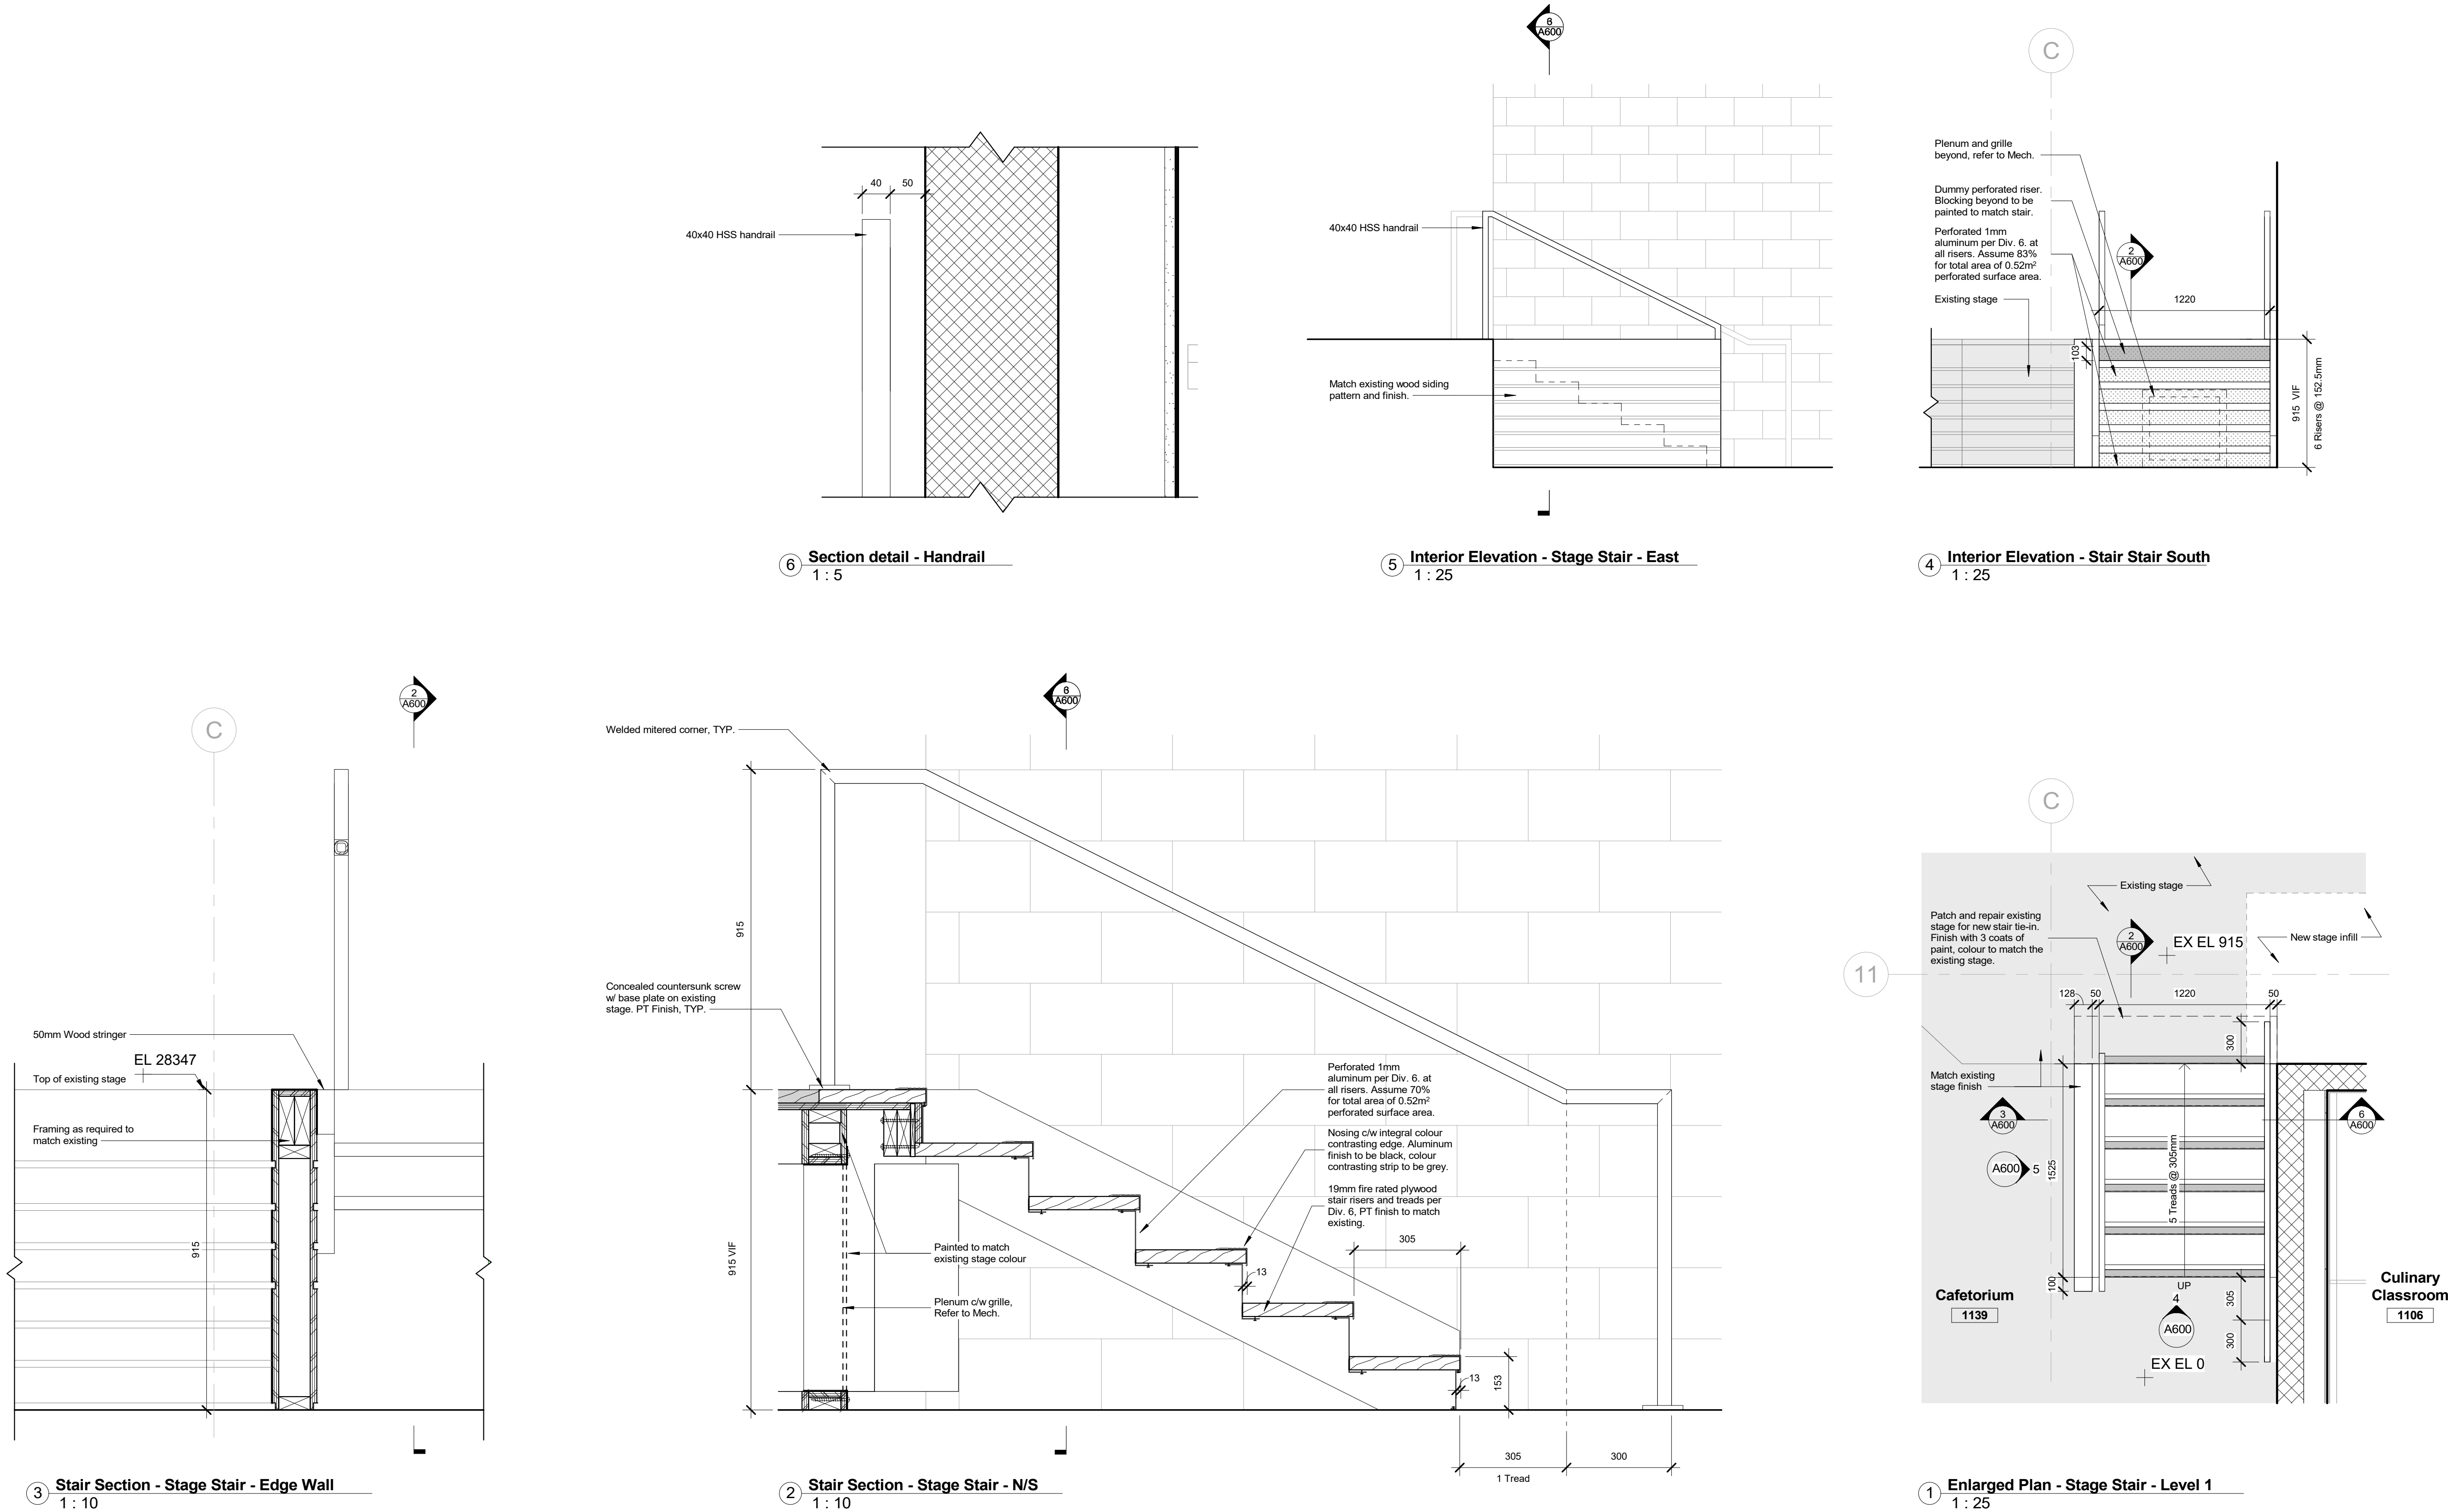

2	Issued for Permit & Tender	10/31/2025
1	Issued for 90% CD - Client Review	10/09/2025

No.	ISSUED/REVISED	DATE
-----	----------------	------

Henry St H.S.  
Culinary Classroom Renovation

600 Henry St, Whitby, ON L1N 1L4


Stage Stair

Scale: As indicated

Project Number:  
25-102



A600

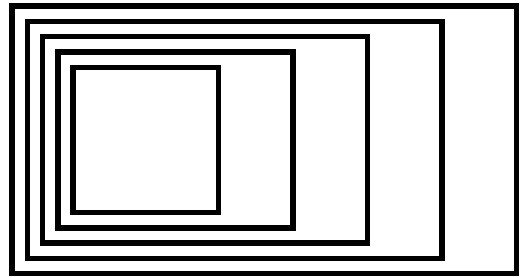

GOW HASTINGS  
ARCHITECTS

275 SPADINA ROAD  
TORONTO ONTARIO M5R 2V3  
416-920-0031  
GOWHASTINGS.COM

ALL DRAWINGS, SPECIFICATIONS, RELATED DOCUMENTS AND DESIGN ARE THE COPYRIGHT PROPERTY OF THE ARCHITECT AND MAY BE RE-USED UPON REQUEST. REPRODUCTION OF THE DRAWINGS, SPECIFICATIONS, RELATED DOCUMENTS AND DESIGN IN WHOLE OR IN PART IS STRICTLY FORBIDDEN WITHOUT THE ARCHITECT'S WRITTEN PERMISSION. THIS DRAWING SHALL NOT BE USED FOR CONSTRUCTION PURPOSES UNLESS COUNTERSIGNED.

FINISHES SYMBOLS LEGEND

1t Floor Finish Tag

FLOOR FINISHES LEGEND

Safety Flooring (SF)

Wood Flooring (WD)

Terrazzo (TER) - Match existing  
Vinyl Composition Tile (VCT)

Floor Base  
SF1 - Safety Flooring Cove Base  
RB - Rubber Base

Note: Pattern is to show extent only and does not represent the actual layout.

WALL FINISHES LEGEND

CER# (Ceramic Tiles)  
Refer to interior elevation for colours, TYP

FLM# (Glazing Film)  
Refer to interior elevation for colours, TYP

HWP# (Hygienic Wall Panel)  
Refer to interior elevation for colours, TYP

SS1 (Stainless Steel)  
Refer to Food Service Drawings for all SS finish, TYP

2 Issued for Permit & Tender 10/31/2025  
1 Issued for 90% CD - Client Review 10/09/2025

No. ISSUED/REVISED DATE

Henry St H.S.  
Culinary Classroom Renovation

600 Henry St, Whitby, ON L1N 1L4

Finishes Plan

Project North

Scale: As indicated


Project Number:  
25-102



A700

NOTE: This drawing is to be viewed in colour.

Room Finish Schedule												
Number	Name	Floor Finish	Base Finish	Ceiling Finish	North Wall Material	North Wall Finish	East Wall Material	East Wall Finish	South Wall Material	South Wall Finish	West Wall Material	West Wall Finish
1100	Corridor	TER	-	PT1	-	-	-	-	-	-	EX CMU, SC1	CER, FLM
1100B	AV Room	VCT1	RB	ACT	CMU	PT1	EX CMU	PT1	CMU	PT1	EX CMU	PT1
1106	Culinary Classroom	SF1	SF1	PT1	CMU	HWP, CER	CMU	HWP, CER	CMU	SS, CER	CMU	HWP, CER
1106B	Closet	SF1	RB	PT1	CMU	PT1	EX CMU	PT1	CMU	PT1	EX CMU	HWP1
1142	Office	EX VCT	RB	ACT	EX CMU	PT1	EX CMU	PT1	EX CMU	PT1	CMU	PT1

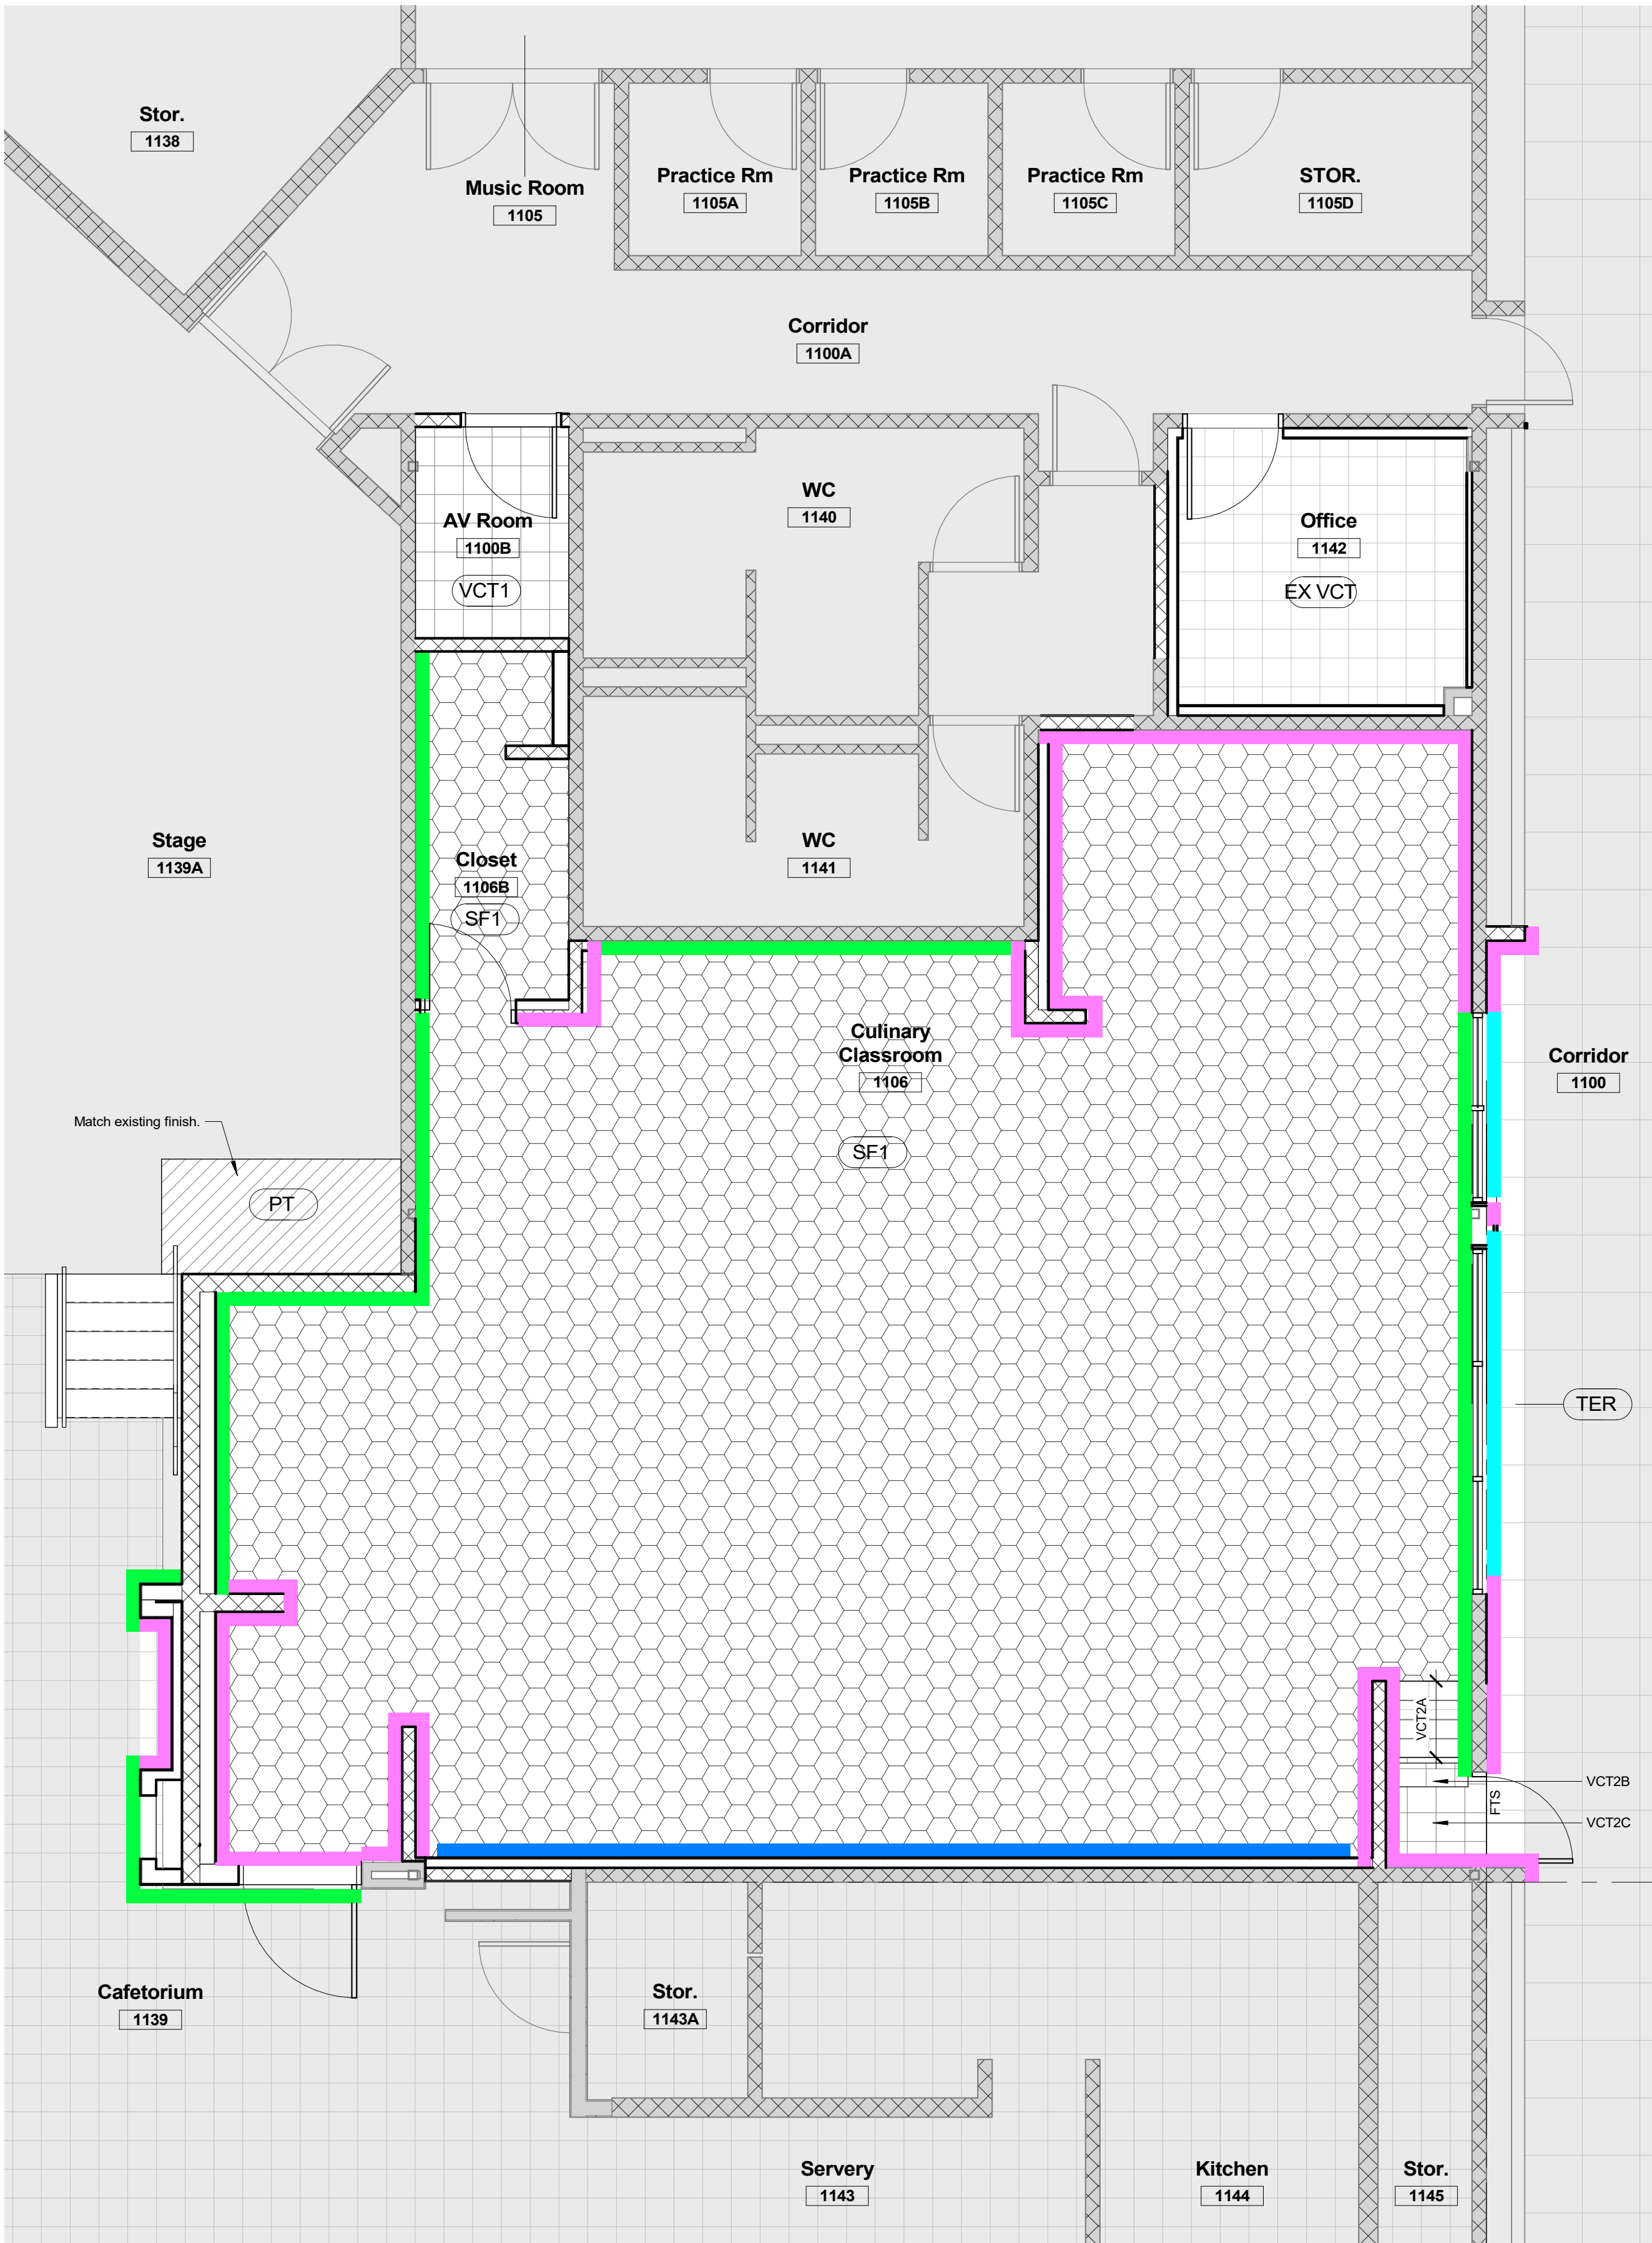

1 Finishes Plan - Level 1  
1 : 50