LIGHTING	LEGEND		EXISTING DEVICES ARE TONED :	
	2' x 2'		P# COLUMINAIRE - RECESSED, CEILING,	
	1' x 4'	RELOCATED PC	USPENDED (NEW or EXISTING IN SITION)	
	2' x 4'	DIAGO	DNAL DENOTES BASE BUILDING FIXTURE	
	EXISTING BASE BUIL	LDING LUMINAIRE	TO REMAIN	
	EXISTING BASE BUIL	LDING LUMINAIRE	TO BE REMOVED	
	LUMINAIRE - WALL N	MOUNTED		
0	LUMINAIRE - RECES	SED OR CEILING I	MOUNTED DOWNLIGHT	
	SINGLE HEAD			
00	DOUBLE HEAD	-   MULTI-HEAD - R	ECESSED OR CEILING MOUNTED	
000	TRIPLE HEAD	1		
	LUMINAIRES - WALL	MOUNTED		
	LUMINAIRE - WALL WASHER/ ADJUSTABLE LUMINAIRE			
 	LUMINAIRE - STEP LIGHT			
<u> </u>	LUMINAIRE - SUSPENDED / PENDANTS		3	
$\bigcirc$	POLE MOUNTED LUI	MINAIRE		
<u> </u>	ILLUMINATED BOLLA			
	LINEAR TRACK c/w T	TRACK HEADS. QU		
<u>                                      </u>	HEADS AS PER LUM DENOTES LUMINAIR			
NL NLO	COVE, UNDERCABIN	NET, AND/OR INTE	GRATED LINEAR LIGHTING STRIP.	
A BO	LUMBIAIDE DECICAL	LENGTH TO BE FIELD MEASURED.  LUMINAIRE DESIGNATOR LETTER DENOTES TYPE.		
	REFER TO LUMINAIF			
T 4	1			
T 4	CEILING MOUNTED	-	REMOTE LIGHTING HEAD. HEADS AS INDICATED.	
<b>T</b>			False DEMOTE LIGHTING LIFADS	
EMERGENCY LIGHTING BATTERY UNIT c/w REMOTE LIGHTING HEADS.  TAG # INDICATES CIRCUITING FOR REMOTE HEADS.				
BU-# BŪ-# EXIT SIGNS:	t TAG # INDICATES C		LINOTE HEADO.	
<ul><li>⊘t ∅ 1⊗</li></ul>	CEILING MOUNTED			
1 <b>2</b> 1	END MOUNTED		EXIT SIGN MOUNTEDING AS INDICATED. DIRECTION AS	
$\overline{\Diamond}$	WALL MOUNTED		INDICATED.	
<u> </u>	WALL MOUNTED WI	TH REMOTE HEAD	S/INTEGRATED BATTERY AS NOTED.	
<u> </u>	- "		KIT SIGN TYPE WHERE MULTIPLE TYPES ARE USED.	
SWITCHES AN	REFER TO LUMINAII D SENSORS:	RE SCHEDULE.		
-	DENOTES SWITCH.	TAG '#' INDICATES	SWITCH TYPE/ACCESSORIES.	
\$#	'3' - 3-WAY '4' - 4-WAY	'E	" - FAN SWITCH BY DIVISION16 8' - MOTORIZED BLINDS SS' - DRO JECTION SCREEN	
ι π	'K' - KEY 'M' - MASTER 'S' - VARIABLE SPEE	'(	'S' - PROJECTION SCREEN DR' - OVERRIDE	
	DENOTES DIMMER S		DICATES SWITCH TYPE/ACCESSORIES.	
Ф#	'3' - 3-WAY DIMMER '4' - 4-WAY DIMMER 'I V' - I OW VOI TAGE	'3' - 3-WAY DIMMER '4' - 4-WAY DIMMER		
<u> </u>		'LV' - LOW VOLTAGE DIMMER  DENOTES SWITCH GANGED UNDER COMMON COVERPLATE (2, 3 & 4 SHOWN)		
<del>п ш ш</del> \$#	OCCUPANCY SENSO		/	
Ψ#  \$]#	LOW VOLTAGE SWIT			
<u>++</u> ***********************************	ALTERNATE VOLTAGE			
 \$#	WIRELESS SWITCH	- ( • )		
₽# ●# <b>₽</b> #	CEILING or WALL MC			
	CEILING or WALL MO	DUNTED DAY LIGH	T SENSOR.	
	PHOTOCELL	JHI SENSOR TYP	<u>=.</u>	
	TIME SWITCH			
	VARIABLE SPEED SI	WITCH		
	VAINABLE SPEED SI	🕠		


ELECTRICAL DRAWING LIST		
DWG. NO.	DRAWING TITLE	
E-001	ELECTRICAL LEGEND AND DRAWING LIST	
ED-201	FIRST FLOOR - DEMOLITION PLAN	
ED-202	ROOF - DEMOLITION PLAN	
E-201	FIRST FLOOR - REFLECTED CEILING PLAN	
E-301	FIRST FLOOR - POWER & SYSTEMS PLAN	
E-302	ROOF- POWER & SYSTEMS PLAN	
E-501	SINGLE LINE DIAGRAM - DEMO & NEW	
E-601	FIRE ALARM RISER	
E-801	ELECTRICAL DETAILS	

MONTH   MON	ELECTRICAL I	EGEND EXISTING DEVICES ARE TONED :	MISCELLAN	NEC
■ SERVIT PRESE PRINCE DIRECT CONNECTION     ■ COOK, SHREEP P	<b>⊘</b>	120V, SINGLE PHASE DIRECT CONNECTION	$\otimes$	
Own Windle Prode Direct Connection  Own There Prodes Direct Conne		208V, SINGLE PHASE DIRECT CONNECTION	$\otimes$	
SOUTH THESE PRIMES DIRECT CONNECTION  ONLY, THREE PRIMES DIRECT CONNECTION - VIOLAGE AS NOTED  U.Y, SINGLE PRIMES DIRECT CONNECTION - VIOLAGE AS NOTED  U.Y, SINGLE PRIMES DIRECT CONNECTION - VIOLAGE AS NOTED  U.Y, SINGLE PRIMES DIRECT CONNECTION - VIOLAGE AS NOTED  U.Y, SINGLE PRIMES DIRECT CONNECTION - VIOLAGE AS NOTED  U.Y, SINGLE PRIMES DIRECT CONNECTION DOX OR PULL BOX  S. SINGLE PRIMES DIRECT CONNECTION DOX OR PULL BOX  S. SINGLE PRIMES DIRECT CONNECTION DOX OR PULL BOX  S. SINGLE PRIMES DIRECT CONNECTION DOX OR PULL BOX  S. SINGLE PRIMES DIRECT CONNECTION DOX OR PULL BOX  S. SINGLE PRIMES DIRECT CONNECTION DOX OR PULL BOX  S. SINGLE PRIMES DIRECT CONNECTION DOX OR PULL BOX  S. SINGLE PRIMES DIRECT CONNECTION DOX OR PULL BOX  S. SINGLE PRIMES DIRECT CONNECTION DOX OR PULL BOX  S. SINGLE PRIMES DIRECT CONNECTION DOX OR PULL BOX  S. SINGLE PRIMES DIRECT CONNECTION DOX OR PULL BOX  S. SINGLE PRIMES DIRECT CONNECTION DOX OR PULL BOX  S. SINGLE PRIMES DIRECT CONNECTION DOX OR PULL BOX  S. SINGLE PRIMES DIRECT DOX DIRECT DOX ON DOX DIRECT D	<b>(A)</b>	208V, THREE PHASE DIRECT CONNECTION		-
### STATES PARASE DIRECT CONNECTION - VOLTAGE AS NOTED  ### OSCOMECT SWITCH - NUMERISHED  ### CECTROL PARASE REGARD - PECESSEED  ### OUTLITY PARASE CREATER SHE FIRE, COMMS 4kg - SUFFACE MOUNTED  ### CONTROL PARASE REGARD - PECESSEED  ### LOOSE MOTOR STANTER  ### OUTLITY PARASE CREATER SHE FIRE, COMMS 4kg - SUFFACE MOUNTED  ### OUTLITY PARASE CREATER SHE FIRE, COMMS 4kg - SUFFACE MOUNTED  ### OUTLITY PARASE CREATER SHE FIRE, COMMS 4kg - SUFFACE MOUNTED  ### OUTLITY PARASE CREATER SHE FIRE, COMMS 4kg - SUFFACE MOUNTED  ### OUTLITY PARASE CREATER SHE FIRE, COMMS 4kg - SUFFACE MOUNTED  ### OUTLITY PARASE CREATER SHE FIRE, COMMS 4kg - SUFFACE MOUNTED  ### OUTLITY PARASE CREATER SHE FIRE MOUNTED SHE MOUNTED SHE MOUNTED  ### OUTLITY PARASE CREATER SHE FIRE MOUNTED SHE MOUNTED SHE MOUNTED SHE MOUNTED  ### OUTLITY PARASE CREATER SHE FIRE MOUNTED SHE MOUNTED SHE MOUNTED  ### OUTLITY PARASE CREATER SHE FIRE MOUNTED SHE MOUNTED SHE MOUNTED  ### OUTLITY PARASE CREATER SHE FIRE MOUNTED SHE MOUNTED  ### OUTLITY PARASE CREATER SHE FIRE MOUNTED SHE MOUNTED  ### OUTLITY PARASE CREATER SHE FIRE MOUNTED SHE MOUNTED  ### OUTLITY PARASE CREATER SHE FIRE MOUNTED SHE MOUNTED  ### OUTLITY PARASE CREATER SHE MOUNTED SHE MOUNTED SHE MOUNTED  ### OUTLITY PARASE CREATER SHE MOUNTED SHE MOUNTED  ### OUTLITY PARASE C		600V, SINGLE PHASE DIRECT CONNECTION	DWG. E-XX	-
United Phase Prince Pr	٥	600V, THREE PHASE DIRECT CONNECTION		
DURING TOWNS TO ANY THE AND ADDRESS AND THE AS INDICATED.  DURING TOWNS TO CONTROL SUR TOWNS TO CONTROL SUR THAT ADDRESS AND THE ASSESSMENT OF THE ADDRESS AND THE ADDRESS A		V, SINGLE PHASE DIRECT CONNECTION - VOLTAGE AS NOTED		
DISCONNECT SWITCH - FUSED  DISCONNECT SWITCH - BUS PLUIS  WARRALE PRESCUENTS BURNAN BOX DAY PAUL HOS  SILECTRICAL PARKELEDARISM REPRESCUENTS BURNAN BOX DAY PAUL HOS  SILECTRICAL PARKELEDARISM REPRESCUENTS BURNAN BOX DAY PAUL HOS  UTILITY PARKELEDARISM REPRESCUENTS BURNAN BOX DAY PAUL HOS BOX DAY  UTILITY PARKELEDARISM REPRESCUENTS BURNAN BOX DAY PAUL HOS BOX DAY  UTILITY PARKELEDARISM REPRESCUENTS BURNAN BOX DAY PAUL HOS BOX DAY  UTILITY PARKELEDARISM REPRESCUENTS BURNAN BOX DAY PAUL HOS BOX DAY  UTILITY PARKELEDARISM REPRESCUENTS BURNAN BOX DAY PAUL HOS BOX DAY  UTILITY PARKELEDARISM REPRESCUENTS BURNAN BOX DAY DAY BURNAN BOX DAY DAY  UTILITY PARKELEDARISM REPRESCUENTS BURNAN BOX DAY DAY BURNAN BOX DAY DAY BURNAN BOX DAY BURNAN BOX DAY BURNAN BOX DAY BURNAN BOX DAY BURNAN BOX DAY BURNAN BOX DAY BURNAN BOX DAY DAY BURNAN BOX DAY BURNAN	<b>4</b>	V, THREE PHASE DIRECT CONNECTION - VOLTAGE AS NOTED		
DISCONSECT SWITCH - SURPO  BISCONSECT SWITCH - SURPO  DISCONSECT SWITCH - SURPO  DISCONSECT SWITCH - SURPO  DISCONSECT SWITCH - SURPO  DISTRIBUTION DOX. 19 DISCONSE SUNCTION DOX OR PULL BOX  DISTRIBUTION DOX. 19 DISCONSE SURPORTON DOX OR PULL BOX  DISTRIBUTION DOX. 19 DISCONSE SURPORTON DOX OR PULL BOX  DISTRIBUTION DOX. 19 DISCONSE SURPORTON DOX OR PULL BOX  DISTRIBUTION DOX. 19 DISCONSE SURPORTON DOX OR PULL BOX  DISTRIBUTION DOX. 19 DISCONSE SURPORTON DOX OR PULL BOX  DISTRIBUTION DOX 19 DISCONSE SURPORTON DOX OR PULL BOX  DISTRIBUTION DOX OR SURPORT OR PURPORTON  DISTRIBUTION DOX OR SURPORT OR PURPORT OR PURPORTON  DISTRIBUTION DOX OR SURPORT OR PURPORT OR P	ㅁ	DISCONNECT SWITCH - NON-FUSED		
DISTRIBUTION ROX OF PRINTERS AUSTRON ROX OR PULL ROX	짭	DISCONNECT SWITCH - FUSED	DP-XXXX —	
### TO DEPORTS BLANK BOX  ### CARRABLE PROCESSOR DEVICE  ### CLECTRICAL PANELBOARD - SUPFACE MOUNTED  ### CLECTRICAL PANELBOARDET (IN FIRE, COMMS 40) - RECESSED  ### CLECTRICAL PANELBOARDET (IN FIRE, COMMS 40) - RECESSED  ### CLECTRICAL PANELBOARDET (IN FIRE, COMMS 40) - RECESSED  ### CLECTRICAL PANELBOARDET (IN FIRE, COMMS 40) - RECESSED  ### CLOOSE GOTOR STATER  ### CONTACTOR  ### COMMS FORMER - SUBPENDED, GIZE AND TYPE AS INDICATED.  ### COMMS FORMER - SUBPENDED, GIZE AND TYPE AS INDICATED.  ### PLASH BUTTON STATION  ### PLASH BUTTON STATION  ### PLASH BUTTON STATION  ### DUPLEX - CAMAG RECEPTACLE - CELLING MOUNTED S-SIR UNLESS NOTED  ### DUPLEX - CAMAG RECEPTACLE - CELLING MOUNTED S-SIR UNLESS NOTED  ### DUPLEX - CAMAG RECEPTACLE - S-SIR UNLESS NOTED  ### DUPLEX - CAMAG RECEPTACLE - S-SIR UNLESS NOTED  ### DUPLEX - CAMAG RECEPTACLE - S-SIR UNLESS NOTED  ### DUPLEX - CAMAG RECEPTACLE - S-SIR UNLESS NOTED  ### DUPLEX - CAMAG RECEPTACLE - S-SIR UNLESS NOTED  ### DUPLEX - CAMAG RECEPTACLE - S-SIR UNLESS NOTED  ### DUPLEX - CAMAG RECEPTACLE - S-SIR UNLESS NOTED  ### SINGLE PROTECTION RECEPTACLE - S-SIR UNLESS NOTED  ### SIN		DISCONNECT SWITCH - BUS PLUG	MISCELLAN	NEC
ELECTRICAL PANELSCARD - SURPACE MOUNTED  ELECTRICAL PANELSCARD - RECESSED  UTILITY PANELSCARD	JB		<u> </u>	
ELECTRICAL PANELCOARD - RECESSED  ED UTILITY PANELCABINET (6- FIRE, COMMS 616.) - SUPFACE MOUNTED  EVERY LOSSE COMMS MICH 76- FIRE, COMMS 616.) - RECESSED  © LOSSE MOTOR STATTER  © LOSSE MOTOR STATTER  © LOSSE MOTOR STATTER  © TRANSFORMER - SUBPENDED, SIZE AND TYPE AS INDICATED.  © TRANSFORMER - SUBPENDED, SIZE AND TYPE AS INDICATED.  © TRANSFORMER - SUBPENDED, SIZE AND TYPE AS INDICATED.  © PUSH BUTTOR STATON  © DUPLEX, 1-GANG RECEPTAGLE - 5-58 UNLESS NOTED  © DUPLEX, 1-GANG RECEPTAGLE - 5-58 UNLESS NOTED  © DUPLEX, 1-GANG RECEPTAGLE - 5-58 UNLESS NOTED  © DUPLEX, 1-GANG RECEPTAGLE - 5-19 UNLESS NOTED  © DUPLEX, 1-GANG RECEPTAGLE - 5-19 UNLESS NOTED  © SINGLE RECEPTAGLE - 7-10 UN MOUNTED.  © SINGLE RECEPTAGLE - 7-10 UNLESS NOTED  © SINGLE RECEPTAGLE - 7-10 UNLESS	VFD	VARIABLE FREQUENCY DRIVE	<del></del> ə	
UTILITY PANEL CABNET (w. FIRE, COMMS etc.) - SURFACE MOUNTED  UTILITY PANEL CABNET (w. FIRE, COMMS etc.) - RECESSED  UDOSE COMBINATION MOTOR STARTER  LOOSE MOTOR STARTER  UTILITY PANEL CABNET (w. FIRE, COMMS etc.) - RECESSED  TRANSFORMER - FLOOR MOUNTED SIZE AND TYPE AS INDICATED.  TRANSFORMER - RUSPENDED SIZE AND TYPE AS INDICATED.  TRANSFORMER - RUSPENDED SIZE AND TYPE AS INDICATED.  TRANSFORMER - RUSPENDED SIZE AND TYPE AS INDICATED.  THE MERCENCY POWER SHUTOPY PURHBUTTON  DUPLEX - GANCA RECEPTACLE - SISE UNLESS NOTED  SINGLE RECEPTACLE - SISE UNLESS NOTED  DUPLEX - GANCA RECEPTACLE - SISE UNLESS NOTED  SINGLE RECEPTACLE - SISE UNLESS NOTED  SISE OF SISE UNLESS NOTED  GROUND FOR THIS SINGLE RECEPTACLE - SISE UNLESS NOTED  SISE OF SISE UNLESS NOTED  GROUND FOR THIS SINGLE RECEPTACLE - SISE UNLESS NOTED  SISE OF SISE UNLESS NOTED  GROUND FOR THIS SINGLE RECEPTACLE - SISE ON MOUNTED.  SISE OF SISE ON		ELECTRICAL PANELBOARD - SURFACE MOUNTED		
UTILITY PANELACAGINET (w. PIRE, COMMS wo) RECESSED  □ LOOSE COMBINATION MOTOR STARTER  □ LOOSE MOTOR STARTER □ COMMACTOR □ TRANSPORMER - FLOOR MOUNTED. SIZE AND TYPE AS INDICATED. □ TRANSPORMER - SUSPENDED SIZE AND TYPE AS INDICATED. □ TRANSPORMER - SUSPENDED SIZE AND TYPE AS INDICATED. □ PURS BUTTOR STATION □ PURS BUTTOR STATION □ DUPLEX - GANG RECEPTACLE - SISE UNLESS NOTED □ DUPLEX - GANG RECEPTACLE - FLOOR MOUNTED. SISE UNLESS NOTED □ DUPLEX - GANG RECEPTACLE - FLOOR MOUNTED. SISE UNLESS NOTED □ DUPLEX - GANG RECEPTACLE - FLOOR MOUNTED. SISE UNLESS NOTED □ DUPLEX - GANG RECEPTACLE - FLOOR MOUNTED. SISE UNLESS NOTED □ SINGLE RECEPTACLE - SISE UNLESS NOTED □ SINGLE RECEPTACLE - SISE UNLESS NOTED □ SINGLE RECEPTACLE - FLOOR MOUNTED. SISE UNLESS NOTED □ SINGLE RECEPTACLE - FLOOR MOUNTED. SISE UNLESS NOTED □ SINGLE RECEPTACLE - FLOOR MOUNTED. SISE UNLESS NOTED □ SINGLE RECEPTACLE - FLOOR MOUNTED. SISE UNLESS NOTED □ SINGLE RECEPTACLE - FLOOR MOUNTED. SISE UNLESS NOTED □ SINGLE RECEPTACLE - FLOOR MOUNTED. SISE UNLESS NOTED □ SINGLE RECEPTACLE - FLOOR MOUNTED. SISE UNLESS NOTED □ SINGLE RECEPTACLE - FLOOR MOUNTED. SISE UNLESS NOTED □ SINGLE RECEPTACLE - FLOOR MOUNTED. SISE UNLESS NOTED □ SINGLE RECEPTACLE - FLOOR MOUNTED. □ SINGLE RECEPTACLE - FLOO		ELECTRICAL PANELBOARD - RECESSED	— — · SR · — —	-
DUPLEX 1-GANG RECEPTACIE - FLOOR MOUNTED SIZE AND TYPE AS INDICATED.  □ CONTACTOR  □ TRANSPORMER - FLOOR MOUNTED. SIZE AND TYPE AS INDICATED.  □ TRANSPORMER - FLOOR MOUNTED. SIZE AND TYPE AS INDICATED.  □ PUSH BUTTON STATION  □ PUSH BUTTON STATION  □ DUPLEX 1-GANG RECEPTACIE - CEILING MOUNTED. 5-15R UNLESS NOTED  □ DUPLEX 1-GANG RECEPTACIE - FLOOR MOUNTED. 5-15R UNLESS NOTED  □ DUPLEX 1-GANG RECEPTACIE - FLOOR MOUNTED. 5-15R UNLESS NOTED  □ DUPLEX 1-GANG RECEPTACIE - FLOOR MOUNTED. 5-15R UNLESS NOTED  □ DUPLEX 1-GANG RECEPTACIE - FLOOR MOUNTED. 5-15R UNLESS NOTED  □ SINGLE RECEPTACIE - FLOOR MOUNTED. 5-15R UNLESS NOTED  □ SINGLE RECEPTACIE - FLOOR MOUNTED. 5-15R UNLESS NOTED  □ SINGLE RECEPTACIE - FLOOR MOUNTED. 5-15R UNLESS NOTED  □ SINGLE RECEPTACIE - FLOOR MOUNTED. 5-15R UNLESS NOTED  □ SINGLE RECEPTACIE - FLOOR MOUNTED. 5-15R UNLESS NOTED  □ SINGLE RECEPTACIE - FLOOR MOUNTED. 5-15R UNLESS NOTED  □ SINGLE RECEPTACIE - FLOOR MOUNTED. 5-15R UNLESS NOTED  □ SINGLE RECEPTACIE - FLOOR MOUNTED. 5-15R UNLESS NOTED  □ SINGLE RECEPTACIE - FLOOR MOUNTED. 5-15R UNLESS NOTED  □ SINGLE RECEPTACIE - FLOOR MOUNTED. 5-15R UNLESS NOTED  □ SINGLE RECEPTACIE - FLOOR MOUNTED. 5-15R UNLESS NOTED  □ SINGLE RECEPTACIE - FLOOR MOUNTED. 5-15R UNLESS NOTED  □ GROUND FAULT INTERRUPTER (GIP) RECEPTACIE - FLOOR MOUNTED  □ SINGLE RECEPTACIE - FLOOR MOUNTED. 5-15R  □ GROUND FAULT INTERRUPTER (GIP) RECEPTACIE - FLOOR MOUNTED  □ GROUND FAULT INTERRUPTER (GIP) RECEPTACIE - FLOOR MOUNTED  □ GROUND FAULT INTERRUPTER (GIP) RECEPTACIE - FLOOR MOUNTED  □ GROUND FAULT INTERRUPTER (GIP) RECEPTACIE - FLOOR MOUNTED  □ GROUND FAULT INTERRUPTER (GIP) RECEPTACIE - FLOOR MOUNTED  □ GROUND FAULT INTERRUPTER (GIP) RECEPTACIE - FLOOR MOUNTED  □ GROUND FAULT INTERRUPTER (GIP) RECEPTACIE - FLOOR MOUNTED  □ GROUND FAULT INTERRUPTER (GIP) RECEPTACIE - FLOOR MOUNTED  □ GROUND FAULT INTERRUPTER (GIP) RECEPTACIE - FLOOR MOUNTED  □ GROUND FAULT INTERRUPTER (GIP) RECEPTACIE - FLOOR MOUNTED  □ GROUND FAULT SERVED FAULT - FLOOR MOUNTED  □ GROUND FAULT SERVED FAULT -		UTILITY PANEL/CABINET (ie: FIRE, COMMS etc.) - SURFACE MOUNTED		
LOOSE MOTOR STARTER  CONTACTOR  TRANSFORMER - FLOOR MOUNTED SIZE AND TYPE AS INDICATED  TRANSFORMER - SUSPENDED RIZE AND TYPE AS INDICATED  TRANSFORMER - SUSPENDED RIZE AND TYPE AS INDICATED  THE PROPERTY POWER SHUTOP PUSHBUTTON  DUPLEX - GAMOR RECEPTACLE - STAR UNLESS NOTED  DUPLEX - GAMOR RECEPTACLE - STAR UNLESS NOTED  DUPLEX - GAMOR RECEPTACLE - CELLING MOUNTED S-19R UNLESS NOTED  DUPLEX - GAMOR RECEPTACLE - CELLING MOUNTED S-19R UNLESS NOTED  DUPLEX - GAMOR RECEPTACLE - CELLING MOUNTED S-20R UNLESS NOTED  DUPLEX - GAMOR RECEPTACLE - CELLING MOUNTED S-20R UNLESS NOTED  DUPLEX - GAMOR RECEPTACLE - CELLING MOUNTED S-20R UNLESS NOTED  SINGLE RECEPTACLE - STAR UNLESS NOTED  SINGLE RECEPTACLE - CELLING MOUNTED S-19R UNLESS NOTED  SINGLE RECEPTACLE - CELLING MOUNTED S-20R UNLESS NOTED  SINGLE RECEPTACLE - CELLING MOUNTED S-20R UNLESS NOTED  SINGLE RECEPTACLE - CELLING MOUNTED S-20R UNLESS NOTED  SINGLE RECEPTACLE - CELLING MOUNTED  GROUND FAULT INTERNUPTER (GRI) RECEPTACLE - CELLING MOUNTED  SAR UNLESS NOTED  GROUND FAULT INTERNUPTER (GRI) RECEPTACLE - CELLING MOUNTED  SAR UNLESS NOTED  DUPLEX - CAMOR RECEPTACLE - CELLING MOUNTED  SAR UNLESS NOTED  DUPLEX - CAMOR RECEPTACLE - CELLING MOUNTED  SAR UNLESS NOTED  DUPLEX - CAMOR RECEPTACLE - CELLING MOUNTED  SAR UNLESS NOTED  DUPLEX - CAMOR RECEPTACLE - CANOR  SPLIT RECEPTACLE - SAR UNLESS NOTED  DUPLEX - CAMOR RECEPTACLE - SAR UNLESS NOTED  SPLIT RECEPTACLE - SAR UNLESS NOTED  DUPLEX - CAMOR RECEPTACLE - SAR UNLESS NOTED  SPLIT RECEPTACLE - SAR UNLESS NOTED  SPLIT RECEPTACLE - SAR UNLESS NOTED  DUPLEX - CAMOR RECEPTACLE - SAR UNLESS NOTED  SPLIT RECEPTACLE - SAR UNLESS NOTED  DUPLE		UTILITY PANEL/CABINET (ie: FIRE, COMMS etc.) - RECESSED	(1.0) kW	
CONTACTOR  TRANSFORMER - FLOOR MOUNTED, SIZE AND TYPE AS INDICATED.  TRANSFORMER - SUSPENDED SIZE AND TYPE AS INDICATED.  THE PUBLIC AND STATION.  THE PU	⊠h	LOOSE COMBINATION MOTOR STARTER		
TRANSFORMER - FLOOR MOUNTED. SIZE AND TYPE AS INDICATED.  TRANSFORMER - SUSPENDED. SIZE AND TYPE AS INDICATED.  PUSHS BUTTON STATION  DUPLEX, 1-GAMG RECEPTACLE - S-15R UNLESS NOTED  DUPLEX, 1-GAMG RECEPTACLE - S-15R UNLESS NOTED  DUPLEX, 1-GAMG RECEPTACLE - S-2R UNLESS NOTED  SINGLE RECEPTACLE - S-15R UNLESS NOTED  DUPLEX, 1-GAMG RECEPTACLE - S-15R UNLESS NOTED  SINGLE RESERVE RECEPTACLE - S-15R UNLESS NOTED  SINGLE RE		LOOSE MOTOR STARTER	- <del>(33333)</del> PT	
TRANSPORMER - SUSPENDED. SIZE AND TYPE AS INDICATED.  IT MANSPORMER - SUSPENDED. SIZE AND TYPE AS INDICATED.  IT MANSPORMER - SUSPENDED.  IT MANSPORMER SHUTDIF PUBRIBUTION  PUBRISH BUILTON STATION  DUPLEX. 1-GANG RECEPTACLE - S-15R UNLESS NOTED  DUPLEX. 1-GANG RECEPTACLE - S-15R UNLESS NOTED  DUPLEX. 1-GANG RECEPTACLE - S-20R UNLESS NOTED  SINGLE RECEPTACLE - S-15R UNLESS NOTED  DUPLEX. 1-GANG RECEPTACLE - S-15R UNLESS NOTED  SINGLE TWISTLOOK RECEPTACLE - LIS-20R UNLESS NOTED  SINGLE TWISTLOOK RECEPTACLE - S-15R UNLESS NOTED  GROUND FAULT INTERRUPTER (GRI) RECEPTACLE - S-15R.  GROUND FAULT INTERRUPTER (GRI) RECEPTACLE - S-15R.  GROUND FAULT INTERRUPTER (GRI) RECEPTACLE - S-15R.  GROUND FAULT INTERRUPTER (GRI) RECEPTACLE - S-20R.  GROUND FAULT INTERRUPTER (GRI) RECEPTACLE - S-20R.  GROUND FAULT SHARE SHOTED  DUPLEX. 1-GANG RECEPTACLE - OUTLET - WITH USB  DUPLEX. 1-GANG RECEPTACLE - OUTLET - WITH USB  DUPLEX. 1-GANG RECEPTACLE - S-20R.  DUPLEX. 1-GANG RECEPTACLE - S-20		CONTACTOR	<del></del>	<u>}</u>
EMERGENCY POWER SHUTOR PUSHBUTTON  PUSH BUTTON STATION  DUPLEX 1-GANG RECEPTACLE - 5-15R UNLESS NOTED  DUPLEX 1-GANG RECEPTACLE - CELLING MOUNTED 5-15R UNLESS NOTED  DUPLEX 1-GANG RECEPTACLE - 1-10OR MOUNTED 5-15R UNLESS NOTED  DUPLEX 1-GANG RECEPTACLE - 1-10OR MOUNTED 5-15R UNLESS NOTED  DUPLEX 1-GANG RECEPTACLE - 1-10OR MOUNTED 5-15R UNLESS NOTED  DUPLEX 1-GANG RECEPTACLE - 1-10OR MOUNTED 5-15R UNLESS NOTED  DUPLEX 1-GANG RECEPTACLE - 1-10OR MOUNTED 5-15R UNLESS NOTED  SINGLE RECEPTACLE - 1-10OR MOUNTED 5-15R UNLESS NOTED  SINGLE RECEPTACLE - 1-10OR MOUNTED 5-15R UNLESS NOTED  SINGLE TWISTLOOK RECEPTACLE - 1-10-20R INDLESS NOTED  GROUND FAULT INTERRUPTER (GIP) RECEPTACLE - 1-10-10R MOUNTED  SINGLE TWISTLOOK RECEPTACLE - 1-10-20R MOUNTED  GROUND FAULT INTERRUPTER (GIP) RECEPTACLE - 1-10-0R MOUNTED  SINGLE TWISTLOOK RECEPTACLE - 1-10-0R MOUNTED  SORT SAND AURISS NOTED  GROUND FAULT INTERRUPTER (GIP) RECEPTACLE - 1-10-0R MOUNTED  SORT SAND AURISS NOTED  DUPLEX 1-10-ANG RECEPTACLE - 1-10-0R MOUNTED  SORT SAND AURISS NOTED  DUPLEX 1-10-ANG RECEPTACLE - 1-10-0R MOUNTED  SORT SAND AURISS NOTED  DUPLEX 1-10-ANG RECEPTACLE - 1-10-0R MOUNTED  SORT SAND AURISS NOTED  DUPLEX 1-10-ANG RECEPTACLE - 1-10-0R MOUNTED SORT  SPLIT RECEPTACLE - 1-10-0R MOUNTED SORT  SPLIT RECEPTACLE - 1-10-0R MOUNTED SORT  SPLIT RECEPTACLE - 1-10-0R MOUNTED SORT  DUPLEX 1-10-ANG RECEPTACLE - 1-10-0R MOUNTED SORT  SPLIT RECEPTACLE - 1-10-0R MOUNTED SORT  DUPLEX 1-10-ANG RECEPTACLE - 1-10-10R MOUNTED SORT  SPLIT RECEPTACLE - 1-10-0R MOUNTED SORT  DUPLEX 1-10-ANG RECEPTACLE - 1-10-10R MOUNTED SORT  SPLIT RECEPTACLE - 1-10-10R MOUNTED SORT  SPLIT RECEPTACLE - 1-10-10R MOUNTED S		TRANSFORMER - FLOOR MOUNTED. SIZE AND TYPE AS INDICATED.	DCS	
PUSH BUTTON STATION      PUSH BUTTON STATION    DUPLEX, 1-GANG RECEPTACLE - 5-16R UNLESS NOTED  DUPLEX, 1-GANG RECEPTACLE - CEILING MOUNTED, 5-15R UNLESS NOTED  DUPLEX, 1-GANG RECEPTACLE - 5-20R UNLESS NOTED  SINGLE RECEPTACLE - 5-16R UNLESS NOTED  DUPLEX, 1-GANG RECEPTACLE - 5-16R UNLESS NOTED  SINGLE RECEPTACLE - 5-16R UNLESS NOTED  SINGLE TWISTLOCK RECEPTACLE - 1-16-20R MOUNTED  L5-15R UNLESS NOTED  SINGLE TWISTLOCK RECEPTACLE - 5-16R UNLESS NOTED  SINGLE TWISTLOCK RECEPTACLE - 1-16-20R MOUNTED  L5-15R UNLESS NOTED  GROUND FAULT INTERRUPTER (GFI) RECEPTACLE - 5-15R, SINGLUNG FAULT INTERRUPTER (GFI) RECEPTACLE - 1-10R MOUNTED  C1-16R GROUND FAULT INTERRUPTER (GFI) RECEPTACLE - 5-10R MOUNTED  SINGLE TRACEPTACLE - 5-15R  DUPLEX, 1-GANG RECEPTACLE - 0-10R MOUNTED STORE  SPLIT RECEPTACLE - 6-10R MOUNTED STORE  DUPLEX, 1-GANG RECEPTACLE - 0-10R MOUNTED STORE  SPLIT RECEPTACLE - 1-10R MOUNTED STORE  DUPLEX, 1-GANG RECEPTACLE - 1-10R MOUNTED STORE  SPLIT RECEPTACLE - 1-10R MOUNTED STORE  DUPLEX, 1-GANG RECEPTACLE - 1-10R MOUNTED STORE  DUPLEX, 1-10R MOUNTED STORE  DUPLEX, 1-10R MOUNT		TRANSFORMER - SUSPENDED. SIZE AND TYPE AS INDICATED.	<u> </u>	
DUPLEX, 1-GANG RECEPTACLE - 5-15R UNLESS NOTED  DUPLEX, 1-GANG RECEPTACLE - 5-10R UNLESS NOTED  DUPLEX, 1-GANG RECEPTACLE - FLOOR MOUNTED, 5-15R UNLESS NOTED  DUPLEX, 1-GANG RECEPTACLE - 5-20R UNLESS NOTED  DUPLEX, 1-GANG RECEPTACLE - 5-20R UNLESS NOTED  DUPLEX, 1-GANG RECEPTACLE - 5-10R UNLESS NOTED  DUPLEX, 1-GANG RECEPTACLE - FLOOR MOUNTED, 5-20R UNLESS NOTED  SINGLE RECEPTACLE - 5-15R UNLESS NOTED  SINGLE RECEPTACLE - FLOOR MOUNTED, 5-15R UNLESS NOTED  SINGLE RECEPTACLE - FLOOR MOUNTED, 5-15R UNLESS NOTED  SINGLE TWISTLOCK RECEPTACLE - FLOOR MOUNTED  SINGLE TWISTLOCK RECEPTACLE - CEILING MOUNTED.  1-5-15R UNLESS NOTED  SINGLE TWISTLOCK RECEPTACLE - FLOOR MOUNTED.  1-5-15R UNLESS NOTED  SINGLE TWISTLOCK RECEPTACLE - FLOOR MOUNTED.  1-5-15R UNLESS NOTED  SINGLE TWISTLOCK RECEPTACLE - FLOOR MOUNTED.  1-5-15R UNLESS NOTED  SINGLE TWISTLOCK RECEPTACLE - FLOOR MOUNTED.  1-5-15R UNLESS NOTED  SINGLE TWISTLOCK RECEPTACLE - FLOOR MOUNTED.  1-5-15R UNLESS NOTED  SINGLE TWISTLOCK RECEPTACLE - FLOOR MOUNTED.  1-5-15R UNLESS NOTED  GROUND FAULT INTERRUPTER (FIF) RECEPTACLE - FLOOR MOUNTED  1-5-15R UNLESS NOTED  GROUND FAULT INTERRUPTER (FIF) RECEPTACLE - FLOOR MOUNTED  1-5-15R UNLESS NOTED  GROUND FAULT INTERRUPTER (FIF) RECEPTACLE - CEILING MOUNTED  1-5-15R UNLESS NOTED  GROUND FAULT INTERRUPTER (FIF) RECEPTACLE - CEILING MOUNTED  1-5-15R UNLESS NOTED  DUPLEX, 1-GANG RECEPTACLE OUTLET - WITH USB  DUPLEX, 1-GANG RECEPTACLE - STAR  DUPLEX, 1-GANG RECEPTACLE OUTLET - FLOOR MOUNTED  1-5-15R UNLESS NOTED  DUPLEX, 1-GANG RECEPTACLE - STAR  DUPLEX, 1-GANG RE	â	EMERGENCY POWER SHUTOFF PUSHBUTTON	-	$\downarrow$
DUPLEY, 1-GANG RECEPTACLE - CEILING MOUNTED, 5-15R UNLESS NOTED  DUPLEY, 1-GANG RECEPTACLE - 5-20R UNLESS NOTED  DUPLEY, 1-GANG RECEPTACLE - 5-20R UNLESS NOTED  DUPLEY, 1-GANG RECEPTACLE - S-20R UNLESS NOTED  DUPLEY, 1-GANG RECEPTACLE - FLOOR MOUNTED, 5-20R UNLESS NOTED  DUPLEY, 1-GANG RECEPTACLE - FLOOR MOUNTED, 5-20R UNLESS NOTED  SINGLE RECEPTACLE - S-15R UNLESS NOTED  SINGLE TWISTLOCK RECEPTACLE - S-15R UNLESS NOTED  DUPLEY, 1-GANG RECEPTACLE - S-15R UNLESS NOTED  SINGLE TWISTLOCK RECEPTACLE - S-15R UNLESS NOTED  DUPLEY, 1-GANG RECEPTACLE - S-15R UNLESS NOTED  SPLIT RECEPTACLE - S-15R UNLESS NOTED  DUPLEY, 1-GANG RECEPTACLE - S-15R UNLESS NOTED  SPLIT RECEPTACLE - S-15R UNLESS NOTED  SPLIT RECEPTACLE - S-15R UNLESS NOTED  DUPLEY, 1-GANG RECEPTACLE - S-15R UNLESS NOTED  SPLIT RECEPTACLE - S-16R UNLESS NOTED  SPLIT RECEP	요	PUSH BUTTON STATION	-	$\downarrow$
DUPLEX, 1-GANG RECEPTACLE - FLOOR MOUNTED. 5-15R UNLESS NOTED  DUPLEX, 1-GANG RECEPTACLE - S-20R UNLESS NOTED  DUPLEX, 1-GANG RECEPTACLE - GEILING MOUNTED. 5-20R UNLESS NOTED  DUPLEX, 1-GANG RECEPTACLE - FLOOR MOUNTED. 5-20R UNLESS NOTED  SINGLE RECEPTACLE - FLOOR MOUNTED. 5-15R UNLESS NOTED  SINGLE RECEPTACLE - FLOOR MOUNTED. 5-15R UNLESS NOTED  SINGLE RECEPTACLE - FLOOR MOUNTED. 5-15R UNLESS NOTED  SINGLE TWISTLOCK RECEPTACLE - 115-20R MOUNTED.  SINGLE TWISTLOCK RECEPTACLE - 115-20R MOUNTED. S-15R UNLESS NOTED.  DUPLEX 1-GANG RECEPTACLE - 115-20R MOUNTED. S-15R UNLESS NOTED.  SPLIT RECEPTACLE - 115-20R MOUNTED. S-15R UNLESS NOTED.  SPLIT RECEPTACLE - 115-20R MOUNTED. S-15R UNLESS NOTED.  SPLIT RECEPTACLE - 115-20R MOUNTED. S-15R UNLESS NOTED.  S		DUPLEX, 1-GANG RECEPTACLE - 5-15R UNLESS NOTED	***	$\downarrow$
DUPLEX, 1-GANG RECEPTACLE - 5-20R UNLESS NOTED  DUPLEX, 1-GANG RECEPTACLE - CEILING MOUNTED, 5-20R UNLESS NOTED  DUPLEX, 1-GANG RECEPTACLE - CEILING MOUNTED, 5-20R UNLESS NOTED  SINGLE RECEPTACLE - GEILING MOUNTED, 5-15R UNLESS NOTED  SINGLE RECEPTACLE - CEILING MOUNTED, 5-15R UNLESS NOTED  SINGLE TWISTLOCK RECEPTACLE - LI-20R MOUNTED, LI-20R UNLESS NOTED  SINGLE TWISTLOCK RECEPTACLE - FLOOR MOUNTED, SINGLE TWISTLOCK RECEPTACLE - GEILING MOUNTED, SINGLE TWISTLOCK RECEPTACLE - CEILING MOUNTED, SINGLE TWISTLOCK RECEPTACLE - GEILING MOUNTED, SINGLE TWISTLOCK RECEPTACLE - GEILING MOUNTED, SINGLE TWISTLOCK RECEPTACLE - GEILING MOUNTED, SINGLE TWISTLOCK RECEPTACLE - CEILING MOUNTED, SINGLE TWISTLOCK RECEPTACLE - GEILING MOUNTED, SINGLE RECEPTACLE - GEILING MOUNTED, SINGLE TWISTLOCK RECEPTACLE - GEILING MOUNTED, SINGLE TWISTLOCK RECEPTACLE - GEILING MOUNTED, SINGLE RECEPTACLE - GEILING MOUNTED, SINGLE TWISTLOCK RECEPTACLE - GEILING MOUNTED, SINGLE		DUPLEX, 1-GANG RECEPTACLE - CEILING MOUNTED. 5-15R UNLESS NOTED	T	$\downarrow$
DUPLEX, 1-GANG RECEPTACLE - CEILING MOUNTED, 5-20R UNLESS NOTED  DUPLEX, 1-GANG RECEPTACLE - FLOOR MOUNTED, 5-20R UNLESS NOTED  SINGLE RECEPTACLE - GEILING MOUNTED, 5-19R UNLESS NOTED  SINGLE RECEPTACLE - CEILING MOUNTED, 5-19R UNLESS NOTED  SINGLE TWISTLOCK RECEPTACLE - L15-20R UNLESS NOTED  SINGLE TWISTLOCK RECEPTACLE - CEILING MOUNTED, L5-18R UNLESS NOTED  SINGLE TWISTLOCK RECEPTACLE - CEILING MOUNTED, L5-18R UNLESS NOTED  SINGLE TWISTLOCK RECEPTACLE - CEILING MOUNTED, L5-18R UNLESS NOTED  GROUND FAULT INTERRUPTER (GF) RECEPTACLE - 15R. MAINLESS NOTED  GROUND FAULT INTERRUPTER (GF) RECEPTACLE - CEILING MOUNTED  STARS, SMA UNLESS NOTED  GROUND FAULT INTERRUPTER (GF) RECEPTACLE - CEILING MOUNTED  STARS, SMA UNLESS NOTED  GROUND FAULT INTERRUPTER (GF) RECEPTACLE - CEILING MOUNTED  STARS, SMA UNLESS NOTED  GROUND FAULT INTERRUPTER (GF) RECEPTACLE - CEILING MOUNTED  STARS SMA UNLESS NOTED  GROUND FAULT INTERRUPTER (GF) RECEPTACLE - CEILING MOUNTED  STARS SMA UNLESS NOTED  GROUND FAULT INTERRUPTER (GF) RECEPTACLE - CEILING MOUNTED  STARS SMA UNLESS NOTED  GROUND FAULT INTERRUPTER (GF) RECEPTACLE - CEILING MOUNTED  STARS SMA UNLESS NOTED  DUPLEX. 1-GANG RECEPTACLE OUTLET - WITH USB  DUPLEX. 1-GANG RECEPTACLE OUTLET - CEILING MOUNTED  SPLIT RECEPTACLE - STAR  DUPLEX. 1-GANG RECEPTACLE - CEILING MOUNTED  SPLIT RECEPTACLE - STAR  DUPLEX. 1-GANG RECEP	Ф	DUPLEX, 1-GANG RECEPTACLE - FLOOR MOUNTED. 5-15R UNLESS NOTED		
DUPLEX, 1-GANG RECEPTACLE - FLOOR MOUNTED, 5-20R UNLESS NOTED  SINGLE RECEPTACLE - 6-15R UNLESS NOTED  SINGLE RECEPTACLE - CEILING MOUNTED, 5-15R UNLESS NOTED  SINGLE TWISTLOCK RECEPTACLE - L15-20R UNLESS NOTED  SINGLE TWISTLOCK RECEPTACLE - L15-20R UNLESS NOTED  SINGLE TWISTLOCK RECEPTACLE - CEILING MOUNTED, L15-15R UNLESS NOTED  SINGLE TWISTLOCK RECEPTACLE - CEILING MOUNTED, L15-15R UNLESS NOTED  SINGLE TWISTLOCK RECEPTACLE - CEILING MOUNTED, L15-15R UNLESS NOTED  SINGLE TWISTLOCK RECEPTACLE - FLOOR MOUNTED, L15-15R UNLESS NOTED  SINGLE TWISTLOCK RECEPTACLE - FLOOR MOUNTED, L15-15R UNLESS NOTED  SINGLE TWISTLOCK RECEPTACLE - FLOOR MOUNTED, L15-15R UNLESS NOTED  SINGLE TWISTLOCK RECEPTACLE - FLOOR MOUNTED, L15-15R UNLESS NOTED  SINGLE TWISTLOCK RECEPTACLE - FLOOR MOUNTED, L15-15R, Sind UNLESS NOTED  SINGLE TWISTLOCK RECEPTACLE - FLOOR MOUNTED, L15-15R, Sind UNLESS NOTED  SINGLE TWISTLOCK RECEPTACLE - CEILING MOUNTED, L15-15R, Sind UNLESS NOTED  SINGLE TWISTLOCK RECEPTACLE - CEILING MOUNTED, L15-15R, Sind UNLESS NOTED  SINGLE TWISTLOCK RECEPTACLE - CEILING MOUNTED, L15-15R, Sind UNLESS NOTED  SINGLE TWISTLOCK RECEPTACLE - CEILING MOUNTED, L15-15R, Sind UNLESS NOTED  SINGLE TWISTLOCK RECEPTACLE - CEILING MOUNTED, L15-15R  SPLIT RECEPTACLE - SIDER  SPLIT RECEPTACLE - SIDER  SPLIT RECEPTACLE - FLOOR MOUNTED, S-15R  SPLIT RECEPTACLE - FLOOR MOUNTED, S-15R  SPLIT RECEPTACLE - FLOOR MOUNTED, S-15R UNLESS NOTED  DUPLEX, 1-GANG RECEPTACLE - S-5 SR ONE HALE CONTROLLED BY WALL SWITCH  DUPLEX, 1-GANG RECEPTACLE - FLOOR MOUNTED, S-15R UNLESS NOTED  STOVE RECEPTACLE - 1-4-50R, 125/250V, 50A  DOR  DOR DRYER RECEPTACLE - 1-4-50R, 125/250V, 50A  DOR  COMBINATION OUTLET - WALL MOUNTED - AS DETAILED  COMBINATION OUTLET - FLOOR MOUNTED - AS DETAILED  COMBINATION OUTLET - FLOOR MOUNTED - AS DETAILED  COMBINATION OUTLET - FLOOR MOUNTED - AS DETAILED		DUPLEX, 1-GANG RECEPTACLE - 5-20R UNLESS NOTED	LIGHTNING PR	ОТ
SINGLE RECEPTACLE - 5-15R UNLESS NOTED  SINGLE RECEPTACLE - CELLING MOUNTED. 5-15R UNLESS NOTED  SINGLE TWISTLOCK RECEPTACLE - L16-20R UNLESS NOTED  SINGLE TWISTLOCK RECEPTACLE - L16-20R UNLESS NOTED  SINGLE TWISTLOCK RECEPTACLE - CELLING MOUNTED.  L5-15R UNLESS NOTED  SINGLE TWISTLOCK RECEPTACLE - CELLING MOUNTED.  L5-15R UNLESS NOTED  CROUND FAULT INTERRUPTER (GF); RECEPTACLE - GELING MOUNTED.  L5-15R UNLESS NOTED  CROUND FAULT INTERRUPTER (GF); RECEPTACLE - CELLING MOUNTED  S-15R, Gind UNLESS NOTED  CROUND FAULT INTERRUPTER (GF); RECEPTACLE - FLOOR MOUNTED  S-15R, Gind UNLESS NOTED  CROUND FAULT INTERRUPTER (GF); RECEPTACLE - CELLING MOUNTED  S-15R, Gind UNLESS NOTED  CROUND FAULT INTERRUPTER (GF); RECEPTACLE - CELLING MOUNTED  S-15R, Gind UNLESS NOTED  CROUND FAULT INTERRUPTER (GF); RECEPTACLE - CELLING MOUNTED  S-15R, Gind UNLESS NOTED  CROUND FAULT INTERRUPTER (GF); RECEPTACLE - FLOOR MOUNTED  S-20R, Gind UNLESS NOTED  DUPLEX, 1-GANG RECEPTACLE OUTLET - WITH USB  DUPLEX, 1-GANG RECEPTACLE OUTLET - FLOOR MOUNTED  WITH USB  DUPLEX, 1-GANG RECEPTACLE OUTLET - FLOOR MOUNTED  WITH USB  SPLIT RECEPTACLE - S-15R  DUPLEX, 1-GANG RECEPTACLE OUTLET - FLOOR MOUNTED  SPLIT RECEPTACLE - CEILING MOUNTED. S-15R  SPLIT RECEPTACLE - S-20R  SPLIT RECEPTACLE - CEILING MOUNTED. S-20R  DUPLEX, 1-GANG RECEPTACLE - S-15R  ONE HALF CONTROLLED BY WALL SWITCH  DUPLEX, 1-GANG RECEPTACLE - S-15R  ONE HALF CONTROLLED BY WALL SWITCH  DUPLEX, 1-GANG RECEPTACLE - S-15R  ONE HALF CONTROLLED BY WALL SWITCH  DUPLEX, 1-GANG RECEPTACLE - S-15R  ONE HALF CONTROLLED BY WALL SWITCH  DUPLEX, 1-GANG RECEPTACLE - S-15R  ONE HALF CONTROLLED BY WALL SWITCH  DUPLEX, 1-GANG RECEPTACLE - S-15R  ONE HALF CONTROLLED BY WALL SWITCH  DUPLEX, 1-GANG RECEPTACLE - S-15R  ONE HALF CONTROLLED BY WALL SWITCH  DUPLEX, 1-GANG RECEPTACLE - S-15R  ONE HALF CONTROLLED BY WALL SWITCH  DUPLEX, 1-GANG RECEPTACLE - S-15R  ONE HALF CONTROLLED BY WALL SWITCH  DUPLEX, 1-GANG RECEPTACLE - S-15R  ONE HALF CONTROLLED BY WALL SWITCH  DUPLEX, 1-GANG RECEPTACLE - S-15R  ONE HALF		DUPLEX, 1-GANG RECEPTACLE - CEILING MOUNTED. 5-20R UNLESS NOTED	•	$\downarrow$
SINGLE RECEPTACLE - CEILING MOUNTED. 5-15R UNLESS NOTED  SINGLE RECEPTACLE - FLOOR MOUNTED. 5-15R UNLESS NOTED  SINGLE TWISTLOCK RECEPTACLE - CEILING MOUNTED. L5-15R UNLESS NOTED  SINGLE TWISTLOCK RECEPTACLE - CEILING MOUNTED. L5-15R UNLESS NOTED  CROUND FAULT INTERRUPTER (GF) RECEPTACLE - S-15R, SMAULESS NOTED  GROUND FAULT INTERRUPTER (GF) RECEPTACLE - CEILING MOUNTED S-15R, SMAULESS NOTED  GROUND FAULT INTERRUPTER (GF) RECEPTACLE - CEILING MOUNTED S-15R, SMAULESS NOTED  GROUND FAULT INTERRUPTER (GF) RECEPTACLE - CEILING MOUNTED S-15R, SMAULESS NOTED  GROUND FAULT INTERRUPTER (GF) RECEPTACLE - CEILING MOUNTED S-15R, SMAULESS NOTED  GROUND FAULT INTERRUPTER (GF) RECEPTACLE - CEILING MOUNTED S-15R, SMAULESS NOTED  GROUND FAULT INTERRUPTER (GF) RECEPTACLE - CEILING MOUNTED S-20R, SMAULESS NOTED  GROUND FAULT INTERRUPTER (GF) RECEPTACLE - CEILING MOUNTED S-20R, SMAULESS NOTED  GROUND FAULT INTERRUPTER (GF) RECEPTACLE - CEILING MOUNTED S-20R, SMAULESS NOTED  GROUND FAULT INTERRUPTER (GF) RECEPTACLE - CEILING MOUNTED S-20R, SMAULESS NOTED  GROUND FAULT INTERRUPTER (GF) RECEPTACLE - CEILING MOUNTED S-20R, SMAULESS NOTED  GROUND FAULT INTERRUPTER (GF) RECEPTACLE - CEILING MOUNTED S-20R, SMAULESS NOTED  GROUND FAULT INTERRUPTER (GF) RECEPTACLE - CEILING MOUNTED S-20R, SMAULESS NOTED  GROUND FAULT INTERRUPTER (GF) RECEPTACLE - CEILING MOUNTED S-20R, SMAULESS NOTED  GROUND FAULT INTERRUPTER (GF) RECEPTACLE - CEILING MOUNTED S-20R, SMAULESS NOTED  GROUND FAULT SANCRE RECEPTACLE - S-15R  GROUND FAULT SANCRE REC	#	DUPLEX, 1-GANG RECEPTACLE - FLOOR MOUNTED. 5-20R UNLESS NOTED		_
SINGLE RECEPTACLE - FLOOR MOUNTED. 5-15R UNLESS NOTED  SINGLE TWISTLOCK RECEPTACLE - L15-20R UNLESS NOTED  SINGLE TWISTLOCK RECEPTACLE - CELLING MOUNTED.  L5-15R UNLESS NOTED  SINGLE TWISTLOCK RECEPTACLE - FLOOR MOUNTED.  L5-15R UNLESS NOTED  GROUND FAUL TITTERRUPTER (6F) RECEPTACLE - S-15R.  SMA UNLESS NOTED  GROUND FAUL TITTERRUPTER (6F) RECEPTACLE - CELLING MOUNTED  S-15R, 5ma UNLESS NOTED  GROUND FAUL TITTERRUPTER (6F) RECEPTACLE - CELLING MOUNTED  S-15R, 5ma UNLESS NOTED  GROUND FAUL TITTERRUPTER (6F) RECEPTACLE - CELLING MOUNTED  S-15R, 5ma UNLESS NOTED  GROUND FAUL TITTERRUPTER (6F) RECEPTACLE - CELLING MOUNTED  S-15R, 5ma UNLESS NOTED  GROUND FAUL TITTERRUPTER (6F) RECEPTACLE - CELLING MOUNTED  S-20R, 5ma UNLESS NOTED  GROUND FAUL TITTERRUPTER (6F) RECEPTACLE - FLOOR MOUNTED  S-20R, 5ma UNLESS NOTED  GROUND FAUL TITTERRUPTER (6F) RECEPTACLE - FLOOR MOUNTED  WITH USB  GROUND FAUL TITTERRUPTER (6F) RECEPTACLE - FLOOR MOUNTED  WITH USB  GROUND FAUL TITTERRUPTER (6F) RECEPTACLE - FLOOR MOUNTED  WITH USB  GROUND FAUL TITTERRUPTER (6F) RECEPTACLE - FLOOR MOUNTED  WITH USB  GROUND FAUL TITTERRUPTER (6F) RECEPTACLE - FLOOR MOUNTED  WITH USB  GROUND FAUL TITTERRUPTER (6F) RECEPTACLE - FLOOR MOUNTED  WITH USB  GROUND FAUL TITTERRUPTER (6F) RECEPTACLE - FLOOR MOUNTED  WITH USB  GROUND FAUL TITTERRUPTER (6F) RECEPTACLE - FLOOR MOUNTED  WITH USB  GROUND FAUL TITTERRUPTER (6F) RECEPTACLE - FLOOR MOUNTED - FLOOR MOUNTED  SPLIT RECEPTACLE - FLOOR MOUNTED - FLOOR MOUNTED  SPLIT RECEPTACLE - CELLING MOUNTED - FLOOR MOUNTED  GROUND FAUL FOOTHOLLED BY WALL SWITCH	Φ	SINGLE RECEPTACLE - 5-15R UNLESS NOTED		
SINGLE TWISTLOCK RECEPTACLE - L15-20R UNLESS NOTED  SINGLE TWISTLOCK RECEPTACLE - CEILING MOUNTED. L5-16R UNLESS NOTED  SINGLE TWISTLOCK RECEPTACLE - FLOOR MOUNTED. L5-16R UNLESS NOTED  GROUND FAULT INTERRUPTER (GFI) RECEPTACLE - 515R. SmA UNLESS NOTED  GROUND FAULT INTERRUPTER (GFI) RECEPTACLE - CEILING MOUNTED S-16R, 5mA UNLESS NOTED  GROUND FAULT INTERRUPTER (GFI) RECEPTACLE - FLOOR MOUNTED S-16R, 5mA UNLESS NOTED  GROUND FAULT INTERRUPTER (GFI) RECEPTACLE - FLOOR MOUNTED S-16R, 5mA UNLESS NOTED  GROUND FAULT INTERRUPTER (GFI) RECEPTACLE - CEILING MOUNTED S-16R, 5mA UNLESS NOTED  GROUND FAULT INTERRUPTER (GFI) RECEPTACLE - FLOOR MOUNTED S-16R, 5mA UNLESS NOTED  GROUND FAULT INTERRUPTER (GFI) RECEPTACLE - FLOOR MOUNTED S-16R, 5mA UNLESS NOTED  GROUND FAULT INTERRUPTER (GFI) RECEPTACLE - FLOOR MOUNTED S-16R, 5mA UNLESS NOTED  GROUND FAULT INTERRUPTER (GFI) RECEPTACLE - FLOOR MOUNTED S-16R, 5mA UNLESS NOTED  DUPLEX, 1-GANG RECEPTACLE OUTLET - WITH USB  DUPLEX, 1-GANG RECEPTACLE OUTLET - FLOOR MOUNTED WITH USB  DUPLEX, 1-GANG RECEPTACLE OUTLET - FLOOR MOUNTED  SPLIT RECEPTACLE - CEILING MOUNTED. 5-15R  SPLIT RECEPTACLE - CEILING MOUNTED. 5-15R  SPLIT RECEPTACLE - FLOOR MOUNTED. 5-20R  DUPLEX, 1-GANG RECEPTACLE - S-20R  ON EHALF CONTROLLED BY WALL SWITCH  DUPLEX, 1-GANG RECEPTACLE - S-20R  ON EHALF CONTROLLED BY WALL SWITCH  DUPLEX, 1-GANG RECEPTACLE - S-20R  ON EHALF CONTROLLED BY WALL SWITCH  DUPLEX, 1-GANG RECEPTACLE - S-20R  ON HALF CONTROLLED BY WALL SWITCH  DUPLEX, 1-GANG RECEPTACLE - S-20R  ON HALF CONTROLLED BY WALL SWITCH  DUPLEX, 1-GANG RECEPTACLE - S-20R  ON HALF CONTROLLED BY WALL SWITCH  DUPLEX, 1-GANG RECEPTACLE - S-20R  ON HALF CONTROLLED BY WALL SWITCH  DUPLEX, 1-GANG RECEPTACLE - S-20R  ON HALF CONTROLLED BY WALL SWITCH  DUPLEX, 1-GANG RECEPTACLE - S-20R  ON HALF CONTROLLED BY WALL SWITCH  DUPLEX, 1-GANG RECEPTACLE - S-20R  ON HALF CONTROLLED BY WALL SWITCH  DUPLEX - 1-GANG RECEPTACLE - S-20R  ON HALF CONTROLLED BY WALL SWITCH  DUPLEX - 1-GANG RECEPTACLE - S-20R  ON HALF CONTROLLED BY WALL SWITC	<del>.</del> +	SINGLE RECEPTACLE - CEILING MOUNTED. 5-15R UNLESS NOTED		$\downarrow$
## SINGLE TWISTLOCK RECEPTACLE - CEILING MOUNTED.  LS-15R UNLESS NOTED    SINGLE TWISTLOCK RECEPTACLE - FLOOR MOUNTED.   LS-15R UNLESS NOTED     SINGLE TWISTLOCK RECEPTACLE - FLOOR MOUNTED.   LS-15R UNLESS NOTED     SINGLE TWISTLOCK RECEPTACLE - FLOOR MOUNTED.   LS-15R UNLESS NOTED     SINGLE TWISTLOCK RECEPTACLE - FLOOR MOUNTED.   SINGLE TWISTLOCK RECEPTACLE - SINGLE RECEPTACLE - FLOOR MOUNTED.   SINGLE TWISTLOCK RECEPTACLE - SINGLE RECEPTACLE - FLOOR MOUNTED.   SINGLE TWISTLOCK RECEPTACLE - SINGLE RECEPTACLE - FLOOR MOUNTED.   SINGLE TWISTLOCK RECEPTACLE - SINGLE RECEPTACLE - FLOOR MOUNTED. SINGLE RECEPTACLE - S	-	SINGLE RECEPTACLE - FLOOR MOUNTED. 5-15R UNLESS NOTED		
LE-1SR INLESS NOTED  DISSIGLE TWISTLOCK RECEPTACLE - FLOOR MOUNTED. LS-1SR UNLESS NOTED  GROUND FAULT INTERRUPTER (GFI) RECEPTACLE - CEILING MOUNTED SIRS, SIAM DISS NOTED  GROUND FAULT INTERRUPTER (GFI) RECEPTACLE - CEILING MOUNTED SIRS, SIAM DISS NOTED  GROUND FAULT INTERRUPTER (GFI) RECEPTACLE - LOOR MOUNTED SIRS, SIAM DISS NOTED  GROUND FAULT INTERRUPTER (GFI) RECEPTACLE - LOOR MOUNTED SIRS, SIAM UNLESS NOTED  GROUND FAULT INTERRUPTER (GFI) RECEPTACLE - CEILING MOUNTED SIRS, SIAM UNLESS NOTED  GROUND FAULT INTERRUPTER (GFI) RECEPTACLE - CEILING MOUNTED SIRS, SIAM UNLESS NOTED  GROUND FAULT INTERRUPTER (GFI) RECEPTACLE - CEILING MOUNTED SIRS, SIAM UNLESS NOTED  DUPLEX, 1-GANG RECEPTACLE OUTLET - WITH USB  DUPLEX, 1-GANG RECEPTACLE OUTLET - CEILING MOUNTED WITH USB  DUPLEX, 1-GANG RECEPTACLE OUTLET - FLOOR MOUNTED WITH USB  SPLIT RECEPTACLE - S-15R  WITH RECEPTACLE - S-15R  SPLIT RECEPTACLE - CEILING MOUNTED. S-15R  SPLIT RECEPTACLE - CEILING MOUNTED. S-15R  SPLIT RECEPTACLE - CEILING MOUNTED. S-20R  SPLIT RECEPTACLE - CEILING MOUNTED. S-20R  SPLIT RECEPTACLE - CEILING MOUNTED. S-20R  SPLIT RECEPTACLE - FLOOR MOUNTED. S-20R  SPLIT RECEPTACLE - S-15R  ONE HALF CONTROLLED BY WALL SWITCH  QUAD, 2-GANG RECEPTACLE, 5-15R UNLESS NOTED  DUPLEX, 1-GANG RECEPTACLE, 5-15R UNLESS NOTED  COMBINATION OUTLET - WALL MOUNTED. S-15R UNLESS NOTED  COMBINATION OUTLET - WALL MOUNTED. S-15R UNLESS NOTED  COMBINATION OUTLET - FLOOR MO	Ø			
U.5-19R UNLESS NOTED  GROUND FAULT INTERRUPTER (GFI) RECEPTACLE 5-15R, SMA UNLESS NOTED  GROUND FAULT INTERRUPTER (GFI) RECEPTACLE - CEILING MOUNTED  GROUND FAULT INTERRUPTER (GFI) RECEPTACLE - LORN MOUNTED  GROUND FAULT INTERRUPTER (GFI) RECEPTACLE - FLOOR MOUNTED  GROUND FAULT INTERRUPTER (GFI) RECEPTACLE - FLOOR MOUNTED  GROUND FAULT INTERRUPTER (GFI) RECEPTACLE - CEILING MOUNTED  GROUND FAULT INTERRUPTER (GFI) RECEPTACLE - CEILING MOUNTED  GROUND FAULT INTERRUPTER (GFI) RECEPTACLE - FLOOR MOUNTED  WITH USB  DUPLEX 1-GANG RECEPTACLE OUTLET - FLOOR MOUNTED  WITH USB  DUPLEX 1-GANG RECEPTACLE OUTLET - FLOOR MOUNTED  WITH USB  SPLIT RECEPTACLE - 5-15R  DUPLEX 1-GANG RECEPTACLE OUTLET - FLOOR MOUNTED  SPLIT RECEPTACLE - FLOOR MOUNTED. 5-15R  SPLIT RECEPTACLE - FLOOR MOUNTED. 5-15R  SPLIT RECEPTACLE - FLOOR MOUNTED. 5-20R  SPLIT RECEPTACLE - FLOOR MOUNTED. 5-20R  SPLIT RECEPTACLE - FLOOR MOUNTED. 5-20R  DUPLEX 1-GANG RECEPTACLE - 5-15R  ONE HALF CONTROLLED BY WALL SWITCH  DUPLEX 1-GANG RECEPTACLE - 5-15R  ONE HALF CONTROLLED BY WALL SWITCH  DUPLEX 1-GANG RECEPTACLE - 5-15R  ONE HALF CONTROLLED BY WALL SWITCH  DUPLEX 1-GANG RECEPTACLE - 5-15R  ONE HALF CONTROLLED BY WALL SWITCH  DUPLEX 1-GANG RECEPTACLE - 5-15R  ONE HALF CONTROLLED BY WALL SWITCH  DUPLEX 1-GANG RECEPTACLE - 5-15R  ONE HALF CONTROLLED BY WALL SWITCH  DUPLEX 1-GANG RECEPTACLE - 5-15R  ONE HALF CONTROLLED BY WALL SWITCH  DUPLEX 1-GANG RECEPTACLE - 5-15R  ONE HALF CONTROLLED BY WALL SWITCH  DUPLEX 1-GANG RECEPTACLE - 5-15R  ONE HALF CONTROLLED BY WALL SWITCH  DUPLEX 1-GANG RECEPTACLE - 5-15R  ONE HALF CONTROLLED BY WALL SWITCH  DUPLEX 1-GANG RECEPTACLE - 5-15R  ONE HALF CONTROLLED BY WALL SWITCH  DUPLEX 1-GANG RECEPTACLE - 5-15R  ONE HALF CONTROLLED BY WALL SWITCH  DUPLEX 1-GANG RECEPTACLE - 5-15R  ONE HALF CONTROLLED	<del>  </del>	L5-15R UNLESS NOTED	FIRE ALARM DI	EVI
MILESS NOTED  GROUND FAULT INTERRUPTER (GFI) RECEPTACLE - CEILING MOUNTED 5-15R, 5ma UNLESS NOTED  GROUND FAULT INTERRUPTER (GFI) RECEPTACLE - FLOOR MOUNTED 5-15R, 5ma UNLESS NOTED  GROUND FAULT INTERRUPTER (GFI) RECEPTACLE - CEILING MOUNTED 5-15R, 5ma UNLESS NOTED  GROUND FAULT INTERRUPTER (GFI) RECEPTACLE - CEILING MOUNTED 5-20R, 5ma UNLESS NOTED  GROUND FAULT INTERRUPTER (GFI) RECEPTACLE - CEILING MOUNTED 5-20R, 5ma UNLESS NOTED  GROUND FAULT INTERRUPTER (GFI) RECEPTACLE - FLOOR MOUNTED 5-20R, 5ma UNLESS NOTED  DUPLEX, 1-GANG RECEPTACLE OUTLET - WITH USB  DUPLEX, 1-GANG RECEPTACLE OUTLET - CEILING MOUNTED  WITH USB  DUPLEX, 1-GANG RECEPTACLE OUTLET - FLOOR MOUNTED  WITH USB  SPLIT RECEPTACLE - 5-15R  SPLIT RECEPTACLE - CEILING MOUNTED. 5-15R  SPLIT RECEPTACLE - CEILING MOUNTED. 5-15R  SPLIT RECEPTACLE - FLOOR MOUNTED. 5-20R  SPLIT RECEPTACLE - CEILING MOUNTED. 5-20R  DUPLEX, 1-GANG RECEPTACLE - 5-15R  DUPLEX, 1-GANG RECEPTACLE - S-15R  DUPLEX,		L5-15R UNLESS NOTED		1
S-15R, 5mA UNLESS NOTED GROUND FAULT INTERRUPTER (GFI) RECEPTACLE -FLOOR MOUNTED S-15R, 5mA UNLESS NOTED GROUND FAULT INTERRUPTER (GFI) RECEPTACLE 5-20R, SMA UNLESS NOTED GROUND FAULT INTERRUPTER (GFI) RECEPTACLE - CEILING MOUNTED S-20R, 5mA UNLESS NOTED GROUND FAULT INTERRUPTER (GFI) RECEPTACLE - CEILING MOUNTED S-20R, 5mA UNLESS NOTED GROUND FAULT INTERRUPTER (GFI) RECEPTACLE - FLOOR MOUNTED S-20R, 5mA UNLESS NOTED DUPLEX, 1-GANG RECEPTACLE OUTLET - WITH USB WITH USB DUPLEX, 1-GANG RECEPTACLE OUTLET - CEILING MOUNTED WITH USB DUPLEX, 1-GANG RECEPTACLE OUTLET - FLOOR MOUNTED WITH USB SPLIT RECEPTACLE - S-15R SPLIT RECEPTACLE - S-15R SPLIT RECEPTACLE - CEILING MOUNTED. 5-15R SPLIT RECEPTACLE - CEILING MOUNTED. 5-15R SPLIT RECEPTACLE - CEILING MOUNTED. 5-20R SPLIT RECEPTACLE - CEILING MOUNTED. 5-20R SPLIT RECEPTACLE - S-15R SPLIT RECE		5mA UNLESS NOTED	<u> </u>	1
S-15R, SMA UNLESS NOTED  GROUND FAULT INTERRUPTER (GFI) RECEPTACLE - CEILING MOUNTED  GROUND FAULT INTERRUPTER (GFI) RECEPTACLE - CEILING MOUNTED  GROUND FAULT INTERRUPTER (GFI) RECEPTACLE - CEILING MOUNTED  5-20R, SMA UNLESS NOTED  DUPLEX, 1-GANG RECEPTACLE OUTLET - WITH USB  DUPLEX, 1-GANG RECEPTACLE OUTLET - CEILING MOUNTED  WITH USB  DUPLEX, 1-GANG RECEPTACLE OUTLET - FLOOR MOUNTED  WITH USB  DUPLEX, 1-GANG RECEPTACLE OUTLET - FLOOR MOUNTED  WITH USB  SPLIT RECEPTACLE - 5-15R  SPLIT RECEPTACLE - FLOOR MOUNTED. 5-15R  SPLIT RECEPTACLE - FLOOR MOUNTED. 5-15R  SPLIT RECEPTACLE - FLOOR MOUNTED. 5-20R  SPLIT RECEPTACLE - FLOOR MOUNTED. 5-20R  DUPLEX, 1-GANG RECEPTACLE - S-20R  DUPLEX, 1-GANG RECEPTACLE - S-15R.  ONE HALF CONTROLLED BY WALL SWITCH  DUPLEX, 1-GANG RECEPTACLE - S-15R UNLESS NOTED  DUPLEX, 1-GANG RECEPTACLE - FLOOR MOUNTED, 5-15R UNLESS NOTED  DUPLEX, 1-GANG RECEPTACLE - FLOOR MOUNTED, 5-15R UNLESS NOTED  DUPLEX, 1-GANG RECEPTACLE - CEILING MOUNTED, 5-15R UNLESS NOTED  DUPLEX, 1-GANG RECEPTACLE - FLOOR MOUNTED, 5-15R UNLESS NOTED  DUPLEX, 1-GANG RECEPTACLE - FLOOR MOUNTED, 5-15R UNLESS NOTED  DUPLEX, 1-GANG RECEPTACLE - FLOOR MOUNTED, 5-15R UNLESS NOTED  DUPLEX, 1-GANG RECEPTACLE - FLOOR MOUNTED, 5-15R UNLESS NOTED  DUPLEX, 1-GANG RECEPTACLE - FLOOR MOUNTED, 5-15R UNLESS NOTED  DUPLEX, 1-GANG RECEPTACLE - FLOOR MOUNTED, 5-15R UNLESS NOTED  DUPLEX, 1-GANG RECEPTACLE - FLOOR MOUNTED, 5-15R UNLESS NOTED  DUPLEX, 1-GANG RECEPTACLE - FLOOR MOUNTED, 5-15R UNLESS NOTED  COMBINATION OUTLET - WALL MOUNTED - AS DETAILED  COMBINATION OUTLET - WALL MOUNTED - AS DETAILED	-	5-15R, 5mA UNLESS NOTED	1	$\downarrow$
Smaunless Noted  GROUND FAULT INTERRUPTER (GFI) RECEPTACLE - CEILING MOUNTED  \$-20R, 5ma UNLESS NOTED  GROUND FAULT INTERRUPTER (GFI) RECEPTACLE - FLOOR MOUNTED  \$-20R, 5ma UNLESS NOTED  DUPLEX, 1-GANG RECEPTACLE OUTLET - WITH USB  DUPLEX, 1-GANG RECEPTACLE OUTLET - CEILING MOUNTED  WITH USB  DUPLEX, 1-GANG RECEPTACLE OUTLET - FLOOR MOUNTED  WITH USB  SPLIT RECEPTACLE - 5-15R  DUPLEX, 1-GANG RECEPTACLE OUTLET - FLOOR MOUNTED  WITH USB  SPLIT RECEPTACLE - CEILING MOUNTED. 5-15R  SPLIT RECEPTACLE - FLOOR MOUNTED. 5-15R  SPLIT RECEPTACLE - FLOOR MOUNTED. 5-20R  SPLIT RECEPTACLE - FLOOR MOUNTED. 5-20R  DUPLEX, 1-GANG RECEPTACLE - 5-15R  ONE HALF CONTROLLED BY WALL SWITCH  DUPLEX, 1-GANG RECEPTACLE - 5-15R  ONE HALF CONTROLLED BY WALL SWITCH  QUAD, 2-GANG RECEPTACLE, 5-15R UNLESS NOTED  DUPLEX, 1-GANG RECEPTACLE - FLOOR MOUNTED, 5-15R UNLESS NOTED  DUPLEX, 1-GANG RECEPTACLE - 14-50R, 125/250V, 50A  DUPLEX, 1-GANG RECEPTACLE - 14-50R, 125/250V, 30A  DOP  COMBINATION OUTLET - WALL MOUNTED - AS DETAILED  COMBINATION OUTLET - FLOOR MOUNTED - AS DETAILED  COMBINATION OUTLET - FLOOR MOUNTED - AS DETAILED	#	5-15R, 5mA UNLESS NOTED	E E	$\downarrow$
# S-20R, 5mA UNLESS NOTED  GROUND FAULT INTERRUPTER (GFI) RECEPTACLE - FLOOR MOUNTED  SPUR 5, 20R, 5mA UNLESS NOTED  DUPLEX, 1-GANG RECEPTACLE OUTLET - WITH USB  DUPLEX, 1-GANG RECEPTACLE OUTLET - FLOOR MOUNTED  WITH USB  DUPLEX, 1-GANG RECEPTACLE OUTLET - FLOOR MOUNTED  WITH USB  SPLIT RECEPTACLE - 5-15R  SPLIT RECEPTACLE - CEILING MOUNTED. 5-15R  SPLIT RECEPTACLE - FLOOR MOUNTED. 5-15R  SPLIT RECEPTACLE - CEILING MOUNTED. 5-20R  SPLIT RECEPTACLE - CEILING MOUNTED. 5-20R  SPLIT RECEPTACLE - FLOOR MOUNTED. 5-20R  DUPLEX, 1-GANG RECEPTACLE - 5-18R. ONE HALF CONTROLLED BY WALL SWITCH  DUPLEX, 1-GANG RECEPTACLE - 5-18R. ONE HALF CONTROLLED BY WALL SWITCH  DUPLEX, 1-GANG RECEPTACLE - 5-15R. ONE HALF CONTROLLED BY WALL SWITCH  DUAD, 2-GANG RECEPTACLE, 5-15R UNLESS NOTED  DUAD, 2-GANG RECEPTACLE - FLOOR MOUNTED, 5-15R UNLESS NOTED  DUAD, 2-GANG RECEPTACLE - 14-50R, 125/250V, 30A  DOR  DOR  DOR  COMBINATION OUTLET - WALL MOUNTED - AS DETAILED  COMBINATION OUTLET - FLOOR MOUNTED - AS DETAILED  COMBINATION OUTLET - FLOOR MOUNTED - AS DETAILED		5mA UNLESS NOTED	Ø Ø	$\downarrow$
S-20R, 5mA UNLESS NOTED  DUPLEX, 1-GANG RECEPTACLE OUTLET - WITH USB  DUPLEX, 1-GANG RECEPTACLE OUTLET - CEILING MOUNTED  WITH USB  DUPLEX, 1-GANG RECEPTACLE OUTLET - FLOOR MOUNTED  WITH USB  SPLIT RECEPTACLE - 5-15R  SPLIT RECEPTACLE - CEILING MOUNTED. 5-15R  SPLIT RECEPTACLE - CEILING MOUNTED. 5-15R  SPLIT RECEPTACLE - S-20R  SPLIT RECEPTACLE - FLOOR MOUNTED. 5-20R  SPLIT RECEPTACLE - FLOOR MOUNTED. 5-20R  DUPLEX, 1-GANG RECEPTACLE - 5-15R.  ONE HALF CONTROLLED BY WALL SWITCH  DUPLEX, 1-GANG RECEPTACLE - 5-20R. ONE HALF CONTROLLED BY WALL SWITCH  QUAD, 2-GANG RECEPTACLE, 5-15R UNLESS NOTED  DUPLEX, 1-GANG RECEPTACLE - FLOOR MOUNTED, 5-15R UNLESS NOTED  DUPLEX, 1-GANG RECEPTACLE - 5-15R.  QUAD, 2-GANG RECEPTACLE - FLOOR MOUNTED, 5-15R UNLESS NOTED  DUPLEX, 1-GANG RECEPTACLE - FLOOR MOUNTED, 5-15R UNLESS NOTED  DUPLEX, 1-GANG RECEPTACLE - FLOOR MOUNTED, 5-15R UNLESS NOTED  DUPLEX, 1-GANG RECEPTACLE - FLOOR MOUNTED, 5-15R UNLESS NOTED  DUPLEX, 1-GANG RECEPTACLE - 14-50R, 125/250V, 50A  DUPLEX, 1-GANG RECEPTACLE - 14-30R, 125/250V, 30A  COMBINATION OUTLET - WALL MOUNTED - AS DETAILED  COMBINATION OUTLET - FLOOR MOUNTED - AS DETAILED		5-20R, 5mA UNLESS NOTED		
DUPLEX, 1-GANG RECEPTACLE OUTLET - CEILING MOUNTED WITH USB  DUPLEX, 1-GANG RECEPTACLE OUTLET - FLOOR MOUNTED WITH USB  SPLIT RECEPTACLE - S-15R  SPLIT RECEPTACLE - CEILING MOUNTED. 5-15R  SPLIT RECEPTACLE - FLOOR MOUNTED. 5-15R  SPLIT RECEPTACLE - S-20R  SPLIT RECEPTACLE - CEILING MOUNTED. 5-20R  SPLIT RECEPTACLE - FLOOR MOUNTED. 5-20R  DUPLEX, 1-GANG RECEPTACLE - S-15R. ONE HALF CONTROLLED BY WALL SWITCH  DUPLEX, 1-GANG RECEPTACLE - S-20R. ONE HALF CONTROLLED BY WALL SWITCH  QUAD, 2-GANG RECEPTACLE, 5-15R UNLESS NOTED  DUPLEX, 1-GANG RECEPTACLE - S-20R. ONE HALF CONTROLLED BY WALL SWITCH  QUAD, 2-GANG RECEPTACLE, 5-15R UNLESS NOTED  STOVE RECEPTACLE - CEILING MOUNTED, 5-15R UNLESS NOTED  DS STOVE RECEPTACLE - CEILING MOUNTED, 5-15R UNLESS NOTED  DN DRYER RECEPTACLE - 14-30R, 125/250V, 30A  COMBINATION OUTLET - WALL MOUNTED - AS DETAILED  COMBINATION OUTLET - FLOOR MOUNTED - AS DETAILED  COMBINATION OUTLET - FLOOR MOUNTED - AS DETAILED  COMBINATION OUTLET - FLOOR MOUNTED - AS DETAILED	#			4
## WITH USB  DUPLEX, 1-GANG RECEPTACLE OUTLET - FLOOR MOUNTED WITH USB  SPLIT RECEPTACLE - 5-15R  SPLIT RECEPTACLE - CEILING MOUNTED. 5-15R  SPLIT RECEPTACLE - FLOOR MOUNTED. 5-15R  SPLIT RECEPTACLE - S-20R  SPLIT RECEPTACLE - S-20R  SPLIT RECEPTACLE - CEILING MOUNTED. 5-20R  SPLIT RECEPTACLE - FLOOR MOUNTED. 5-20R  SPLIT RECEPTACLE - FLOOR MOUNTED. 5-20R  DUPLEX, 1-GANG RECEPTACLE - 5-15R  DUPLEX, 1-GANG RECEPTACLE - 5-15R  QUAD, 2-GANG RECEPTACLE - 5-20R.  ONE HALF CONTROLLED BY WALL SWITCH  QUAD, 2-GANG RECEPTACLE - S-15R UNLESS NOTED  ## QUAD, 2-GANG RECEPTACLE - FLOOR MOUNTED, 5-15R UNLESS NOTED  ## QUAD, 2-GANG RECEPTACLE - CEILING MOUNTED, 5-15R UNLESS NOTED  ## QUAD, 2-GANG RECEPTACLE - CEILING MOUNTED, 5-15R UNLESS NOTED  ## QUAD, 2-GANG RECEPTACLE - 14-50R, 125/250V, 50A   DDR DRYER RECEPTACLE - 14-30R, 125/250V, 30A  ©  FDNE  COMBINATION OUTLET - WALL MOUNTED - AS DETAILED  COMBINATION OUTLET - FLOOR MOUNTED - AS DETAILED		·	_	1
## WITH USB    SPLIT RECEPTACLE - 5-15R     SPLIT RECEPTACLE - FLOOR MOUNTED. 5-15R     SPLIT RECEPTACLE - FLOOR MOUNTED. 5-15R     SPLIT RECEPTACLE - 5-20R     SPLIT RECEPTACLE - CEILING MOUNTED. 5-20R     SPLIT RECEPTACLE - CEILING MOUNTED. 5-20R     SPLIT RECEPTACLE - FLOOR MOUNTED. 5-20R     SPLIT RECEPTACLE - FLOOR MOUNTED. 5-20R     DUPLEX, 1-GANG RECEPTACLE - 5-15R     ONE HALF CONTROLLED BY WALL SWITCH     DUPLEX, 1-GANG RECEPTACLE - 5-20R     ONE HALF CONTROLLED BY WALL SWITCH     QUAD, 2-GANG RECEPTACLE - 5-20R     OUAD, 2-GANG RECEPTACLE - FLOOR MOUNTED, 5-15R UNLESS NOTED     QUAD, 2-GANG RECEPTACLE - FLOOR MOUNTED, 5-15R UNLESS NOTED     QUAD, 2-GANG RECEPTACLE - CEILING MOUNTED, 5-15R UNLESS NOTED     QUAD, 2-GANG RECEPTACLE - 14-30R, 125/250V, 50A     QDR DRYER RECEPTACLE - 14-30R, 125/250V, 30A     CDR DRYER RECEPTACLE - 5-15R     CDR DRYER		WITH USB	<del>-</del>	1
SPLIT RECEPTACLE - CEILING MOUNTED. 5-15R  SPLIT RECEPTACLE - FLOOR MOUNTED. 5-15R  SPLIT RECEPTACLE - S-20R  SPLIT RECEPTACLE - CEILING MOUNTED. 5-20R  SPLIT RECEPTACLE - FLOOR MOUNTED. 5-20R  DUPLEX, 1-GANG RECEPTACLE - 5-15R. ONE HALF CONTROLLED BY WALL SWITCH  DUPLEX, 1-GANG RECEPTACLE - 5-20R. ONE HALF CONTROLLED BY WALL SWITCH  QUAD, 2-GANG RECEPTACLE, 5-15R UNLESS NOTED  QUAD, 2-GANG RECEPTACLE, 5-15R UNLESS NOTED  DYS  STOVE RECEPTACLE - 14-50R, 125/250V, 50A  DRYER RECEPTACLE - 14-30R, 125/250V, 30A  ©  EDNE  COMBINATION OUTLET - WALL MOUNTED - AS DETAILED  COMBINATION OUTLET - FLOOR MOUNTED - AS DETAILED	₿		<del></del>	1
SPLIT RECEPTACLE - FLOOR MOUNTED. 5-15R  SPLIT RECEPTACLE - 5-20R  SPLIT RECEPTACLE - CEILING MOUNTED. 5-20R  SPLIT RECEPTACLE - FLOOR MOUNTED. 5-20R  DUPLEX, 1-GANG RECEPTACLE - 5-15R. ONE HALF CONTROLLED BY WALL SWITCH  DUPLEX, 1-GANG RECEPTACLE - 5-20R. ONE HALF CONTROLLED BY WALL SWITCH  QUAD, 2-GANG RECEPTACLE, 5-15R UNLESS NOTED  QUAD, 2-GANG RECEPTACLE - FLOOR MOUNTED, 5-15R UNLESS NOTED  QUAD, 2-GANG RECEPTACLE - CEILING MOUNTED, 5-15R UNLESS NOTED  STOVE RECEPTACLE - 14-50R, 125/250V, 50A  QDR  DRYER RECEPTACLE - 14-30R, 125/250V, 30A  COMBINATION OUTLET - WALL MOUNTED - AS DETAILED  COMBINATION OUTLET - FLOOR MOUNTED - AS DETAILED		SPLIT RECEPTACLE - 5-15R	<b>8 9</b>	$\downarrow$
SPLIT RECEPTACLE - 5-20R  SPLIT RECEPTACLE - CEILING MOUNTED. 5-20R  SPLIT RECEPTACLE - FLOOR MOUNTED. 5-20R  DUPLEX, 1-GANG RECEPTACLE - 5-15R. ONE HALF CONTROLLED BY WALL SWITCH  DUPLEX, 1-GANG RECEPTACLE - 5-20R. ONE HALF CONTROLLED BY WALL SWITCH  QUAD, 2-GANG RECEPTACLE - 5-15R UNLESS NOTED  QUAD, 2-GANG RECEPTACLE - 5-15R UNLESS NOTED  QUAD, 2-GANG RECEPTACLE - FLOOR MOUNTED, 5-15R UNLESS NOTED  STOVE RECEPTACLE - 14-50R, 125/250V, 50A  QDR  DRYER RECEPTACLE - 14-30R, 125/250V, 30A  CO  EDDE  COMBINATION OUTLET - WALL MOUNTED - AS DETAILED  COMBINATION OUTLET - FLOOR MOUNTED - AS DETAILED		SPLIT RECEPTACLE - CEILING MOUNTED. 5-15R	<b>⊕</b> <sup>™</sup>	$\downarrow$
SPLIT RECEPTACLE - CEILING MOUNTED. 5-20R  SPLIT RECEPTACLE - FLOOR MOUNTED. 5-20R  DUPLEX, 1-GANG RECEPTACLE - 5-15R. ONE HALF CONTROLLED BY WALL SWITCH  DUPLEX, 1-GANG RECEPTACLE - 5-20R. ONE HALF CONTROLLED BY WALL SWITCH  QUAD, 2-GANG RECEPTACLE, 5-15R UNLESS NOTED  QUAD, 2-GANG RECEPTACLE - FLOOR MOUNTED, 5-15R UNLESS NOTED  QUAD, 2-GANG RECEPTACLE - CEILING MOUNTED, 5-15R UNLESS NOTED  STOVE RECEPTACLE - 14-50R, 125/250V, 50A  POPR  DRYER RECEPTACLE - 14-30R, 125/250V, 30A  COMBINATION OUTLET - WALL MOUNTED - AS DETAILED  COMBINATION OUTLET - FLOOR MOUNTED - AS DETAILED	<b>III</b>	SPLIT RECEPTACLE - FLOOR MOUNTED. 5-15R		
## SPLIT RECEPTACLE - FLOOR MOUNTED. 5-20R  DUPLEX, 1-GANG RECEPTACLE - 5-15R. ONE HALF CONTROLLED BY WALL SWITCH  DUPLEX, 1-GANG RECEPTACLE - 5-20R. ONE HALF CONTROLLED BY WALL SWITCH  QUAD, 2-GANG RECEPTACLE - 5-20R. ONE HALF CONTROLLED BY WALL SWITCH  QUAD, 2-GANG RECEPTACLE, 5-15R UNLESS NOTED  ## QUAD, 2-GANG RECEPTACLE - FLOOR MOUNTED, 5-15R UNLESS NOTED  ## QUAD, 2-GANG RECEPTACLE - CEILING MOUNTED, 5-15R UNLESS NOTED  DS STOVE RECEPTACLE - 14-50R, 125/250V, 50A   DRYER RECEPTACLE - 14-30R, 125/250V, 30A  ©  FDNE  COMBINATION OUTLET - WALL MOUNTED - AS DETAILED  COMBINATION OUTLET - FLOOR MOUNTED - AS DETAILED  □ □ □ □ □ □ □ □ □ □ □ □ □ □ □ □ □ □ □	•	SPLIT RECEPTACLE - 5-20R		1
DUPLEX, 1-GANG RECEPTACLE - 5-15R. ONE HALF CONTROLLED BY WALL SWITCH  DUPLEX, 1-GANG RECEPTACLE - 5-20R. ONE HALF CONTROLLED BY WALL SWITCH  QUAD, 2-GANG RECEPTACLE, 5-15R UNLESS NOTED  QUAD, 2-GANG RECEPTACLE - FLOOR MOUNTED, 5-15R UNLESS NOTED  QUAD, 2-GANG RECEPTACLE - CEILING MOUNTED, 5-15R UNLESS NOTED  QUAD, 2-GANG RECEPTACLE - CEILING MOUNTED, 5-15R UNLESS NOTED  OS STOVE RECEPTACLE - 14-50R, 125/250V, 50A  OPPR  DRYER RECEPTACLE - 14-30R, 125/250V, 30A  ©  EDNE  COMBINATION OUTLET - WALL MOUNTED - AS DETAILED  COMBINATION OUTLET - FLOOR MOUNTED - AS DETAILED  □  COMBINATION OUTLET - FLOOR MOUNTED - AS DETAILED  □  □  □  □ □ □ □ □ □ □ □ □ □ □ □ □ □		SPLIT RECEPTACLE - CEILING MOUNTED. 5-20R		1
● ONE HALF CONTROLLED BY WALL SWITCH  DUPLEX, 1-GANG RECEPTACLE - 5-20R. ONE HALF CONTROLLED BY WALL SWITCH  QUAD, 2-GANG RECEPTACLE, 5-15R UNLESS NOTED  QUAD, 2-GANG RECEPTACLE - FLOOR MOUNTED, 5-15R UNLESS NOTED  QUAD, 2-GANG RECEPTACLE - CEILING MOUNTED, 5-15R UNLESS NOTED  © STOVE RECEPTACLE - 14-50R, 125/250V, 50A  © DRYER RECEPTACLE - 14-30R, 125/250V, 30A  © COMBINATION OUTLET - WALL MOUNTED - AS DETAILED  © COMBINATION OUTLET - FLOOR MOUNTED - AS DETAILED	•••			$\downarrow$
ONE HALF CONTROLLED BY WALL SWITCH  QUAD, 2-GANG RECEPTACLE, 5-15R UNLESS NOTED  QUAD, 2-GANG RECEPTACLE - FLOOR MOUNTED, 5-15R UNLESS NOTED  QUAD, 2-GANG RECEPTACLE - CEILING MOUNTED, 5-15R UNLESS NOTED  STOVE RECEPTACLE - 14-50R, 125/250V, 50A  QDR  DRYER RECEPTACLE - 14-30R, 125/250V, 30A  C  FDNE  COMBINATION OUTLET - WALL MOUNTED - AS DETAILED  COMBINATION OUTLET - FLOOR MOUNTED - AS DETAILED	₩	ONE HALF CONTROLLED BY WALL SWITCH		$\downarrow$
# QUAD, 2-GANG RECEPTACLE - FLOOR MOUNTED, 5-15R UNLESS NOTED  # QUAD, 2-GANG RECEPTACLE - CEILING MOUNTED, 5-15R UNLESS NOTED	•			$\downarrow$
QUAD, 2-GANG RECEPTACLE - CEILING MOUNTED, 5-15R UNLESS NOTED		QUAD, 2-GANG RECEPTACLE, 5-15R UNLESS NOTED		$\downarrow$
	#	QUAD, 2-GANG RECEPTACLE - FLOOR MOUNTED, 5-15R UNLESS NOTED		$\downarrow$
↑	<del>*</del>	QUAD, 2-GANG RECEPTACLE - CEILING MOUNTED, 5-15R UNLESS NOTED		1
FDNE  COMBINATION OUTLET - WALL MOUNTED - AS DETAILED  COMBINATION OUTLET - FLOOR MOUNTED - AS DETAILED  COMBINATION OUTLET - FLOOR MOUNTED - AS DETAILED	Фѕ	STOVE RECEPTACLE - 14-50R, 125/250V, 50A		$\downarrow$
COMBINATION OUTLET - WALL MOUNTED - AS DETAILED  COMBINATION OUTLET - FLOOR MOUNTED - AS DETAILED  COMBINATION OUTLET - FLOOR MOUNTED - AS DETAILED	Φ <sup>DR</sup>	DRYER RECEPTACLE - 14-30R, 125/250V, 30A	<u>©</u>	1
COMBINATION OUTLET - WALL MOUNTED - AS DETAILED  COMBINATION OUTLET - FLOOR MOUNTED - AS DETAILED  COMBINATION OUTLET - FLOOR MOUNTED - AS DETAILED				$\downarrow$
COMBINATION OUTLET - FLOOR MOUNTED - AS DETAILED  COMBINATION OUTLET - FLOOR MOUNTED - AS DETAILED			FDNE	
	<b>P</b>	COMBINATION OUTLET - WALL MOUNTED - AS DETAILED	1	1
	<b>A</b>	COMBINATION OUTLET - FLOOR MOUNTED - AS DETAILED	EWW3	1
SERVICE POLE - SERVICE POLE FEED TO FURNITURE SYSTEM			<u> </u>	1
		SERVICE POLE - SERVICE POLE FEED TO FURNITURE SYSTEM	<u> </u>	$\downarrow$
FEED FOR POWER & COMMUNICATIONS TO SYSTEM FURNITURE - WALL	•	FEED FOR POWER & COMMUNICATIONS TO SYSTEM FURNITURE - WALL		$\downarrow$

MISCELLANE	EOUS LEGEND EXISTING DEVICES ARE TONED:	SYSTEMS L	EGEND	EXISTING DEVIC ARE TONE
$\otimes$	'REFER TO KEYNOTE NOTE' NUMBER	DATA OUTLETS	MOUNTED	
 ⊗	'REFER TO DETAIL NOTE' NUMBER	▽#	WALL	COMPLETE WITH BACKBOX, PULL CORD AN
	DENOTES EXISTING DEVICE(S), WIRING OR CONDUIT TO BE 'REMOVED'	₩#	FLOOR	CONDUIT BACK TO THE NEAREST COMMUN ROOM, CLOSET, OR LOCAL CABLE TRAY, UN
DWG. E-XX	DENOTES MATCHLINE	-\\$\right\r	CEILING	SPECIFICALLY NOTED OTHERWISE "#" DENG OF OUTLETS
# # ***********************************	DENOTES CROSS SECTION DETAIL CALL OUT	VOICE OUTLETS	3	
# ************************************	DENOTES DETAIL CALL OUT	<b>▼</b> #	WALL FLOOR	COMPLETE WITH BACKBOX, PULL CORD AN CONDUIT BACK TO THE NEAREST COMMUN ROOM, CLOSET, OR LOCAL CABLE TRAY, UN SPECIFICALLY NOTED OTHERWISE "#" DENG
XX-X DP-XXXX	- DENOTES MECHANICAL EQUIPMENT TAG - DENOTES PANEL FEED	DATAVOICE OU	CEILING	OF OUTLETS
MISCELLANE	COUS DEVICES:	\\\\\\\\\\\\\\\\\\\\\\\\\\\\\\\\\\\\\\	WALL	COMPLETE WITH BACKBOX, PULL CORD AN
<b></b> 0	CONDUIT RUN UP	<b>™</b>	FLOOR	CONDUIT BACK TO THE NEAREST COMMUN ROOM, CLOSET, OR LOCAL CABLE TRAY, UN
<b>—</b> ⇒	CONDUIT RUN DOWN	- <b>\_</b> #	CEILING	SPECIFICALLY NOTED OTHERWISE "#" DENG OF OUTLETS
———	CONDUIT STUB	FURNITURE OU	L TLETS	1
SR	SURFACE RACEWAY	<b>¥</b> #		IS OUTLET - FURNITURE SYSTEM
(1.0) kW)	ELECTRIC BASEBOARD HEATER, SIZE AND VOLTAGE AS INDICATED.	TV OUTLETS	1	
	ALL BASEBOARDS COMPLETE WITH BUILT-IN THERMOSTAT	TV	WALL	COMPLETE WITH BACKBOX, PULL CORD AN CONDUIT BACK TO THE NEAREST COMMUN
<del>(33333)-</del> (PT)	ELECTRIC PIPE TRACE HEATING CABLE - SIZE AS NOTED REFER TO PIPE TRACE SCHEDULE	- <del> </del>	CEILING	ROOM, CLOSET, OR LOCAL CABLE TRAY, UN SPECIFICALLY NOTED OTHERWISE
<del>()</del> 0 (PT)	ELECTRIC PIPE TRACE HEATING RISER CABLE - SIZE AS NOTED REFER TO PIPE TRACE SCHEDULE	AUDIO/VISUAL I	OCATION	1
DCS	DRYER CURRENT SENSOR	AV	WALL	- AUDIO/VISUAL
<u> </u>	FORCE FLOW HEATER - SURFACE MOUNTED	-AV-	CEILING	,,,,,,,,,,,,,,,,,,,,,,,,,,,,,,,,,,,,,,,
<u> </u>	FORCE FLOW HEATER - RECESSED MOUNTED	(M) (M)	MUSIC SPEAKER	- CEILING, WALL MOUNTED
<u> </u>	UNIT HEATER - CEILING MOUNTED	<u></u> €M	SOUND MASKING	SPEAKER
<del></del>	GROUND BAR	WIRELESS ACC	ESS POINT (WAP) LO	OCATION T
T	LINE VOLTAGE THERMOSTAT		WALL	WIRELESS ACCESS POINT (WIFI)
		ф- 	CEILING	
LIGHTNING PROT	FECTION/GROUNDING DEVICES:			
•	CONNECTION POINT	<u> </u>	CONDUIT DESIGN	IATION
	DOWNLEAD		DATA ZONE CON	DUIT
	LIGHTNING TERMINAL		VOICE ZONE CON	IDUIT
<u> </u>	GROUNDING ROD		DATA RACK - 19"	
	GROUND POINT		CABLE TRAY AS I	
		<u></u> <u> </u>		G & WALL MOUNTED-LINES DENOTE CLOCK FA
FIRE ALARM DEV			SS SYSTEM LOCATION	ON
	MANUAL PULL STATION	P	WALL CEILING	PUBLIC ADDRESS SYSTEM SPEAKER
<u></u>	FIRE FIGHTER'S HANDSET  FIRE ALARM (EVAC) SPEAKER - CEILING, WALL MOUNTED		ACCESS DEVICES	
T P	STROBE LIGHT - CEILING, WALL MOUNTED	CTV	WALL OR	CLOSED CIRCUIT TELEVISION (SECURITY C.
S S	SPEAKER/STROBE COMBINATION DEVICE - CEILING, WALL MOUNTED	MD	CEILING	CLOSED CIRCUIT TELEVISION (SECURITY C.
	·		\ \\\\\\\\\\\\\\\\\\\\\\\\\\\\\\\\\\\\	
	RELL-WALLMOUNTED	-MD-	CEILING	MOTION DETECTOR - SECURITY
	HORN SPEAKER - CEILING, WALL MOUNTED	-MD-	CEILING	MOTION DETECTOR - SECURITY
· · · · · · · · · · · · · · · · · · ·	HORN SPEAKER - CEILING, WALL MOUNTED	GB .	CEILING  WALL  CEILING	- MOTION DETECTOR - SECURITY  - GLASS BREAK SENSING DEVICE
		GB -GB	WALL	
	HORN SPEAKER - CEILING, WALL MOUNTED  HORN SPEAKER/STROBE - CEILING, WALL MOUNTED	GB -GB CR	WALL	
	HORN SPEAKER - CEILING, WALL MOUNTED  HORN SPEAKER/STROBE - CEILING, WALL MOUNTED  SMOKE DETECTOR - CEILING, WALL MOUNTED	GB -GB	WALL CEILING CARD READER	GLASS BREAK SENSING DEVICE
	HORN SPEAKER - CEILING, WALL MOUNTED  HORN SPEAKER/STROBE - CEILING, WALL MOUNTED  SMOKE DETECTOR - CEILING, WALL MOUNTED  SMOKE DETECTOR - CEILING, WALL MOUNTED - SOUNDER BASE	GB -GB- CR DC	WALL CEILING CARD READER DOOR CONTACT	GLASS BREAK SENSING DEVICE
	HORN SPEAKER - CEILING, WALL MOUNTED  HORN SPEAKER/STROBE - CEILING, WALL MOUNTED  SMOKE DETECTOR - CEILING, WALL MOUNTED - SOUNDER BASE  SMOKE DETECTOR - CEILING, WALL MOUNTED - RELAY BASE	GB GB CR DC	WALL CEILING CARD READER DOOR CONTACT ELECTRIC STRIKE	GLASS BREAK SENSING DEVICE
	HORN SPEAKER - CEILING, WALL MOUNTED  HORN SPEAKER/STROBE - CEILING, WALL MOUNTED  SMOKE DETECTOR - CEILING, WALL MOUNTED - SOUNDER BASE  SMOKE DETECTOR - CEILING, WALL MOUNTED - RELAY BASE  DUCT TYPE SMOKE DETECTOR W/REMOTE INDICATION	GB GB CR DC ES	WALL CEILING CARD READER DOOR CONTACT ELECTRIC STRIKE	GLASS BREAK SENSING DEVICE
	HORN SPEAKER - CEILING, WALL MOUNTED  HORN SPEAKER/STROBE - CEILING, WALL MOUNTED  SMOKE DETECTOR - CEILING, WALL MOUNTED - SOUNDER BASE  SMOKE DETECTOR - CEILING, WALL MOUNTED - RELAY BASE  DUCT TYPE SMOKE DETECTOR W/REMOTE INDICATION  PHOTOELECTRIC BEAM TYPE SMOKE DETECTOR	GB GB CR DC ES EL	WALL CEILING CARD READER DOOR CONTACT ELECTRIC STRIKE ELECTRIC LATCH ELECTRO-MAGNE	GLASS BREAK SENSING DEVICE  ETIC LOCKING DEVICE. (MAG LOCK)  DPEN DEVICE
	HORN SPEAKER - CEILING, WALL MOUNTED  HORN SPEAKER/STROBE - CEILING, WALL MOUNTED  SMOKE DETECTOR - CEILING, WALL MOUNTED - SOUNDER BASE  SMOKE DETECTOR - CEILING, WALL MOUNTED - RELAY BASE  DUCT TYPE SMOKE DETECTOR W/REMOTE INDICATION  PHOTOELECTRIC BEAM TYPE SMOKE DETECTOR  HEAT DETECTOR - 130° FIXED TEMPERATURE - CEILING, WALL MOUNTED	GB -GB -CR	WALL CEILING CARD READER DOOR CONTACT ELECTRIC STRIKE ELECTRIC LATCH ELECTRO-MAGNE ELECTRIC HOLD	GLASS BREAK SENSING DEVICE  ETIC LOCKING DEVICE. (MAG LOCK)  OPEN DEVICE  T DEVICE
	HORN SPEAKER - CEILING, WALL MOUNTED  HORN SPEAKER/STROBE - CEILING, WALL MOUNTED  SMOKE DETECTOR - CEILING, WALL MOUNTED - SOUNDER BASE  SMOKE DETECTOR - CEILING, WALL MOUNTED - RELAY BASE  DUCT TYPE SMOKE DETECTOR W/REMOTE INDICATION  PHOTOELECTRIC BEAM TYPE SMOKE DETECTOR  HEAT DETECTOR - 130° FIXED TEMPERATURE - CEILING, WALL MOUNTED  HEAT DETECTOR - 190° FIXED TEMPERATURE - CEILING, WALL MOUNTED	GB GB CR DC ES EL ML EH REX	WALL CEILING CARD READER DOOR CONTACT ELECTRIC STRIKE ELECTRIC LATCH ELECTRO-MAGNE ELECTRIC HOLD REQUEST TO EXI	GLASS BREAK SENSING DEVICE  ETIC LOCKING DEVICE. (MAG LOCK)  OPEN DEVICE  T DEVICE
	HORN SPEAKER - CEILING, WALL MOUNTED  HORN SPEAKER/STROBE - CEILING, WALL MOUNTED  SMOKE DETECTOR - CEILING, WALL MOUNTED - SOUNDER BASE  SMOKE DETECTOR - CEILING, WALL MOUNTED - RELAY BASE  DUCT TYPE SMOKE DETECTOR W/REMOTE INDICATION  PHOTOELECTRIC BEAM TYPE SMOKE DETECTOR  HEAT DETECTOR - 130° FIXED TEMPERATURE - CEILING, WALL MOUNTED  HEAT DETECTOR - 190° FIXED TEMPERATURE - CEILING, WALL MOUNTED  HEAT DETECTOR - RATE OF RISE - CEILING, WALL MOUNTED  SMOKE ALARM C/W INTEGRAL STROBE LIGHT (RESIDENTIAL)	GB GB CR DC ES EL	WALL CEILING CARD READER DOOR CONTACT ELECTRIC STRIKE ELECTRIC LATCH ELECTRO-MAGNE ELECTRIC HOLD REQUEST TO EXI	GLASS BREAK SENSING DEVICE  ETIC LOCKING DEVICE. (MAG LOCK)  OPEN DEVICE  T DEVICE
	HORN SPEAKER - CEILING, WALL MOUNTED  HORN SPEAKER/STROBE - CEILING, WALL MOUNTED  SMOKE DETECTOR - CEILING, WALL MOUNTED - SOUNDER BASE  SMOKE DETECTOR - CEILING, WALL MOUNTED - RELAY BASE  DUCT TYPE SMOKE DETECTOR W/REMOTE INDICATION  PHOTOELECTRIC BEAM TYPE SMOKE DETECTOR  HEAT DETECTOR - 130° FIXED TEMPERATURE - CEILING, WALL MOUNTED  HEAT DETECTOR - RATE OF RISE - CEILING, WALL MOUNTED  SMOKE ALARM C/W INTEGRAL STROBE LIGHT (RESIDENTIAL)  CEILING, WALL MOUNTED  SMOKE ALARM (RESIDENTIAL)		WALL CEILING CARD READER DOOR CONTACT ELECTRIC STRIKE ELECTRIC LATCH ELECTRO-MAGNE ELECTRIC HOLD REQUEST TO EXI SECURITY KEY P.	GLASS BREAK SENSING DEVICE  ETIC LOCKING DEVICE. (MAG LOCK)  OPEN DEVICE  T DEVICE
	HORN SPEAKER - CEILING, WALL MOUNTED  HORN SPEAKER/STROBE - CEILING, WALL MOUNTED  SMOKE DETECTOR - CEILING, WALL MOUNTED - SOUNDER BASE  SMOKE DETECTOR - CEILING, WALL MOUNTED - RELAY BASE  DUCT TYPE SMOKE DETECTOR W/REMOTE INDICATION  PHOTOELECTRIC BEAM TYPE SMOKE DETECTOR  HEAT DETECTOR - 130° FIXED TEMPERATURE - CEILING, WALL MOUNTED  HEAT DETECTOR - RATE OF RISE - CEILING, WALL MOUNTED  SMOKE ALARM C/W INTEGRAL STROBE LIGHT (RESIDENTIAL) CEILING, WALL MOUNTED  SMOKE ALARM (RESIDENTIAL) CEILING, WALL MOUNTED	GB GB CR DC ES EL	WALL CEILING CARD READER DOOR CONTACT ELECTRIC STRIKE ELECTRIC LATCH ELECTRIC HOLD REQUEST TO EXI SECURITY KEY P. DOOR BELL DOOR BUZZER	GLASS BREAK SENSING DEVICE  ETIC LOCKING DEVICE. (MAG LOCK)  OPEN DEVICE  T DEVICE  AD
	HORN SPEAKER - CEILING, WALL MOUNTED  HORN SPEAKER/STROBE - CEILING, WALL MOUNTED  SMOKE DETECTOR - CEILING, WALL MOUNTED - SOUNDER BASE  SMOKE DETECTOR - CEILING, WALL MOUNTED - RELAY BASE  DUCT TYPE SMOKE DETECTOR WIREMOTE INDICATION  PHOTOELECTRIC BEAM TYPE SMOKE DETECTOR  HEAT DETECTOR - 130° FIXED TEMPERATURE - CEILING, WALL MOUNTED  HEAT DETECTOR - RATE OF RISE - CEILING, WALL MOUNTED  SMOKE ALARM C/W INTEGRAL STROBE LIGHT (RESIDENTIAL) CEILING, WALL MOUNTED  SMOKE ALARM (RESIDENTIAL) CEILING, WALL MOUNTED  CARBON MONOXIDE DETECTOR (CO) - CEILING, WALL MOUNTED  COMBINATION SMOKE ALARM/CARBON MONOXIDE (CO) DETECTOR - STROBE		WALL CEILING CARD READER DOOR CONTACT ELECTRIC STRIKE ELECTRIC LATCH ELECTRIC HOLD REQUEST TO EXI SECURITY KEY PO DOOR BELL DOOR BUZZER DOOR CHIME	GLASS BREAK SENSING DEVICE  ETIC LOCKING DEVICE. (MAG LOCK)  OPEN DEVICE  T DEVICE  AD
	HORN SPEAKER - CEILING, WALL MOUNTED  HORN SPEAKER/STROBE - CEILING, WALL MOUNTED  SMOKE DETECTOR - CEILING, WALL MOUNTED - SOUNDER BASE  SMOKE DETECTOR - CEILING, WALL MOUNTED - RELAY BASE  DUCT TYPE SMOKE DETECTOR W/REMOTE INDICATION  PHOTOELECTRIC BEAM TYPE SMOKE DETECTOR  HEAT DETECTOR - 130° FIXED TEMPERATURE - CEILING, WALL MOUNTED  HEAT DETECTOR - 190° FIXED TEMPERATURE - CEILING, WALL MOUNTED  HEAT DETECTOR - RATE OF RISE - CEILING, WALL MOUNTED  SMOKE ALARM C/W INTEGRAL STROBE LIGHT (RESIDENTIAL) CEILING, WALL MOUNTED  SMOKE ALARM (RESIDENTIAL) CEILING, WALL MOUNTED  CARBON MONOXIDE DETECTOR (CO) - CEILING, WALL MOUNTED  COMBINATION SMOKE ALARM/CARBON MONOXIDE (CO) DETECTOR - STROBE CEILING, WALL MOUNTED  COMBINATION SMOKE ALARM/CARBON MONOXIDE (CO) DETECTOR		WALL CEILING CARD READER DOOR CONTACT ELECTRIC STRIKE ELECTRIC LATCH ELECTRIC HOLD REQUEST TO EXI SECURITY KEY P. DOOR BELL DOOR BUZZER DOOR CHIME PANIC ALARM BU	ETIC LOCKING DEVICE. (MAG LOCK)  OPEN DEVICE  T DEVICE  AD
	HORN SPEAKER - CEILING, WALL MOUNTED  HORN SPEAKER/STROBE - CEILING, WALL MOUNTED  SMOKE DETECTOR - CEILING, WALL MOUNTED - SOUNDER BASE  SMOKE DETECTOR - CEILING, WALL MOUNTED - RELAY BASE  DUCT TYPE SMOKE DETECTOR WIREMOTE INDICATION  PHOTOELECTRIC BEAM TYPE SMOKE DETECTOR  HEAT DETECTOR - 130° FIXED TEMPERATURE - CEILING, WALL MOUNTED  HEAT DETECTOR - RATE OF RISE - CEILING, WALL MOUNTED  HEAT DETECTOR - RATE OF RISE - CEILING, WALL MOUNTED  SMOKE ALARM C/W INTEGRAL STROBE LIGHT (RESIDENTIAL)  CEILING, WALL MOUNTED  SMOKE ALARM (RESIDENTIAL)  CEILING, WALL MOUNTED  CARBON MONOXIDE DETECTOR (CO) - CEILING, WALL MOUNTED  COMBINATION SMOKE ALARM/CARBON MONOXIDE (CO) DETECTOR - STROBE  CEILING, WALL MOUNTED  COMBINATION SMOKE ALARM/CARBON MONOXIDE (CO) DETECTOR  CEILING, WALL MOUNTED		WALL CEILING CARD READER DOOR CONTACT ELECTRIC STRIKE ELECTRIC LATCH ELECTRIC HOLD REQUEST TO EXI SECURITY KEY P DOOR BELL DOOR BUZZER DOOR CHIME PANIC ALARM BU SONA ALERT	ETIC LOCKING DEVICE. (MAG LOCK)  DPEN DEVICE  T DEVICE  AD  TTON
	HORN SPEAKER - CEILING, WALL MOUNTED  HORN SPEAKER/STROBE - CEILING, WALL MOUNTED  SMOKE DETECTOR - CEILING, WALL MOUNTED - SOUNDER BASE  SMOKE DETECTOR - CEILING, WALL MOUNTED - RELAY BASE  DUCT TYPE SMOKE DETECTOR W/REMOTE INDICATION  PHOTOELECTRIC BEAM TYPE SMOKE DETECTOR  HEAT DETECTOR - 130° FIXED TEMPERATURE - CEILING, WALL MOUNTED  HEAT DETECTOR - RATE OF RISE - CEILING, WALL MOUNTED  SMOKE ALARM C/W INTEGRAL STROBE LIGHT (RESIDENTIAL)  CEILING, WALL MOUNTED  CARBON MONOXIDE DETECTOR (CO) - CEILING, WALL MOUNTED  COMBINATION SMOKE ALARM/CARBON MONOXIDE (CO) DETECTOR - STROBE CEILING, WALL MOUNTED  COMBINATION SMOKE ALARM/CARBON MONOXIDE (CO) DETECTOR CEILING, WALL MOUNTED	BB GB CR	WALL CEILING CARD READER DOOR CONTACT ELECTRIC STRIKE ELECTRIC LATCH ELECTRIC HOLD REQUEST TO EXI SECURITY KEY P. DOOR BELL DOOR BUZZER DOOR CHIME PANIC ALARM BU SONA ALERT DOOR RELEASE I	ETIC LOCKING DEVICE. (MAG LOCK)  DPEN DEVICE  T DEVICE  AD  TTON
	HORN SPEAKER - CEILING, WALL MOUNTED  HORN SPEAKER/STROBE - CEILING, WALL MOUNTED  SMOKE DETECTOR - CEILING, WALL MOUNTED - SOUNDER BASE  SMOKE DETECTOR - CEILING, WALL MOUNTED - RELAY BASE  DUCT TYPE SMOKE DETECTOR WREMOTE INDICATION  PHOTOELECTRIC BEAM TYPE SMOKE DETECTOR  HEAT DETECTOR - 130° FIXED TEMPERATURE - CEILING, WALL MOUNTED  HEAT DETECTOR - 190° FIXED TEMPERATURE - CEILING, WALL MOUNTED  HEAT DETECTOR - RATE OF RISE - CEILING, WALL MOUNTED  SMOKE ALARM C/W INTEGRAL STROBE LIGHT (RESIDENTIAL) CEILING, WALL MOUNTED  SMOKE ALARM (RESIDENTIAL) CEILING, WALL MOUNTED  CARBON MONOXIDE DETECTOR (CO) - CEILING, WALL MOUNTED  COMBINATION SMOKE ALARM/CARBON MONOXIDE (CO) DETECTOR - STROBE CEILING, WALL MOUNTED  COMBINATION SMOKE ALARM/CARBON MONOXIDE (CO) DETECTOR CEILING, WALL MOUNTED  REMOTE PILOT LIGHT FOR SMOKE DETECTOR - CEILING, WALL MOUNTED		WALL CEILING CARD READER DOOR CONTACT ELECTRIC STRIKE ELECTRIC LATCH ELECTRIC HOLD REQUEST TO EXI SECURITY KEY P. DOOR BELL DOOR BUZZER DOOR CHIME PANIC ALARM BU SONA ALERT DOOR RELEASE I	ETIC LOCKING DEVICE. (MAG LOCK)  DPEN DEVICE T DEVICE AD  TTON  BUTTON HOLDER LEASE PULL STATION - BLUE
	HORN SPEAKER - CEILING, WALL MOUNTED  HORN SPEAKER/STROBE - CEILING, WALL MOUNTED  SMOKE DETECTOR - CEILING, WALL MOUNTED - SOUNDER BASE  SMOKE DETECTOR - CEILING, WALL MOUNTED - RELAY BASE  DUCT TYPE SMOKE DETECTOR WREMOTE INDICATION  PHOTOELECTRIC BEAM TYPE SMOKE DETECTOR  HEAT DETECTOR - 130° FIXED TEMPERATURE - CEILING, WALL MOUNTED  HEAT DETECTOR - 190° FIXED TEMPERATURE - CEILING, WALL MOUNTED  HEAT DETECTOR - RATE OF RISE - CEILING, WALL MOUNTED  SMOKE ALARM C/W INTEGRAL STROBE LIGHT (RESIDENTIAL) CEILING, WALL MOUNTED  SMOKE ALARM (RESIDENTIAL) CEILING, WALL MOUNTED  CARBON MONOXIDE DETECTOR (CO) - CEILING, WALL MOUNTED  COMBINATION SMOKE ALARM/CARBON MONOXIDE (CO) DETECTOR - STROBE CEILING, WALL MOUNTED  COMBINATION SMOKE ALARM/CARBON MONOXIDE (CO) DETECTOR CEILING, WALL MOUNTED  REMOTE PILOT LIGHT FOR SMOKE DETECTOR - CEILING, WALL MOUNTED  FIRE ALARM CONNECTION TO DEVICE AS INDICATED		WALL CEILING CARD READER DOOR CONTACT ELECTRIC STRIKE ELECTRIC LATCH ELECTRIC HOLD REQUEST TO EXI SECURITY KEY PO DOOR BELL DOOR BUZZER DOOR CHIME PANIC ALARM BU SONA ALERT DOOR RELEASE E MAGNETIC DOOR EMERGENCY RELEASE	GLASS BREAK SENSING DEVICE  ETIC LOCKING DEVICE. (MAG LOCK)  OPEN DEVICE T DEVICE AD  TTON  BUTTON HOLDER  LEASE PULL STATION - BLUE ES:
	HORN SPEAKER - CEILING, WALL MOUNTED  HORN SPEAKER/STROBE - CEILING, WALL MOUNTED  SMOKE DETECTOR - CEILING, WALL MOUNTED - SOUNDER BASE  SMOKE DETECTOR - CEILING, WALL MOUNTED - RELAY BASE  DUCT TYPE SMOKE DETECTOR WREMOTE INDICATION  PHOTOELECTRIC BEAM TYPE SMOKE DETECTOR  HEAT DETECTOR - 130° FIXED TEMPERATURE - CEILING, WALL MOUNTED  HEAT DETECTOR - RATE OF RISE - CEILING, WALL MOUNTED  SMOKE ALARM C/W INTEGRAL STROBE LIGHT (RESIDENTIAL) CEILING, WALL MOUNTED  SMOKE ALARM (RESIDENTIAL) CEILING, WALL MOUNTED  CARBON MONOXIDE DETECTOR (CO) - CEILING, WALL MOUNTED  COMBINATION SMOKE ALARM/CARBON MONOXIDE (CO) DETECTOR - STROBE CEILING, WALL MOUNTED  COMBINATION SMOKE ALARM/CARBON MONOXIDE (CO) DETECTOR CEILING, WALL MOUNTED  REMOTE PILOT LIGHT FOR SMOKE DETECTOR - CEILING, WALL MOUNTED  FIRE ALARM CONNECTION TO DEVICE AS INDICATED  FIRE ALARM PANEL AS INDICATED - DGP, CONTROL, ANNUNCIATOR	BARRIER-FREE	WALL CEILING CARD READER DOOR CONTACT ELECTRIC STRIKE ELECTRIC LATCH ELECTRIC HOLD REQUEST TO EXI SECURITY KEY P DOOR BELL DOOR BUZZER DOOR CHIME PANIC ALARM BU SONA ALERT DOOR RELEASE E MAGNETIC DOOR EMERGENCY REI WASHROOM DEVIC	GLASS BREAK SENSING DEVICE  ETIC LOCKING DEVICE. (MAG LOCK)  OPEN DEVICE T DEVICE AD  TTON  BUTTON HOLDER  LEASE PULL STATION - BLUE ES:
	HORN SPEAKER - CEILING, WALL MOUNTED  HORN SPEAKER/STROBE - CEILING, WALL MOUNTED  SMOKE DETECTOR - CEILING, WALL MOUNTED - SOUNDER BASE  SMOKE DETECTOR - CEILING, WALL MOUNTED - RELAY BASE  DUCT TYPE SMOKE DETECTOR WIREMOTE INDICATION  PHOTOELECTRIC BEAM TYPE SMOKE DETECTOR  HEAT DETECTOR - 130° FIXED TEMPERATURE - CEILING, WALL MOUNTED  HEAT DETECTOR - 190° FIXED TEMPERATURE - CEILING, WALL MOUNTED  HEAT DETECTOR - RATE OF RISE - CEILING, WALL MOUNTED  SMOKE ALARM CW INTEGRAL STROBE LIGHT (RESIDENTIAL)  CEILING, WALL MOUNTED  CARBON MONOXIDE DETECTOR (CO) - CEILING, WALL MOUNTED  COMBINATION SMOKE ALARM/CARBON MONOXIDE (CO) DETECTOR - STROBE  CEILING, WALL MOUNTED  COMBINATION SMOKE ALARM/CARBON MONOXIDE (CO) DETECTOR  CEILING, WALL MOUNTED  REMOTE PILOT LIGHT FOR SMOKE DETECTOR - CEILING, WALL MOUNTED  FIRE ALARM CONNECTION TO DEVICE AS INDICATED  FIRE ALARM PANEL AS INDICATED - DGP, CONTROL, ANNUNCIATOR  FIRE ALARM LINE ISOLATION MODULE	BARRIER-FREE	WALL CEILING CARD READER DOOR CONTACT ELECTRIC STRIKE ELECTRIC LATCH ELECTRIC HOLD REQUEST TO EXI SECURITY KEY P DOOR BELL DOOR BUZZER DOOR CHIME PANIC ALARM BU SONA ALERT DOOR RELEASE E MAGNETIC DOOR EMERGENCY REI WASHROOM DEVIC	GLASS BREAK SENSING DEVICE  ETIC LOCKING DEVICE. (MAG LOCK)  OPEN DEVICE T DEVICE AD  TTON  BUTTON  HOLDER  EASE PULL STATION - BLUE  ES: R  OOR OPERATOR ACTUATOR
	HORN SPEAKER - CEILING, WALL MOUNTED  HORN SPEAKER/STROBE - CEILING, WALL MOUNTED  SMOKE DETECTOR - CEILING, WALL MOUNTED - SOUNDER BASE  SMOKE DETECTOR - CEILING, WALL MOUNTED - RELAY BASE  DUCT TYPE SMOKE DETECTOR WIREMOTE INDICATION  PHOTOELECTRIC BEAM TYPE SMOKE DETECTOR  HEAT DETECTOR - 130° FIXED TEMPERATURE - CEILING, WALL MOUNTED  HEAT DETECTOR - RATE OF RISE - CEILING, WALL MOUNTED  SMOKE ALARM C/W INTEGRAL STROBE LIGHT (RESIDENTIAL)  CEILING, WALL MOUNTED  CARBON MONOXIDE DETECTOR (CO) - CEILING, WALL MOUNTED  COMBINATION SMOKE ALARM/CARBON MONOXIDE (CO) DETECTOR - STROBE CEILING, WALL MOUNTED  COMBINATION SMOKE ALARM/CARBON MONOXIDE (CO) DETECTOR CEILING, WALL MOUNTED  REMOTE PILOT LIGHT FOR SMOKE DETECTOR - CEILING, WALL MOUNTED  FIRE ALARM CONNECTION TO DEVICE AS INDICATED  FIRE ALARM PANEL AS INDICATED - DGP, CONTROL, ANNUNCIATOR  FIRE ALARM LINE ISOLATION MODULE  FIRE ALARM END OF LINE RESISTOR	GB GP CR CR DO ES ES EL AL	WALL CEILING CARD READER DOOR CONTACT ELECTRIC STRIKE ELECTRIC LATCH ELECTRIC HOLD REQUEST TO EXI SECURITY KEY P. DOOR BELL DOOR BUZZER DOOR CHIME PANIC ALARM BU SONA ALERT DOOR RELEASE E MAGNETIC DOOR EMERGENCY RELEASE E WASHROOM DEVIC DOOR OPERATOR BARRIER-FREE D	GLASS BREAK SENSING DEVICE  ETIC LOCKING DEVICE. (MAG LOCK)  OPEN DEVICE  T DEVICE  AD  TTON  BUTTON  HOLDER  EASE PULL STATION - BLUE  ES:  R  OOR OPERATOR ACTUATOR  BUTTON
	HORN SPEAKER - CEILING, WALL MOUNTED  HORN SPEAKER/STROBE - CEILING, WALL MOUNTED  SMOKE DETECTOR - CEILING, WALL MOUNTED - SOUNDER BASE  SMOKE DETECTOR - CEILING, WALL MOUNTED - RELAY BASE  DUCT TYPE SMOKE DETECTOR WIREMOTE INDICATION  PHOTOELECTRIC BEAM TYPE SMOKE DETECTOR  HEAT DETECTOR - 130° FIXED TEMPERATURE - CEILING, WALL MOUNTED  HEAT DETECTOR - RATE OF RISE - CEILING, WALL MOUNTED  SMOKE ALARM CW INTEGRAL STROBE LIGHT (RESIDENTIAL) CEILING, WALL MOUNTED  CARBON MONOXIDE DETECTOR (CO) - CEILING, WALL MOUNTED  COMBINATION SMOKE ALARM/CARBON MONOXIDE (CO) DETECTOR - STROBE CEILING, WALL MOUNTED  COMBINATION SMOKE ALARM/CARBON MONOXIDE (CO) DETECTOR CEILING, WALL MOUNTED  FIRE ALARM CONNECTION TO DEVICE AS INDICATED  FIRE ALARM PANEL AS INDICATED - DGP, CONTROL, ANNUNCIATOR  FIRE ALARM LINE ISOLATION MODULE  FIRE ALARM END OF LINE RESISTOR  FIRE ALARM CONNECTION TO SMOKE DAMPER	GB GP CR CR DC ES ES EL ML EH REX EP SA CH AB ACH	WALL CEILING CARD READER DOOR CONTACT ELECTRIC STRIKE ELECTRIC LATCH ELECTRIC HOLD REQUEST TO EXI SECURITY KEY P. DOOR BELL DOOR BUZZER DOOR CHIME PANIC ALARM BU SONA ALERT DOOR RELEASE I MAGNETIC DOOR EMERGENCY REI WASHROOM DEVIC DOOR OPERATOR BARRIER-FREE D DURESS ALARM I	GLASS BREAK SENSING DEVICE  ETIC LOCKING DEVICE. (MAG LOCK)  OPEN DEVICE  T DEVICE  AD  TTON  BUTTON  HOLDER  EASE PULL STATION - BLUE  ES:  R  OOR OPERATOR ACTUATOR  BUTTON
	HORN SPEAKER - CEILING, WALL MOUNTED  HORN SPEAKER/STROBE - CEILING, WALL MOUNTED  SMOKE DETECTOR - CEILING, WALL MOUNTED - SOUNDER BASE  SMOKE DETECTOR - CEILING, WALL MOUNTED - SOUNDER BASE  SMOKE DETECTOR - CEILING, WALL MOUNTED - RELAY BASE  DUCT TYPE SMOKE DETECTOR W/REMOTE INDICATION  PHOTOELECTRIC BEAM TYPE SMOKE DETECTOR  HEAT DETECTOR - 130° FIXED TEMPERATURE - CEILING, WALL MOUNTED  HEAT DETECTOR - 190° FIXED TEMPERATURE - CEILING, WALL MOUNTED  HEAT DETECTOR - RATE OF RISE - CEILING, WALL MOUNTED  SMOKE ALARM C/W INTEGRAL STROBE LIGHT (RESIDENTIAL)  CEILING, WALL MOUNTED  CARBON MONOXIDE DETECTOR (CO) - CEILING, WALL MOUNTED  COMBINATION SMOKE ALARM/CARBON MONOXIDE (CO) DETECTOR - STROBE  CEILING, WALL MOUNTED  COMBINATION SMOKE ALARM/CARBON MONOXIDE (CO) DETECTOR CEILING, WALL MOUNTED  REMOTE PILOT LIGHT FOR SMOKE DETECTOR - CEILING, WALL MOUNTED  FIRE ALARM CONNECTION TO DEVICE AS INDICATED  FIRE ALARM PANEL AS INDICATED - DGP, CONTROL, ANNUNCIATOR  FIRE ALARM END OF LINE RESISTOR  FIRE ALARM END OF LINE RESISTOR  FIRE ALARM CONNECTION TO SMOKE DAMPER  FIRE ALARM CONNECTION TO SMOKE DAMPER	BB GR	WALL CEILING CARD READER DOOR CONTACT ELECTRIC STRIKE ELECTRIC LATCH ELECTRIC HOLD REQUEST TO EXI SECURITY KEY P. DOOR BELL DOOR BUZZER DOOR CHIME PANIC ALARM BU SONA ALERT DOOR RELEASE I MAGNETIC DOOR EMERGENCY REL WASHROOM DEVIC DOOR OPERATOR BARRIER-FREE D DURESS ALARM II INTERCOM DEVICE SYSTEM PUSH BIS	GLASS BREAK SENSING DEVICE  TIC LOCKING DEVICE. (MAG LOCK)  DPEN DEVICE  T DEVICE  AD  TTON  BUTTON  HOLDER  EASE PULL STATION - BLUE  ES:  R  OOR OPERATOR ACTUATOR  BUTTON  SE

SYSTEMS LE	GEND	DISTRIBUTIO	N LEG	
DATA OUTLETS	MOUNTED	ARE TONED. CR	<u>-</u> -}}	TRAN
∇#	WALL			ISOL
		COMPLETE WITH BACKBOX, PULL CORD AND 27mm CONDUIT BACK TO THE NEAREST COMMUNICATIONS		
<b>□</b> #	FLOOR	ROOM, CLOSET, OR LOCAL CABLE TRAY, UNLESS SPECIFICALLY NOTED OTHERWISE "#" DENOTES NUMBER OF OUTLETS	Δ	DEL1
-☆#	CEILING	OF COTLETS	ļ ĻĒ	WYE
VOICE OUTLETS			<u> -</u> Μ-	CUR
<b>▼</b> #	WALL	COMPLETE WITH BACKBOX, PULL CORD AND 27mm CONDUIT BACK TO THE NEAREST COMMUNICATIONS	_{}	POTE
<b>#</b>	FLOOR	ROOM, CLOSET, OR LOCAL CABLE TRAY, UNLESS  SPECIFICALLY NOTED OTHERWISE "#" DENOTES NUMBER		MOL
-₩-#	CEILING	OF OUTLETS	M_	МОТ
DATA/VOICE OUT	LETS			AIR (
<b>▼</b> #	WALL	COMPLETE WITH BACKBOX, PULL CORD AND 27mm	<b>⟨←→&gt;</b>	AIR (
<b>™</b> #	FLOOR	CONDUIT BACK TO THE NEAREST COMMUNICATIONS ROOM, CLOSET, OR LOCAL CABLE TRAY, UNLESS	<b> </b>	HIGH
- <b>\_</b>	CEILING	SPECIFICALLY NOTED OTHERWISE "#" DENOTES NUMBER OF OUTLETS	<del>                                    </del>	CON
FURNITURE OUT				CON
₩#		COLITIET FURNITURE SYSTEM		FUSE
•		S OUTLET - FURNITURE SYSTEM		
<b>¥</b> #	TELEPHONE OUTL	.ET - FURNITURE SYSTEM		DISC
TV OUTLETS				DISC
TV	WALL	COMPLETE WITH BACKBOX, PULL CORD AND 27mm CONDUIT BACK TO THE NEAREST COMMUNICATIONS		LOA
- <del>[</del> -	CEILING	ROOM, CLOSET, OR LOCAL CABLE TRAY, UNLESS SPECIFICALLY NOTED OTHERWISE		TRAN
AUDIO/VISUAL LO	DCATION			FEE
AV	WALL			BUS
-AV-	CEILING	AUDIO/VISUAL		BUS
	MUSIC SPEAKER -	CEILING, WALL MOUNTED	<u> </u>	GEN
SM)	SOUND MASKING		(K)	KIRK
	SS POINT (WAP) LO			UTIL
W	WALL			UTIL
		WIRELESS ACCESS POINT (WIFI)		UTIL
<u>-₩</u> -	CEILING			
			M	METI
	CONDUIT DESIGNA	ATION	DMS	DIGI
$\rightarrow$	DATA ZONE COND	UIT	SPD	SUR
<b>-</b>	VOICE ZONE CONI	DUIT	NGR	NEU <sup>-</sup>
	DATA RACK - 19"		[GFP]	GRO
	CABLE TRAY AS N	OTED	<u>                                   </u>	GRO
西 (A)	CLOCKS - CEILING	& WALL MOUNTED-LINES DENOTE CLOCK FACE DIRECTION	<b>⊶</b> ⊶	LIGH
PUBLIC ADDRES	S SYSTEM LOCATIO	N	<u> </u>	LIGH
P	WALL	PUBLIC ADDRESS SYSTEM SPEAKER	•	STRE
P	CEILING	PUBLIC ADDRESS SYSTEM SPEAKER	R	RELA
SECURITY AND A	ACCESS DEVICES		A	AMM
<u>CTV</u> ✓	WALL OR CEILING	CLOSED CIRCUIT TELEVISION (SECURITY CAMERA)	$\bigcirc$	VOL
MD	WALL		6	SING
-MD-	CEILING	MOTION DETECTOR - SECURITY	<del>,</del>	THRI
GB	WALL			PANI
	CEILING	GLASS BREAK SENSING DEVICE		PANI
'				I AINI
	CARD READER			
DC	DOOR CONTACT			
ES	ELECTRIC STRIKE		R RL	R-R
EL .	ELECTRIC LATCH			DEN
ML	ELECTRO-MAGNE	FIC LOCKING DEVICE. (MAG LOCK)	R <sub>(II)</sub> R <sub>77</sub>	DEN
EH	ELECTRIC HOLD C	PEN DEVICE	(S) RL	DEN
REX	REQUEST TO EXIT	DEVICE		Г
KP	SECURITY KEY PA	D	$\Phi \nabla$	EXIS
×-	DOOR BELL			
BL	DOOR BUZZER			
			ABBREVIATIONS	:
BZ	DOOR BUZZER	TON	AFI - ARC FAUL	T INTE
BZ CH	DOOR BUZZER  DOOR CHIME	TON	AFI - ARC FAUL AF - AMPS FRAI AV - AUDIO/VISI	T INTE ME UAL DE
BZ CH AB	DOOR BUZZER  DOOR CHIME  PANIC ALARM BUT		AFI - ARC FAUL AF - AMPS FRAI AV - AUDIO/VISI CH - COUNTER CLG - CEILING	T INTE ME UAL DE HEIGH
BZ BZ CH AB SA DR	DOOR BUZZER  DOOR CHIME  PANIC ALARM BUT  SONA ALERT	UTTON	AFI - ARC FAUL AF - AMPS FRAI AV - AUDIO/VISI CH - COUNTER CLG - CEILING DW - DISHWASI GFI - GROUND F	T INTE ME UAL DE HEIGH HER FAULT
BZ CH AB SA DR	DOOR BUZZER  DOOR CHIME  PANIC ALARM BUT  SONA ALERT  DOOR RELEASE B  MAGNETIC DOOR	UTTON HOLDER	AFI - ARC FAUL AF - AMPS FRAI AV - AUDIO/VISI CH - COUNTER CLG - CEILING DW - DISHWASH GFI - GROUND GND - GROUND HK - HOUSE KEI	T INTE ME UAL DE HEIGH FAULT EPING
ER	DOOR BUZZER  DOOR CHIME  PANIC ALARM BUT  SONA ALERT  DOOR RELEASE B  MAGNETIC DOOR  EMERGENCY RELE	UTTON HOLDER EASE PULL STATION - BLUE	AFI - ARC FAUL' AF - AMPS FRAI AV - AUDIO/VISI CH - COUNTER CLG - CEILING DW - DISHWASH GFI - GROUND F GND - GROUND HK - HOUSE KEI IDF - INTERMED K - KEY OPERAT	T INTE ME UAL DE HEIGH HER FAULT EPING DIATE D TRIBU
BARRIER-FREE V	DOOR BUZZER  DOOR CHIME  PANIC ALARM BUT  SONA ALERT  DOOR RELEASE B  MAGNETIC DOOR  EMERGENCY RELE  VASHROOM DEVICE	UTTON HOLDER EASE PULL STATION - BLUE S:	AFI - ARC FAUL AF - AMPS FRAI AV - AUDIO/VISI CH - COUNTER CLG - CEILING DW - DISHWASH GFI - GROUND F GND - GROUND HK - HOUSE KE IDF - INTERMED K - KEY OPERA MDF - MAIN DIS MM - MULTIMOD (N) - NORMAL C	T INTE ME UAL DE HEIGH FAULT EPING IATE E TED TRIBU
BZ CH AB SA DR DH ER BARRIER-FREE V	DOOR BUZZER  DOOR CHIME  PANIC ALARM BUT  SONA ALERT  DOOR RELEASE B  MAGNETIC DOOR  EMERGENCY RELE  VASHROOM DEVICE  DOOR OPERATOR	UTTON HOLDER EASE PULL STATION - BLUE S:	AFI - ARC FAUL AF - AMPS FRAI AV - AUDIO/VISI CH - COUNTER CLG - CEILING DW - DISHWASH GFI - GROUND F GND - GROUND HK - HOUSE KE IDF - INTERMED K - KEY OPERAT MDF - MAIN DIS	T INTE ME UAL DE HEIGH FAULT EPING DIATE D TRIBU DE IRCUIT IT BRANG
BZ CH AB SA DR DH ER BARRIER-FREE V DO BF	DOOR BUZZER  DOOR CHIME  PANIC ALARM BUT  SONA ALERT  DOOR RELEASE B  MAGNETIC DOOR  EMERGENCY RELE  VASHROOM DEVICE  DOOR OPERATOR	UTTON HOLDER EASE PULL STATION - BLUE S:	AFI - ARC FAUL AF - AMPS FRAI AV - AUDIO/VISI CH - COUNTER CLG - CEILING DW - DISHWASH GFI - GROUND GND - GROUND HK - HOUSE KEI IDF - INTERMED K - KEY OPERA MDF - MAIN DIS MM - MULTIMOE (N) - NORMAL C NL - NIGHT LIGH PBX - PRIVATE R - TO BE REMO RL - RELOCATE	T INTE ME UAL DE HEIGH FAULT EPING DIATE D TRIBU DE BRANG DVED D POS JIR
BZ CH AB SA OR DH ER BARRIER-FREE V DO BF	DOOR BUZZER  DOOR CHIME  PANIC ALARM BUT  SONA ALERT  DOOR RELEASE B  MAGNETIC DOOR  EMERGENCY RELE  VASHROOM DEVICE  DOOR OPERATOR	UTTON HOLDER EASE PULL STATION - BLUE S: DOR OPERATOR ACTUATOR	AFI - ARC FAUL AF - AMPS FRAI AV - AUDIO/VISI CH - COUNTER CLG - CEILING DW - DISHWASH GFI - GROUND HK - HOUSE KEI IDF - INTERMED K - KEY OPERA' MDF - MAIN DIS MM - MULTIMOE (N) - NOGMAL C NL - NIGHT LIGH PBX - PRIVATE I R - TO BE REMO RL - RELOCATE R/A - RETURN A (SC) - SEPARAT SM - SINGLE MO	T INTE ME UAL DE HEIGH HER FAULT EPING DIATE D TRIBU DE IRCUIT HT BRANG DVED D POS JIR E CIRC DDE
BZ CH AB SA DR DH ER BARRIER-FREE V DO BF	DOOR BUZZER  DOOR CHIME  PANIC ALARM BUT  SONA ALERT  DOOR RELEASE B  MAGNETIC DOOR  EMERGENCY RELE  VASHROOM DEVICE  DOOR OPERATOR  BARRIER-FREE DO	UTTON HOLDER EASE PULL STATION - BLUE S: DOR OPERATOR ACTUATOR	AFI - ARC FAUL AF - AMPS FRAI AV - AUDIO/VISI CH - COUNTER CLG - CEILING DW - DISHWASH GFI - GROUND HK - HOUSE KEI IDF - INTERMED K - KEY OPERAT MDF - MAIN DIS MM - MULTIMOE (N) - NORMAL C NL - NIGHT LIGH PBX - PRIVATE L R - TO BE REMO RL - RELOCATE R/A - RETURN A (SC) - SEPARAT SM - SINGLE MO TEMP - TEMPOR TL - TWIST LOC	T INTE ME UAL DE HEIGH FAULT EPING DIATE D TRIBU DE IRCUIT IT BRANG D POS IR E CIRC DE RARY K
BZ CH AB SA OR DH ER BARRIER-FREE V DO BF IC	DOOR BUZZER  DOOR CHIME  PANIC ALARM BUT  SONA ALERT  DOOR RELEASE B  MAGNETIC DOOR  EMERGENCY RELE  VASHROOM DEVICE  DOOR OPERATOR  BARRIER-FREE DO  DURESS ALARM B	UTTON HOLDER EASE PULL STATION - BLUE S: DOR OPERATOR ACTUATOR UTTON	AFI - ARC FAUL AF - AMPS FRAI AV - AUDIO/VISI CH - COUNTER CLG - CEILING DW - DISHWASH GFI - GROUND HK - HOUSE KE IDF - INTERMED K - KEY OPERA MDF - MAIN DIS MM - MULTIMOD (N) - NORMAL C NL - NIGHT LIGH PBX - PRIVATE R - TO BE REMO RL - RELOCATE R/A - RETURN A (SC) - SEPARAT SM - SINGLE MO TEMP - TEMPOF TL - TWIST LOC TR - TAMPER R U/G - UNDERGR	T INTE ME UAL DE HEIGH FAULT EPING DIATE D TRIBU DE IRCUIT BRANG DVED D POS IR E CIRC DDE RARY K ESIST/R COUND OTHER
BARRIER-FREE V	DOOR BUZZER  DOOR CHIME  PANIC ALARM BUT  SONA ALERT  DOOR RELEASE B  MAGNETIC DOOR  EMERGENCY RELE  VASHROOM DEVICE  DOOR OPERATOR  BARRIER-FREE DO  DURESS ALARM B  INTERCOM DEVICE  SYSTEM PUSH BU	UTTON HOLDER EASE PULL STATION - BLUE S: DOOR OPERATOR ACTUATOR UTTON	AFI - ARC FAUL AF - AMPS FRAI AV - AUDIO/VISI CH - COUNTER CLG - CEILING DW - DISHWASH GFI - GROUND HK - HOUSE KEI IDF - INTERMED K - KEY OPERA MDF - MAIN DIS MM - MULTIMOE (N) - NORMAL C NL - NIGHT LIGH PBX - PRIVATE R - TO BE REMO RL - RETURN A (SC) - SEPARAT SM - SINGLE MO TEMP - TEMPOF TL - TWIST LOC TR - TAMPER R U/G - UNDERGR UON - UNLESS OUTP - UNSHIELL WG - WIRE GUA	T INTE ME UAL DE HEIGH HER FAULT EPING DIATE D TRIBU DE IRCUIT HT BRANC DVED D POS IR E CIRC DOE RARY K ESISTA ROUND OTHER DED TV
BZ CH AB SA OR DH ER BARRIER-FREE V DO BF IC	DOOR BUZZER  DOOR CHIME  PANIC ALARM BUT  SONA ALERT  DOOR RELEASE B  MAGNETIC DOOR  EMERGENCY RELE  VASHROOM DEVICE  DOOR OPERATOR  BARRIER-FREE DO  DURESS ALARM B  INTERCOM DEVICE  SYSTEM PUSH BU	UTTON HOLDER EASE PULL STATION - BLUE S:  DOR OPERATOR ACTUATOR  UTTON  TON LOCATION  STANCE - AUDIBLE & VISUAL SIGNAL	AFI - ARC FAUL AF - AMPS FRAI AV - AUDIO/VISI CH - COUNTER CLG - CEILING DW - DISHWASH GFI - GROUND HK - HOUSE KE IDF - INTERMED K - KEY OPERA MDF - MAIN DIS MM - MULTIMOE (N) - NORMAL C NL - NIGHT LIGH PBX - PRIVATE R - TO BE REMO RL - RELOCATE R/A - RETURN A (SC) - SEPARAT SM - SINGLE MO TEMP - TEMPOH TL - TWIST LOC TR - TAMPER R U/G - UNDERGR UON - UNLESS O	T INTE ME UAL DE HEIGH HER FAULT EPING DIATE D TRIBU DE IRCUIT HT BRANC DVED D POS IR E CIRC DOE RARY K ESISTA ROUND OTHER DED TV

	DN LEGEND	ARE TONED :	
<sup>Δ</sup> ξξ <sup>Α</sup> *	TRANSFORMER. VOLTAGE	AND RATING AS INDICATED.	
<b>∄</b> E	ISOLATION TRANSFORMER	C/W ELECTROSTATIC SHIELD	
Δ	DELTA		
<u> </u>	WYE		
<u></u> γ	CURRENT TRANSFORMER	(CT)	
<u>_</u> -{}	POTENTIAL TRANSFORMER		
<u> </u>	MOLDED CASE CIRCUIT BR	EAKER (EIXED)	
		, ,	
	MOTORIZED CIRCUIT BREA		
	AIR CIRCUIT BREAKER (FIX	ED)	
< <del>⟨</del> →⟩	AIR CIRCUIT BREAKER (DR	AW OUT)	
<b></b>	HIGH VOLTAGE CIRCUIT BF	REAKER	
$\bigoplus$	CONTACTOR - NORMALLY	OPEN	
<del>W</del>	CONTACTOR - NORMALLY	CLOSED	
———	FUSE		
	DISCONNECT SWITCH (FUS	SED)	
	DISCONNECT SWITCH (UNFUSED)		
	LOAD BREAK SWITCH		
_ <u> </u>			
<u> † </u>	TRANSFER SWITCH (AUTO)	иA LIC OR MANUAL)	
	FEEDER		
	BUS		
	BUS DUCT RISER		
<u> </u>	GENERATOR		
(K)	KIRK KEY INTERLOCK		
	UTILITY METER		
<u></u>	UTILITY METER SOCKET		
	UTILITY METER CABINET		
М	METERING POINT		
DMS	DIGITAL METERING SYSTEM	vi	
SPD	SURGE PROTECTIVE DEVIC	E	
NGR	NEUTRAL GROUND		
GFP	GROUND FAULT PROTECTI	ON DEVICE	
<u> </u>	GROUNDING CONNECTION		
<b>→</b> ⊶  ı	LIGHTNING ARRESTER		
<del>р _a-</del>	LIGHT INDICATOR (ie: VOLT	AGE)	
•	STRESS CONE		
(R)			
	RELAY		
(A)	AMMETER		
<u>(V)</u>	VOLTMETER		
9	SINGLE PHASE MOTOR		
<u> </u>	THREE PHASE MOTOR		
	PANEL BOARD (SINGLE TUE	3)	
	PANEL BOARD (DOUBLE TU	JB)	
	<u> </u>		
	DEMOLITION		
	DEMOLITION		
R RL	R - REMOVE RL - RELOCA		
	R - REMOVE RL - RELOCA	TE MENT, DEVICES, CONDUIT TO BE 'REMOVED'	
	R - REMOVE RL - RELOCA	MENT, DEVICES, CONDUIT TO BE 'REMOVED'	
R √7	R - REMOVE RL - RELOCATION DENOTES EXISTING EQUIPMENT	MENT, DEVICES, CONDUIT TO BE 'REMOVED' ES TO BE 'REMOVED'	
	R - REMOVE RL - RELOCATION DENOTES EXISTING EQUIPMENTS EXISTING DEVICES	MENT, DEVICES, CONDUIT TO BE 'REMOVED' ES TO BE 'REMOVED'	
	R - REMOVE RL - RELOCATION OF THE PROPERTY OF	MENT, DEVICES, CONDUIT TO BE 'REMOVED' ES TO BE 'REMOVED' ES TO BE 'RELOCATED'	
	R - REMOVE RL - RELOCATION OF THE PROPERTY OF	MENT, DEVICES, CONDUIT TO BE 'REMOVED' ES TO BE 'REMOVED' ES TO BE 'RELOCATED'	
	R - REMOVE RL - RELOCATION RELOCA	MENT, DEVICES, CONDUIT TO BE 'REMOVED' ES TO BE 'REMOVED' ES TO BE 'RELOCATED'	
	R - REMOVE RL - RELOCATE DENOTES EXISTING EQUIPED DENOTES EXISTING DEVICED DENOTES EXISTING DEVICED EXISTING TO REMAIN (TON	MENT, DEVICES, CONDUIT TO BE 'REMOVED' ES TO BE 'REMOVED' ES TO BE 'RELOCATED'	
	R - REMOVE RL - RELOCATE DENOTES EXISTING EQUIPED DENOTES EXISTING DEVICED DENOTES EXISTING DEVICED EXISTING TO REMAIN (TON	MENT, DEVICES, CONDUIT TO BE 'REMOVED' ES TO BE 'REMOVED' ES TO BE 'RELOCATED'	
RL S  RL S  BREVIATIONS  FI - ARC FAUL F - AMPS FRA	R - REMOVE RL - RELOCATE DENOTES EXISTING EQUIPED DENOTES EXISTING DEVICED DENOTES EXISTING DEVICED EXISTING TO REMAIN (TONOTE)  EXISTING TO REMAIN (TONOTE)  T INTERRUPTER ME	MENT, DEVICES, CONDUIT TO BE 'REMOVED'  ES TO BE 'REMOVED'  ES TO BE 'RELOCATED'  ED)  AFF - ABOVE FINISHED FLOOR AT - AMPS TRIP	
BBREVIATIONS  FI - ARC FAUL F - AMPS FRA V - AUDIO/VIS CH - COUNTER	R - REMOVE RL - RELOCATE DENOTES EXISTING EQUIPED DENOTES EXISTING DEVICE EXISTING DEVICE EXISTING TO REMAIN (TON EXISTENCE TO R	MENT, DEVICES, CONDUIT TO BE 'REMOVED'  ES TO BE 'REMOVED'  ES TO BE 'RELOCATED'  ED)  AFF - ABOVE FINISHED FLOOR AT - AMPS TRIP (C) DEDICATED CIRCUIT CHP - CHILD PROOF	
BBREVIATIONS  FI - ARC FAUL  F - AMPS FRA  V - AUDIO/VIS  CH - COUNTER  CLG - CEILING  W - DISHWASI	R-REMOVE RL-RELOCATE DENOTES EXISTING EQUIPED DENOTES EXISTING DEVICED DENOTES EXISTING DEVICED EXISTING TO REMAIN (TON EXISTING TO REMAIN (TON TON TON TON TON TON TON TON TON TON	MENT, DEVICES, CONDUIT TO BE 'REMOVED'  ES TO BE 'REMOVED'  ES TO BE 'RELOCATED'  ED)  AFF - ABOVE FINISHED FLOOR AT - AMPS TRIP (C) DEDICATED CIRCUIT CHP - CHILD PROOF CP - CONSOLIDATION POINT EXP - EXPLOSION PROOF	
BBREVIATIONS  FI - ARC FAUL  F - AMPS FRA  V - AUDIO/VIS  CH - COUNTER  CLG - CEILING  W - DISHWASI  GFI - GROUND  CND - GROUND	R-REMOVE RL-RELOCATE DENOTES EXISTING EQUIPED DENOTES EXISTING DEVICED DENOTES EXISTING DEVICED EXISTING TO REMAIN (TON EXISTING TO REMAIN (TON EXISTING TO REMAIN (TON DELIVER DEVICE HEIGHT, 12" OR AS NOTED HER FAULT INTERRUPTER	MENT, DEVICES, CONDUIT TO BE 'REMOVED'  ES TO BE 'REMOVED'  ES TO BE 'RELOCATED'  ED)  AFF - ABOVE FINISHED FLOOR AT - AMPS TRIP (C) DEDICATED CIRCUIT CHP - CHILD PROOF CP - CONSOLIDATION POINT EXP - EXPLOSION PROOF GFCI - GROUND FAULT CURRENT INTERRUPTER GWB - GYPSUM WALL BOARD	
BBREVIATIONS  FI - ARC FAUL F - AMPS FRA V - AUDIO/VIS CH - CEILING W - DISHWASI SFI - GROUND SMD - GROUND K - HOUSE KE DF - INTERMED	R - REMOVE RL - RELOCATE DENOTES EXISTING EQUIPED DENOTES EXISTING DEVICED DENOTES EXISTING DEVICED EXISTING TO REMAIN (TON EXISTING TORSE)  T INTERRUPTER ME UAL DEVICE HEIGHT, 12" OR AS NOTED HER FAULT INTERRUPTER DEPING DIATE DISTRIBUTION FRAME	MENT, DEVICES, CONDUIT TO BE 'REMOVED'  ES TO BE 'REMOVED'  ES TO BE 'RELOCATED'  ED)  AFF - ABOVE FINISHED FLOOR AT - AMPS TRIP (C) DEDICATED CIRCUIT CHP - CHILD PROOF CP - CONSOLIDATION POINT EXP - EXPLOSION PROOF GFCI - GROUND FAULT CURRENT INTERRUPTER GWB - GYPSUM WALL BOARD HP - HOSPITAL GRADE IG - ISOLATED GROUND	
BREVIATIONS  AFI - ARC FAUL  AF - AMPS FRA  AV - AUDIO/VIS  CH - COUNTER  CH - COUNTER  CH - GROUND  CH - HOUSE KE  CH - KEY OPERA  CH - KEY OPERA  CH - MAIN DIS	R-REMOVE RL-RELOCATE  DENOTES EXISTING EQUIP  DENOTES EXISTING DEVICE  EXISTING  EXISTING TO REMAIN (TON  EXISTING TO REMAIN (TON  TINTERRUPTER  ME  UAL DEVICE  HEIGHT, 12" OR AS NOTED  HER  FAULT INTERRUPTER  DIATE DISTRIBUTION FRAME  TED  TTRIBUTION FRAME	MENT, DEVICES, CONDUIT TO BE 'REMOVED'  ES TO BE 'REMOVED'  ES TO BE 'RELOCATED'  ED)  AFF - ABOVE FINISHED FLOOR AT - AMPS TRIP (C) DEDICATED CIRCUIT CHP - CHILD PROOF CP - CONSOLIDATION POINT EXP - EXPLOSION PROOF GFCI - GROUND FAULT CURRENT INTERRUPTER GWB - GYPSUM WALL BOARD HP - HOSPITAL GRADE IG - ISOLATED GROUND MCS - MULTIMEDIA COMMUNICATION SYSTEM MH - MANHOLE	
BBREVIATIONS  AFI - ARC FAUL  F - AMPS FRA  V - AUDIO/VIS  CH - COUNTER  CLG - CEILING  W - DISHWASI  GROUND  SMD - GROUND  K - HOUSE KE  OF - INTERMED  - KEY OPERA	R - REMOVE RL - RELOCATE DENOTES EXISTING EQUIPED DENOTES EXISTING DEVICED DENOTES EXISTING DEVICED EXISTING TO REMAIN (TON EX	MENT, DEVICES, CONDUIT TO BE 'REMOVED'  ES TO BE 'REMOVED'  ES TO BE 'RELOCATED'  ED)  AFF - ABOVE FINISHED FLOOR AT - AMPS TRIP (C) DEDICATED CIRCUIT CHP - CHILD PROOF CP - CONSOLIDATION POINT EXP - EXPLOSION PROOF GFCI - GROUND FAULT CURRENT INTERRUPTER GWB - GYPSUM WALL BOARD HP - HOSPITAL GRADE IG - ISOLATED GROUND MCS - MULTIMEDIA COMMUNICATION SYSTEM	
BREVIATIONS  AFI - ARC FAUL  AF - AMPS FRA  AV - AUDIO/VIS  CH - COUNTER  CLG - CEILING  WW - DISHWASI  GROUND  GROUND	R-REMOVE RL-RELOCATE DENOTES EXISTING EQUIP DENOTES EXISTING DEVICE  EXISTING  EXISTING  EXISTING TO REMAIN (TON  EXISTING TO REMAIN (TON  TON  TON  TON  TON  TON  EXISTING  EXISTING TO REMAIN (TON  EXISTING TO REMAIN (TON  TON  EXISTING TO REMAIN (TON  EXISTING  EXISTING TO REMAIN (TON  EXISTING  EXISTIN	MENT, DEVICES, CONDUIT TO BE 'REMOVED'  ES TO BE 'REMOVED'  ES TO BE 'RELOCATED'  ED)  AFF - ABOVE FINISHED FLOOR AT - AMPS TRIP (C) DEDICATED CIRCUIT CHP - CHILD PROOF CP - CONSOLIDATION POINT EXP - EXPLOSION PROOF GFCI - GROUND FAULT CURRENT INTERRUPTER GWB - GYPSUM WALL BOARD HP - HOSPITAL GRADE IG - ISOLATED GROUND MCS - MULTIMEDIA COMMUNICATION SYSTEM MH - MANHOLE MW - MICROWAVE NIC - NOT IN CONTRACT	
BREVIATIONS  BREVIATIONS  BREVIATIONS  BRI - ARC FAUL  F - AMPS FRA  V - AUDIO/VIS  CH - COUNTER  CH - REPURITE  CH - RELOCATE  CH - RELOCATE  CH - RELOCATE  CH - RETURN  CH	R-REMOVE RL-RELOCATE DENOTES EXISTING EQUIP DENOTES EXISTING DEVICE  EXISTING  EXISTING TO REMAIN (TON  EXISTING  EXISTIN	MENT, DEVICES, CONDUIT TO BE 'REMOVED'  ES TO BE 'REMOVED'  ES TO BE 'RELOCATED'  ED)  AFF - ABOVE FINISHED FLOOR AT - AMPS TRIP (C) DEDICATED CIRCUIT CHP - CHILD PROOF CP - CONSOLIDATION POINT EXP - EXPLOSION PROOF GFCI - GROUND FAULT CURRENT INTERRUPTER GWB - GYPSUM WALL BOARD HP - HOSPITAL GRADE IG - ISOLATED GROUND MCS - MULTIMEDIA COMMUNICATION SYSTEM MH - MANHOLE MW - MICROWAVE NIC - NOT IN CONTRACT O/H - OVERHEAD PR - PAIR RE - TO BE RELOCATED RF - REFRIGERATOR S/A - SUPPLY AIR	
BBREVIATIONS  AFI - ARC FAUL  AFF - AMPS FRA  AV - AUDIO/VIS  CH - COUNTER  CH - CEILING  WW - DISHWASI  CH - GROUND  CH - HOUSE KE  CH - KEY OPERA  MIDF - MAIN DIS  MM - MULTIMOI  MI - NIGHT LIGH  MI - NIGHT LIGH  MI - PRIVATE  MI - TO BE REM  MI - TO BE REM  MI - RETURN A  MI - SINGLE M	R-REMOVE RL-RELOCATE DENOTES EXISTING EQUIP DENOTES EXISTING DEVICE  EXISTING  EXISTING TO REMAIN (TON  EXISTING  EXISTING TO REMAIN (TON  EXISTING  EXISTIN	MENT, DEVICES, CONDUIT TO BE 'REMOVED'  ES TO BE 'REMOVED'  ES TO BE 'RELOCATED'  ED)  AFF - ABOVE FINISHED FLOOR AT - AMPS TRIP (C) DEDICATED CIRCUIT CHP - CHILD PROOF CP - CONSOLIDATION POINT EXP - EXPLOSION PROOF GFCI - GROUND FAULT CURRENT INTERRUPTER GWB - GYPSUM WALL BOARD HP - HOSPITAL GRADE IG - ISOLATED GROUND MCS - MULTIMEDIA COMMUNICATION SYSTEM MH - MANHOLE MW - MICROWAVE NIC - NOT IN CONTRACT O/H - OVERHEAD PR - PAIR RE - TO BE RELOCATED RF - REFRIGERATOR S/A - SUPPLY AIR SG - SINGLE GANG SS - STAINLESS STEEL	
BREVIATIONS  FI - ARC FAUL F - AMPS FRA V - AUDIO/VIS CH - COUNTER CH - GROUND K - HOUSE KE OF - INTERMED INTER	R-REMOVE RL-RELOCATE  DENOTES EXISTING EQUIP  DENOTES EXISTING DEVICE  EXISTING  EXISTING  EXISTING TO REMAIN (TON  EXISTING	MENT, DEVICES, CONDUIT TO BE 'REMOVED'  ES TO BE 'REMOVED'  ES TO BE 'RELOCATED'  ED)  AFF - ABOVE FINISHED FLOOR AT - AMPS TRIP (C) DEDICATED CIRCUIT CHP - CHILD PROOF CP - CONSOLIDATION POINT EXP - EXPLOSION PROOF GFCI - GROUND FAULT CURRENT INTERRUPTER GWB - GYPSUM WALL BOARD HP - HOSPITAL GRADE IG - ISOLATED GROUND MCS - MULTIMEDIA COMMUNICATION SYSTEM MH - MANHOLE MW - MICROWAVE NIC - NOT IN CONTRACT O/H - OVERHEAD PR - PAIR RE - TO BE RELOCATED RF - REFRIGERATOR S/A - SUPPLY AIR SG - SINGLE GANG SS - STAINLESS STEEL TGBB - TELECOM GROUNDING BUSBAR TSER - TELECOM GROUNDING BUSBAR TSER - TELECOM SERVICE ENTRANCE ROOM	
BREVIATIONS  FI - ARC FAUL F - AMPS FRA V - AUDIO/VIS H - COUNTER LG - CEILING W - DISHWASI FF - INTERMED K - HOUSE KE FF - INTERMED K - HOUSE KE KEY OPERA HOS HOUSE K - HOUSE KE HOUSE KE HOUSE K - HOUSE HOS HOUSE HOS	R-REMOVE RL-RELOCATE DENOTES EXISTING EQUIP DENOTES EXISTING DEVICE  EXISTING  EXISTING  EXISTING TO REMAIN (TON  EXISTING  EXISTING TO REMAIN (TON  EXISTING  EX	MENT, DEVICES, CONDUIT TO BE 'REMOVED'  ES TO BE 'REMOVED'  ES TO BE 'RELOCATED'  ED)  AFF - ABOVE FINISHED FLOOR AT - AMPS TRIP (C) DEDICATED CIRCUIT CHP - CHILD PROOF CP - CONSOLIDATION POINT EXP - EXPLOSION PROOF GFCI - GROUND FAULT CURRENT INTERRUPTER GWB - GYPSUM WALL BOARD HP - HOSPITAL GRADE IG - ISOLATED GROUND MCS - MULTIMEDIA COMMUNICATION SYSTEM MH - MANHOLE MW - MICROWAVE NIC - NOT IN CONTRACT O/H - OVERHEAD PR - PAIR RE - TO BE RELOCATED RF - REFRIGERATOR S/A - SUPPLY AIR SG - SINGLE GANG SS - STAINLESS STEEL TGBB - TELECOM GROUNDING BUSBAR	

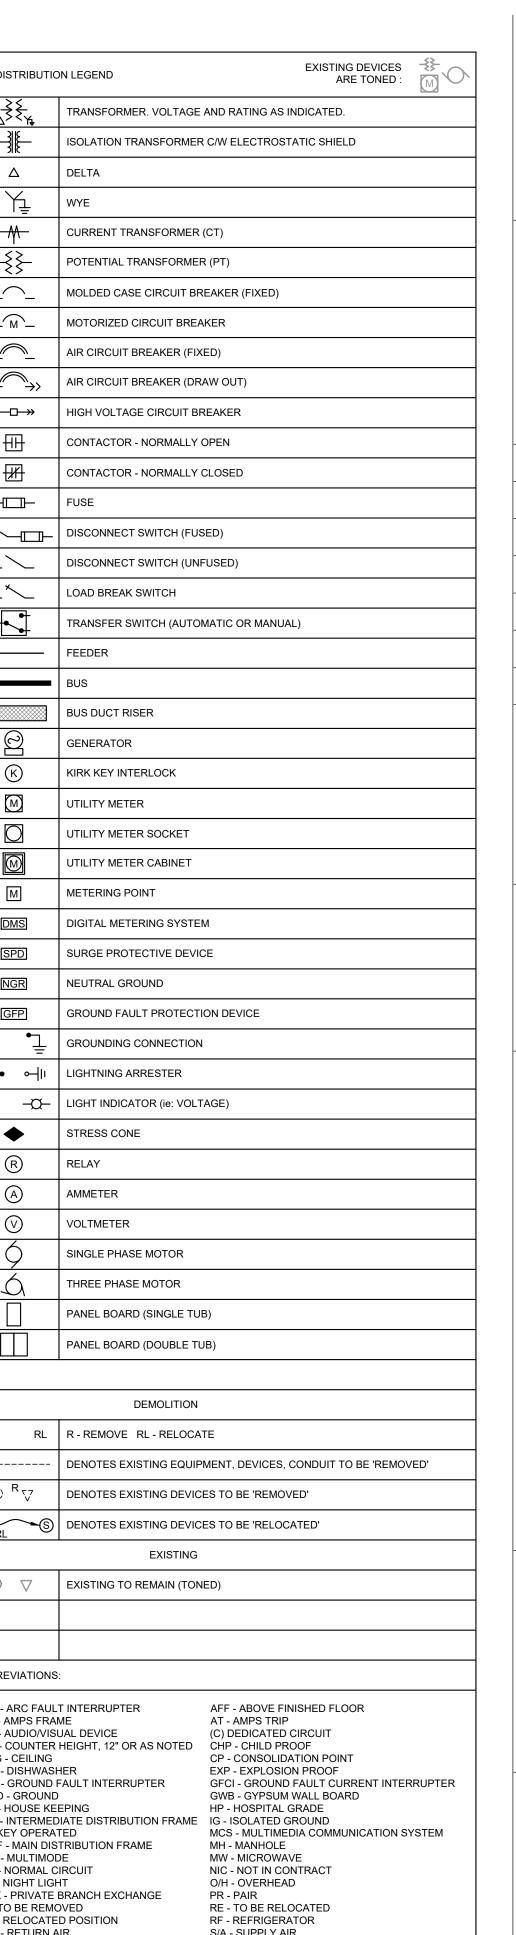



THEHIDIGROUP

155 Gordon Baker Road, Suite 200

Toronto, ON M2H 3N5 Canada

t. 416 364 2100 | HIDI.com

PRIME CONSULTANT

partners

310 Spadina Ave, Suite 100B Toronto, Ontario, Canada M5T 2E8 T: 416 203 7600 F: 416 203 3342 lga-ap.com

DESIGN BY:	SJ
DRAWN BY:	CW
CHECKED BY:	JP
APPROVED BY:	SJ
SCALE:	N/A
DATE:	JUNE.2025
CONSULTANT PROJECT NO.	2025-0012.01

#### ISSUE DATE:

4 2025-09-18 IFT 3 2025-07-14 ISSUED FOR PERMIT 2 2025-07-10 ISSUED FOR PERMIT REVIEW 1 2025-06-02 ISSUED FOR REVIEW

NO. DATE DESCRIPTION

09/12/2025 S. JAIN



# THE REGIONAL **MUNICIPALITY OF** DURHAM

WORKS DEPARTMENT DESIGN, CONSTRUCTION & ASSET MANAGEMENT

PHASE 2 RENOVATIONS


1635 DUNDAS STREET EAST WHITBY, ONTARIO

SHEET TITLE:

## ELECTRICAL LEGEND AND DRAWING LIST

PROPERTY NO.	FACILITY CODE
RP-W-42	SS-W-02
FACILITIES PROJECT NO.	CONTRACT NO.
SS-W-02-23-01	RFP-1048-2025

SHEET NO.

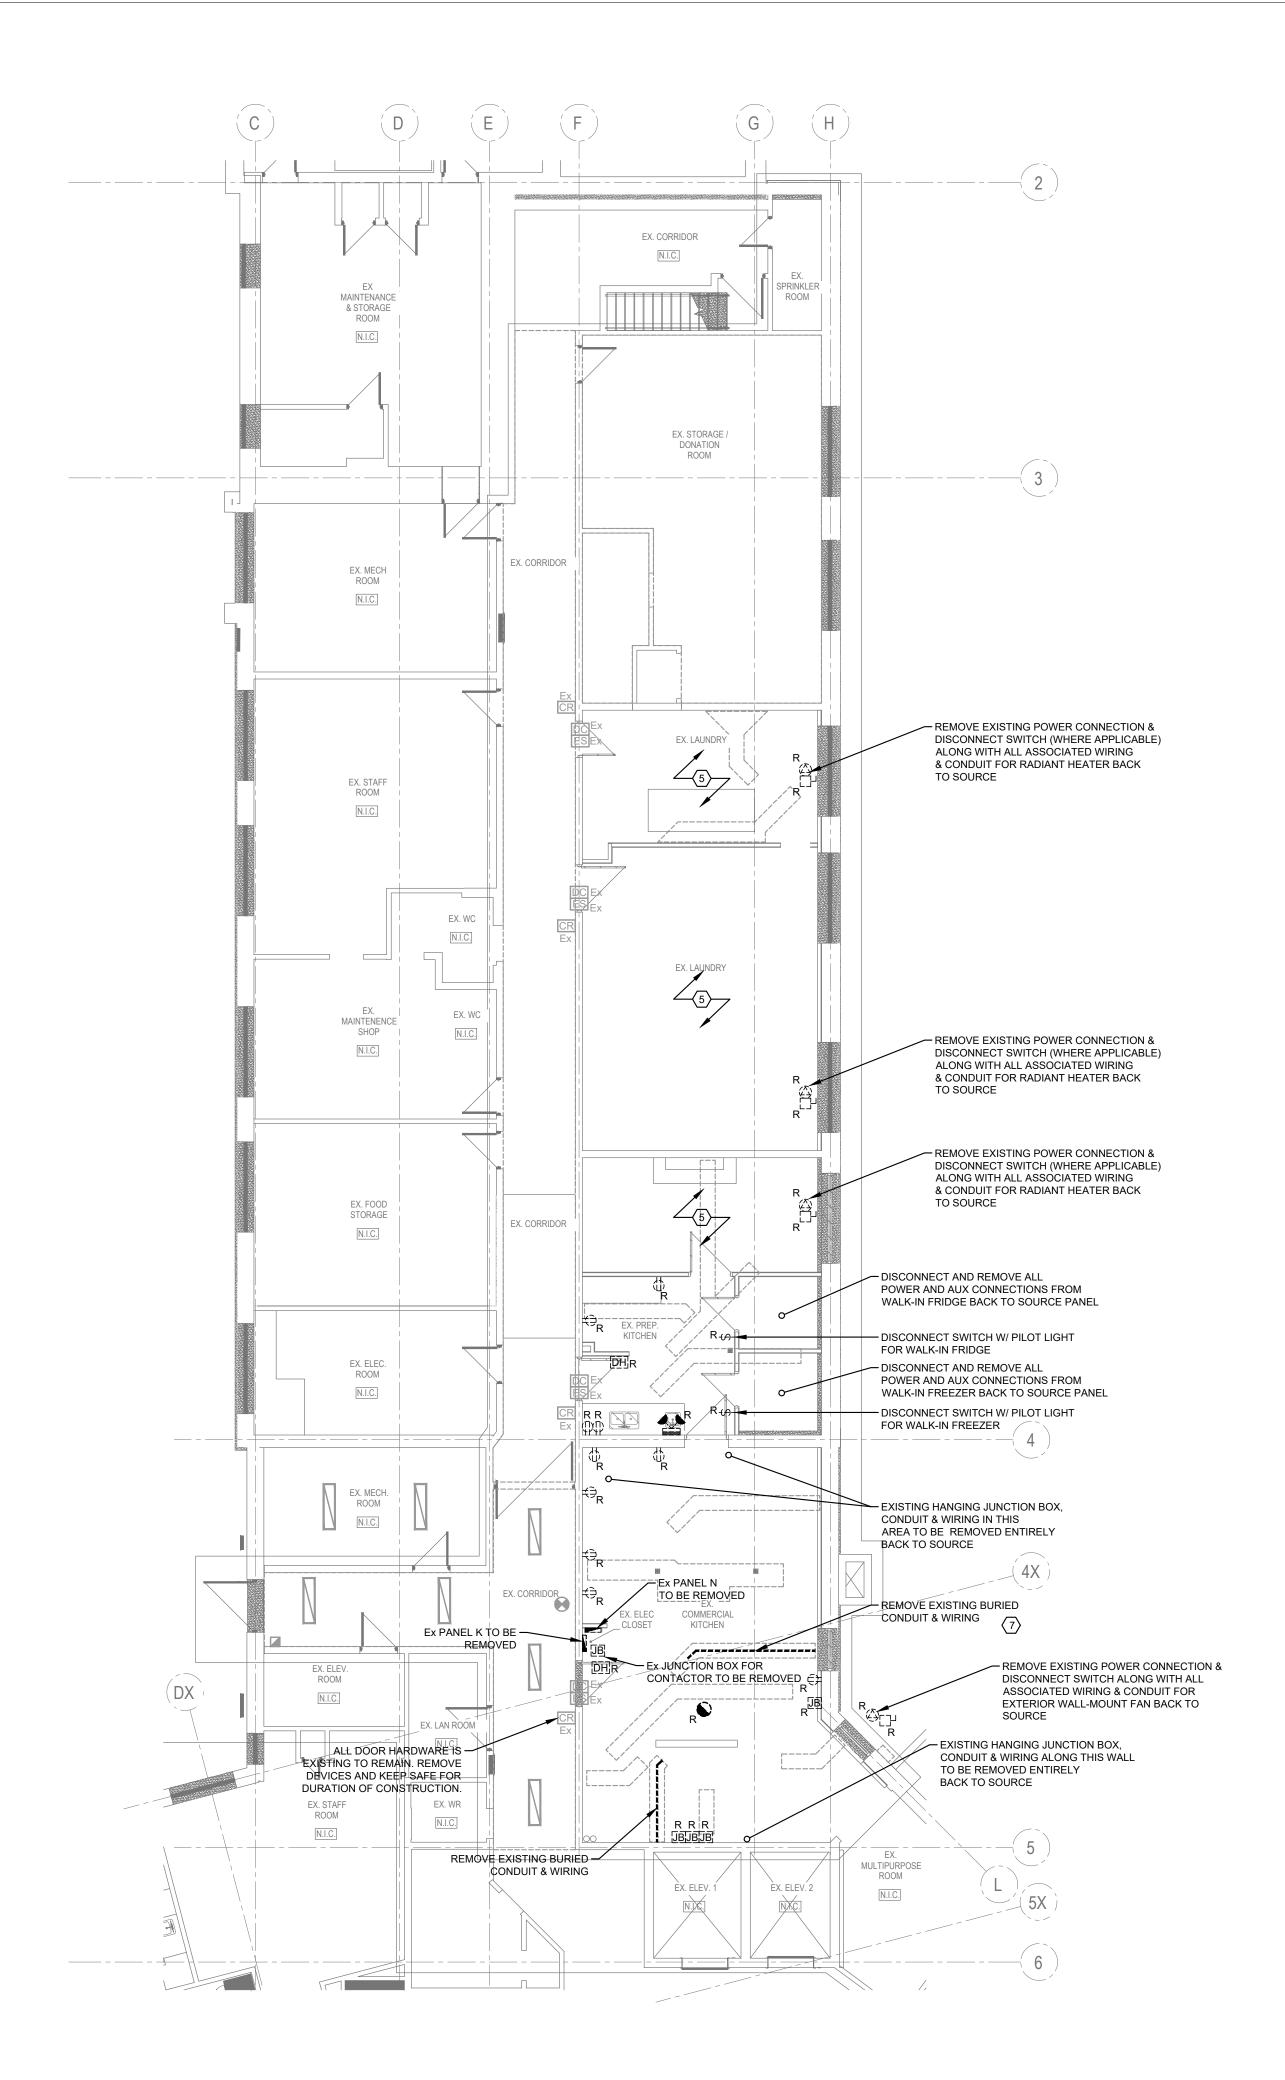

\ FIRST FLOOR - DEMOLITION PLAN SCALE: 1:100 ED-201

#### **DRAWING NOTES**

- THIS DRAWING IS TO BE READ IN CONJUNCTION WITH ARCHITECTURAL, STRUCTURAL,
- FIRST FLOOR DEMOLITION SCOPE. NOT ALL EXISTING DEVICES, SYSTEMS, WIRING & CONDUIT ARE SHOWN. UNLESS OTHERWISE NOTED: POWER: REMOVE ALL POWER CONNECTIONS, RECEPTACLES, DEVICES AND ALL ASSOCIATED WIRING AND CONDUIT BACK TO SOURCE PANEL. UPON REMOVAL OF ANY WIRING PENETRATING WALLS, SEAL ANY PENETRATIONS WITH APPROPRIATE FIRE STOP & MATERIAL.

FIRE ALARM: REMOVE ALL FIRE ALARM DEVICES, SENSORS AND CONNECTIONS BACK TO SOURCE AND REMOVE ALL ASSOCIATED WIRING, INTERLOCKS, CONNECTIONS AND CONDUITS. FIRE ALARM DEVICES IN THE CORRIDOR ARE

SECURITY: SECURITY DEVICES WITHIN AND IN THE VICINITY OF THE SCOPE OF WORK AREA ARE EXISTING TO REMAIN. ENSURE ALL DEVICES ARE ADEQUATELY PROTECTED FROM CONSTRUCTION ACTIVITIES.

COMMUNICATIONS/AV: REMOVE ALL DEVICES WITHIN THE SCOPE OF WORK AREA, AND ALL ASSOCIATED WIRING/CONDUIT BACK TO SOURCE SYSTEM.

- EQUIPMENT THAT HAVE BEEN REMOVED BACK TO PANEL ARE TO BE DESIGNATED AS
- $\overline{\langle 7. \rangle}$  CONTRACTOR TO ALLOW FOR TRENCHING WORK TO REMOVE EXTENT OF ALL BURIED
- FOR ANY REMOVED WIRING AND CONDUIT THAT HAD BEEN PENETRATING THROUGH WALLS, CEILINGS AND FLOORS, CONTRACTOR TO APPROPRIATELY SEAL PENETRATION WITH SEALANT SUITABLE TO MAINTAIN FIRE RATING. REFER TO ARCHITECTURAL DRAWING SET FOR FIRE RATINGS OF EACH WALL & SPACE.



THIS DRAWING IS TO BE USED AS DIAGRAMMATIC PURPOSES ONLY. NOT ALL EXISTING DEVICES MAY BE SHOWN. CONTRACTOR SHALL CONFIRM QUANTITY AND LOCATION OF ALL ELECTRIC DEVICES AND EQUIPMENT ON SITE PRIOR TO COMMENCING WORK. ALL ELECTRICAL DEVICES AND EQUIPMENT ARE TO REMAIN, UNLESS OTHERWISE NOTED.

- MECHANICAL AND ANY OTHER DISCIPLINES' DRAWINGS.
- PROVIDE ELECTRICAL DEMOLITION AS REQUIRED TO ACCOMPLISH THE ARCHITECTURAL, STRUCTURAL, MECHANICAL AND ANY OTHER DISCIPLINES' SCOPES OF
- FOR ANY ELECTRICAL DEVICES, JUNCTION BOXES AND ROUGH-INS THAT ARE RECESSED INTO BLOCK WALL, CEILING OR FLOOR, CONTRACTOR TO REMOVE DEVICE, JUNCTION BOX AND ROUGH-IN ENTIRELY, REMOVE THE WIRING AND CONDUIT BACK TO SOURCE PANELS AND PATCH/REPAIR THE WALL WITH APPROPRIATE MATERIAL. REFER TO THE ARCHITECTURAL DRAWINGS FOR PATCH & REPAIR OF EXISTING WALLS SCOPE OF

<u>LIGHTING</u>: REMOVE ALL EXISTING LIGHT FIXTURES WITH ALL ASSOCIATED WIRING & CONDUIT BACK TO SOURCE PANEL. REMOVE ALL EXISTING EMERGENCY LIGHTING FIXTURES & DEVICES BACK TO SOURCE PANEL.

- BREAKERS AND/OR DISCONNECT SWITCHES FEEDING SERVICES, DEVICES AND
- CONDUIT & WIRING IN SCOPE OF WORK SPACE.



THE **HIDI**GROUP

155 Gordon Baker Road, Suite 200 Toronto, ON M2H 3N5 Canada **HIDI** t. 416 364 2100 | HIDI.com



partners

310 Spadina Ave, Suite 100B Toronto, Ontario, Canada M5T 2E8 T: 416 203 7600 F: 416 203 3342 lga-ap.com

DESIGN BY:	SJ
DRAWN BY:	CW
CHECKED BY:	JP
APPROVED BY:	SJ
SCALE:	AS SHOWN
DATE:	JUNE.2025
CONSULTANT PROJECT NO.	2025-0012.01

#### ISSUE DATE:

2025-09-18	IFT
2025 07 44	ICCLIED FOD I

3 2025-07-14 ISSUED FOR PERMIT 2 2025-07-10 ISSUED FOR PERMIT REVIEW 1 | 2025-06-02 | ISSUED FOR REVIEW

NO. DATE DESCRIPTION





# THE REGIONAL MUNICIPALITY OF DURHAM

**WORKS DEPARTMENT DESIGN, CONSTRUCTION & ASSET MANAGEMENT** 

PHASE 2 RENOVATIONS

1635 DUNDAS STREET EAST WHITBY, ONTARIO

SHEET TITLE:

## FIRST FLOOR -**DEMOLITION PLAN**


PROPERTY NO. **FACILITY CODE** RP-W-42 SS-W-02

**FACILITIES PROJECT NO.** SS-W-02-23-01

CONTRACT NO. RFP-1048-2025

SHEET NO.

ED-201

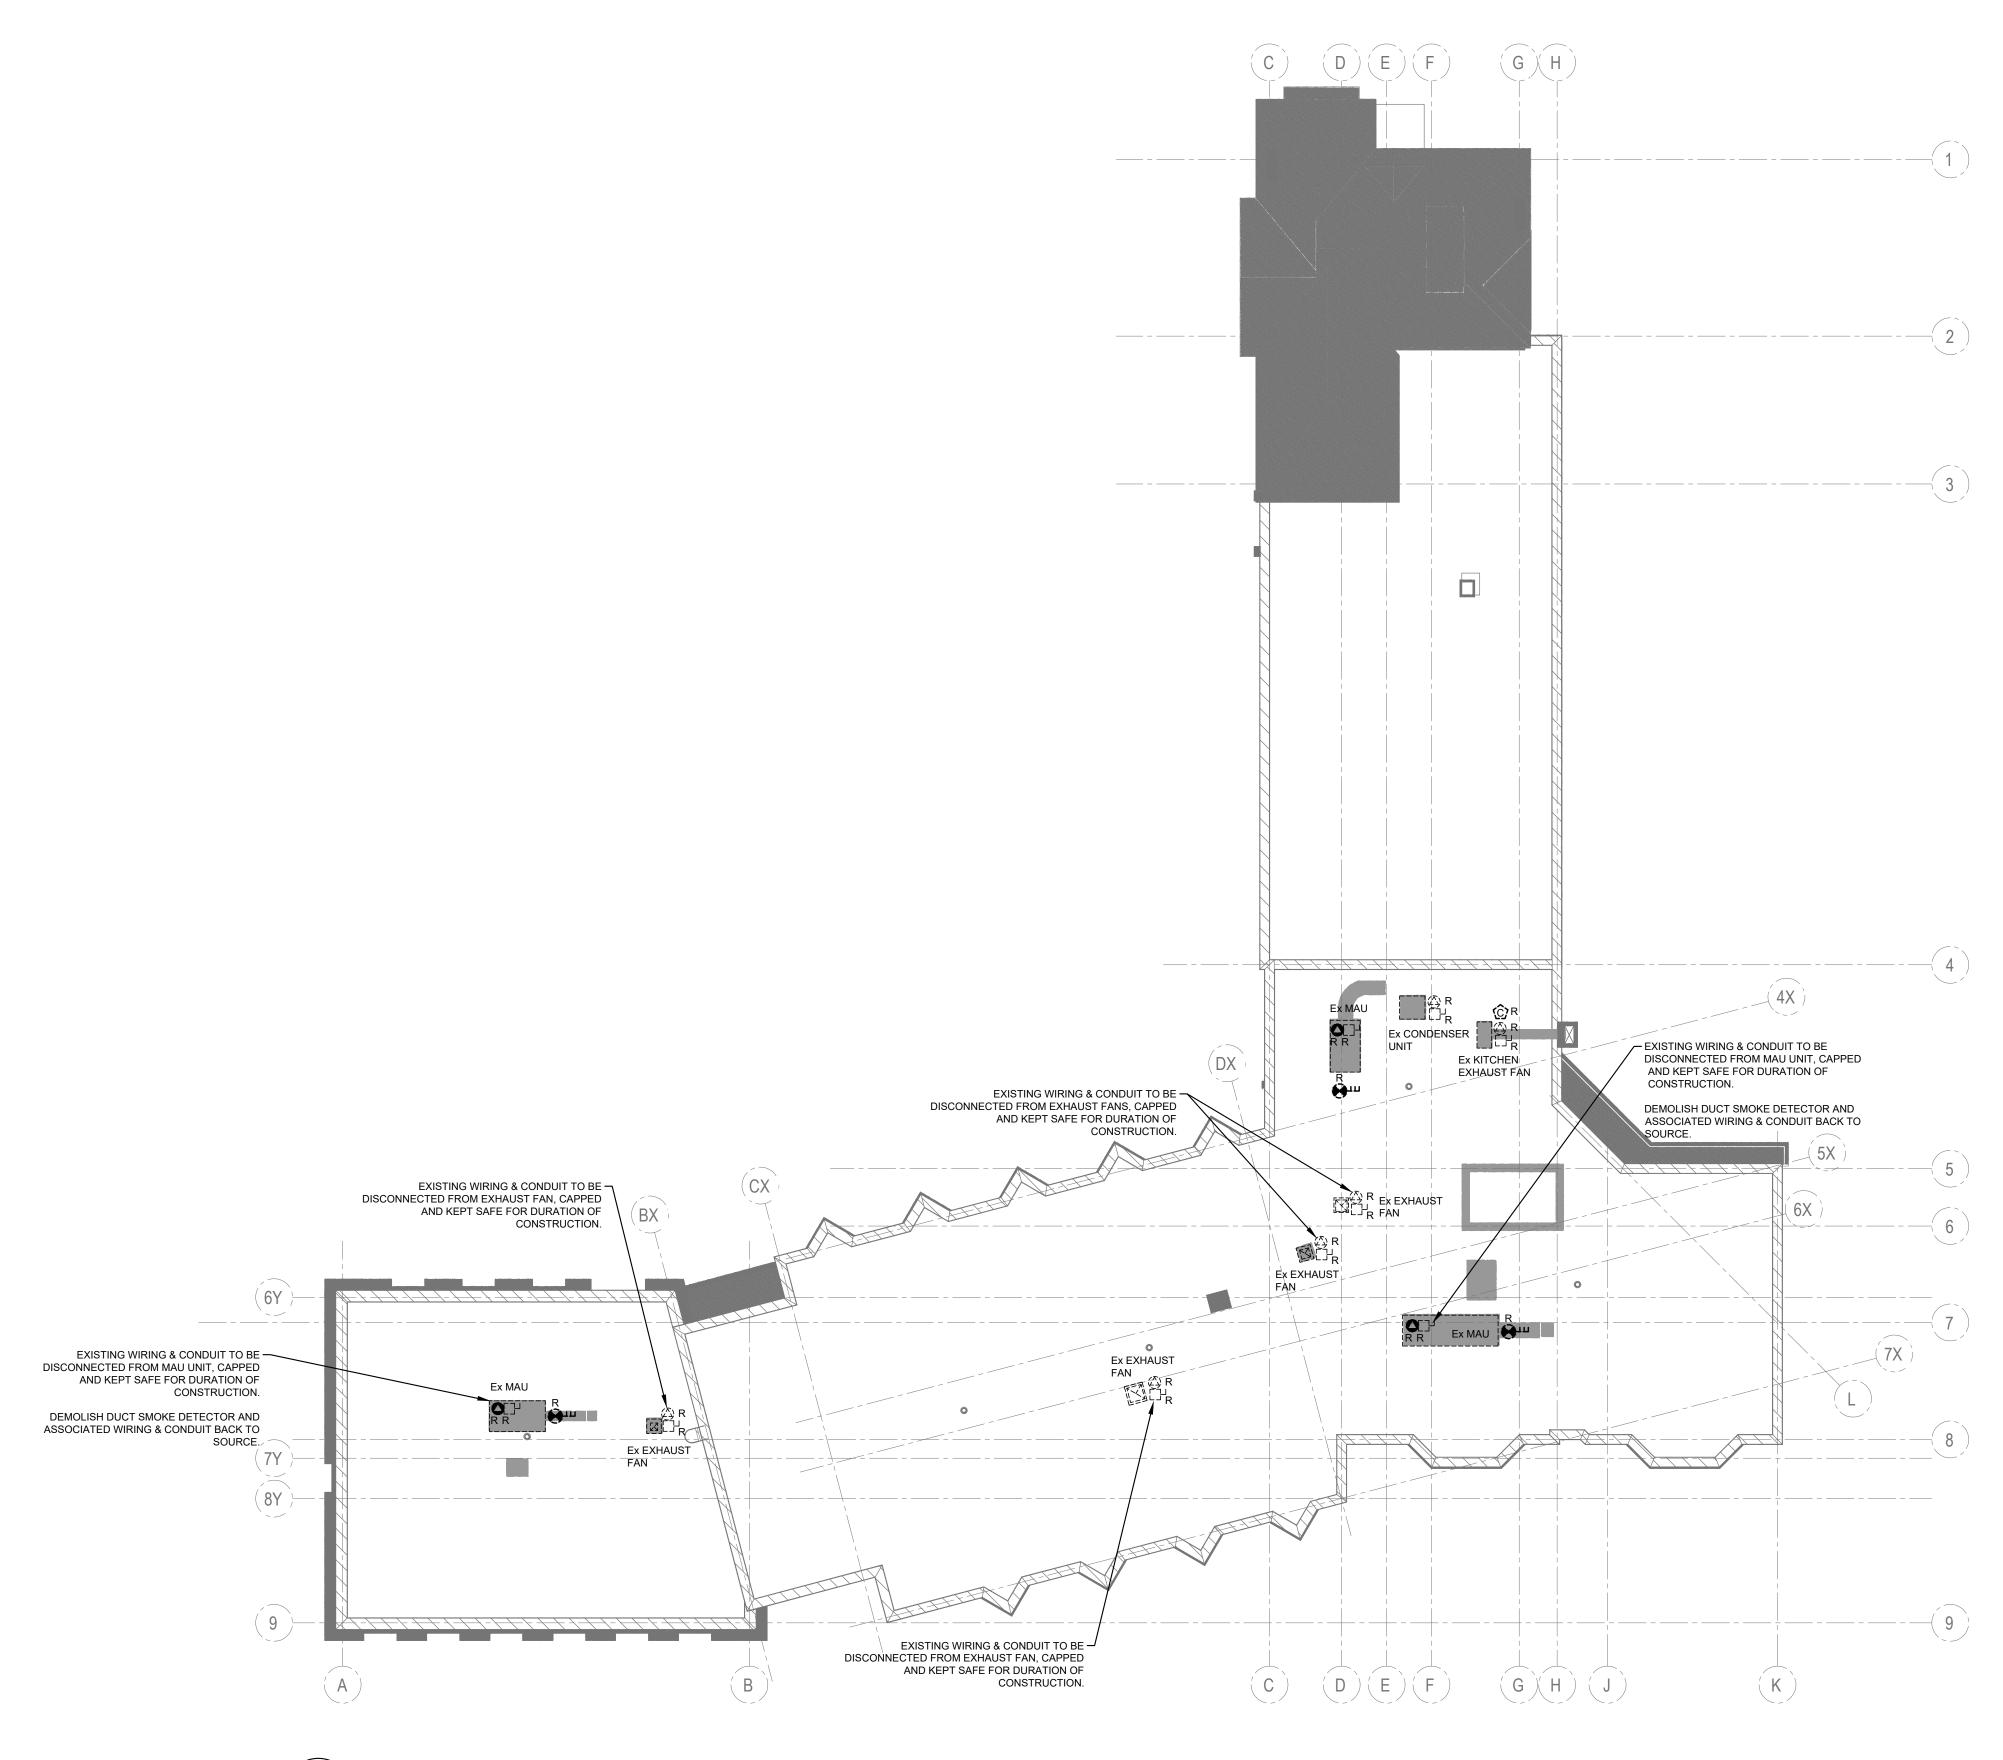

ROOF - DEMOLITION PLAN ED-202 SCALE: 1:200

#### **DRAWING NOTES**

THIS DRAWING IS TO BE USED AS DIAGRAMMATIC PURPOSES ONLY. NOT ALL EXISTING DEVICES MAY BE SHOWN. CONTRACTOR SHALL CONFIRM QUANTITY AND LOCATION OF ALL ELECTRIC DEVICES AND EQUIPMENT ON SITE PRIOR TO COMMENCING WORK. ALL ELECTRICAL DEVICES AND EQUIPMENT ARE TO REMAIN, UNLESS OTHERWISE NOTED.

- THIS DRAWING IS TO BE READ IN CONJUNCTION WITH ARCHITECTURAL, STRUCTURAL, MECHANICAL AND ANY OTHER DISCIPLINES' DRAWINGS.
- PROVIDE ELECTRICAL DEMOLITION AS REQUIRED TO ACCOMPLISH THE ARCHITECTURAL, STRUCTURAL, MECHANICAL AND ANY OTHER DISCIPLINES' SCOPES OF WORK.
- ROOF DEMOLITION SCOPE. UNLESS OTHERWISE NOTED:

  POWER: REMOVE ALL POWER CONNECTIONS, RECEPTACLES, DEVICES AND ALL ASSOCIATED WIRING AND CONDUIT BACK TO SOURCE PANEL.

FIRE ALARM: REMOVE ALL FIRE ALARM SENSORS, DEVICES AND CONNECTIONS BACK TO SOURCE AND REMOVE ALL ASSOCIATED WIRING, INTERLOCKS, CONNECTIONS AND CONDUITS.

FOR ANY REMOVED WIRING AND CONDUIT THAT HAD BEEN PENETRATING THROUGH WALLS, CEILINGS AND FLOORS, CONTRACTOR TO APPROPRIATELY SEAL PENETRATION WITH SEALANT SUITABLE TO MAINTAIN FIRE RATING. REFER TO ARCHITECTURAL DRAWINGS FOR INFORMATION OF FIRE RATING.



THEHIDIGROUP
155 Gordon Baker Road, Suite 200
Toronto, ON M2H 3N5 Canada
t. 416 364 2100 | HIDI.com

PRIME CONSULTANT

partners

310 Spadina Ave, Suite 100B Toronto, Ontario, Canada M5T 2E8 T: 416 203 7600 F: 416 203 3342 lga-ap.com

DESIGN BY:	SJ
DRAWN BY:	CW
CHECKED BY:	JP
APPROVED BY:	SJ
SCALE:	N/A
DATE:	JUNE.2025
CONSULTANT PROJECT NO.	2025-0012.01

#### **ISSUE DATE:**

4	2025-09-18	IFT
3	2025-07-14	ISSUED FOR PERMIT
2	2025-07-10	ISSUED FOR PERMIT REVIEW
1	2025-06-02	ISSUED FOR REVIEW

NO. DATE DESCRIPTION





# THE REGIONAL MUNICIPALITY OF DURHAM

**WORKS DEPARTMENT** DESIGN, CONSTRUCTION & ASSET MANAGEMENT

PHASE 2 RENOVATIONS

1635 DUNDAS STREET EAST WHITBY, ONTARIO

SHEET TITLE:

## ROOF -DEMOLITION PLAN


DEW SETTION	/  \		
PROPERTY NO.	FACILITY CODE		
RP-W-42	SS-W-02		

**FACILITIES PROJECT NO.** SS-W-02-23-01

CONTRACT NO. RFP-1048-2025

SHEET NO.

ED-202

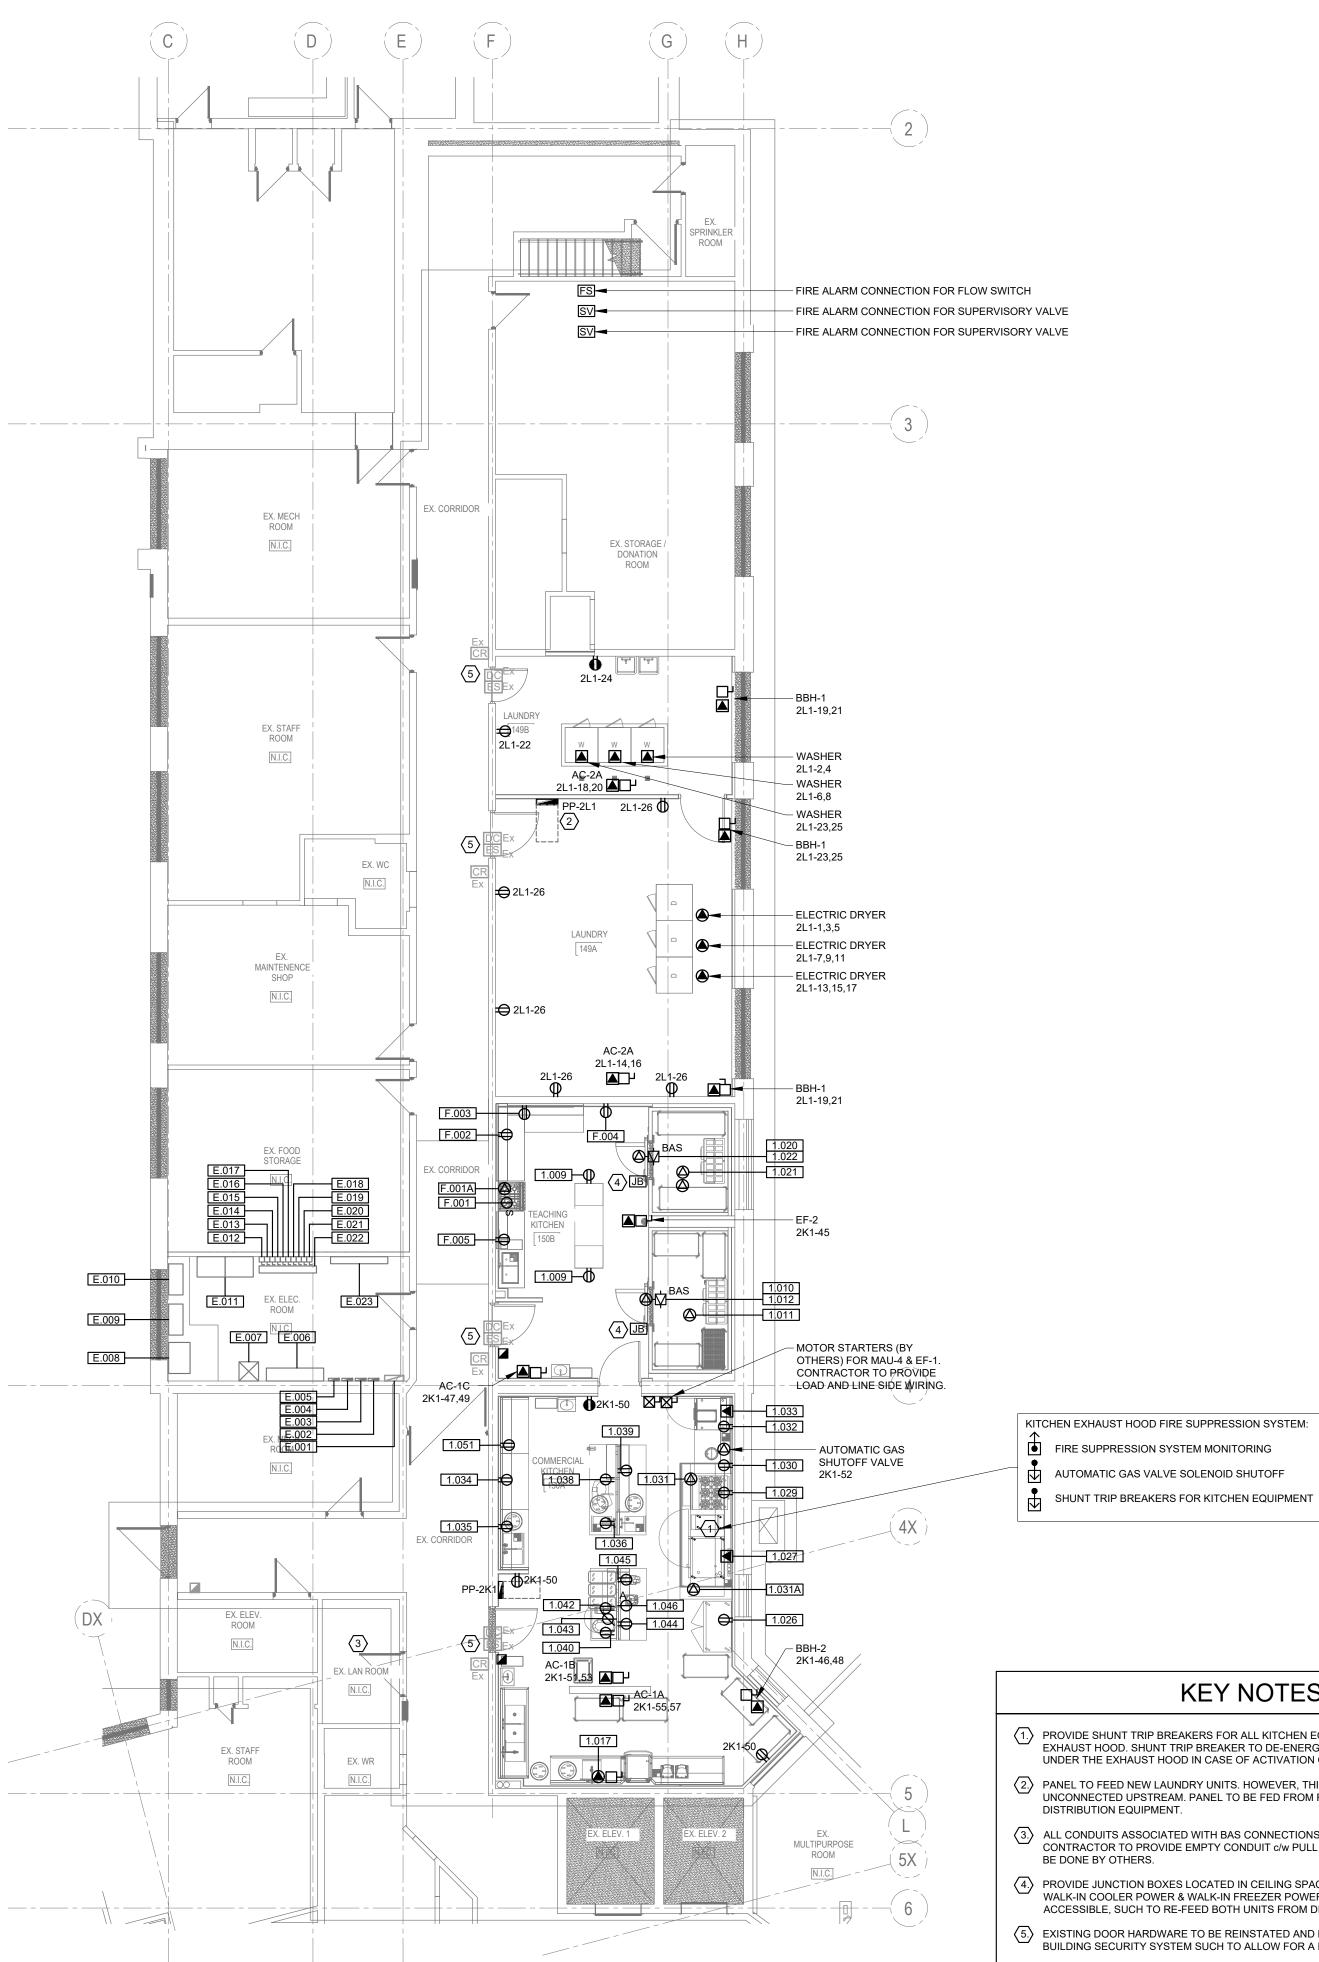

\ FIRST FLOOR - POWER AND SYSTEMS PLAN

SCALE: 1:100

KITCHEN EQUIPMENT SCHEDULE **ELECTRICAL** CONNECTION TYPE WIRE SIZE CIRCUIT DESCRIPTION ELECTRICAL REMARKS ITEM NO. QTY. 1.000 2 HAND SINK 3 WASTE BIN, SLIM JIM 1.000A HAND SINK W/EMERGENCY EYEWASH SHELVING, MOBILE SHELVING, MOBILE SHELVING, MOBILE DUNNAGE RACK S.S. ISLAND PROVIDE NEMA 5-15R RECEPT 12 A 120 1 RECEPTACLE 15A-1P 2#12AWG (CU) + GND IN 21 mmC 2 A 120 1 DIRECT 15A-1P 2#12AWG (CU) + GND IN 21 mmC PROVIDE DATA FOR BAS SYSTEM WALK-IN COOLER EVAPORATOR COIL 1.00 A | 120 | 1 | DIRECT | 15A-1P | 2#12AWG (CU) + GND IN 21 mmC POWER FROM 1.010. CONN TO B.A.S. BY CONTROLS DIV. TEMPERATURE ALARM REFER TO DRAWING E-302 FOR CONNECTION LOCATION CONDENSING UNIT 6.20 A | 208 | 3 | DIRECT | 15A-3P | 4#12AWG (CU) + GND IN 21 mmC S.S. DISHTABLE W/ THREE SINKS SMART WALL SHELVING S.S. DISHROOM PANEL S.S. SOILED DISHTABLE W/ SINK S.S. SORTING SHELF, WALL MOUNT DISHWASHER, DOOR TYPE, HIGH TEMP 52.5 A 208 3 DIRECT 70A-3P 4#4AWG (CU) + GND IN 27 mmC 1.017 VENTLESS 1.018 1 S.S. CLEAN DISHTABLE S.S. WALL SHELVING PROVIDE DATA FOR BAS SYSTEM WALK-IN FREEZER 15A-1P 2#12AWG (CU) + GND IN 21 mmC ADD'L 120V/1/60 11.7A REQ'D FOR DRAIN LINE HEATER 10.10 A 208 1 DIRECT 15A-2P 3#12AWG (CU) + GND IN 21 mmC EVAPORATOR COIL TEMPERATURE ALARM POWER FROM 1.020. CONN TO B.A.S. BY CONTROLS DIV. 15A-3P 4#12AWG (CU) + GND IN 21 mmC CONDENSING UNIT REFER TO DRAWING E-302 FOR CONNECTION LOCATION 4 DRYING RACK, MOBILE REACH-IN DUAL TEMP 6.4A | 120 | 1 | RECEPTACLE | 15A-1P | 2#12AWG (CU) + GND IN 21 mmC | PROVIDE NEMA 5-15R RECEPT 1.026 REFRIGERATOR/FREEZER PROVIDE NEMA 6-15R RECEPT. PROVIDE SHUNT TRIP BREAKER. COMBI OVEN, GAS 15A-2P 3#12AWG (CU) + GND IN 21 mmC 3.8 A 208 WATER FILTER FRYER, GAS 1 RANGE WITH CONVECTION OVEN, GAS 0.6 A 120 RECEPTACLE | 15A-1P | 2#12AWG (CU) + GND IN 21 mmC PROVIDE NEMA 5-15R RECEPT. PROVIDE SHUNT TRIP BREAKER. RECEPTACLE 15A-1P 2#12AWG (CU) + GND IN 21 mmC PROVIDE NEMA 5-15R RECEPT. PROVIDE SHUNT TRIP BREAKER. COUNTERTOP SOUP WARMER 20A-1P 2#12AWG (CU) + GND IN 21 mmC PROVIDE FIRE ALARM START UP CONNECTION EXHAUST HOOD 1.031A 1 FIRE SUPPRESSION CABINET 1 A 120 1 DIRECT 15A-1P 2#12AWG (CU) + GND IN 21 mmC 1 S.S. WALL PANEL HOOD 12 A 120 1 RECEPTACLE 15A-1P 2#12AWG (CU) + GND IN 21 mmC PROVIDE NEMA 5-15R RECEPT S.S. PREP TABLE 1 S.S. WALL MOUNT SHELVING 15A-2P 3#12AWG (CU) + GND IN 21 mmC 1 BLAST CHILLER PROVIDE NEMA 6-15R RECEPT 1 S.S. PREP TABLE 12 A 120 1 RECEPTACLE 15A-1P 2#12AWG (CU) + GND IN 21 mmC PROVIDE NEMA 5-15R RECEPT S.S. WALL MOUNT SHELVING 12 A 120 1 RECEPTACLE 15A-1P 2#12AWG (CU) + GND IN 21 mmC 1 S.S. TABLE W/ TWO SINKS PROVIDE NEMA 5-15R RECEPT 1 S.S. WALL MOUNT SHELVING 1.035A 12 A 120 1 RECEPTACLE 15A-1P 2#12AWG (CU) + GND IN 21 mmC PROVIDE NEMA 5-15R RECEPT 1 S.S. TABLE W/ SINK 1.036A 1 S.S. BACKSPLASH MOUNT SHELVING 1.036B 1 S.S. CHASE 1.037 1 CAN OPENER 5.6 A 120 1 RECEPTACLE 15A-1P 2#12AWG (CU) + GND IN 21 mmC PROVIDE NEMA 5-15R RECEPT 1.038 1 | 12 A | 120 | 1 | RECEPTACLE | 15A-1P | 2#12AWG (CU) + GND IN 21 mmC 1 S.S. TABLE W/SINK PROVIDE NEMA 5-15R RECEPT 1 S.S. BACKSPLASH MOUNT SHELVING 12 A 120 1 RECEPTACLE 15A-1P 2#12AWG (CU) + GND IN 21 mmC 1 040 1 S.S. PREP TABLE PROVIDE NEMA 5-15R RECEPT 1.040A 1 S.S. BACKSPLASH MOUNT SHELVING 1.040B 1 S.S. CHASE 1.041 INGREDIENT BINS 1.042 RECEPTACLE 15A-1P 2#12AWG (CU) + GND IN 21 mmC DIGITAL SCALE PROVIDE NEMA 5-15R RECEPT 12 QUART MIXER RECEPTACLE 15A-1P 2#12AWG (CU) + GND IN 21 mmC PROVIDE NEMA 5-15R RECEPT 1 S.S. PREP TABLE RECEPTACLE 15A-1P 2#12AWG (CU) + GND IN 21 mmC PROVIDE NEMA 5-15R RECEPT 1.044A 1 S.S. BACKSPLASH MOUNT SHELVING 1.045 1 VEGETABLE SLICER 3 A 120 1 RECEPTACLE 15A-1P 2#12AWG (CU) + GND IN 21 mmC PROVIDE NEMA 5-15R RECEPT 1.046 1 BLIXER 15 A 208 3 RECEPTACLE 20A-3P 4#12AWG (CU) + GND IN 21 mmC 35,37,39 PROVIDE NEMA L15-20R RECEPT 1.047 1 FOOD TRANSPORT CART 1.049 8 SHELVING, MOBILE WASTE BIN W/ DOLLY 1.051 S.S. PREP TABLE 12 A 120 1 RECEPTACLE 15A-1P 2#12AWG (CU) + GND IN 21 mmC PROVIDE NEMA 5-15R RECEPT 1.051A 1 S.S. WALL MOUNT SHELVING 1.052 1 SHELVING, MOBILE

	FUTURE EQUIPMENT SCHEDULE									
								ELE	CTRICAL	
ITEM NO.	QTY.	DESCRIPTION	AMPS	VOLTS	PHASE	CONNECTION TYPE	BREAKER	WIRE SIZE	CIRCUIT	ELECTRICAL REMARKS
F.001	1	FUTURE DOMESTIC OVEN, ELECTRIC	40 A	208	1	RECEPTACLE	50A-1P	3#6AWG (CU) + GND IN 21 mmC	38	PROVIDE NEMA 14-50R RECEPT
F.001A	1	FUTURE DOMESTIC HOOD	20 A	120	1	DIRECT	25A-1P	2#10AWG (CU) + GND IN 21 mmC	40	
F.002	1	FUTURE MILLWORK BASE CABINET	12 A	120	1	RECEPTACLE	15A-1P	2#12AWG (CU) + GND IN 21 mmC	41	PROVIDE NEMA 5-15R RECEPT
F.002A	1	FUTURE MILLWORK UPPER CABINET								
F.003	1	FUTURE MILLWORK BASE CABINET	12 A	120	1	RECEPTACLE	15A-1P	2#12AWG (CU) + GND IN 21 mmC	42	PROVIDE NEMA 5-15R RECEPT
F.003A	1	FUTURE MILLWORK UPPER CABINET								
F.004	1	FUTURE OFFICE CHAIR & DESK	12 A	120	1	RECEPTACLE	15A-1P	2#12AWG (CU) + GND IN 21 mmC	43	PROVIDE NEMA 5-15R RECEPT & DATA CONNECTION
F.005	1	FUTURE MILLWORK BASE CABINET	12 A	120	1	RECEPTACLE	15A-1P	2#12AWG (CU) + GND IN 21 mmC	44	PROVIDE NEMA 5-15R RECEPT
F.005A	1	FUTURE MILLWORK UPPER CABINET								
F.005B	1	FUTURE UNDERMOUNT SINK W/FAUCET								

208V NEMA L15-20P RECEPTACLE

## **KEY NOTES**

- 1.) PROVIDE SHUNT TRIP BREAKERS FOR ALL KITCHEN EQUIPMENT LOCATED UNDER THE EXHAUST HOOD. SHUNT TRIP BREAKER TO DE-ENERGIZE ALL KITCHEN EQUIPMENT UNDER THE EXHAUST HOOD IN CASE OF ACTIVATION OF FIRE SUPPRESSION SYSTEM.
- 2.) PANEL TO FEED NEW LAUNDRY UNITS. HOWEVER, THIS PANEL IS TO REMAIN UNCONNECTED UPSTREAM. PANEL TO BE FED FROM FUTURE UPSTREAM DISTRIBUTION EQUIPMENT.
- (3.) ALL CONDUITS ASSOCIATED WITH BAS CONNECTIONS TO BE RUN TO THIS ROOM. THIS CONTRACTOR TO PROVIDE EMPTY CONDUIT c/w PULL STRING. BAS WIRING WORK TO BE DONE BY OTHERS.
- 4) PROVIDE JUNCTION BOXES LOCATED IN CEILING SPACE AND SPLICE FEED FOR WALK-IN COOLER POWER & WALK-IN FREEZER POWER. ENSURE WIRING IS ACCESSIBLE, SUCH TO RE-FEED BOTH UNITS FROM DIFFERENT SOURCE IN FUTURE
- $\langle \overline{5}. \rangle$  EXISTING DOOR HARDWARE TO BE REINSTATED AND PROGRAMMED WITH EXISTING BUILDING SECURITY SYSTEM SUCH TO ALLOW FOR A FULLY FUNCTIONAL SYSTEM.

## DRAWING NOTES

- THIS DRAWING IS TO BE READ IN CONJUNCTION WITH ARCHITECTURAL, STRUCTURAL, MECHANICAL AND ALL OTHER CONSULTANT DRAWINGS AND
- REFER TO ARCHITECTURAL & KITCHEN CONSULTANT DRAWINGS AND ELEVATIONS FOR FINAL DEVICE LOCATION AND MOUNTING HEIGHTS. IF NOT INDICATED, CONFIRM WITH ARCHITECT & KITCHEN CONSULTANT.
- THE KITCHEN AREA FLOOR PLANS SHALL BE READ IN CONJUNCTION WITH THE KITCHEN EQUIPMENT SCHEDULE TO DETERMINE APPROPRIATE ROUGH-IN
- THIS BUILDING UTILIZES A PRECAST HOLLOW-CORE CONCRETE SLAB. COORDINATE ALL HORIZONTAL CONDUIT RUNS AND CEILING PENETRATIONS WITH THE SLAB MANUFACTURER PRIOR TO ROUGH-IN. UNLESS ALLOWED OTHERWISE
- FOR POWER REQUIRED AT TEACHING & COMMERCIAL KITCHEN ISLANDS, WIRING AND CONDUIT TO BE TRENCHED BELOW SLAB USING MOST FEASIBLE PATH TO
- REFER TO ARCHITECTURAL AND KITCHEN ELEVATION DRAWINGS FOR ALL MOUNTING HEIGHTS AND FINAL LOCATIONS OF CONNECTIONS.

IN THE SPECIFICATIONS, ALL CONDUITS SHALL BE CONCEALED.

#### ELECTRICAL ROOM SCHEDULE

QUIPMENT NO.	DESCRIPTION	SCOPE
E.001	Ex. FIRE ALARM CONTROL PANEL	Ex. TO REMAIN
E.002	Ex. PANEL EM, 225A, 120/208V, 3\psi, 4W	Ex. TO REMAIN
E.003	Ex. PANEL L, 225A, 120/208V, 3φ, 4W	Ex. TO REMAIN
E.004	Ex. PANEL J, 225A, 120/208V, 3φ, 4W	Ex. TO REMAIN
E.005	Ex. PANEL C, 225A, 120/208V, 3\phi, 4W	Ex. TO REMAIN
E.006	Ex. UNNAMED SWITCHBOARD, 600A, 120/208V, 3¢, 4W	Ex. TO REMAIN
E.007	Ex. UNNAMED TRANSFORMER, 225kVA, 600V-120/208V, 3¢	Ex. TO REMAIN
E.008	Ex. AUTOMATIC TRANSFER SWITCH, 400A, 600/347V, 3-POLE, 4W	Ex. TO REMAIN
E.009	Ex. HYDRO METERING CABINET	Ex. TO REMAIN
E.010	Ex. MAIN DISCONNECT SWITCH, 400A, 347/600V, 3 4W	Ex. TO REMAIN
E.011	Ex. MAIN DISTRIBUTION SWITCHBOARD, 400A, 347/600V, 3φ, 4W	Ex. TO REMAIN
E.012	Ex. DISCONNECT SWITCH FOR ELEVATOR 1, 60A, 600V, 3¢	Ex. TO REMAIN
E.013	Ex. DISCONNECT SWITCH FOR ELEVATOR 2, 60A, 600V, 3¢	Ex. TO REMAIN
E.014	Ex. DISCONNECT SWITCH FOR VILLA, 30A, 600V, 3¢	Ex. TO REMAIN
E.015	Ex. DISCONNECT SWITCH FOR MAKE UP AIR #2, 30A, 600V, 3¢	Ex. TO REMAIN
E.016	Ex. DISCONNECT SWITCH FOR MAKE UP AIR #3, 30A, 600V, 3¢	Ex. TO REMAIN
E.017	Ex. DISCONNECT SWITCH FOR KITCHEN FAN EF-21, 30A, 600V, 3¢	Ex. TO REMAIN
E.018	Ex. DISCONNECT SWITCH FOR WASHROOM FAN EF-7, 30A, 600V, 3¢	Ex. TO REMAIN
<b>Ξ.019</b>	Ex. DISCONNECT SWITCH FOR SOUTH EAST AIR UNIT, 30A, 600V, 3¢	Ex. TO REMAIN
E.020	Ex. DISCONNECT SWITCH FOR WEST AIR UNIT, 30A, 600V, 3¢	Ex. TO REMAIN
E.021	Ex. DISCONNECT SWITCH FOR NORTH EAST AIR UNIT, 30A, 600V, 3¢	Ex. TO REMAIN
E.022	Ex. MECH SPLITTER, 225A, 600V, 3¢	Ex. TO REMAIN

Ex. COMMUNICATIONS EQUIPMENT



THE**HIDI**GROUP 155 Gordon Baker Road, Suite 200 Toronto, ON M2H 3N5 Canada

PRIME CONSULTANT

310 Spadina Ave, Suite 100B

partners

Toronto, Ontario, Canada M5T 2E8 T: 416 203 7600 F: 416 203 3342 lga-ap.com

DESIGN BY:	SJ
DRAWN BY:	CW
CHECKED BY:	JP
APPROVED BY:	SJ
SCALE:	N/A
DATE:	JUNE.2025
CONSULTANT PROJECT NO.	2025-0012.01

#### ISSUE DATE:

4	2025-09-18	IFT
3	2025-07-14	ISSUED FOR PERMIT
2	2025-07-10	ISSUED FOR PERMIT REVIEW
1	2025-06-02	ISSUED FOR REVIEW

NO. DATE DESCRIPTION





# THE REGIONAL MUNICIPALITY OF DURHAM

**WORKS DEPARTMENT DESIGN, CONSTRUCTION & ASSET MANAGEMENT** 

PHASE 2 RENOVATIONS

1635 DUNDAS STREET EAST WHITBY, ONTARIO


SHEET TITLE:

## FIRST FLOOR -POWER AND SYSTEMS PLAN

PROPERTY NO. RP-W-42	SS-W-02
FACILITIES PROJECT NO.	CONTRACT NO.
SS-W-02-23-01	RFP-1048-2025

SHEET NO.

Ex. TO REMAIN

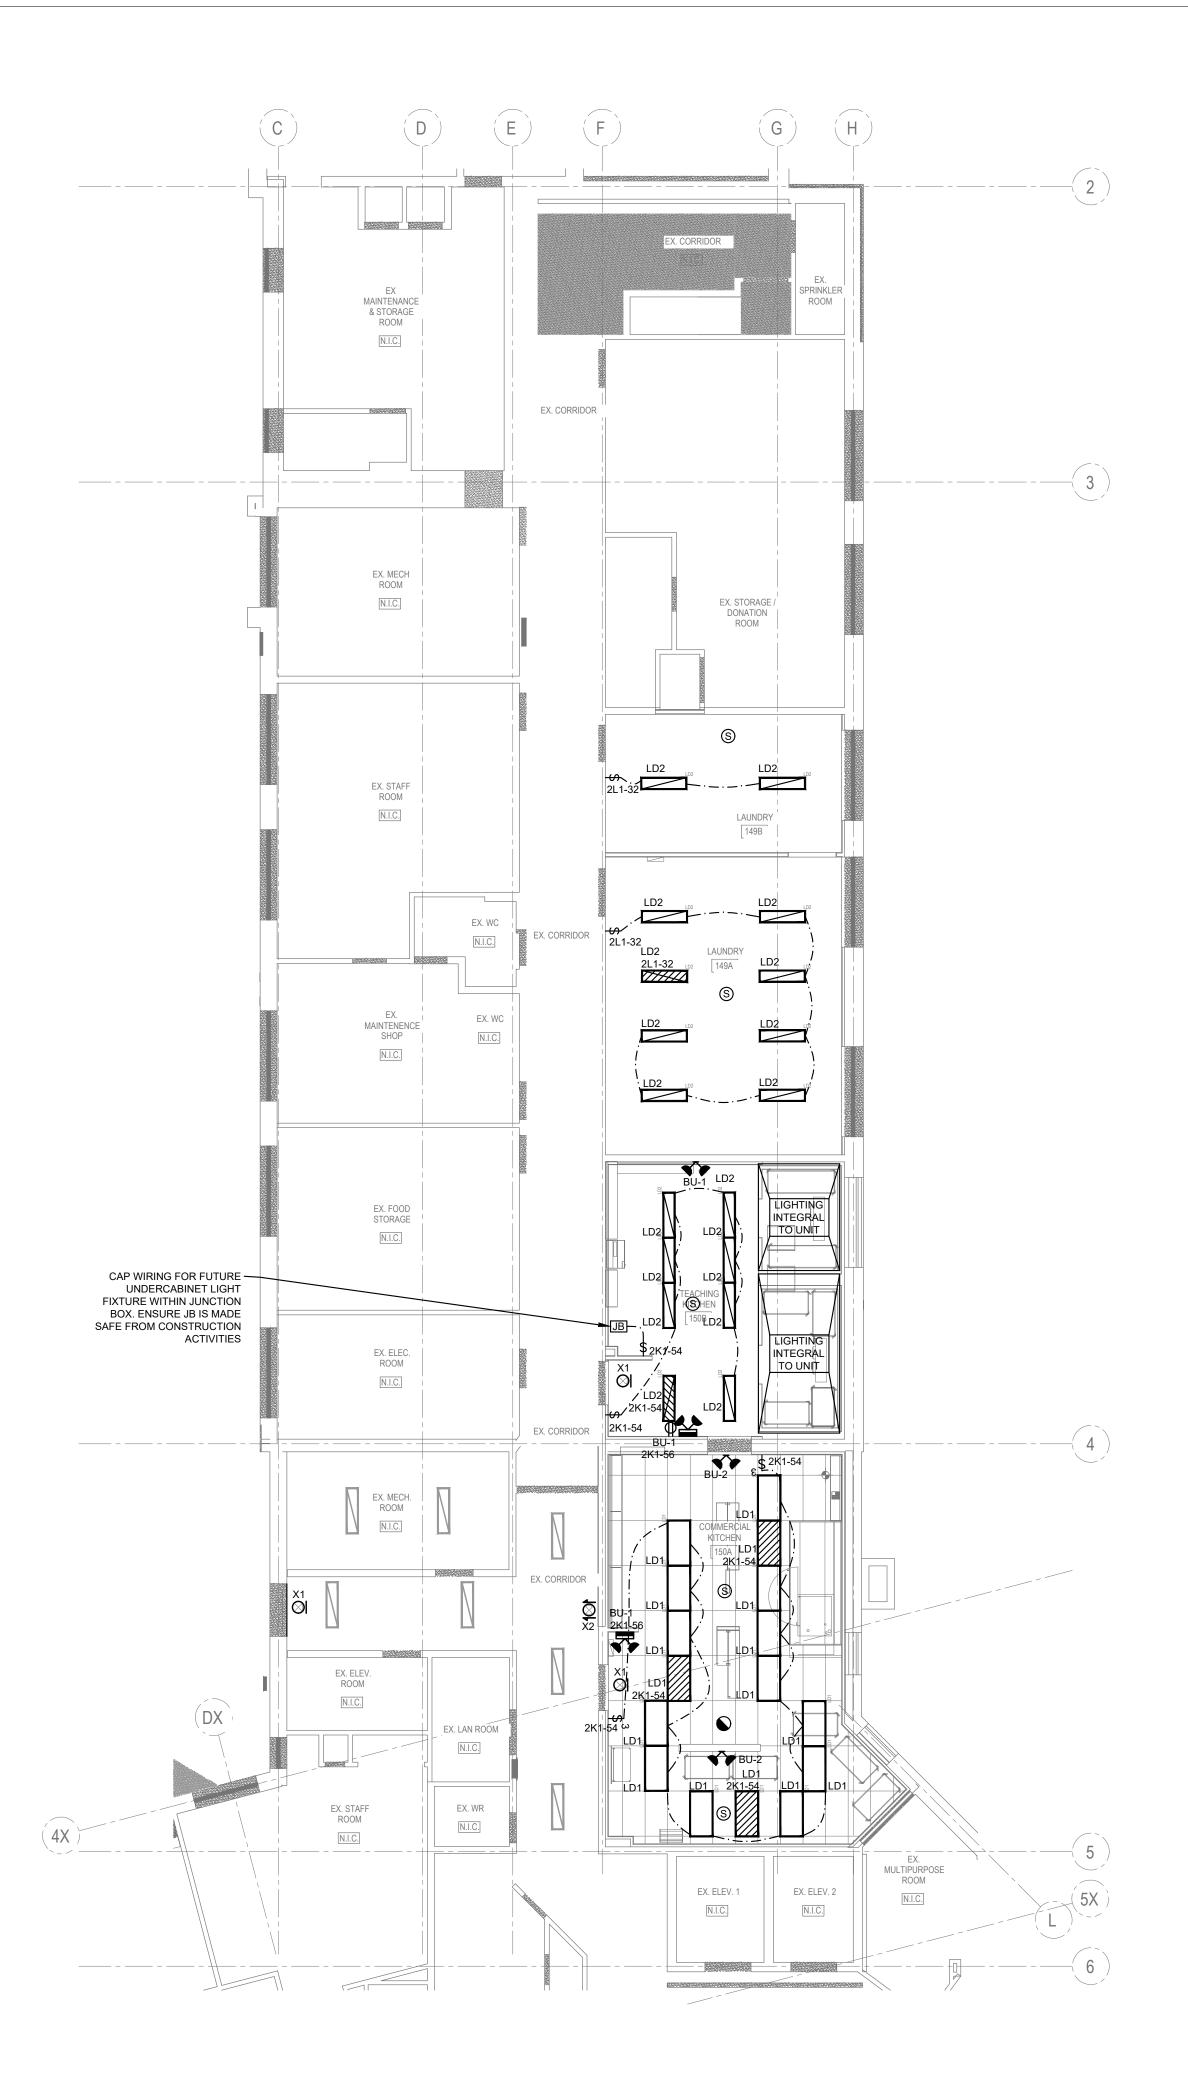

## FIRST FLOOR - REFLECTED CEILING PLAN E-201 SCALE: 1:100

#### **DRAWING NOTES**

- 1. THIS DRAWING IS TO BE READ IN CONJUNCTION WITH ARCHITECTURAL, STRUCTURAL, MECHANICAL AND ALL OTHER CONSULTANT DRAWINGS AND DOCUMENTS.
- 2. REFER TO ARCHITECTURAL & KITCHEN CONSULTANT DRAWINGS AND ELEVATIONS FOR FINAL DEVICE LOCATION, IF NOT INDICATED, CONFIRM WITH ARCHITECT & KITCHEN CONSULTANT PRIOR TO ROUGH-IN.
- 3. HATCHED FIXTURES ARE INTENDED TO REMAIN ALWAYS ON.
- 4. EXIT SIGNS TO BE FED USING EXISTING NEARBY EXIT SIGN CIRCUIT. PROVIDE NEW WIRING, CONDUIT & JUNCTION BOXES TO EXTEND FEED TO NEW SIGN AS REQUIRED.

	BATTERY UNIT SCHEDULE							
ID	DC VOLTAGE	AC VOLTAGE	CAPACITY	RUNTIME	CONNECTED LOADS	LOCATION	REMARKS	
BU-1	24V	120V	136W	120 MIN	20W	TEACHING KITCHEN	PROVIDE REMOTE HEADS AS SHOWN	
BU-2	24V	120V	136W	120 MIN	30W	COMMERCIAL KITCHEN	PROVIDE REMOTE HEADS AS SHOWN	



THEHIDIGROUP 155 Gordon Baker Road, Suite 200 Toronto, ON M2H 3N5 Canada

**HIDI** t. 416 364 2100 | HIDI.com PRIME CONSULTANT

partners

310 Spadina Ave, Suite 100B Toronto, Ontario, Canada M5T 2E8 T: 416 203 7600 F: 416 203 3342 lga-ap.com

DESIGN BY:	SJ
DRAWN BY:	CW
CHECKED BY:	JP
APPROVED BY:	SJ
SCALE:	N/A
DATE:	JUNE.2025
CONSULTANT PROJECT NO.	2025-0012.01

#### ISSUE DATE:

4 2025-09-18 IFT 3 2025-07-14 ISSUED FOR PERMIT 2 2025-07-10 ISSUED FOR PERMIT REVIEW 1 2025-06-02 ISSUED FOR REVIEW

NO. DATE DESCRIPTION

09/12/2025 S. JAIN



# THE REGIONAL MUNICIPALITY OF DURHAM

WORKS DEPARTMENT DESIGN, CONSTRUCTION & ASSET MANAGEMENT

PHASE 2 RENOVATIONS

1635 DUNDAS STREET EAST WHITBY, ONTARIO

SHEET TITLE:

## FIRST FLOOR -REFLECTED CEILING PLAN

PROPERTY NO. RP-W-42 FACILITIES PROJECT NO.


**FACILITY CODE** SS-W-02

CONTRACT NO. RFP-1048-2025 SS-W-02-23-01

SHEET NO.

#### DRAWING NOTES

- THIS DRAWING IS TO BE READ IN CONJUNCTION WITH ARCHITECTURAL, STRUCTURAL, MECHANICAL AND ALL OTHER CONSULTANT DRAWINGS AND DOCUMENTS.
- REFER TO MECHANICAL DRAWINGS, EQUIPMENT SUBMITTALS AND COORDINATE WITH MECHANICAL CONTRACTOR FOR FINAL CONNECTION LOCATION.
- PROVIDE JUNCTION BOXES LOCATED IN CEILING SPACE OF 3RD FLOOR CORRIDOR.
  JUNCTION BOXES TO BE UTILIZED TO SPLICE FEED FOR UNIT'S POWER. ENSURE WIRING IS ACCESSIBLE, SUCH TO ALLOW RE-FEED OF UNITS FROM DIFFERENT SOURCE IN FUTURE.

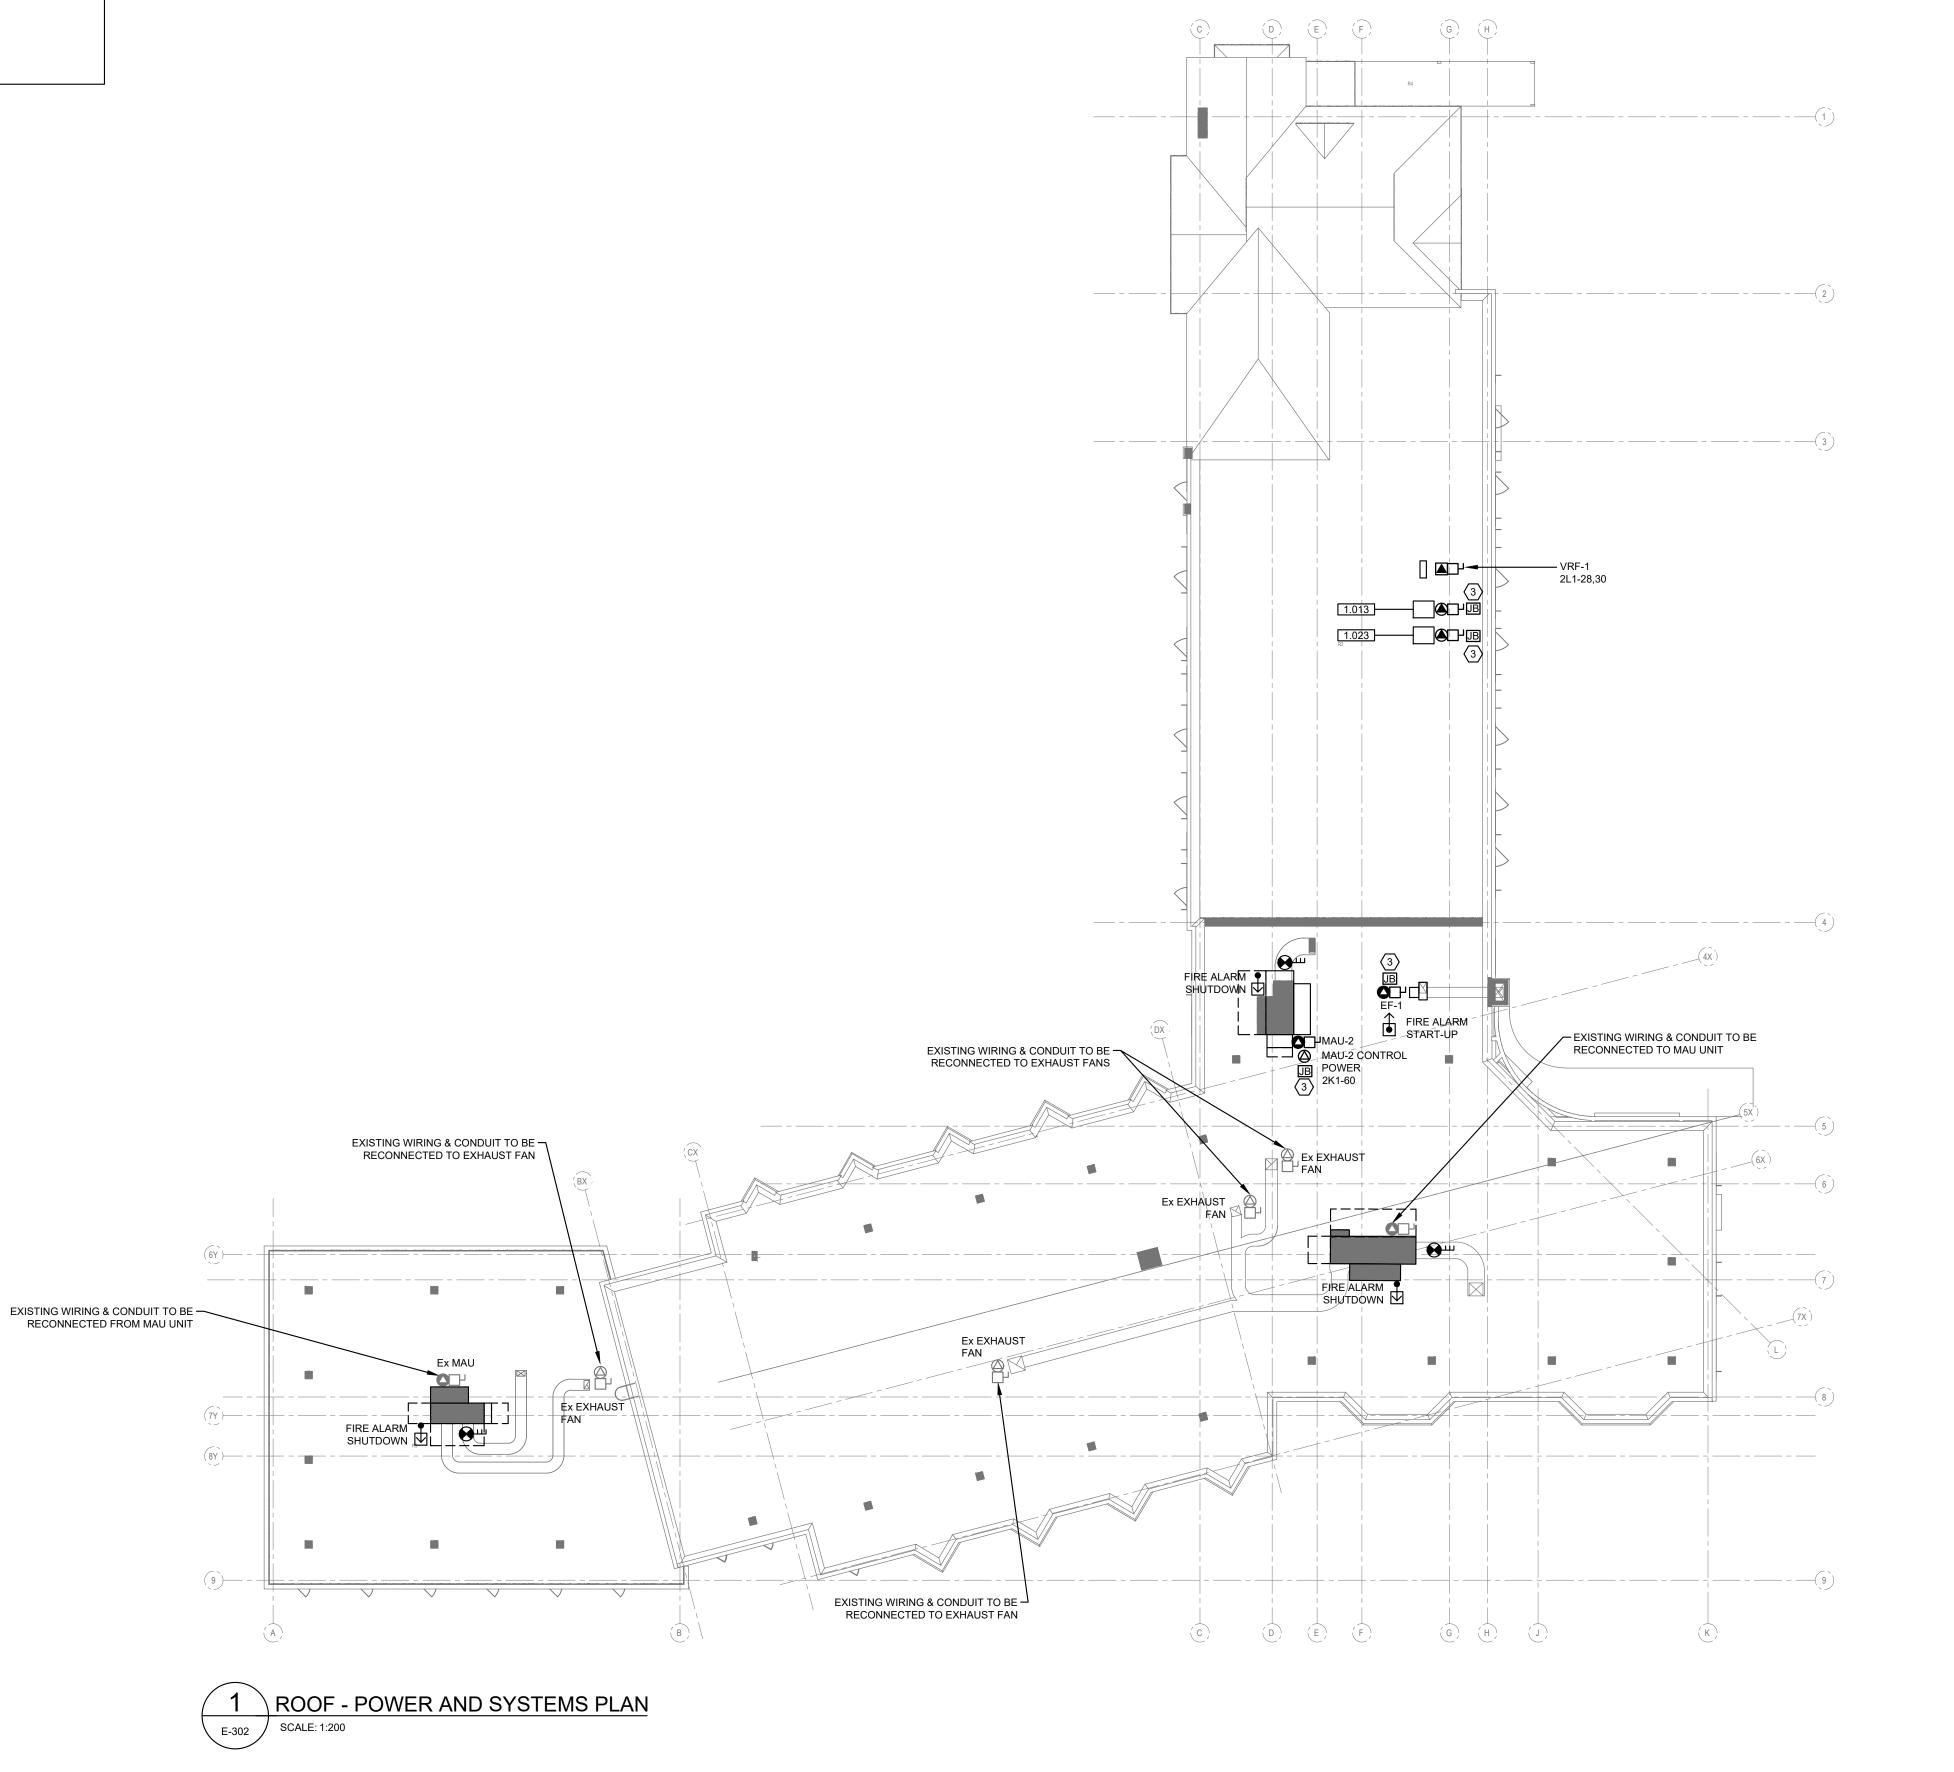





partners

310 Spadina Ave, Suite 100B Toronto, Ontario, Canada M5T 2E8 T: 416 203 7600 F: 416 203 3342 lga-ap.com


DESIGN BY:	SJ	
DRAWN BY:	CW	
CHECKED BY:	JP	
APPROVED BY:	SJ	
SCALE:	N/A	
DATE:	JUNE.2025	
CONSULTANT PROJECT NO.	2025-0012.01	

#### ISSUE DATE:

4	2025-09-18	IFT
3	2025-07-14	ISSUED FOR PERMIT
2	2025-07-10	ISSUED FOR PERMIT REVIEW
1	2025-06-02	ISSUED FOR REVIEW

NO. DATE

DESCRIPTION

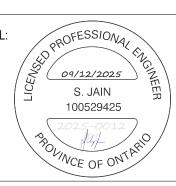



# THE REGIONAL MUNICIPALITY OF DURHAM

WORKS DEPARTMENT DESIGN, CONSTRUCTION & ASSET MANAGEMENT

PHASE 2 RENOVATIONS

1635 DUNDAS STREET EAST WHITBY, ONTARIO

SHEET TITLE:


## ROOF -POWER AND SYSTEMS PLAN


POWER AINL	DOTOTEINIOPL		
PROPERTY NO.	FACILITY CODE		
RP-W-42	SS-W-02		

FACILITIES PROJECT NO. SS-W-02-23-01

CONTRACT NO. RFP-1048-2025

SHEET NO.

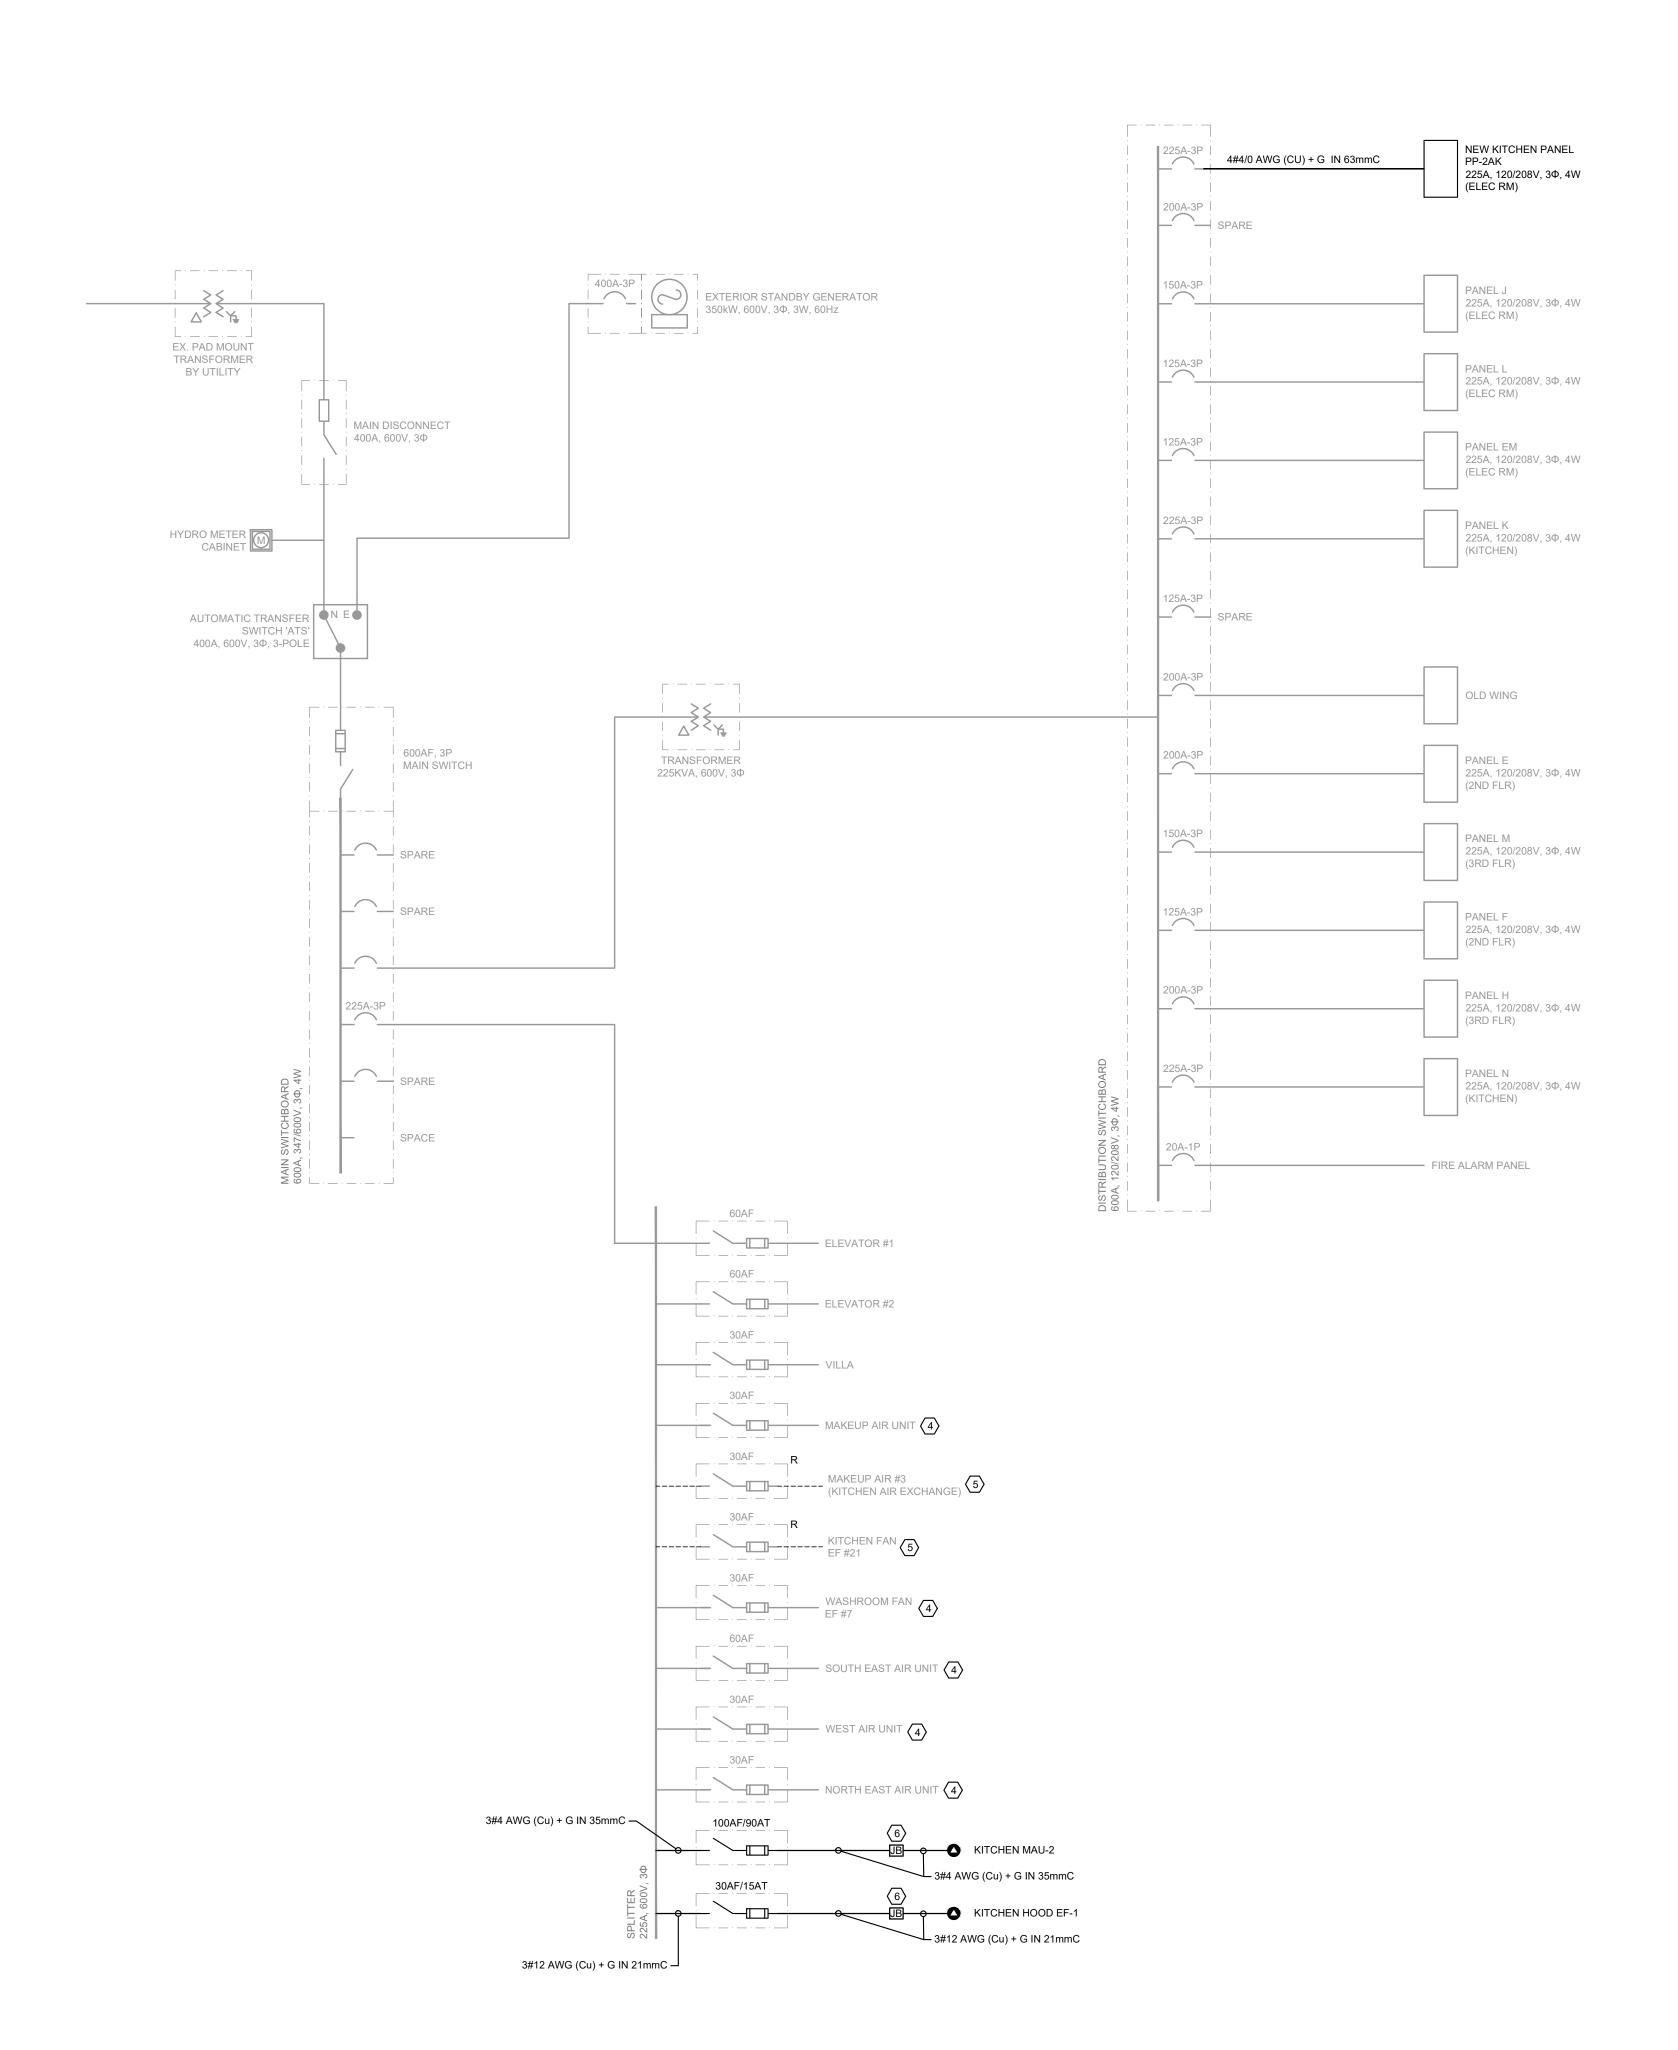

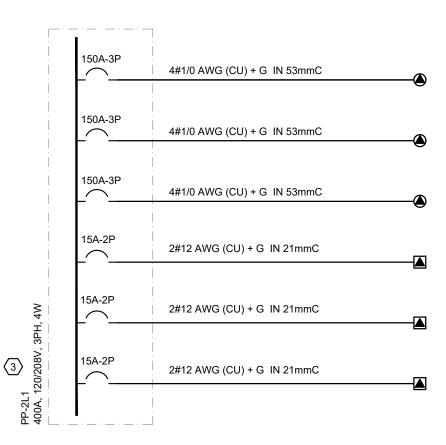

#### **DRAWING NOTES**

1. THIS DRAWING IS TO BE READ IN CONJUNCTION WITH ARCHITECTURAL, STRUCTURAL, MECHANICAL AND ALL OTHER CONSULTANT DRAWINGS AND DOCUMENTS.

- 2. ALL DISTRIBUTION EQUIPMENT, UNLESS OTHERWISE NOTED, IS EXISTING TO REMAIN.
- (3.) THIS PANEL IS TO REMAIN UNFED FROM UPSTREAM SOURCES. DOWNSTREAM LOADS SHOWN ARE TO BE CONNECTED TO NEW PANEL BY THIS CONTRACTOR, AND NEW INCOMING FEED FOR PANEL TO BE COMPLETED IN FUTURE. LOADS SHOWN ON SLD ARE MAJOR LOADS CONNECTED TO THIS PANEL. REFER TO PANEL SCHEDULE FOR FUTURE DETAILS.
- $\langle 4. 
  angle$  DISCONNECT FEED TO UNIT AT ROOF LEVEL, CAP AND KEEP SAFE FOR DURATION OF CONSTRUCTION. ONCE ROOFING WORK HAS BEEN COMPLETED AND MECHANICAL CONTRACTOR HAS RE-INSTALLED UNIT, RE-CONNECT ELECTRICAL FEED BACK TO THE UNIT. ALLOW FOR ADDITIONAL WIRING CONDUIT WORK TO SUIT RE-INSTALLED UNIT, IF REQUIRED. COORDINATE ALL WORK WITH MECHANICAL CONTRACTOR.
- (5.) POWER CONNECTION TO BE DEMOLISHED FROM UNIT TO SPLITTER, ALONG WITH DISCONNECT SWITCH.
- $\langle 6. \rangle$  JUNCTION BOX TO BE PROVIDED FOR WIRING SPLICING, SUCH TO RE-FEED UNIT FROM ANOTHER SOURCE IN FUTURE.



THE**HIDI**GROUP 155 Gordon Baker Road, Suite 200

**HIDI** t. 416 364 2100 | HIDI.com PRIME CONSULTANT

partners 310 Spadina Ave, Suite 100B Toronto, Ontario, Canada M5T 2E8 T: 416 203 7600 F: 416 203 3342

DESIGN BY:	SJ
DRAWN BY:	CW
CHECKED BY:	JP
APPROVED BY:	SJ
SCALE:	N/A
DATE:	JUNE.2025
CONSULTANT PROJECT NO.	2025-0012.01

#### **ISSUE DATE:**

lga-ap.com

2025-09-18	IFT
2025-07-14	ISSUED FOR PERMIT
2025-07-10	ISSUED FOR PERMIT REVIEW
2025-06-02	ISSUED FOR REVIEW
	2025-07-14 2025-07-10

NO. DATE DESCRIPTION





## THE REGIONAL MUNICIPALITY OF DURHAM

**WORKS DEPARTMENT DESIGN, CONSTRUCTION &** ASSET MANAGEMENT

PHASE 2 RENOVATIONS

1635 DUNDAS STREET EAST WHITBY, ONTARIO

SHEET TITLE:

## SINGLE LINE DIAGRAM -**DEMO & NEW**

PROPERTY NO. RP-W-42

SS-W-02-23-01

SHEET NO.


SS-W-02

CONTRACT NO.

RFP-1048-2025

**FACILITY CODE** 

**FACILITIES PROJECT NO.** 

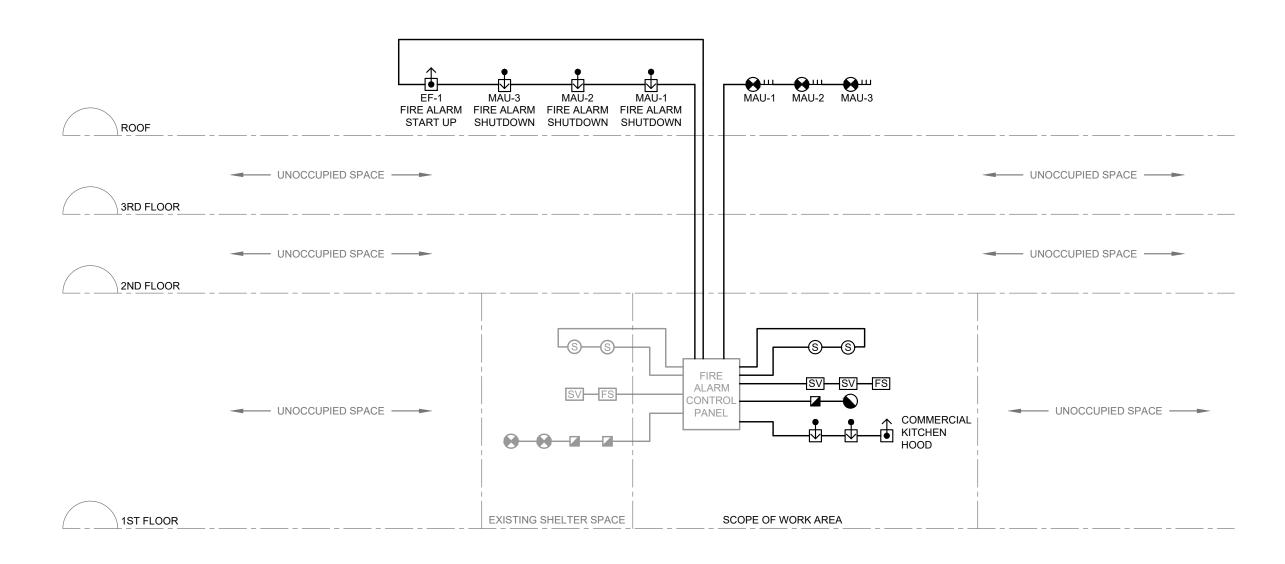

$\bigcirc$ 1	FIRE ALARM RISER
E-601	SCALE: N/A

ZONE #	ZONE DESCRIPTION	PULL STATION (FZ)	CNAONE	SUPERVI SED VALVE (SZ)	SPRINKLER FLOW SWITCH (FZ)	LOSS OF PRESSURE (SZ)	DUCT DETECT OR (FZ)	STARTUP SIGNAL (CZ)	SHUTDO WN SIGNAL (CZ)	HORN/STR OBE CCT. A (HZ)	HORN/STRO BE CCT. B (HZ)	AUDIO CCT. 1 (BZ)	AUDIO CCT. 2 (BZ)	HANDSE T (PZ)	FIRE ALARM CONNECTION (CZ)	AUX. SYSTEM TROUBLE (SZ)	AUX. SYSTEM ALARM (FZ)	REMARKS
1	FIRST FLOOR																	EXISTING ZONE TO REMAIN; CONNECT NEW DEVICES TO EXISTING ZONE
2	SECOND FLOOR																	EXISTING ZONE TO REMAIN
3	THIRD FLOOR																	EXISTING ZONE TO REMAIN
4	MAIN SPRINKLER SUPERVISORY VALVE																	EXISTING ZONE TO REMAIN
5	MAIN SPRINKLER HEADER																	EXISTING ZONE TO REMAIN
6	FIRST FLOOR SPRINKLER																	EXISTING ZONE TO REMAIN
7	SECOND FLOOR SPRINKLER																	EXISTING ZONE TO REMAIN
8	THIRD FLOOR SPRINKLER																	EXISTING ZONE TO REMAIN
9	ALL STAIR WELLS																	EXISTING ZONES TO REMAIN
10	ELEVATOR 1 PIT/SHAFT																	EXISTING ZONE TO REMAIN
11	ELEVATOR 2 PIT/SHAFT																	EXISTING ZONE TO REMAIN
12	ELEVATOR MACHINE ROOM																	EXISTING ZONE TO REMAIN
13	ELEVATOR MAIN LOBBY SMOKE																	EXISTING ZONE TO REMAIN
14	ELEVATOR FLOOR 2-3 SMOKE																	EXISTING ZONE TO REMAIN
15	ELEVATOR 1 RECALL																	EXISTING ZONE TO REMAIN
16	ELEVATOR 2 RECALL																	EXISTING ZONE TO REMAIN
17	ELEVATOR 1 ALTERNATE FLOOR																	EXISTING ZONE TO REMAIN
18	ELEVATOR 2 ALTERNATE FLOOR																	EXISTING ZONE TO REMAIN
19	CENTRAL MAU						•											
20	KITCHEN MAU						•		•									
21	WEST WING MAU						•											
22	EF-1							•										
23	KITCHEN FIRE SUPPRESSION SYSTEM															•		
24	KITCHEN EQUIPMENT SHUNT TRIP														•			
25	KITCHEN GAS SHUT OFF														•			
26	COMMERCIAL KITCHEN/LAUNDRY ROOM SPRINKLER ZONE			•	•													



#### NOTES

#### 1. THE EXISTING FIRE ALARM SYSTEM IS A TWO-STAGE SYSTEM.

- SPRINKLER ZONE NOMENCLATURE SHALL BE COORDINATED TO SUIT THE FINAL SPRINKLER MECHANICAL SYSTEM DESIGN, CONTROL PANEL LED LABELS SHALL BE UPDATED
- 3. ALL FINAL DESIGNATION OF NAMES FOR THE FIRE ALARM CONTROL PANEL ARE TO CORRESPOND TO THE ELEVATOR NUMBERS AND FLOOR DESIGNATIONS.
- 4. RETURN WIRING OF CLASS 'A' CIRCUIT SHALL BE RUN SEPARATE FROM THE REMAINDER OF THE CIRCUIT WIRING.
- FIRE SUPPRESSION SYSTEM PRESSURE REDUCING STATION HAS FOUR (4) SUPERVISORY VALVES WHICH MUST BE CONNECTED TO THE FIRE ALARM SYSTEM.
- 6. EACH NEW SPRINKLER ZONE CONTROL STATION HAS ONE FLOW SWITCH AND ONE SUPERVISORY VALVE WHICH MUST BE CONNECTED TO THE FIRE ALARM SYSTEM. REVIEW THE MECHANICAL SPRINKLER DRAWINGS FOR LOCATION AND QUANTITY OF DEVICES.
- 7. PROVIDE A 120V POWER CONNECTION FOR THE SPRINKLER 'LOW PRESSURE' ALARM SENSOR. THE LOW PRESSURE ALARM SENSOR WILL BE CONNECTED TO THE F.A. CONTROL PANEL TO SIGNAL TROUBLE.
- B. ELECTRICAL CONTRACTOR SHALL LOCATE DUCT DETECTORS IN THE STRAIGHT SECTION WITHIN THE DUCTWORK SYSTEM. IF THE LOCATION DOES NOT ADHERE TO THE LATEST RECOMMENDED STANDARDS. THE ELECTRICAL CONTRACTOR SHALL HAVE THE SITE
- 9. ELECTRICAL CONTRACTOR SHALL OBTAIN FAN SHUT DOWN LIST AND PROVIDE FINAL TERMINATIONS AND TESTING.

REVIEWED BY THE FIRE ALARM MANUFACTURER AND SUBMIT IN WRITING THAT

DETECTORS ARE STILL MONITORING THE SYSTEM ACCURATELY.

- 10. FIRE ALARM RISER CABLING SHALL BE FIRE RATED.
- 11. ALL EXISTING SPRINKLER ZONES ARE TO REMAIN.
- 12. PROVIDE WIRING FOR ALL NEW SPRINKLER FLOW SWITCHES, SUPERVISED AND PRESSURE SWITCHES. CONNECT INTO PROPER ZONES AND COORDINATE WITH SPRINKLER CONTRACTOR PRIOR TO ROUGH-IN & ORDERING FIRE ALARM EQUIPMENT. ZONES INDICATED ON THIS RISER AND SCHEDULE ARE FOR REFERENCE, FINAL ZONES WILL BE FINALIZED WITH SPRINKLER SHOP DRAWINGS.
- 13. REFER TO FIRE PROTECTION DRAWINGS FOR THE FIRE PROTECTION DIAGRAMS FOR RELATED DETAILS.
- 14. PRIOR TO SUBMISSION OF THE SHOP DRAWINGS, COORDINATE WITH THE SPRINKLER CONTRACTOR FOR THE EXACT LOCATION OF EACH DEVICES AND INDICATE ON THE DEVICES ON THE SHOP DRAWINGS.
- 15. THE FIRE PROTECTION DIAGRAMS & FLOOR PLANS INDICATED ON FIRE PROTECTION DRAWINGS IS CONCEPTUAL ONLY AND IT IS SUBJECT TO CHANGES BASED ON THE SPRINKLER SHOP DRAWINGS. THE FIRE ALARM MANUFACTURER AND CONTRACTOR SHALL MAKE ALLOWANCE IN THE TENDER PRICE AT NO EXTRA COSTS TO THE CONTRACT FOR THE PROVISION FOR ADDITION OF FIVE PERCENT (5%) OF THE TOTAL QUANTITIES FOR ALL THE DEVICES SUCH AS FLOW SWITCHES, SUPERVISORY VALVE, PRESSURE SWITCHES, CONNECTION TO CONTROL PANELS ETC. WITH ALL RELATED WIRING, VERIFICATION AND ACCESSORIES FOR A COMPLETE AND OPERATING SYSTEM.
- 16. PROVIDE HOA (HAND-OFF-AUTO) SWITCH AT THE FIRE ALARM PANEL FOR EACH MAU.

# KITCHEN FIRE SUPPRESSION SYSTEM SEQUENCE OF OPERATIONS

UPON ACTIVATION OF THE KITCHEN FIRE SUPPRESSION SYSTEM:

- SEND A SIGNAL TO THE FIRE ALARM CONTROL PANEL AND ENTER SECOND STAGE ALARM.
   SEND FIRE ALARM SIGNAL TO KITCHEN MAKE UP UNIT TO SHUT OFF VIA AUXILIARY CONTACT.
- KITCHEN EXHAUST FAN EF-1 SHALL TURN ON VIA AUXILIARY CONTACT.
   ALL EQUIPMENT UNDER THE COMMERCIAL KITCHEN EXHAUST HOOD SHALL BE DE-ENERGIZED BY OPENING THE SHUNT TRIP BREAKERS TO THE EQUIPMENT.
- 3. ALL EQUIPMENT UNDER THE KITCHEN EXHAUST HOOD SHALL HAVE GAS SUPPLY SHUT OFF BY CLOSING THE MOTORIZED GAS VALVE VIA AUXILIARY CONTACT.

### FIRE ALARM SEQUENCE OF OPERATIONS

THIS SEQUENCE OF OPERATIONS ONLY APPLIES TO NEW DEVICES. EXISTING SEQUENCE OF OPERATIONS OF ALL EXISTING DEVICES IS TO REMAIN.

- AIR HANDLING UNIT
- 1.1. ALL MAKE-UP AIR UNITS (CENTRAL, KITCHEN & WEST WING) SHALL RUN UNLESS THE ASSOCIATED DUCT SMOKE DETECTOR IS ACTIVATED (ZONE 19 TO 21). AT ANY TIME IF THE DUCT SMOKE DETECTOR IS ACTIVATED, THE UNITS SHALL BE SHUT DOWN.
- 1.2. UPON ACTIVATION OF FIRST STAGE OF FIRE ALARM SYSTEM FOR BUILDING OR ACTIVATION OF FIRE SUPPRESSION SYSTEM, KITCHEN MAKE-UP AIR UNIT SHALL BE SHUT DOWN.
- 2. KITCHEN HOOD EXHAUST FAN EF-1

  2.1. UPON ACTIVATION OF FIRST STAGE OF FIRE ALARM SYSTEM FOR BUILDING OR ACTIVATION OF FIRE SUPPRESSION SYSTEM, EF-1 TO TURN ON (OR STAY ON).



# THE **HIDI**GROUP

155 Gordon Baker Road, Suite 200 Toronto, ON M2H 3N5 Canada H I D I t. 416 364 2100 | HIDI.com




310 Spadina Ave, Suite 100B Toronto, Ontario, Canada M5T 2E8 T: 416 203 7600 F: 416 203 3342 lga-ap.com

DESIGN BY:	SJ
DRAWN BY:	CW
CHECKED BY:	JP
APPROVED BY:	SJ
SCALE:	N/A
DATE:	JUNE.2025
CONSULTANT PROJECT NO.	2025-0012.01

#### ISSUE DATE:

4	2025-09-18	IFT
3	2025-07-14	ISSUED FOR PERMIT
2	2025-07-10	ISSUED FOR PERMIT REVIEW
1	2025-06-02	ISSUED FOR REVIEW

NO. DATE DESCRIPTION

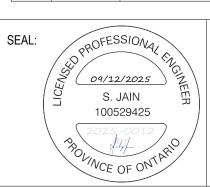



# THE REGIONAL MUNICIPALITY OF DURHAM

WORKS DEPARTMENT
DESIGN, CONSTRUCTION &
ASSET MANAGEMENT

PROJEC

PHASE 2 RENOVATIONS

1635 DUNDAS STREET EAST WHITBY, ONTARIO

SHEET TITLE:


## FIRE ALARM RISER

FACILITIES PROJECT NO.	CONTRACT NO.
RP-W-42	SS-W-02
PROPERTY NO.	FACILITY CODE

RFP-1048-2025

SHEET NO.

SS-W-02-23-01

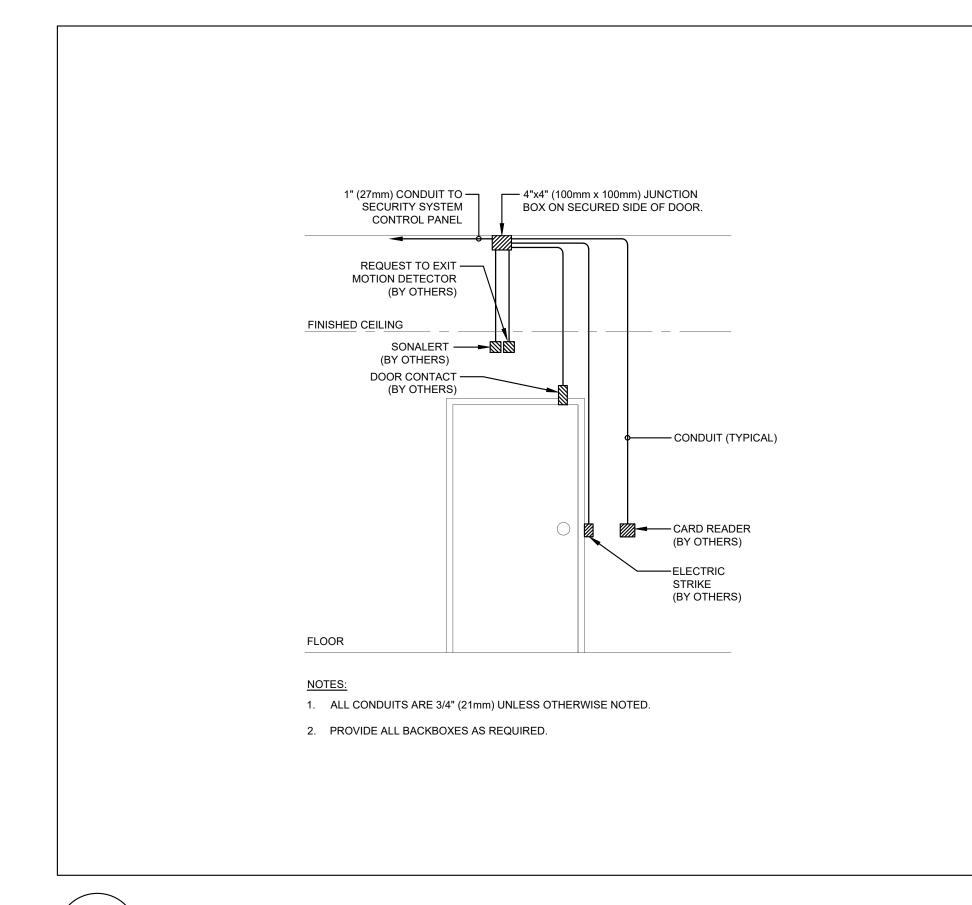

SINGLE DOOR WITH ELECTRIC STRIKE (TYPICAL) SCALE: NTS E801



# THEHIDIGROUP

155 Gordon Baker Road, Suite 200 Toronto, ON M2H 3N5 Canada t. 416 364 2100 | HIDI.com



partners 310 Spadina Ave, Suite 100B Toronto, Ontario, Canada M5T 2E8 T: 416 203 7600 F: 416 203 3342

DESIG	GN BY:	SJ
DRAV	VN BY:	CW
CHEC	KED BY:	JP
APPR	OVED BY:	SJ
SCAL	E:	N/A
DATE	:	JUNE.2025
CONS	SULTANT PROJECT NO.	2025-0012.01

#### ISSUE DATE:

lga-ap.com

ISSUE DATE:									
	4	2025-09-18	IFT						
	3	2025-07-14	ISSUED FOR PERMIT						
	2	2025-07-10	ISSUED FOR PERMIT REVIEW						
	1	2025-06-02	ISSUED FOR REVIEW						

NO. DATE DESCRIPTION

09/12/2025 S. JAIN



# THE REGIONAL **MUNICIPALITY OF** DURHAM

WORKS DEPARTMENT DESIGN, CONSTRUCTION & ASSET MANAGEMENT

PHASE 2 RENOVATIONS

1635 DUNDAS STREET EAST WHITBY, ONTARIO

SHEET TITLE:

## ELECTRICAL DETAILS

PROPERTY NO. RP-W-42	FACILITY CODE SS-W-02
FACILITIES PROJECT NO.	CONTRACT NO.
SS-W-02-23-01	RFP-1048-2025

SHEET NO.