MECHAN	NICAL LEGEND EXISTING DEVICES ARE TONED:
	SUPPLY OR OUTSIDE AIR DUCT (UP / DOWN)
	RETURN AIR DUCT (UP / DOWN)
	EXHAUST AIR DUCT (UP / DOWN)
	DAMPER DF - FIRE DM - MANUAL BALANCING
D?	DA - AUTOMATIC W/ OPERATOR
	DFS - FIRE/SMOKE
+ + +	DOUBLE LINE DUCT - SINGLE LINE DUCT
	DOUBLE LINE DUCT - SINGLE LINE DUCT WITH LINING AS NOTED
 	DOUBLE LINE DUCT - SINGLE LINE DUCT WITH ACOUSTIC INSULATION
	DOUBLE LINE DUCT - SINGLE LINE DUCT WITH SILENCER
/////////////////////////////////////	DOUBLE LINE DUCT - SINGLE LINE DUCT WITH FIRE WRAP
	FLEX DUCT WITH TAKE-OFF C/W MANUAL BALANCING DAMPER
	SECURITY BAR IN DUCTWORK
	RETURN AIR GRILLE
	EXHAUST GRILLE
	TRANSFER GRILLE
	LIGHT TROFFER - TOP INLET
	LIGHT TROFFER - SIDE INLET
<u> </u>	SQUARE DIFFUSER
(0)	ROUND DIFFUSER
	LINEAR DIFFUSER
	VAV BOX
	VAV BOX WITH REHEAT COIL
	VAV BOX WITH ATTENUATOR
	VAV BOX WITH ATTENUATOR AND REHEAT COIL
	BYPASS BOX
	FAN POWERED VAV BOX
	MECHANICAL EQUIPMENT AS INDICATED (REVIT)
0	THERMOSTAT
	TEMPERATURE SENSOR - (DIGITAL)
C	CO SENSOR
X	TEMPERATURE/CO2 SENSOR
Z	TEMPERATURE/OCCUPANCY SENSOR
N	CO/NOX SENSOR
C2	CO2 SENSOR
H	HUMIDITY SENSOR
	LEAK DETECTOR
S	SPEED CONTROLLER
\$	ON/OFF SWITCH - CONTROL SWITCH
	DRAIN FD - FLOOR FFD - FUNNEL FLOOR GD - GARAGE
□ RD	ROOF DRAIN (SIZE)
MH	CATCH BASIN MAN HOLE AS INDICATED
RT	RUNNING TRAP
GTD	TD - TRENCH
BWV	DRAIN GTD - GARAGE
	BACKWATER VALVE
<u> </u>	CLEANOUT HB - HOSE BIB NFHB - NON-FREEZE HOSE BIB
→ ^{HB}	BIB WH - WALL HYDRANT
© GH	NON-FREEZE GROUND HYDRANT
	CAP
FHC	FIRE HOSE CABINET
FE⊗	FIRE EXTINGUISHER
FEC	FIRE EXTINGUISHER WITH CABINET
•	SPRINKLER HEAD - PENDANT
Ø	SPRINKLER HEAD - SEMI-RECESSED
<u>.</u>	SPRINKLER HEAD - RECESSED
0	SPRINKLER HEAD - UPRIGHT
∇	SPRINKLER HEAD - SIDEWALL
e+<>	FIRE DEPARTMENT CONNECTION
===	FIRE HYDRANT
<u> </u>	FIRE PUMP TEST HEADER

MECHA	NICAL LEC	GEND EXISTING DEVICES CBV ARE TONED:
\bowtie	ISOLATION VALV	/E
⋈ ^{CBV}	CIRCUIT BALANC	CING VALVE
MABV	AUTOMATIC FLO	W CONTROL VALVE
×	BALANCING VAL	VE
Ź	CHECK VALVE	
	PRESSURE RED	UCING VALVE
*	SUPERVISED VA	LVE
	(SAFETY) RELIEF	
<u>**</u>		
	2 OR 3 WAY CON	
R SAFE	SOLENOID VALV	E
D SAFE	SHUT OFF FIRE	SAFE VALVE
	DRAIN VALVE	
À	STRAINER	
Ш	UNION	
4	AIR VENT	
ф	FLOW SWITCH	
P YPW	PRESSURE GAU	GE PRESSURE WELL
₽ Y™	THERMOMETER	THERMOMETER WELL
φ	TEMPERATURE	GAUGE
W G M	WATER METER	/ GAS METER / METER AS NOTED
oxdot	VENTURI FLOW	METER
BFP	BACKFLOW PRE	VENTOR
$\overline{}$	PIPE GUIDE / PIF	PF ANCHOR
	WALL SLEEVE	
	_	
EXP	EXPANSION JOIN	
С — 	ELBOW TURNING	G DN. / TEE OUTLET TURNING DN.
<u> </u>	ELBOW TURNING	G UP / TEE OUTLET TURNING UP
[PIPE END CAPPE	ED
J	RUNNING TRAP	
w	HEAT TRACE	
-	FLOW ARROW	
2	LINE BREAK	
<u></u>	 SAN	SANITARY DRAIN IN CEILING SPACE
		SANITARY DRAIN BELOW SLAB
		SANITARY DRAIN - PUMPED INDIRECT DRAIN
	-V	
		STORM DRAIN - SUSPENDED FROM CEILING STORM DRAIN - BURIED (BELOW FLOOR)
		STORM DRAIN - PUMPED
		DOMESTIC COLD WATER DOMESTIC HOT WATER
	60	DOMESTIC HOT WATER - HIGH TEMPERATURE DOMESTIC HOT WATER RECIRC - HIGH TEMPERATU
	IR	
		HEATING WATER - SUPPLY HEATING WATER - RETURN
		HEATING WATER - RETURN HEATING WATER - SUPPLY - LOW TEMPERATURE
		HEATING WATER - RETURN - LOW TEMPERATURE CHILLED WATER - SUPPLY
		CHILLED WATER - SUPPLY CHILLED WATER - RETURN
		CONDENSER WATER - SUPPLY
		CONDENSER WATER - RETURN GLYCOL CHILLED WATER - SUPPLY
		GLYCOL HEATING, SUPPLY
		GLYCOL HEATING - SUPPLY GLYCOL HEATING - RETURN
		FUEL OIL - SUPPLY
FOR		
FOV		FUEL OIL - VENT
G		
	-F	FIRE LINE
	PR#	SPRINKLER LINE SPRINKLER LINE - ZONE NOTED
		SPRINKLER LINE - DRY

MECHAN	NICAL LEG	END EXISTING DEVICES ARE TONED:
MAX. AIR (CFM or MIN. AIR (CFM or	· - A I	VAV BOX
MIN. AIIX (CI M OI	ns) <u>00 </u>	
MAX. AIR (CFM or MIN. AIR (CFM or HTG. AIR (CFM or HTG. CAP (MBH or k	I/s) 00 A	VAV BOX WITH HEATING COIL
PRIMARY MAX (CFI	M or I/s) 00	
PRIMARY MIN (CFI HTG. AIR (CFI HTG. CAP (MBH	VI or I/s) 00	FAN POWERED VAV BOX
SIZE LENGTH NECK DIAMET (in X in or mm X n AIR FLOW (CFM or	TER (1m) (00"x00" A)	DIFFUSER, REGISTER OR GRILLE TYPE = Sx, Rx, Ex
LENGTH (in or m	A I	RADIATION OR (RP) RADIANT PANEL
CTE	CONNECT TO EXI	
	PLUMBING FIXTU	(REFER TO SCHEDULE) RE TAG
(XX-#)	RISER TAG	
	'REFER TO KEYNO	DTE' NUMBER
\otimes	'REFER TO DETAIL	L NOTE' NUMBER
DWG. M-XXX	DENOTES MATCH	LINE
DWG. M-XXX	DENOTES CROSS	SECTION DETAIL CALL OUT
# (XXXXXXXXXXXXXXXXXXXXXXXXXXXXXXXXXXXX	DENOTES DETAIL	CALLOUT
CWR DEMO	DENOTES EXISTIN	NG EQUIPMENT, DUCT TO BE 'REMOVED' NG PIPE TO BE 'REMOVED' NG EQUIPMENT TO BE 'REMOVED' NG EQUIPMENT, PIPE, DUCT TO BE 'RELOCATED'
<u>ra KL IL GI</u>	EX	ISTING
	EXISTING TO REM	IAIN (TONED)
		DOMESTIC COLD WATER - HIGH PRESSURE DOMESTIC HOT WATER - HIGH PRESSURE
— P — P		DOMESTIC HOT WATER RECIRC - HIGH PRESSURE GROUND WATER DRAIN - LINDERGROUND
— — P — — - · GV — — C — RE		GROUND WATER RECIRC - HIGH PRESSURE GROUND WATER DRAIN - UNDERGROUND CONDENSATE DRAIN REFRIGERANT REFRIGERANT - RETURN CONDENSATE - HIGH PRESSURE
— — — — — P — — — ·GV — — C — RE — — — ·RE — — — MP	V-————————————————————————————————————	GROUND WATER DRAIN - UNDERGROUND CONDENSATE DRAIN REFRIGERANT REFRIGERANT - RETURN CONDENSATE - HIGH PRESSURE CONDENSATE - MEDIUM PRESSURE CONDENSATE - LOW PRESSURE
— — — — — — P — — — — ·GV — — — RE — — — RE — — — MP — — — P	F	GROUND WATER DRAIN - UNDERGROUND CONDENSATE DRAIN REFRIGERANT REFRIGERANT - RETURN CONDENSATE - HIGH PRESSURE CONDENSATE - MEDIUM PRESSURE CONDENSATE - LOW PRESSURE CONDENSATE - PUMPED MAKEUP WATER
——————————————————————————————————————	F	GROUND WATER DRAIN - UNDERGROUND CONDENSATE DRAIN REFRIGERANT REFRIGERANT - RETURN CONDENSATE - HIGH PRESSURE CONDENSATE - MEDIUM PRESSURE CONDENSATE - LOW PRESSURE CONDENSATE - PUMPED
——————————————————————————————————————	F	GROUND WATER DRAIN - UNDERGROUND CONDENSATE DRAIN REFRIGERANT REFRIGERANT - RETURN CONDENSATE - HIGH PRESSURE CONDENSATE - MEDIUM PRESSURE CONDENSATE - LOW PRESSURE CONDENSATE - PUMPED MAKEUP WATER STEAM - HIGH PRESSURE
——————————————————————————————————————	F	GROUND WATER DRAIN - UNDERGROUND CONDENSATE DRAIN REFRIGERANT REFRIGERANT - RETURN CONDENSATE - HIGH PRESSURE CONDENSATE - MEDIUM PRESSURE CONDENSATE - LOW PRESSURE CONDENSATE - PUMPED MAKEUP WATER STEAM - HIGH PRESSURE STEAM - MEDIUM PRESSURE STEAM - LOW PRESSURE

MECHANICAL LEGEND		EXISTING DEVICES OP/CL ARE TONED : CO2	
OP/CL	OPEN/CLOSE		
C2	CO2 SENSOR		
AFS	AIR FLOW SENSOR		
MOD	MODULATING		
FAS	FIRE ALARM SYSTEM		
E/S	END SWITCH		
S/S	START/STOP		
E/D	ENABLE/DISABLE		
HH	HIGH HUMIDITY SENSOR		
PD	PRESSURE DIFFERENTIAL		
SD	SMOKE DETECTOR		
FS	FIRE STAT		
FZ	FREEZE STAT		
DI	DIGITAL INPUT	DIGITAL INPUT	
DO	DIGITAL OUTPUT	DIGITAL OUTPUT	
AI	ANALOGUE INPUT		
AO	ANALOGUE OUTPUT		
Т	TEMPERATURE SENSOR		
F	FLOW SENSOR		
P	PRESSURE SENSOR		
H	HUMIDITY SENSOR		

MECHANICAL DRAWING LIST		
DWG. NO.	DRAWING TITLE	
M-001	MECHANICAL LEGEND AND DRAWING LIST, SITE PLAN	
M-002	MECHANICAL SPECIFICATIONS	
DM-100	BELOW GRADE PLUMBING - DEMOLITION PLAN	
DM-101	GROUND FLOOR PLUMBING - DEMOLITION PLAN	
DM-201	GROUND FLOOR FIRE PROTECTION - DEMOLITION PLAN	
DM-301	GROUND FLOOR HVAC - DEMOLITION PLAN	
M-100	BELOW GRADE PLUMBING - NEW PLAN	
M-101	GROUND FLOOR PLUMBING - NEW PLAN	
M-201	GROUND FLOOR FIRE PROTECTION - NEW PLAN	
M-301	GROUND FLOOR HVAC - NEW PLAN	
M-400	ROOF - NEW PLAN	
M-500	MECHANICAL DETAILS	
M-501	MECHANICAL DETAILS	
M-600	MECHANICAL SCHEDULES	





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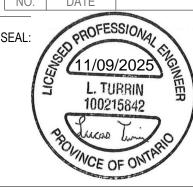
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CHECKED BY:	MS
APPROVED BY:	MS
SCALE:	
DATE:	JUNE.2025

ISSUE DATE:

CONSULTANT PROJECT NO.

5	2025-09-18	IFT
4	2025-07-14	ISSUED FOR PERMIT
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NO	DATE	DECODIDITION





THE REGIONAL MUNICIPALITY OF DURHAM

WORKS DEPARTMENT DESIGN, CONSTRUCTION & ASSET MANAGEMENT

PHASE 2 RENOVATIONS

1635 DUNDAS STREET EAST WHITBY, ONTARIO

MECHANICAL LEGEND, AND DRAWING LIST

PROPERTY NO.
RP-W-42

FACILITY CODE SS-W-02

RFP-1048-2025

FACILITIES PROJECT NO. CONTRACT NO. SS-W-02-23-01



		PIPE CC	NNECTIC	N	
SYMBOL	ITEM	C.W.	H.W.	DRAIN	VENT
WC	WATER CLOSET (FLUSH TANK)	1/2"Ø	-	3"Ø	1-1/2"Ø
WC	WATER CLOSET (FLUSH VALVE)	1"Ø	-	3"Ø	1-1/2"Ø
U	URINAL	3/4"Ø	-	1-1/2"Ø	1-1/4"Ø
SH	SHOWER	1/2"Ø	1/2"Ø	1-1/2"Ø	1-1/4"Ø
LAV	LAVATORY	1/2"Ø	1/2"Ø	1-1/4"Ø	1-1/4"Ø
KS	KITCHEN SINK	1/2"Ø	1/2"Ø	1-1/2"Ø	1-1/4"Ø
MS	MOP SINK	1/2"Ø	1/2"Ø	3"Ø	1-1/2"Ø
DF	DRINKING FOUNTAIN	1/2"Ø	-	1-1/4"Ø	1-1/4"Ø
CW	CLOTHES WASHER	1/2"Ø	1/2"Ø	1-1/2"Ø	2"Ø
DW	DISHWASHER (ROUGH-IN ONLY)	-	1/2"Ø	1-1/2"Ø	1-1/4"Ø
НВ	HOSE BIBB	1/2"Ø	-	-	-
NFHB	NON-FREEZE HOSE BIBB	3/4"Ø	-	-	-
EW	EYE WASH	3/4"Ø	3/4"Ø	1-1/4"Ø	1-1/4"Ø
FD	FLOOR DRAIN	PRIMED	-	2"Ø/3"Ø	1-1/2"Ø
NOTES:					

NOTES:

- ALL SANITARY VENTING TO BE INSTALLED IN ACCORDANCE WITH LATEST EDITION OF THE

PLUMBING FIXTURE SCHEDULE





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DESIGN, CONSTRUCTION &
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PHASE 2 RENOVATIONS

1635 DUNDAS STREET EAST WHITBY, ONTARIO

SHEET TITLE:

MECHANICAL SPECIFICATIONS

PROPERTY NO.
RP-W-42


FACILITY CODE SS-W-02

FACILITIES PROJECT NO. SS-W-02-23-01

D. CONTRACT NO. RFP-1048-2025

SHEET NO.

OBC.
- ALL FLOOR DRAINS & HUB DRAINS SHALL BE TRAPPED, VENTED AND PRIMED BELOW FLOOR.

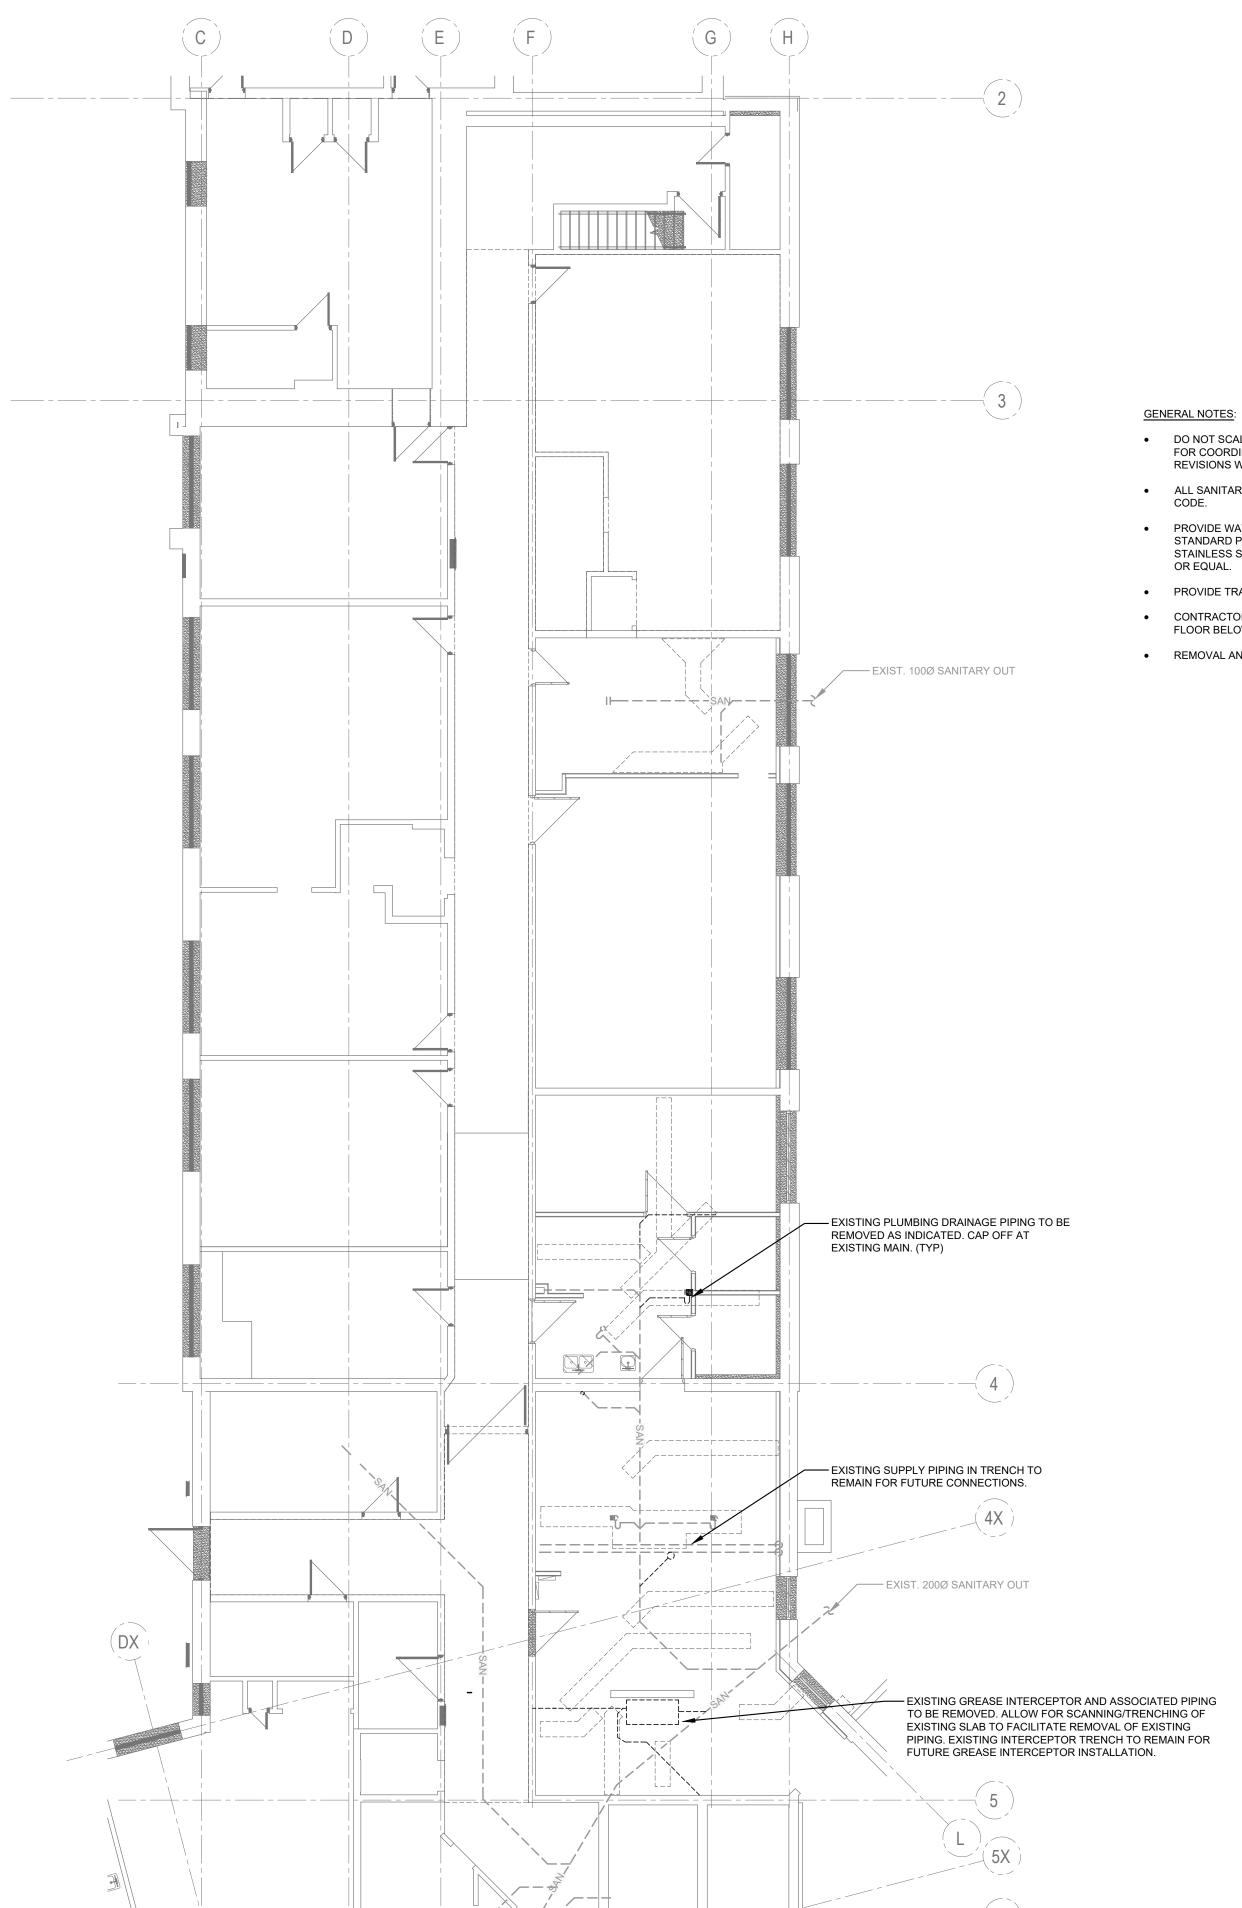

- DO NOT SCALE DRAWINGS. LOCATIONS OF ITEMS ARE APPROXIMATE AND ARE INTENDED TO BE USED FOR COORDINATION. EXACT LOCATIONS ARE DEPENDANT UPON SITE CONDITIONS. REVIEW ANY
- ALL SANITARY VENTING SHALL BE SIZED AND INSTALLED IN ACCORDANCE WITH THE ONTARIO BUILDING
- PROVIDE WATER HAMMER ARRESTORS IN ACCORDANCE WITH PLUMBING AND DRAINAGE INSTITUTE STANDARD PDI-WH201 AND MANUFACTURER'S INSTRUCTIONS. WATER HAMMER ARRESTORS SHALL BE STAINLESS STEEL CONSTRUCTION WITH NESTING BELLOWS PRECHARGED WITH AIR - WADE `SHOCKSTOP'
- PROVIDE TRAP SEAL PRIMERS FOR ALL TRAPS OF FLOOR DRAINS
- CONTRACTOR TO CONFIRM LOCATION AND CLEARANCE OF BELOW GRADE PIPING IN CEILING SPACE OF FLOOR BELOW. CONTRACTOR SHALL INFORM CONSULTANT OF POSSIBLE INTERFERENCE.
- REMOVAL AND REPLACEMENT OF THE CEILING TILES NOT BY DIVISION 22.





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2025-0012

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PHASE 2 RENOVATIONS

1635 DUNDAS STREET EAST WHITBY, ONTARIO

BELOW GRADE - PLUMBING DEMOLITION PLAN


PROPERTY NO. RP-W-42

FACILITY CODE SS-W-02

FACILITIES PROJECT NO. SS-W-02-23-01

CONTRACT NO. RFP-1048-2025

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PHASE 2 RENOVATIONS

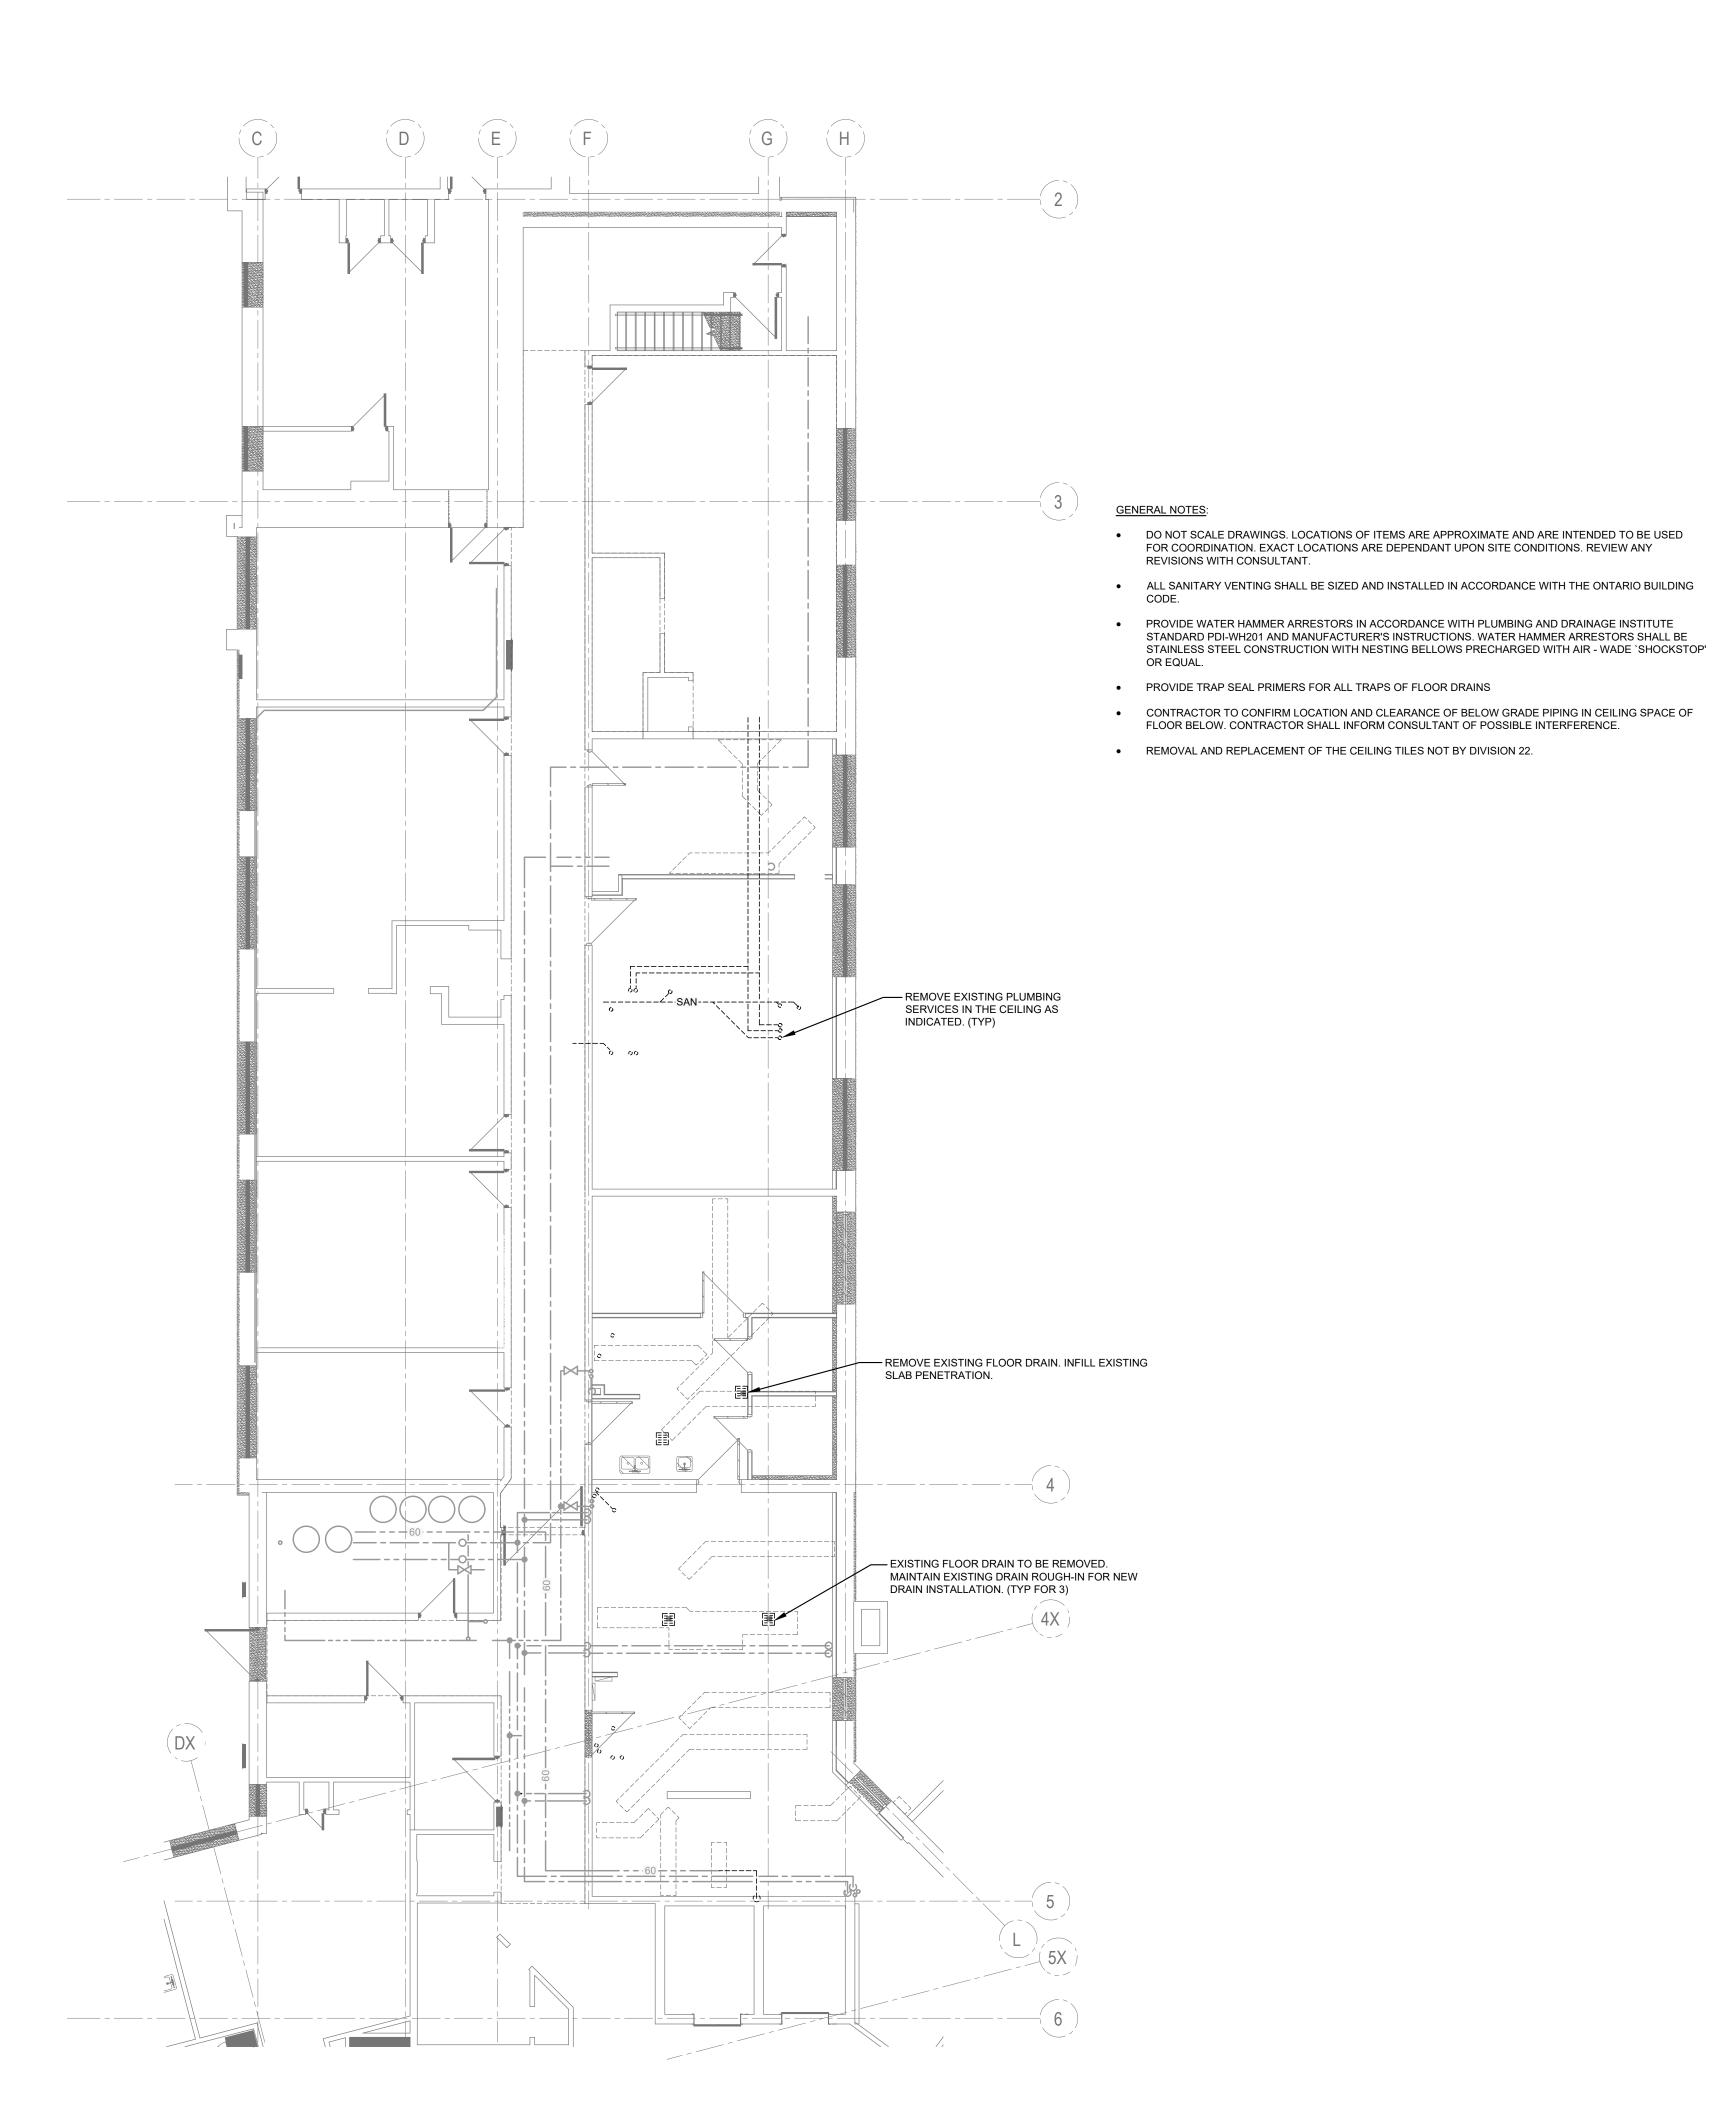1635 DUNDAS STREET EAST WHITBY, ONTARIO

SHEET T

FIRST FLOOR - PLUMBING DEMOLITION PLAN


PROPERTY NO. RP-W-42

FACILITY CODE SS-W-02

FACILITIES PROJECT NO. SS-W-02-23-01

CONTRACT NO.RFP-1048-2025

SHEET NO.

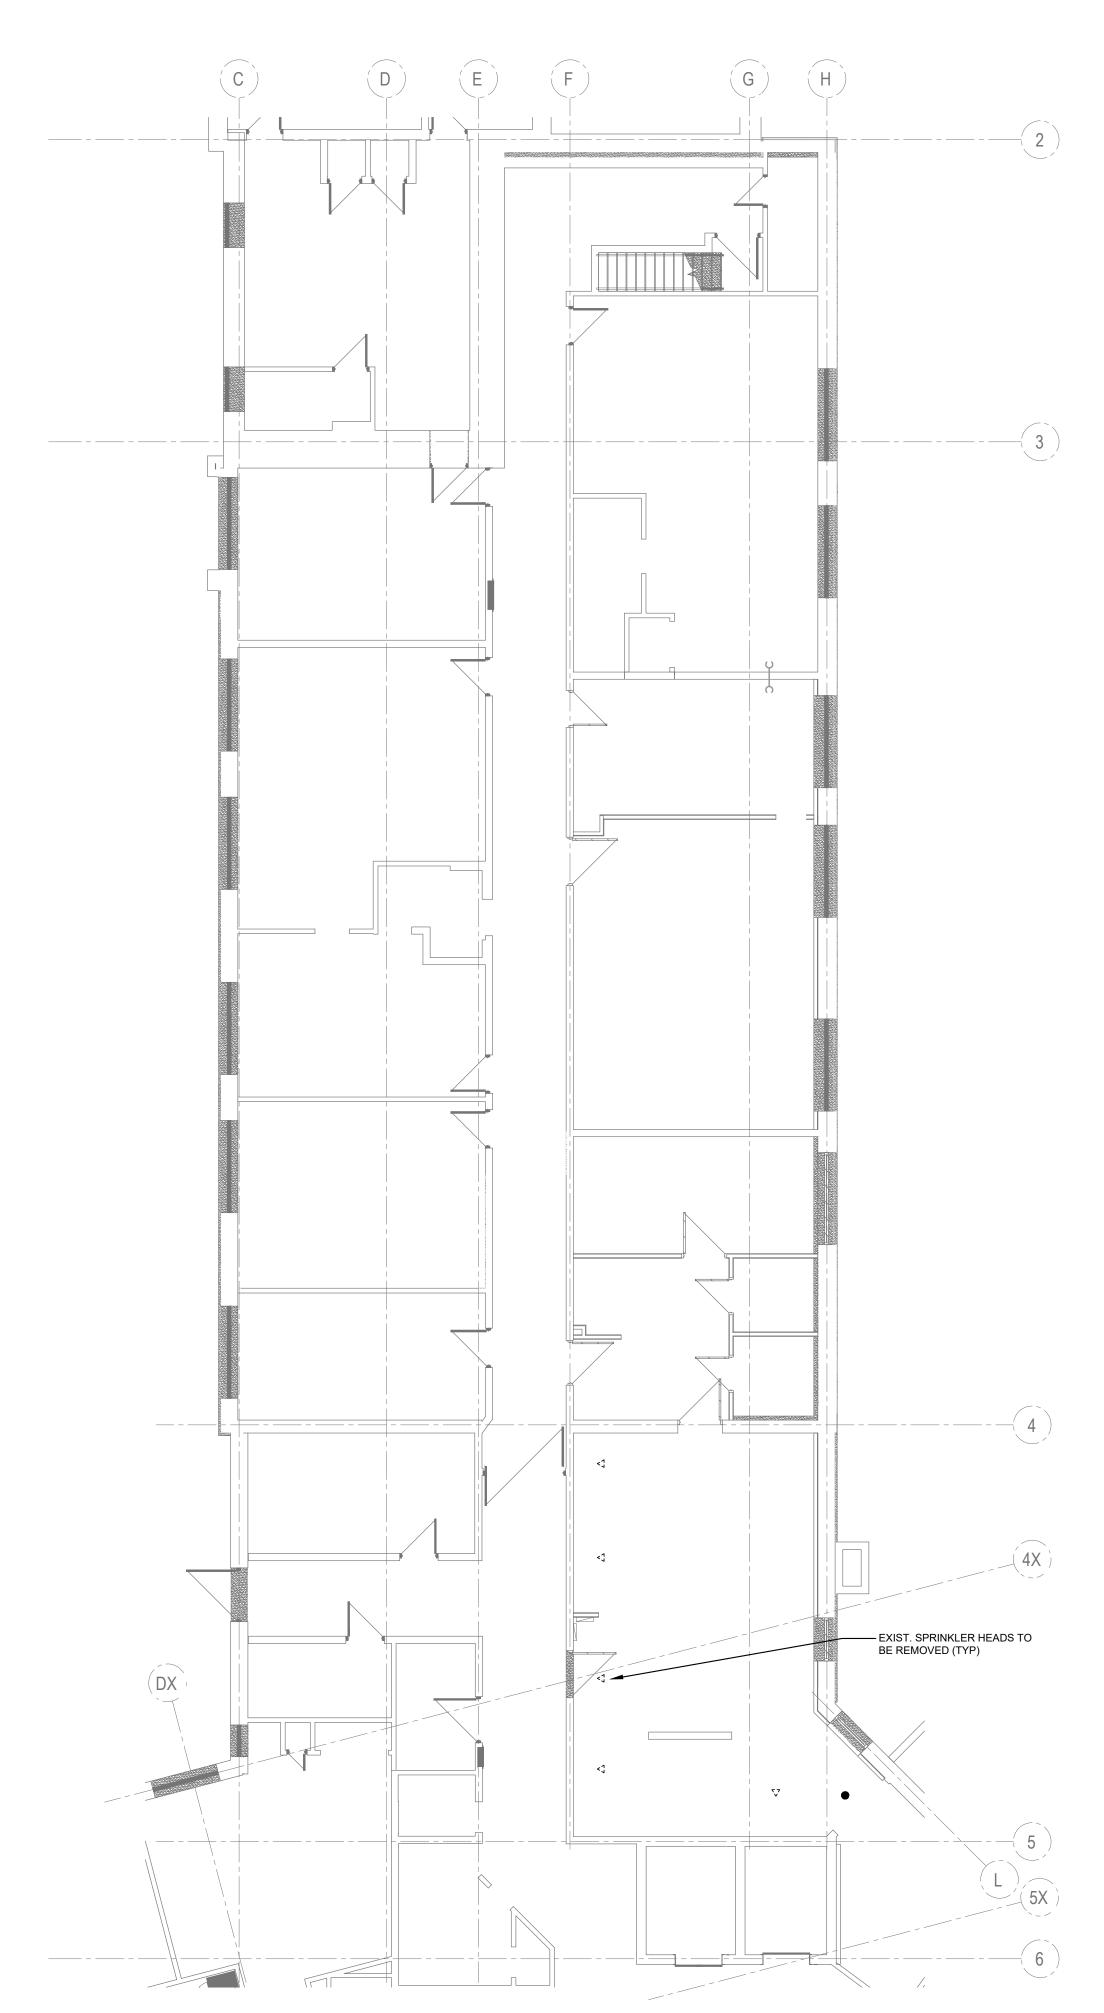

GENERAL NOTES:

- DO NOT SCALE DRAWINGS. LOCATIONS OF ITEMS ARE APPROXIMATE AND ARE INTENDED TO BE
 USED FOR COORDINATION. EXACT LOCATIONS ARE DEPENDANT UPON SITE CONDITIONS. REVIEW ANY
- HEAD LOCATION, HEAD QUANTITY, AND LAYOUT OF SPRINLKER SYSTEM ON DRAWINGS ARE TO ASSIST WITH TENDER PRICING ONLY. IT IS THE RESPONSIBILITY OF THE CONTRACTOR TO ENSURE ADEQUATE HEAD COVERAGE, HEAD QUANTITIES, PIPE SIZING, ZONING, AND VALVING FOR THE EXISTING SYSTEM AS PER NFPA 13 HAZARD OCCUPANCIES, OWNER'S INSURERS' STANDARDS, AND AUTHORITIES HAVING JURISDICTION. INSTALL ADDITIONAL HEADS, VALVES, AND RESIZE PIPING AS REQUIRED AT NO ADDITIONAL COST TO THE OWNER.
- SIZE REDUCTION OF SPRINKLER MAIN SHALL NOT BE ACCEPTED UNLESS APPROVED BY THE CONSULTANT. RE-ROUTING OF SPRINKLER MAIN SHALL BE APPROVED IN ADVANCE BY THE CONSULTANT.
- REMOVAL AND REPLACEMENT OF THE CEILING TILES NOT BY DIVISION 21.





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PHASE 2 RENOVATIONS

1635 DUNDAS STREET EAST WHITBY, ONTARIO

SHEET T

DEMOLITION PLAN - FIRST FLOOR - FIRE PROTECTION


PROPERTY NO.
RP-W-42

FACILITY CODE SS-W-02

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CONTRACT NO.RFP-1048-2025

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THE REGIONAL MUNICIPALITY OF DURHAM

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PHASE 2 RENOVATIONS

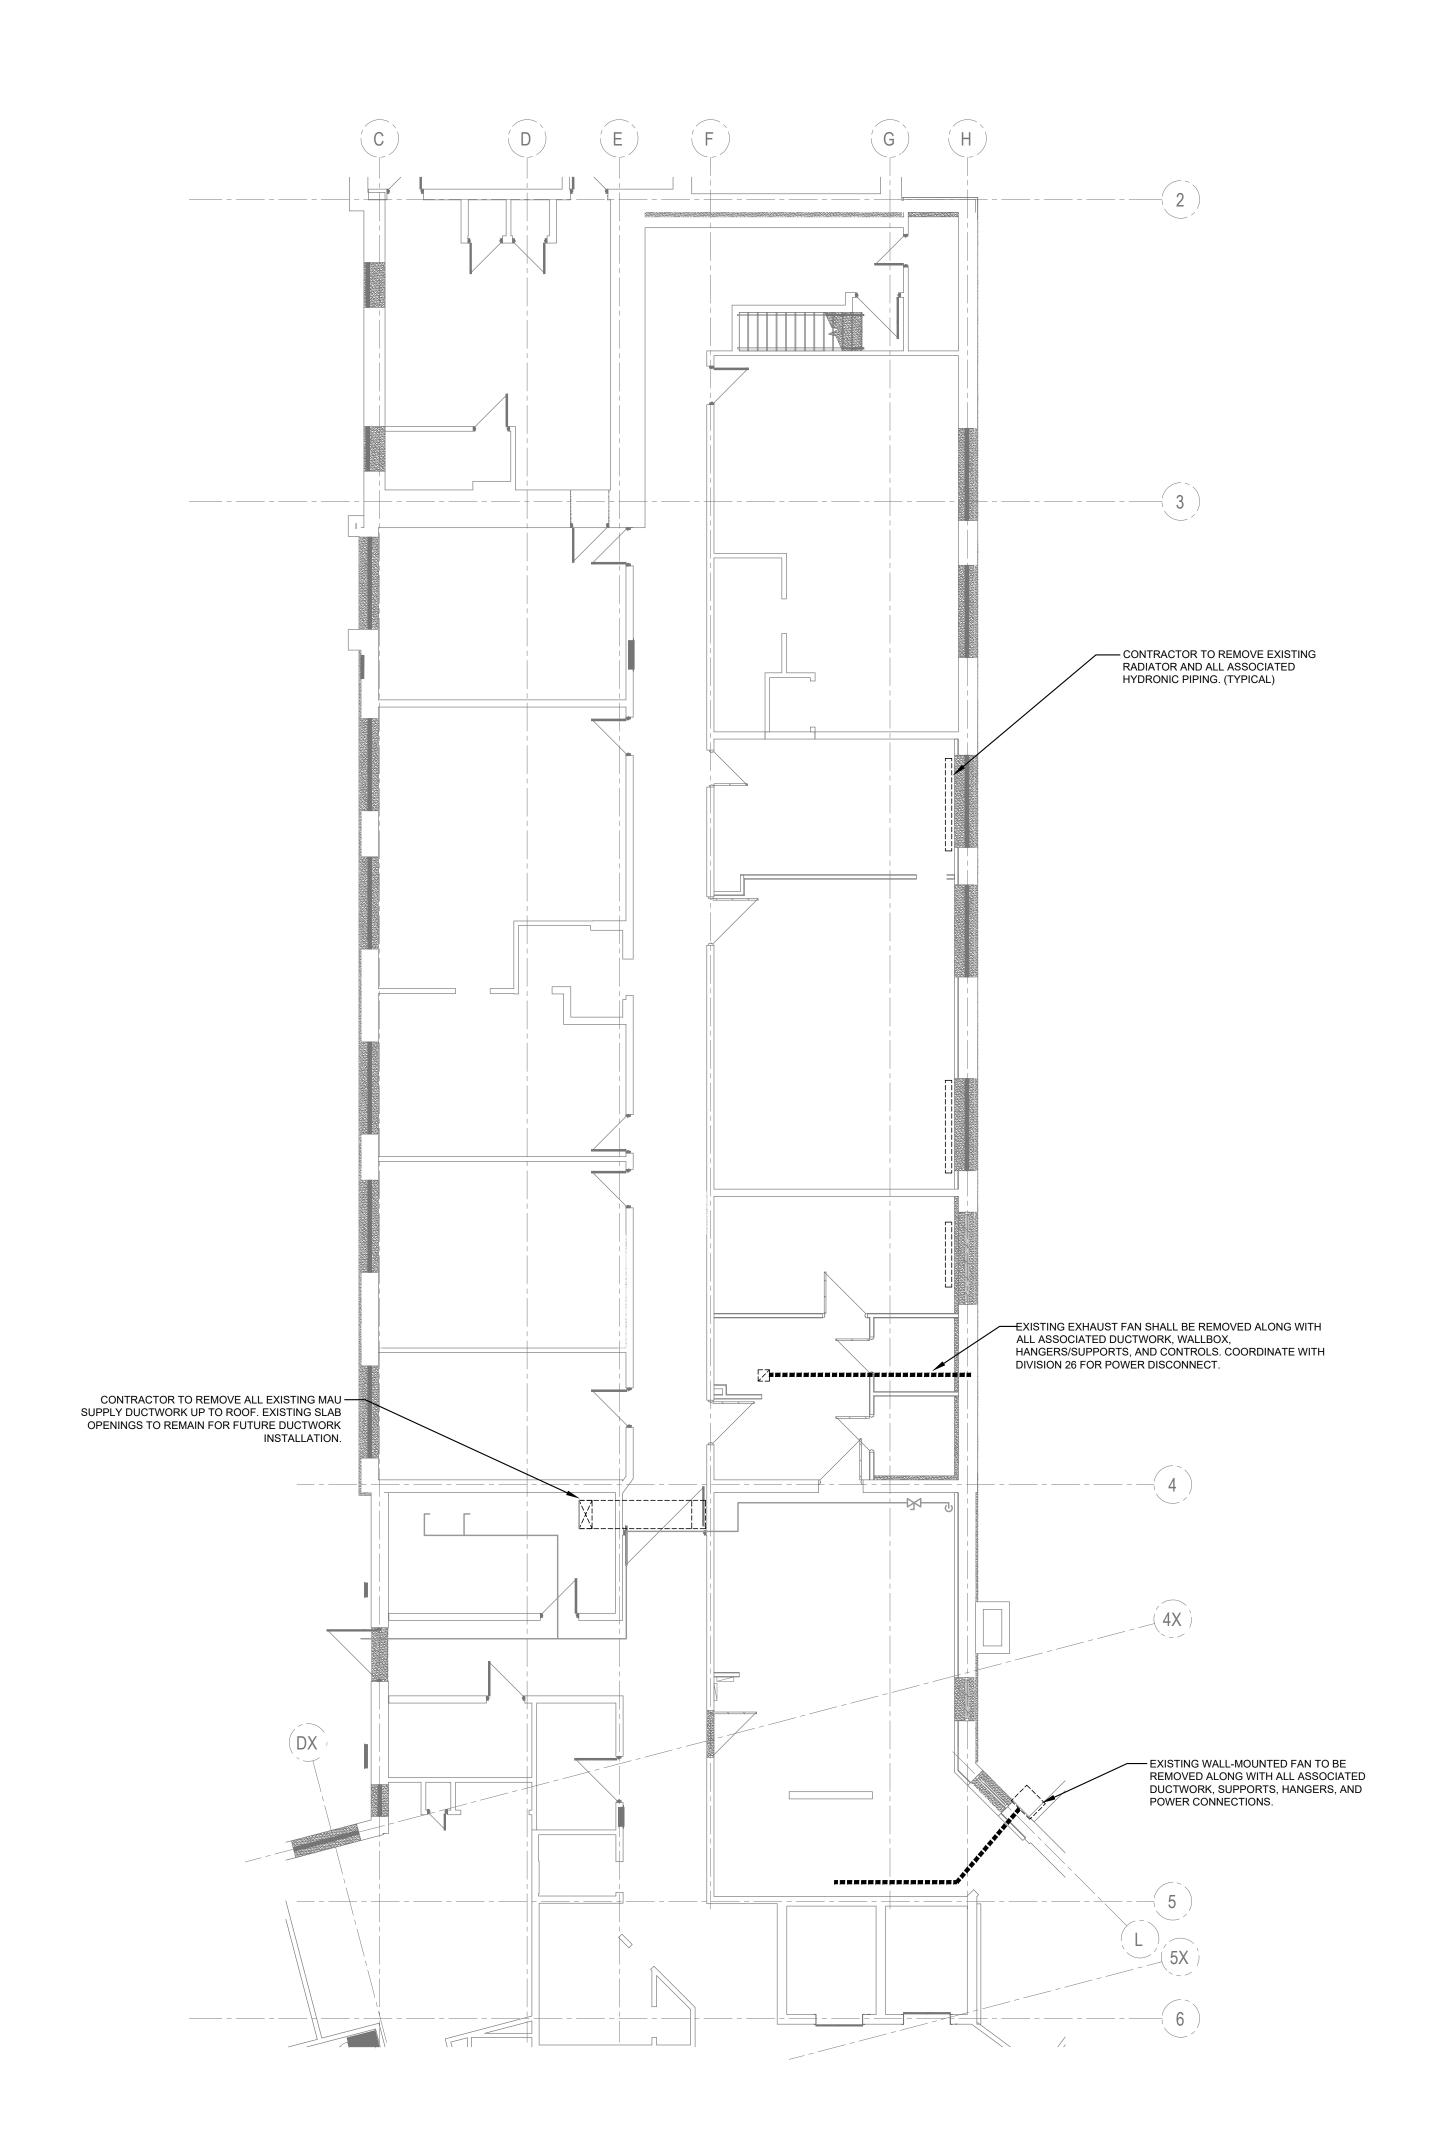1635 DUNDAS STREET EAST WHITBY, ONTARIO

SHEET T

DEMOLITION PLAN - FIRST FLOOR - HVAC


PROPERTY N
RP-W-42

FACILITY CODE SS-W-02

FACILITIES PROJECT NO. SS-W-02-23-01

CONTRACT NO. RFP-1048-2025

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THE REGIONAL MUNICIPALITY OF DURHAM
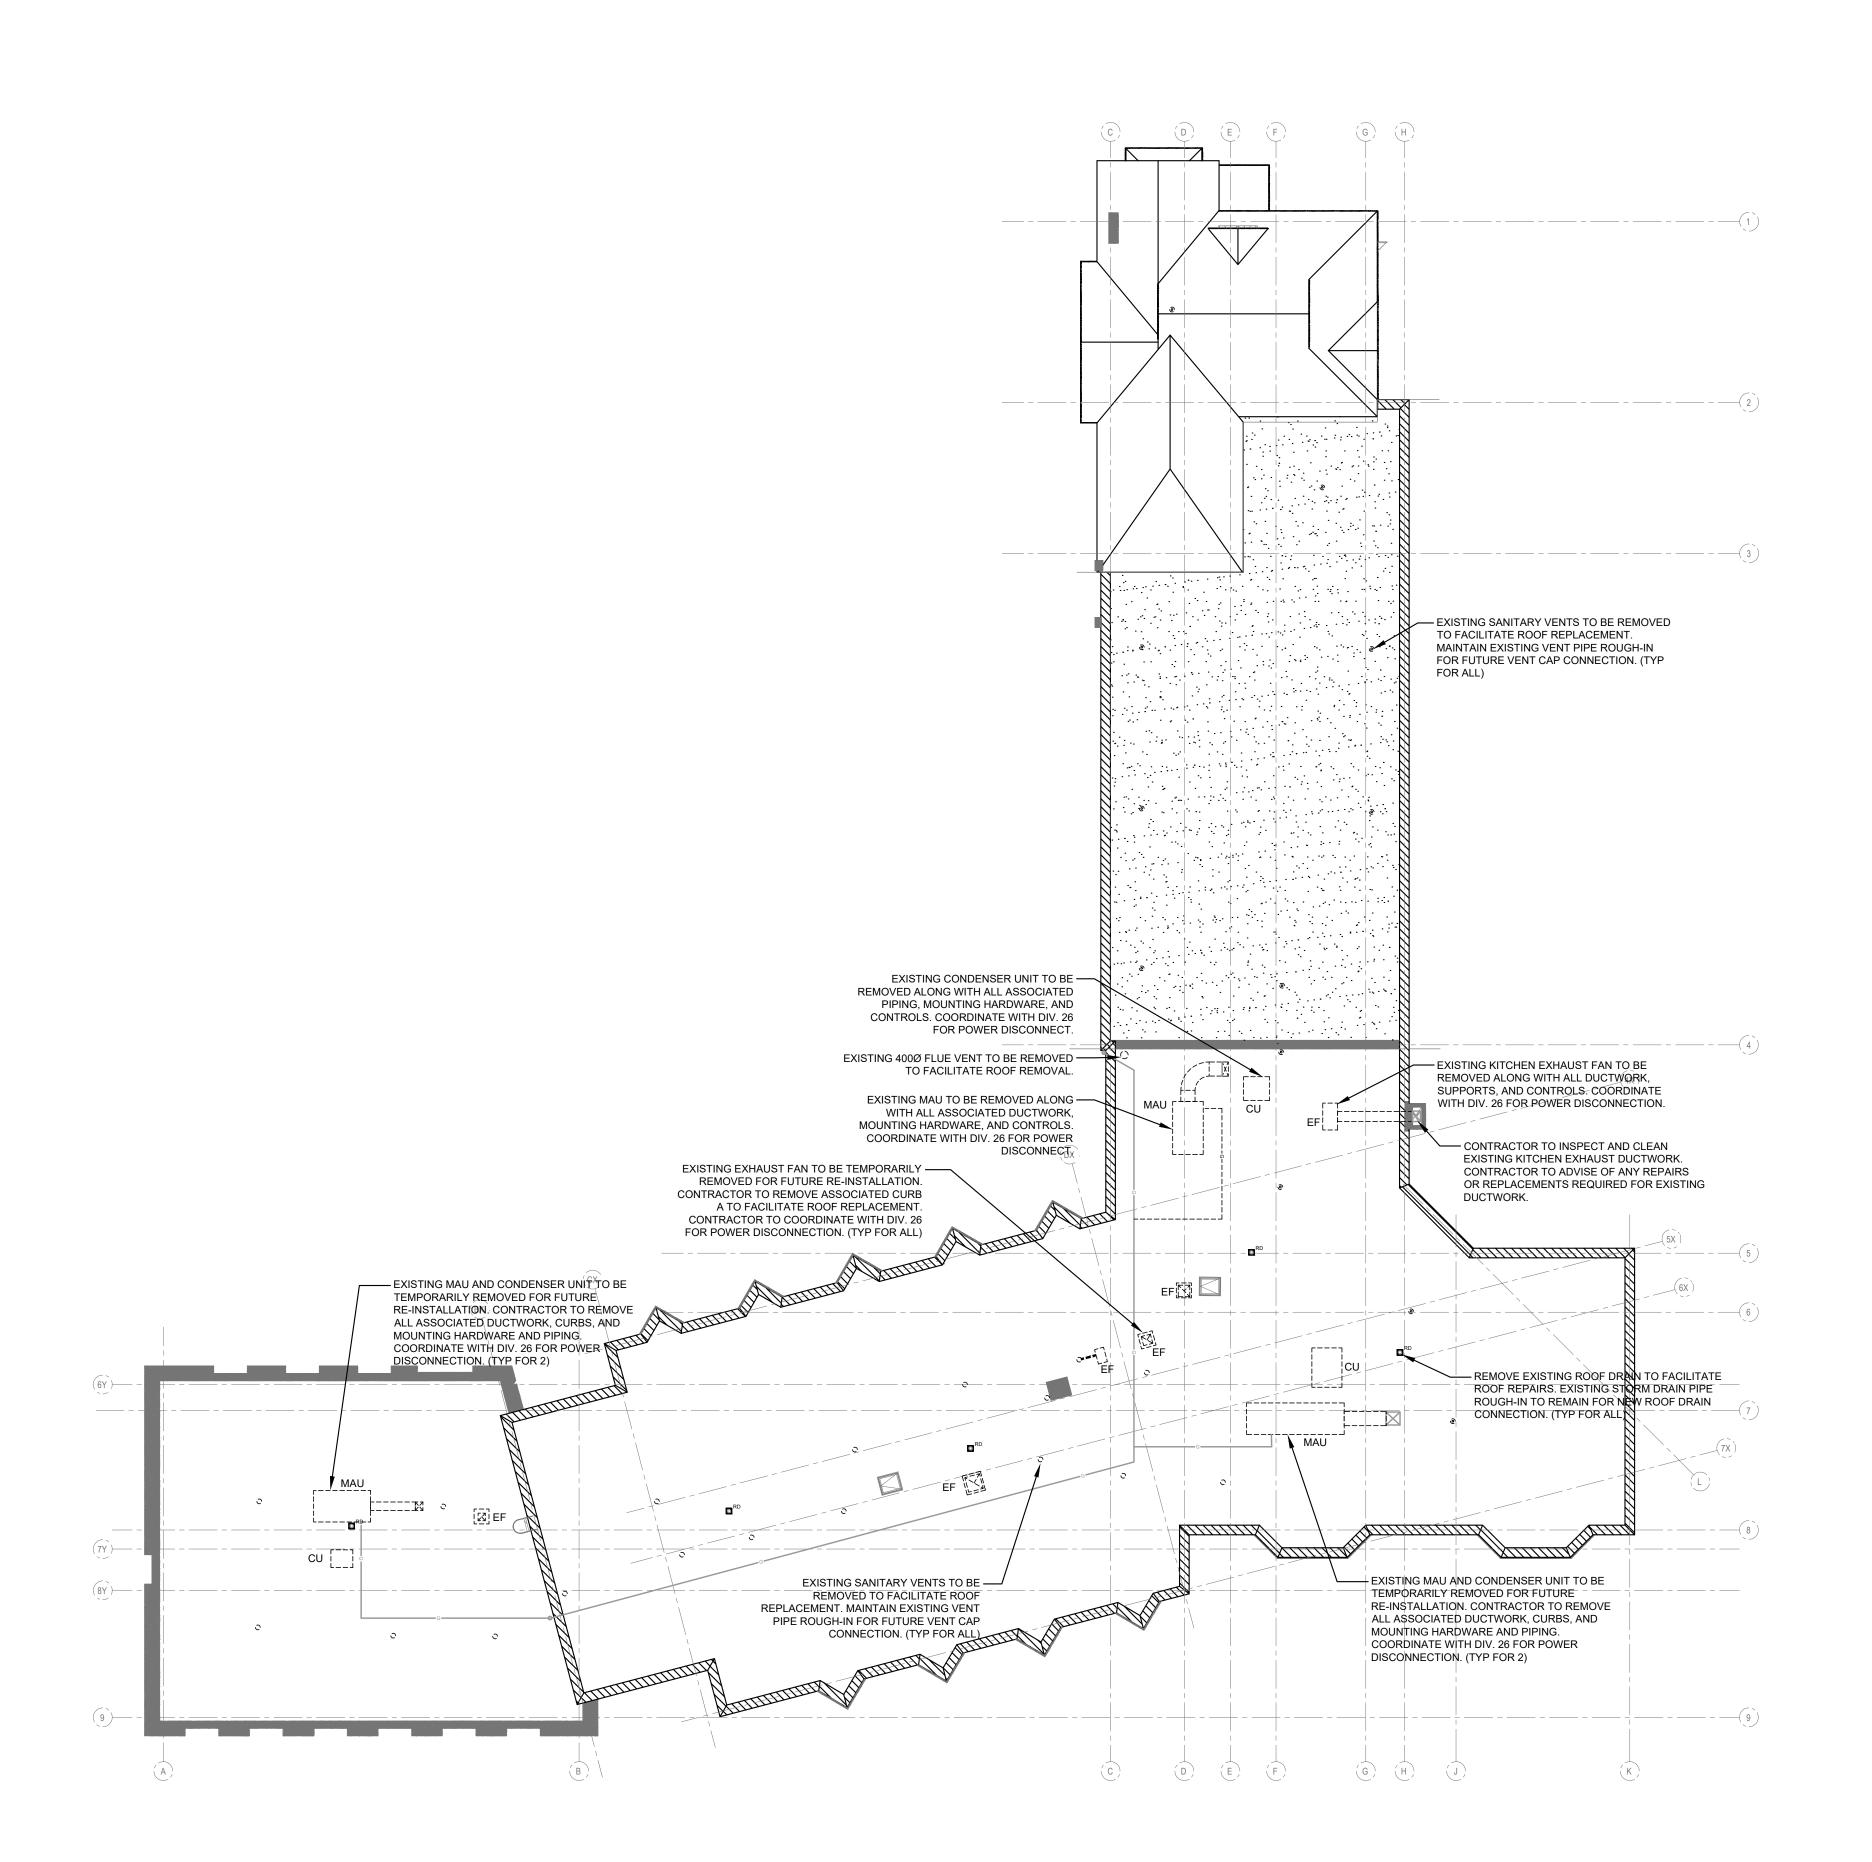
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DESIGN, CONSTRUCTION &
ASSET MANAGEMENT

PROJECT:

PHASE 2 RENOVATIONS

1635 DUNDAS STREET EAST WHITBY, ONTARIO

SHEET TITLE:


ROOF - DEMOLITION PLAN

PROPERTY NO. RP-W-42 SS-W-02

FACILITIES PROJECT NO. SS-W-02-23-01

CONTRACT NO.RFP-1048-2025

SHEET NO.

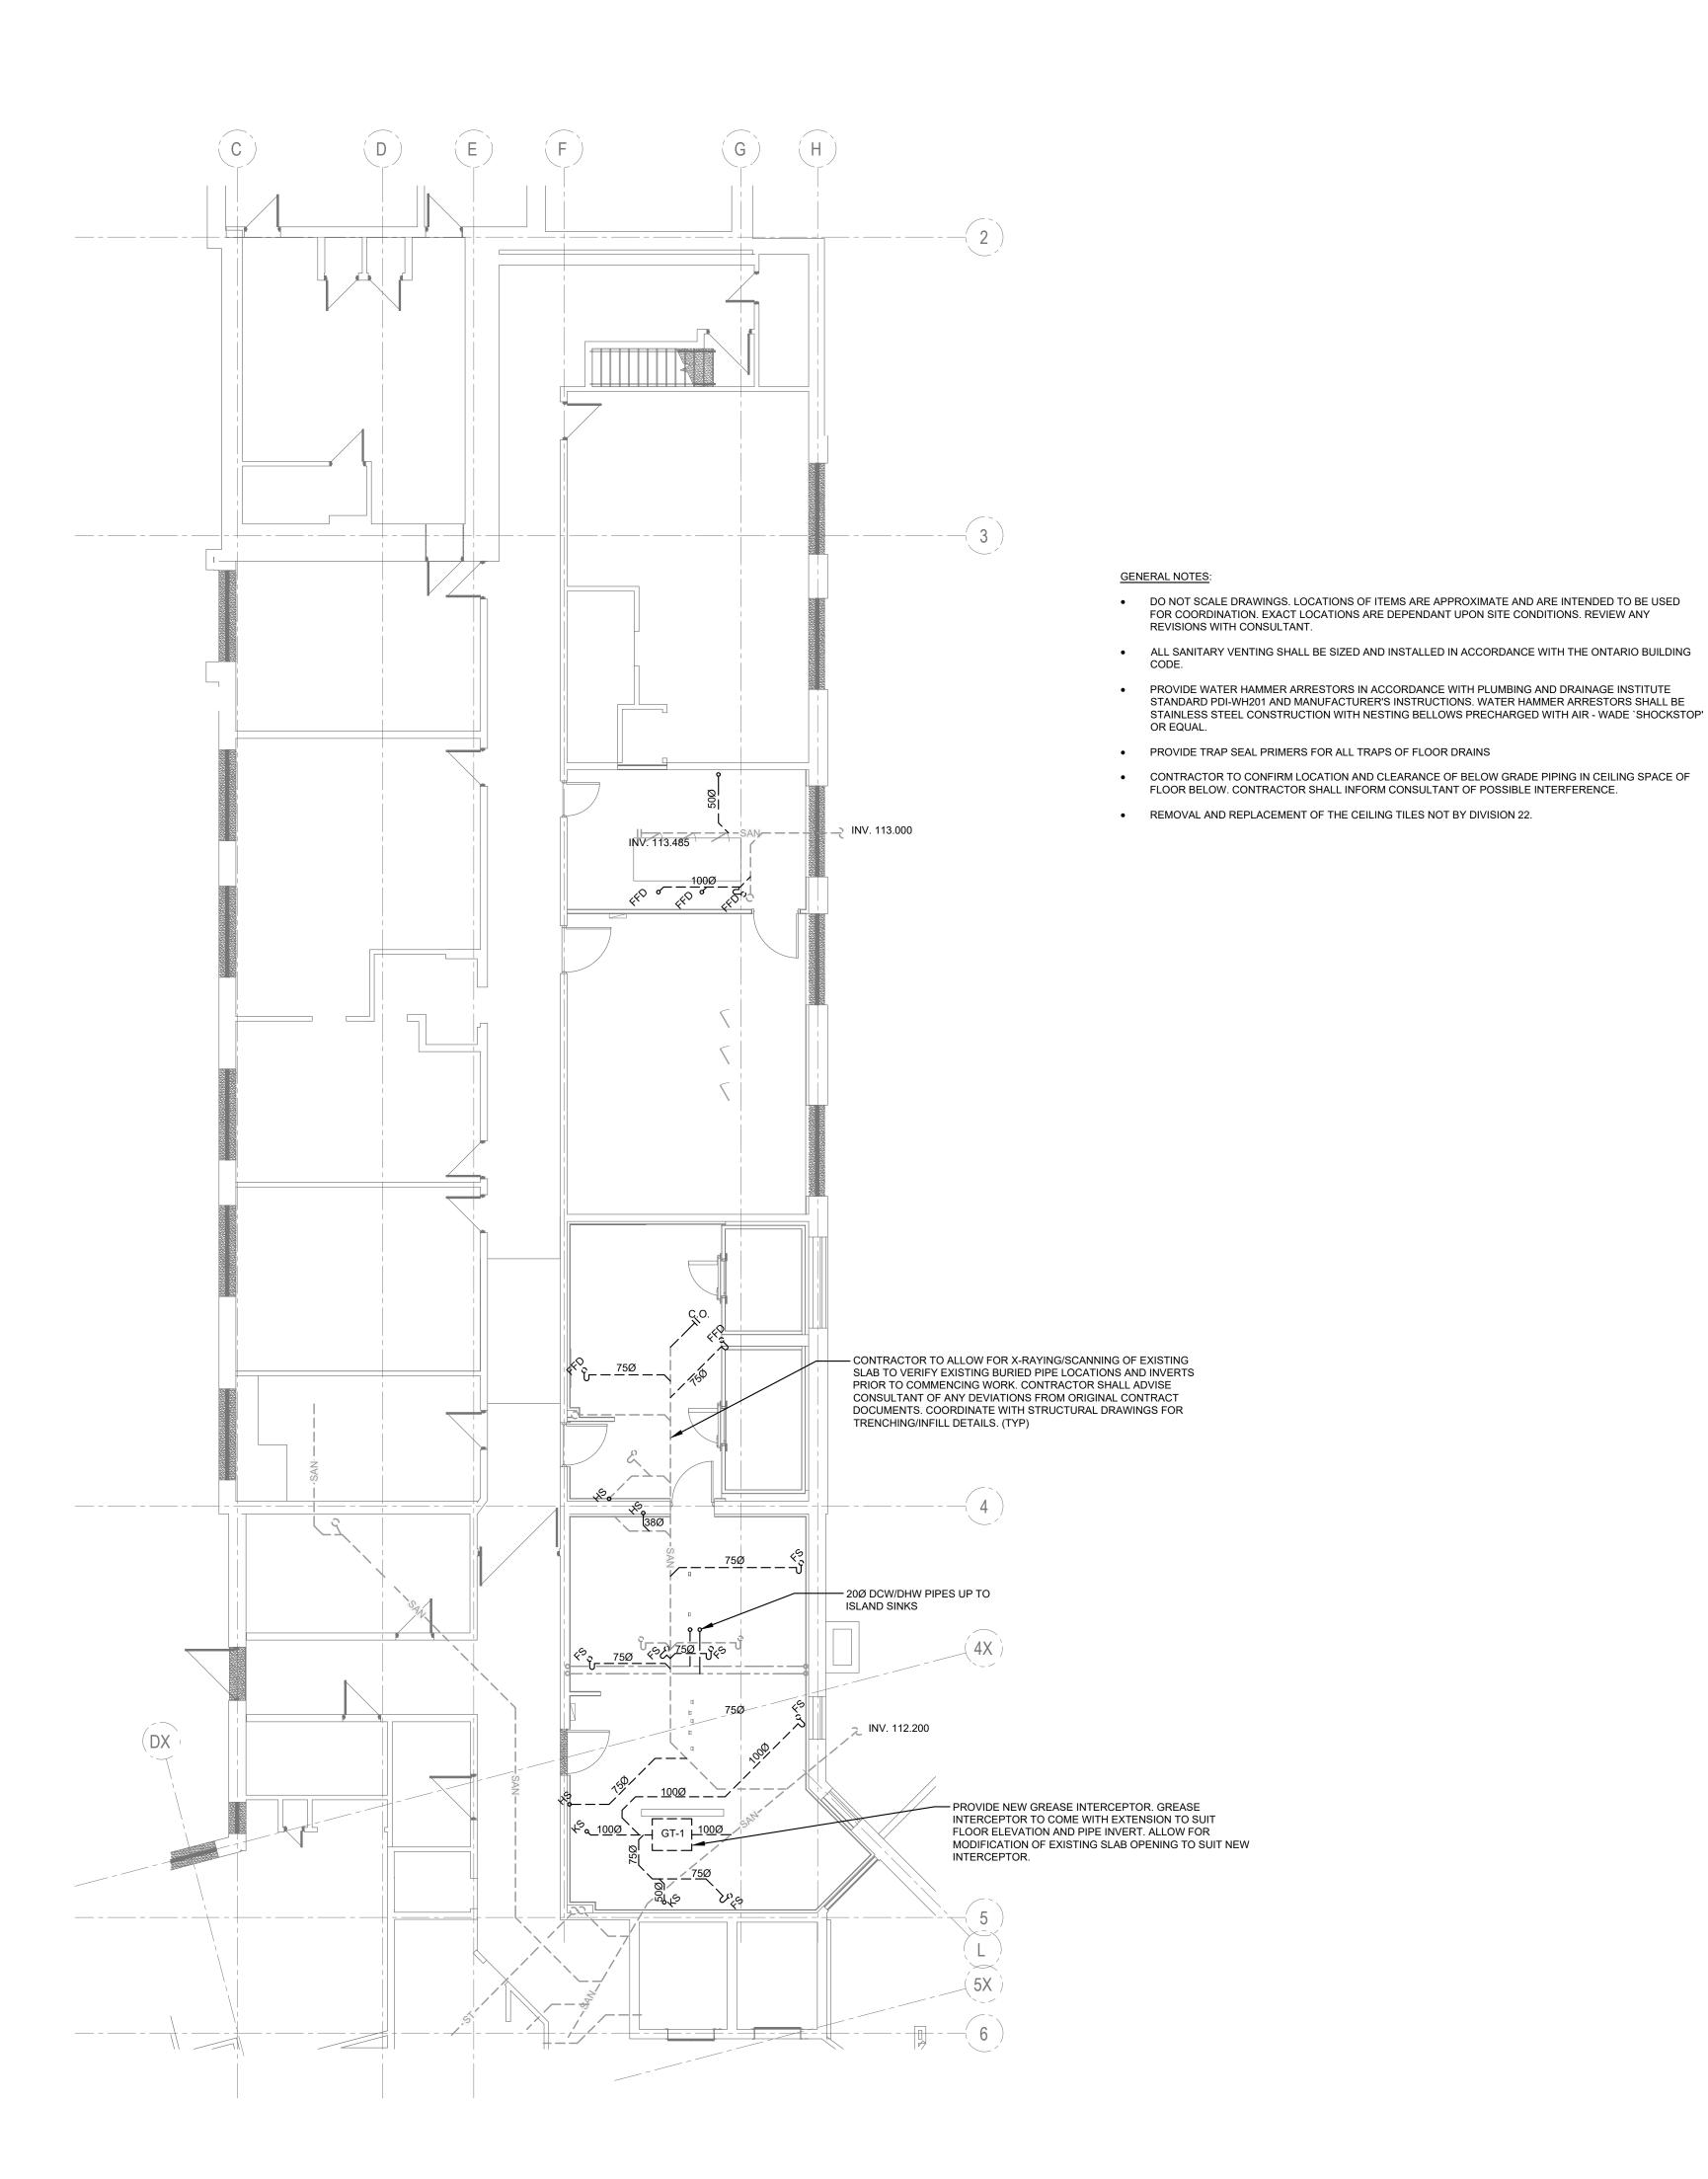





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PHASE 2 RENOVATIONS

1635 DUNDAS STREET EAST WHITBY, ONTARIO

SHEET TITLE:

BELOW GRADE - NEW DRAINAGE PLAN


PROPERTY NO.
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FACILITY CODE SS-W-02

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SHEET NO.



- DO NOT SCALE DRAWINGS. LOCATIONS OF ITEMS ARE APPROXIMATE AND ARE INTENDED TO BE USED FOR COORDINATION. EXACT LOCATIONS ARE DEPENDANT UPON SITE CONDITIONS. REVIEW ANY REVISIONS WITH CONSULTANT.
- ALL SANITARY VENTING SHALL BE SIZED AND INSTALLED IN ACCORDANCE WITH THE ONTARIO BUILDING
- PROVIDE WATER HAMMER ARRESTORS IN ACCORDANCE WITH PLUMBING AND DRAINAGE INSTITUTE STANDARD PDI-WH201 AND MANUFACTURER'S INSTRUCTIONS. WATER HAMMER ARRESTORS SHALL BE STAINLESS STEEL CONSTRUCTION WITH NESTING BELLOWS PRECHARGED WITH AIR - WADE 'SHOCKSTOP'
- PROVIDE TRAP SEAL PRIMERS FOR ALL TRAPS OF FLOOR DRAINS
- CONTRACTOR TO CONFIRM LOCATION AND CLEARANCE OF BELOW GRADE PIPING IN CEILING SPACE OF FLOOR BELOW. CONTRACTOR SHALL INFORM CONSULTANT OF POSSIBLE INTERFERENCE.
- REMOVAL AND REPLACEMENT OF THE CEILING TILES NOT BY DIVISION 22.

PLUMBING FIXTURES AND DRAINS									1110	T	
	FIXTURES BRASS				PIPE CONN.						
SYMBOL	SPECIFICATION	TRIM	SUPPLY PIPES STOPS ETC.	WASTE STRAINER OVERFLOW	TRAP	SUP.	C.W.	H.W.	DR.	VENT	REMARKS
1.	HAND SINK	N	Υ	N	Υ	N	12	12	40	32	
2.	S.S TABLE W/ TWO SINKS	N	Υ	N	N	N	12	12	40	-	INDIRECT DRAIN TO FS
3.	S.S. DISHTABLE W/ THREE SINKS	N	Y	N	N	N	20	20	75	32	DIRECT DRAIN TO GT. PROVIDE SECOND PAIR OF 20Ø DCW/DHW PIPE CONNECTIONS.
4.	S.S. SOILED DISHTABLE SINK	N	Υ	N	N	N	20	20	50	32	DRAIN TO GT.
5.	DISHWASHER	N	Y	N	N	N	20	20	40	-	PROVIDE ROUGH-IN FOR WATER SOFTNER. DRAIN TO GT VIA FS. UNIT SHALL COME WITH DWT KIT.
6.	COMBI-OVEN	N	Υ	N	N	N	20	-	75	-	DRAIN TO GT VIA FS. UNIT SHALL COME WITH DWT KIT.
7.	WATER FILTER	N	Υ	N	N	N	20	-	-	-	
8.	S.S. TABLE W/ SINK	N	Υ	N	N	N	12	12	40	-	DRAIN TO FS.
9.	LAUNDRY SINK (LT-1)	Y	Υ	Υ	Υ	Υ	12	12	40	32	
10.	WASHING MACHINE	N	Υ	N	N	N	20	20	75	-	DRAIN TO FFD

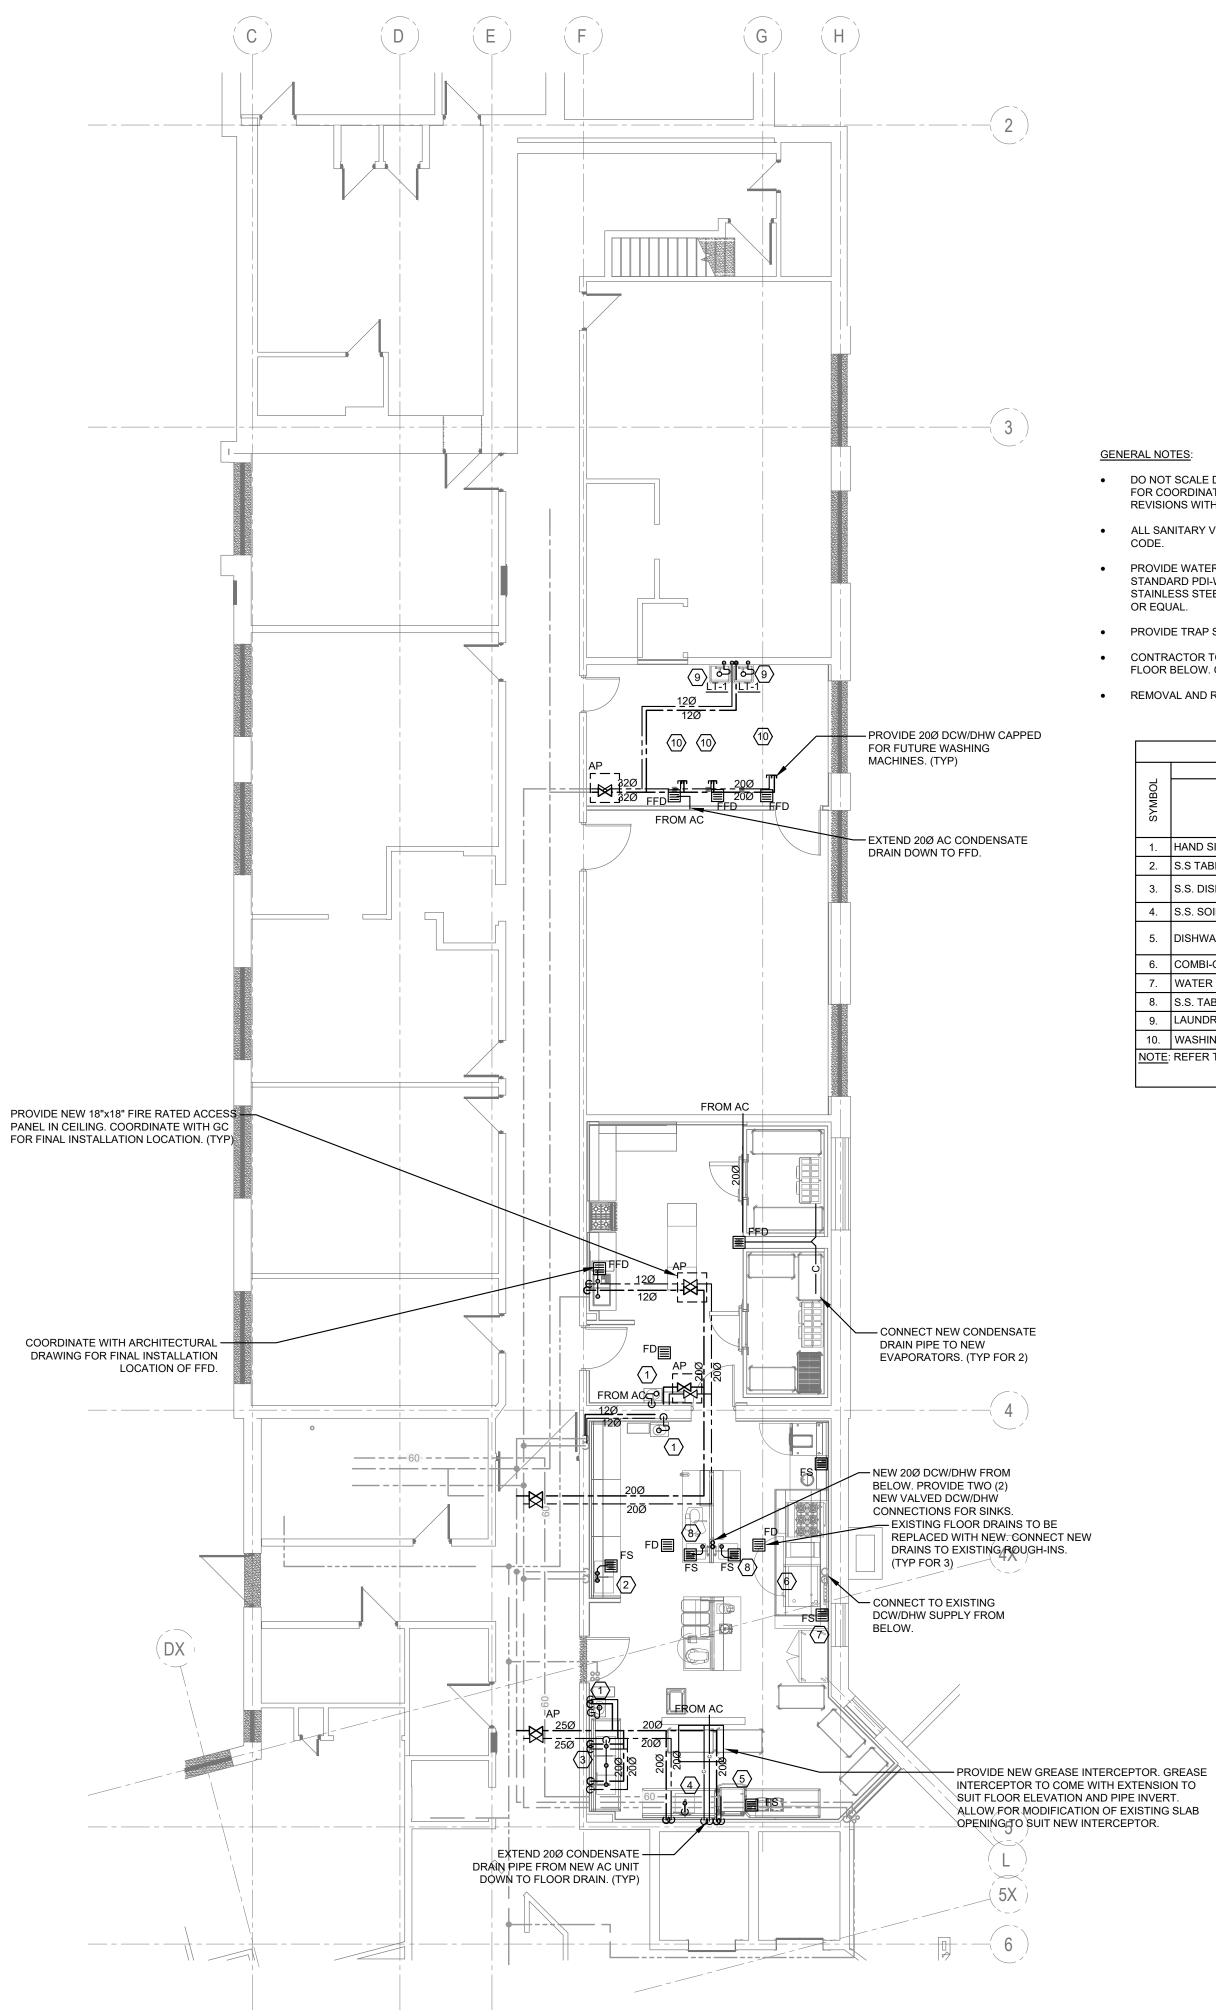



partners

310 Spadina Ave, Suite 100B Toronto, Ontario, Canada M5T 2E8 T: 416 203 7600 F: 416 203 3342 lga-ap.com

DESIGN BY:	НА
DRAWN BY:	НА
CHECKED BY:	MS
APPROVED BY:	MS
SCALE:	1:100
DATE:	JUNE.2025

ISSU	E D	ΑT	Έ:	

CONSULTANT PROJECT NO.

5	2025-09-18	IFT
4	2025-07-14	ISSUED FOR PERMIT
3	2025-06-27	ISSUED FOR PERMIT REVIEW
2	2025-06-11	ISSUED FOR REVIEW
1	2025-06-09	ISSUED FOR COORDINATION
NO.	DATE	DESCRIPTION





THE REGIONAL MUNICIPALITY OF DURHAM

WORKS DEPARTMENT DESIGN, CONSTRUCTION & ASSET MANAGEMENT

PHASE 2 RENOVATIONS

1635 DUNDAS STREET EAST WHITBY, ONTARIO

SHEET TITLE:


FIRST FLOOR - NEW PLUMBING PLAN


PROPERTY NO. RP-W-42

FACILITY CODE SS-W-02

FACILITIES PROJECT NO. SS-W-02-23-01

CONTRACT NO. RFP-1048-2025

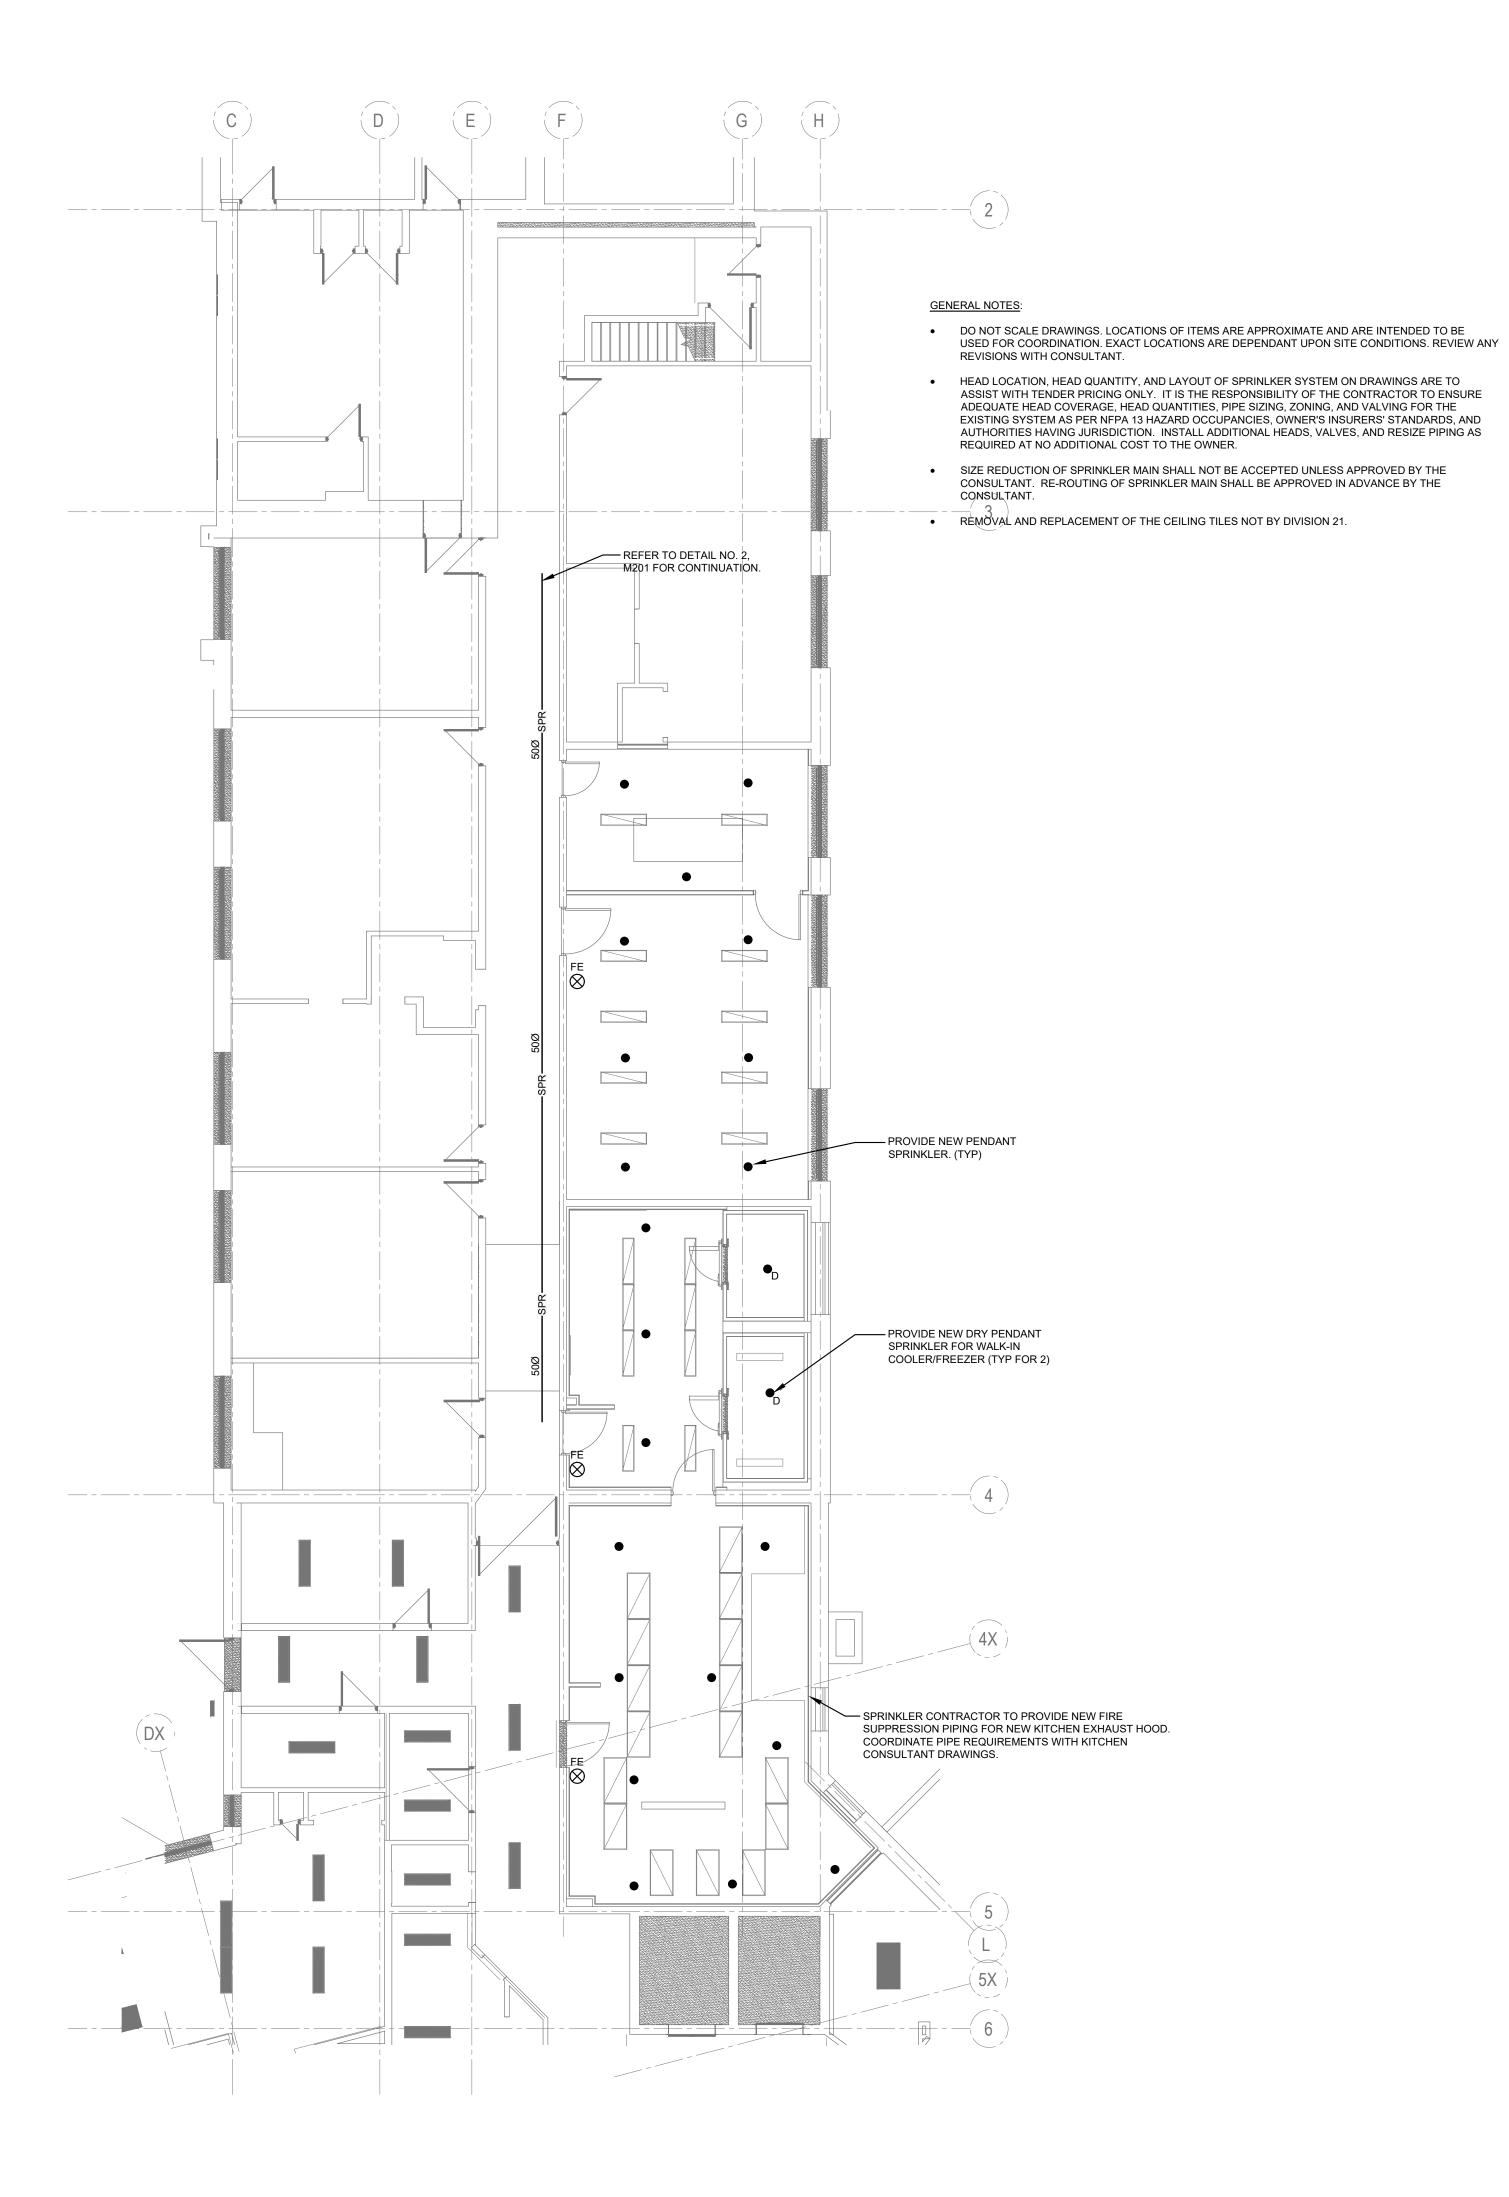

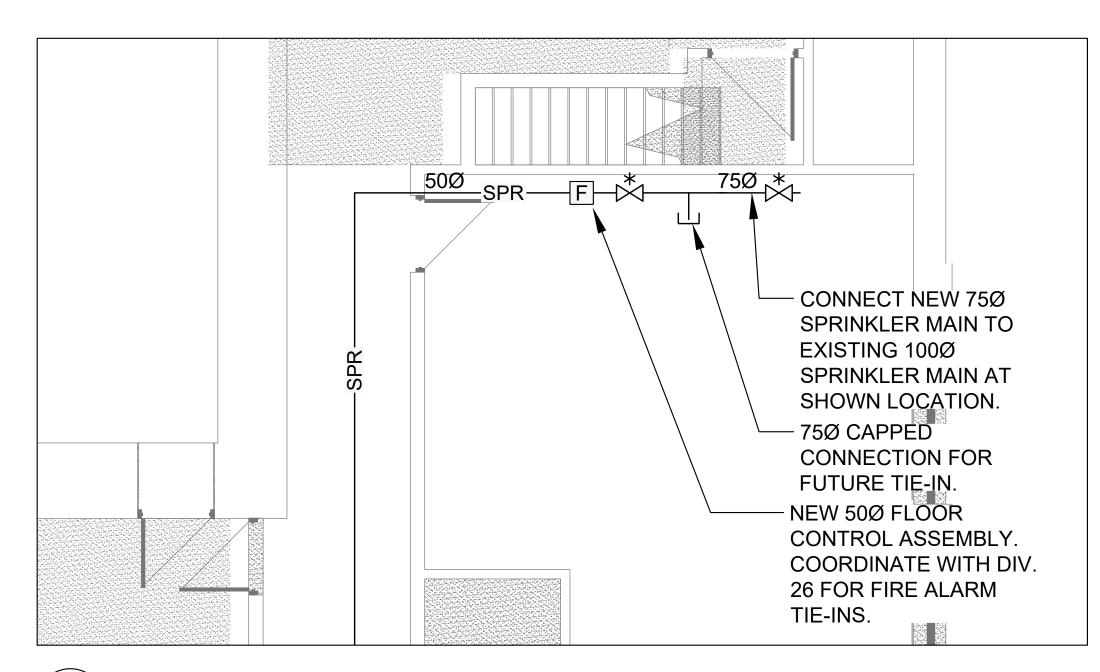

2 NEW SPRINKLER ZONE INSTALLATION

M201 SCALE: 1:50





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THE REGIONAL MUNICIPALITY OF DURHAM

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DESIGN, CONSTRUCTION &
ASSET MANAGEMENT

PROJ

PHASE 2 RENOVATIONS

1635 DUNDAS STREET EAST WHITBY, ONTARIO

SHEET T

FIRST FLOOR - FIRE PROTECTION NEW


PROPERTY NO.
RP-W-42


SS-W-02

SS-W-02-23-01 CONTRACT NO. RFP-1048-202

02-23-01 RFP-1048-2025

SHEET NO.

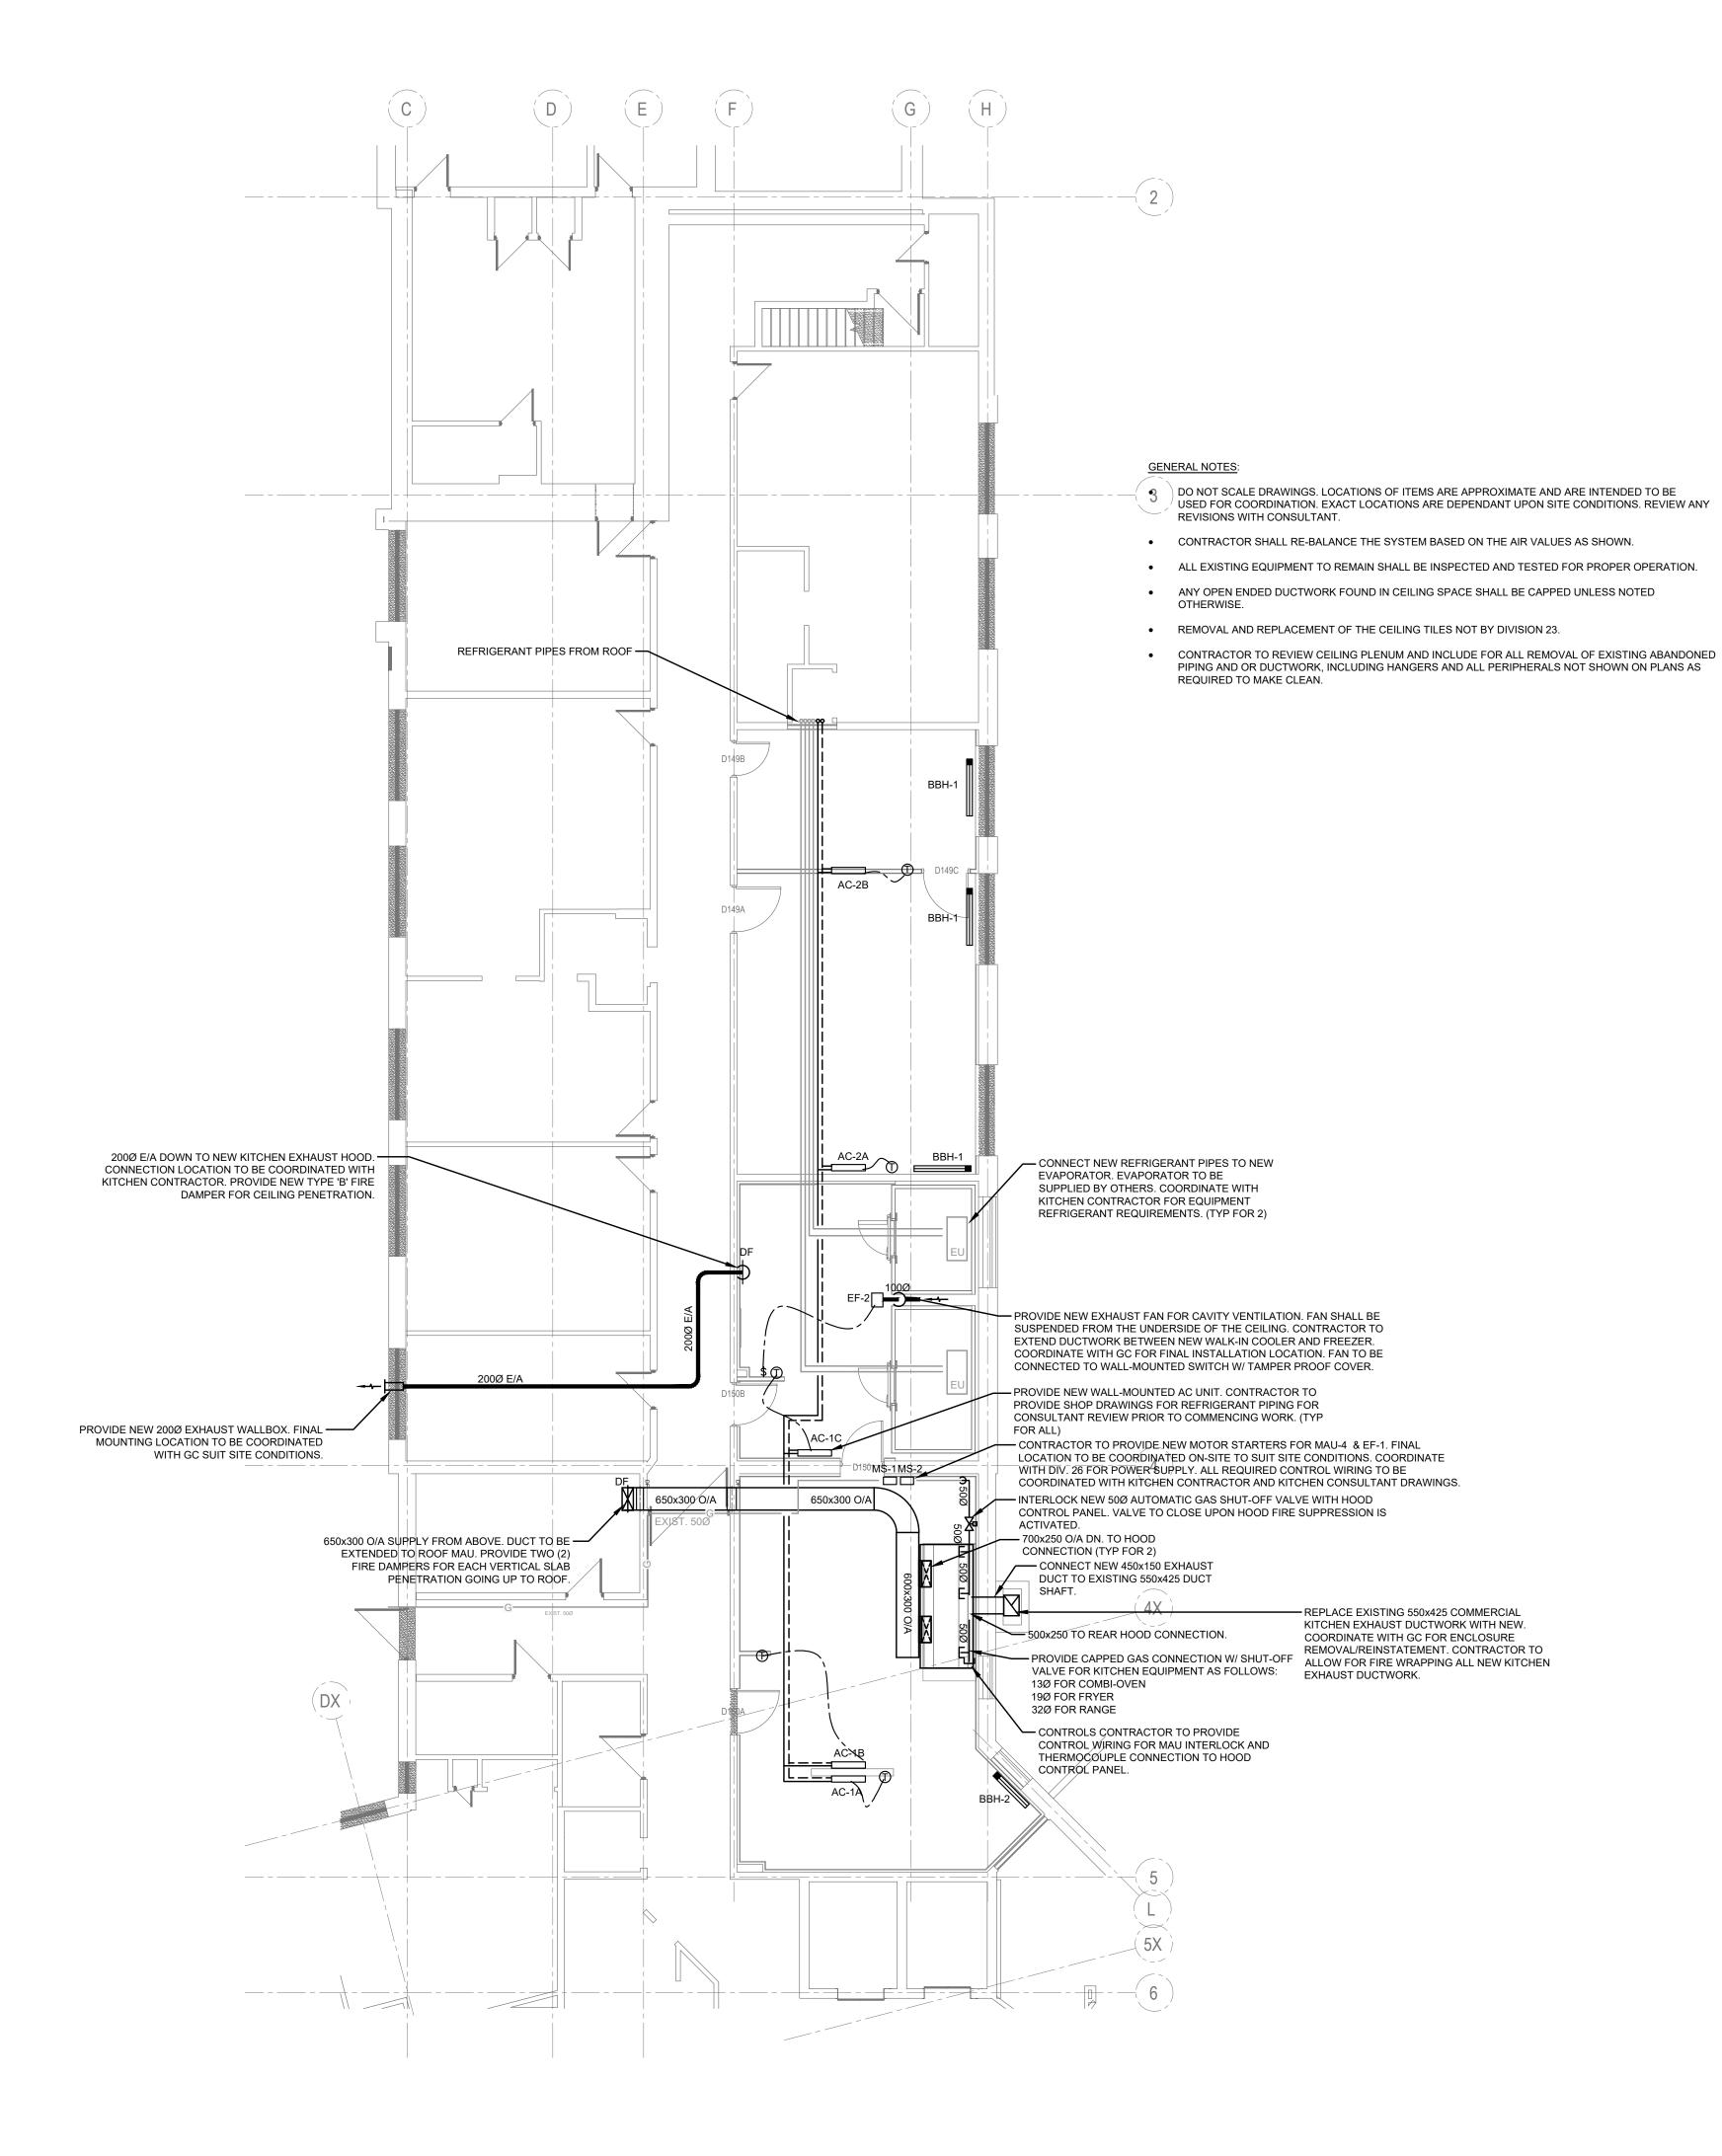

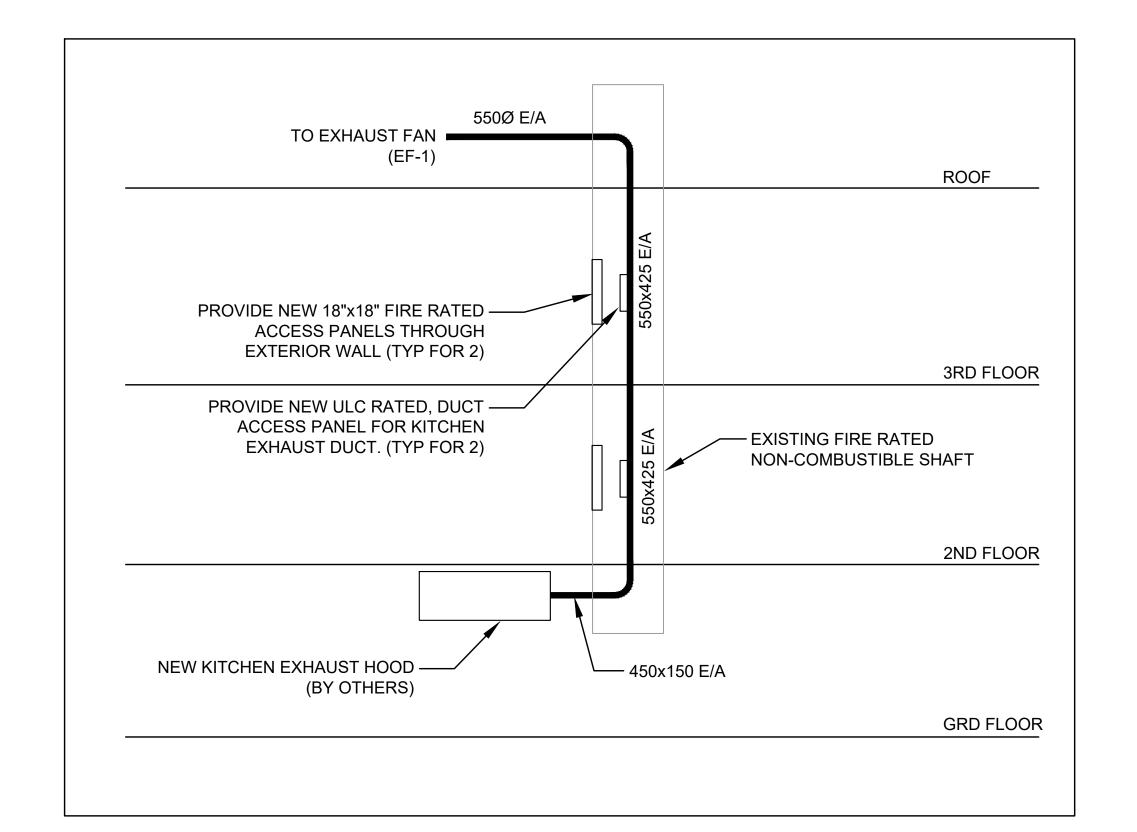

COMMERCIAL KITCHEN EXHAUST DUCTWORK SCHEMATIC M-301 / SCALE: N.T.S.





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WORKS DEPARTMENT DESIGN, CONSTRUCTION & ASSET MANAGEMENT

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1635 DUNDAS STREET EAST WHITBY, ONTARIO

SHEET TITLE:


FIRST FLOOR - HVAC NEW

PROPERTY NO.
RP-W-42

FACILITY CODE SS-W-02

RFP-1048-2025

FACILITIES PROJECT NO. | CONTRACT NO. SS-W-02-23-01

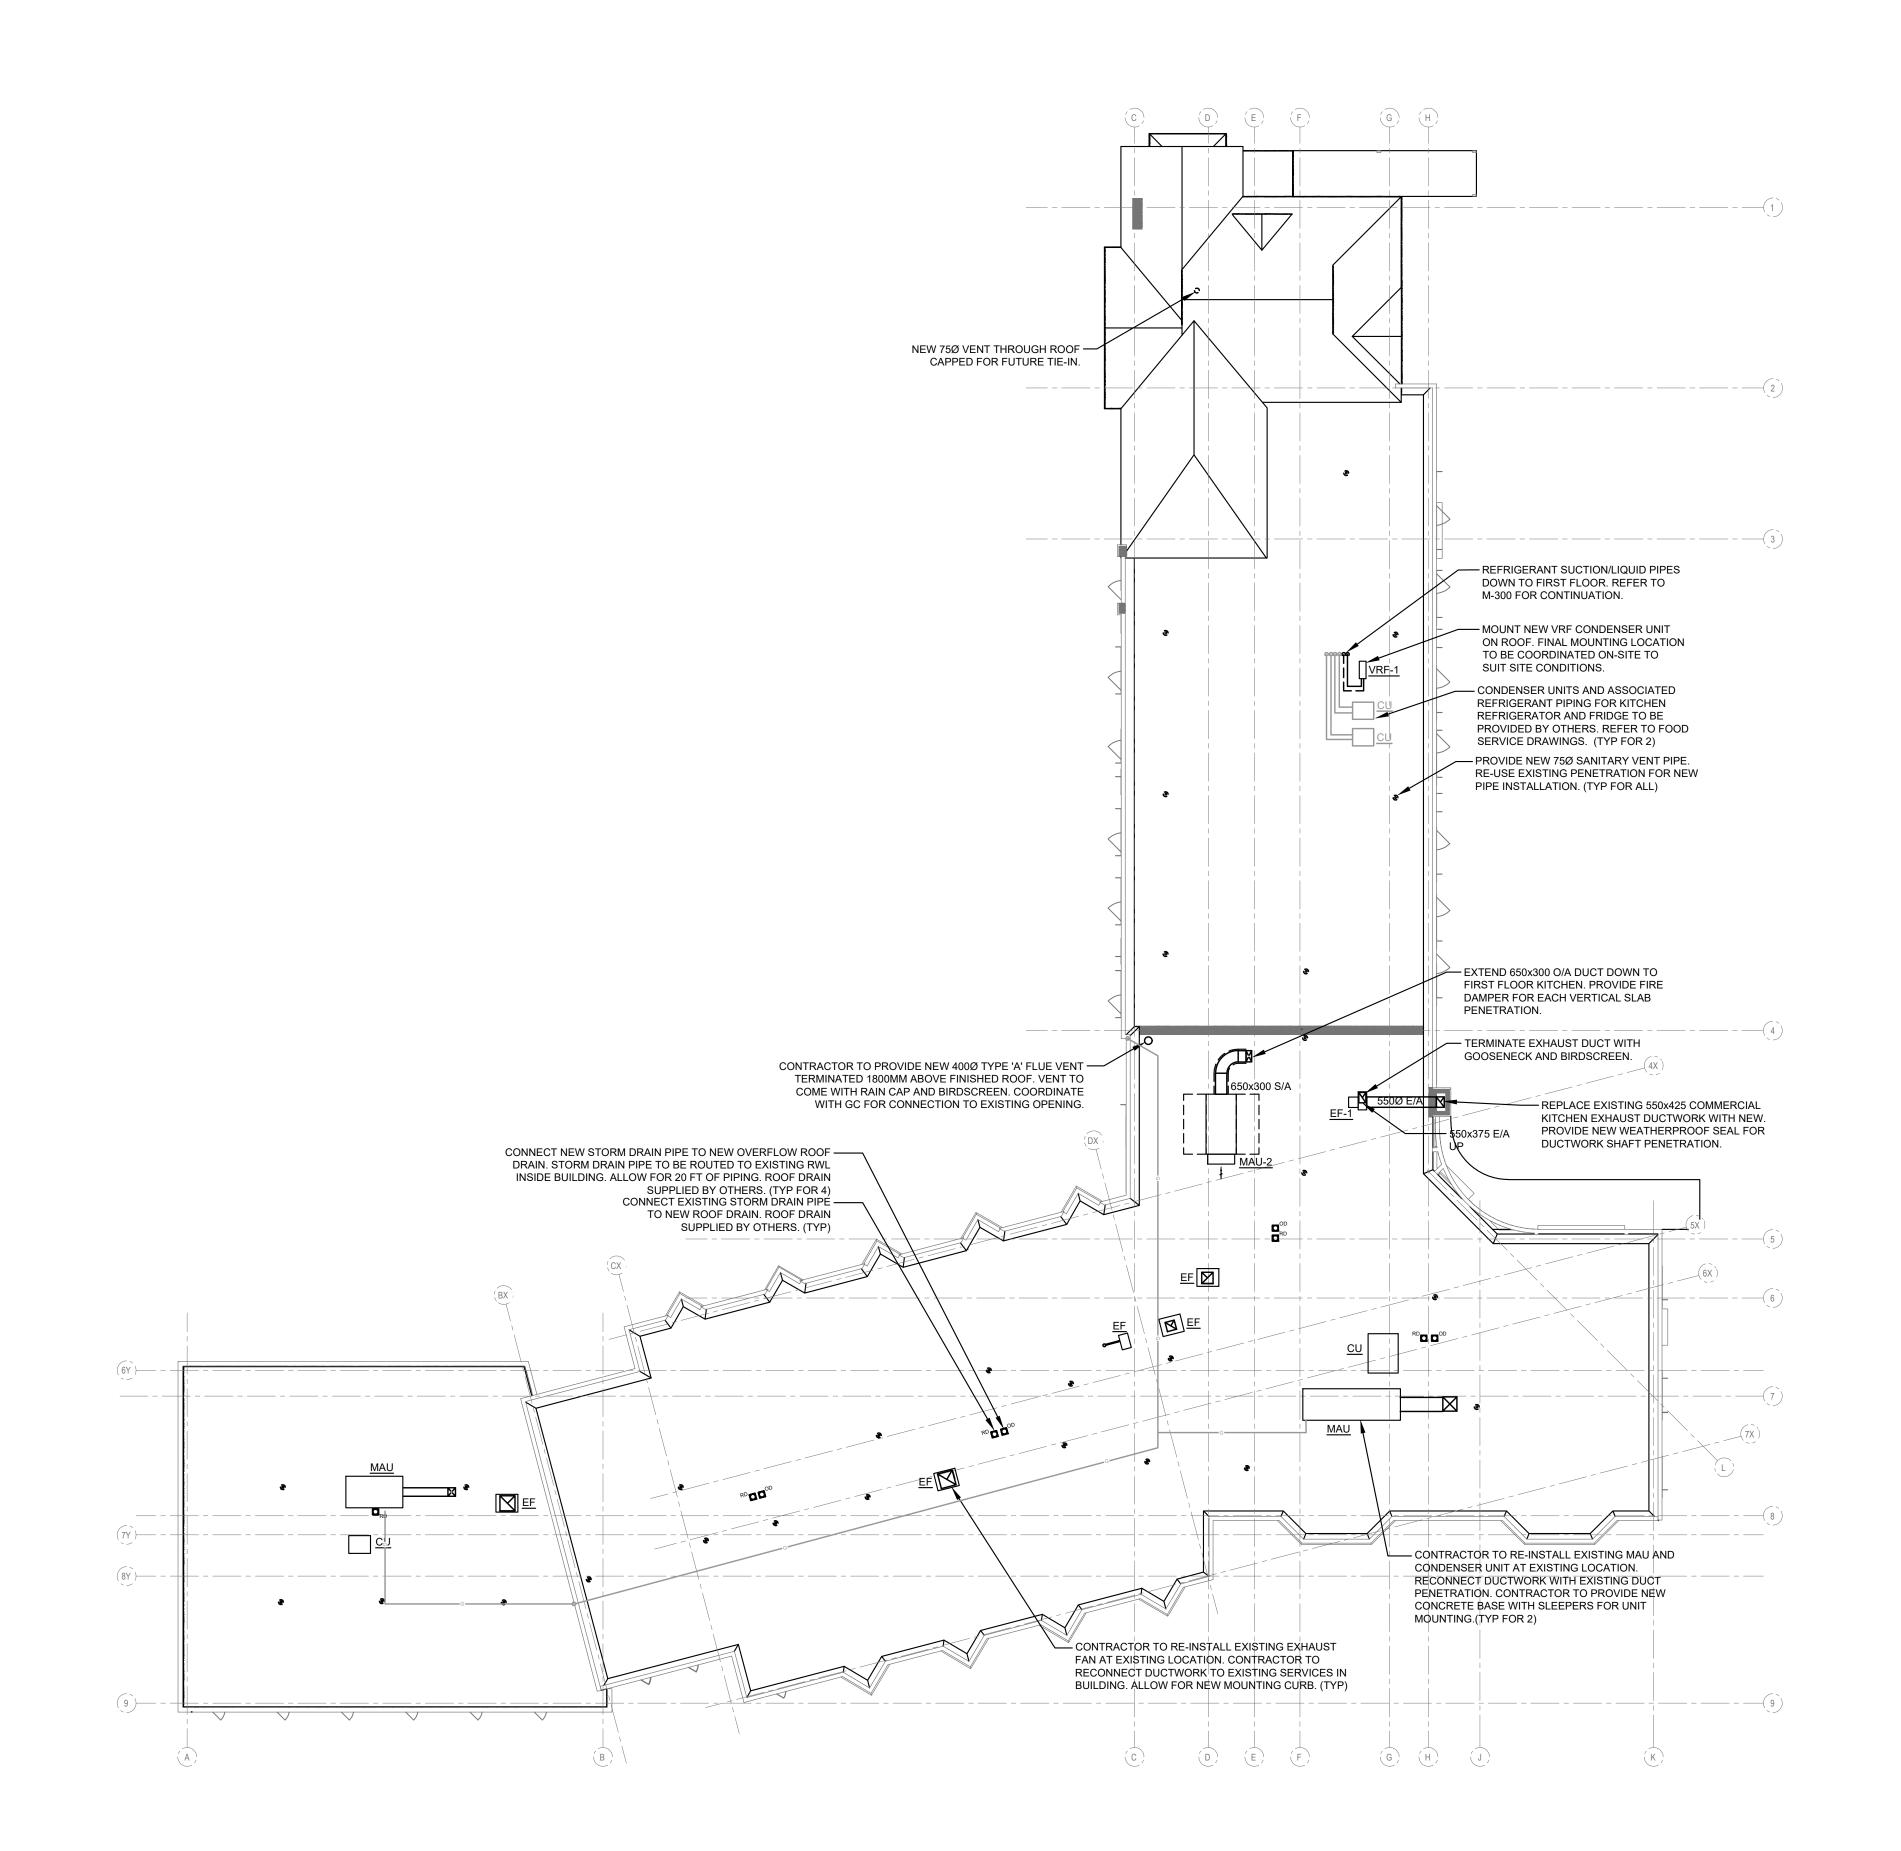





architectura partners

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SCALE:	1:200
DATE:	JUNE.2025
CONSULTANT PROJECT NO.	2025-0012

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NO.	DATE	DESCRIPTION





THE REGIONAL MUNICIPALITY OF DURHAM

WORKS DEPARTMENT
DESIGN, CONSTRUCTION &
ASSET MANAGEMENT

PROJECT:

PHASE 2 RENOVATIONS


1635 DUNDAS STREET EAST WHITBY, ONTARIO


SHEET TITLE:

ROOF - NEW PLAN

PROPERTY NO.	FACILITY CODE
RP-W-42	SS-W-02
FACILITIES PROJECT NO.	CONTRACT NO.
SS-W-02-23-01	RFP-1048-2025



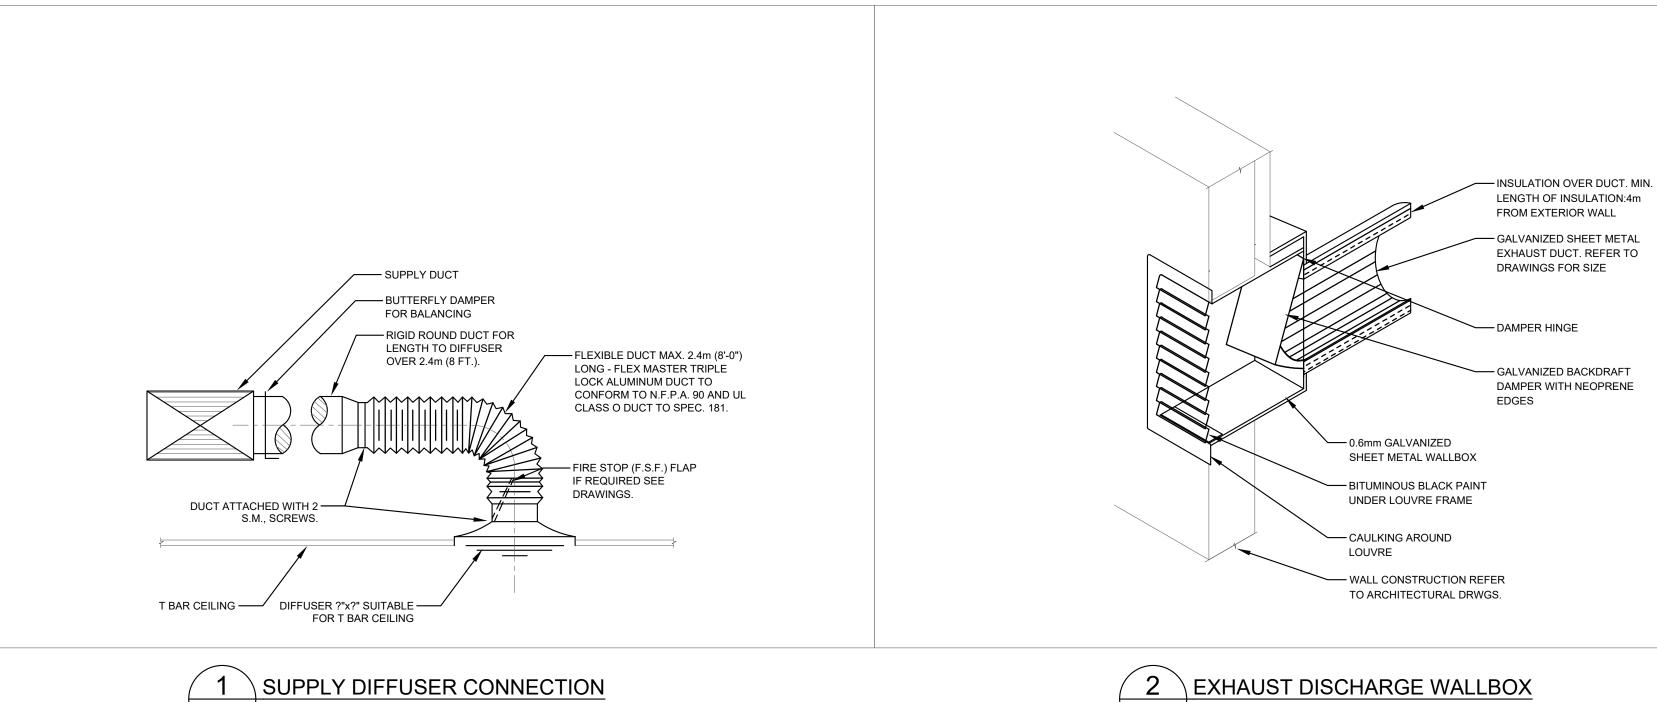


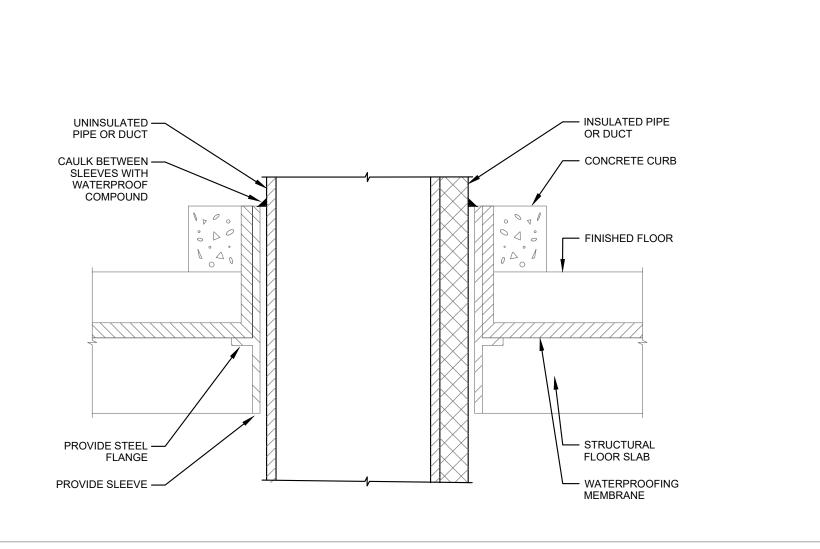









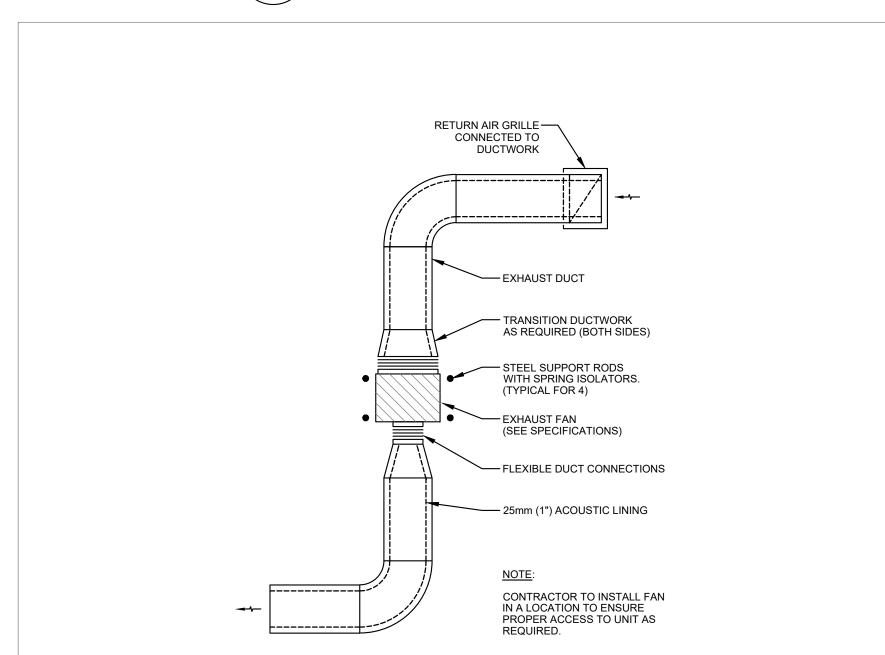

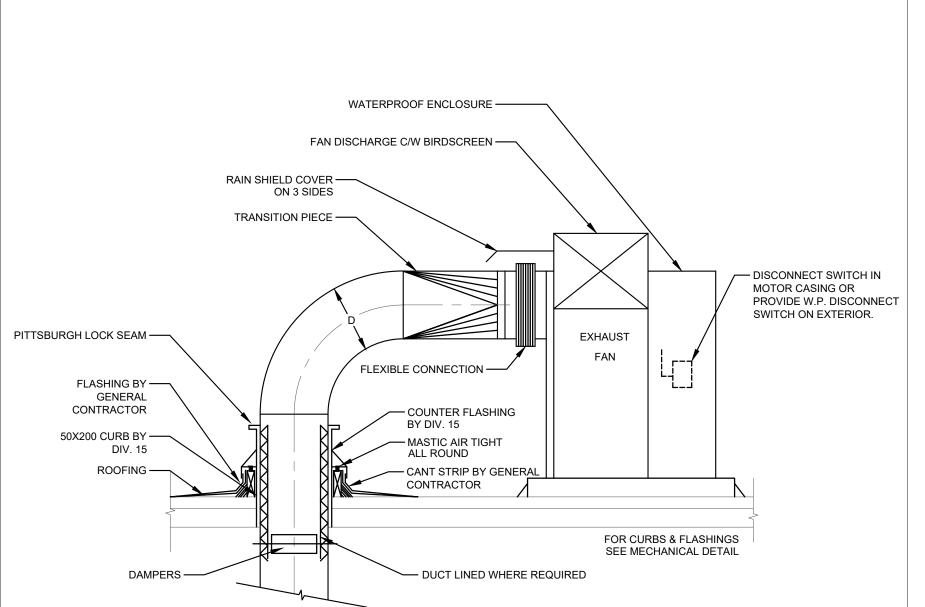


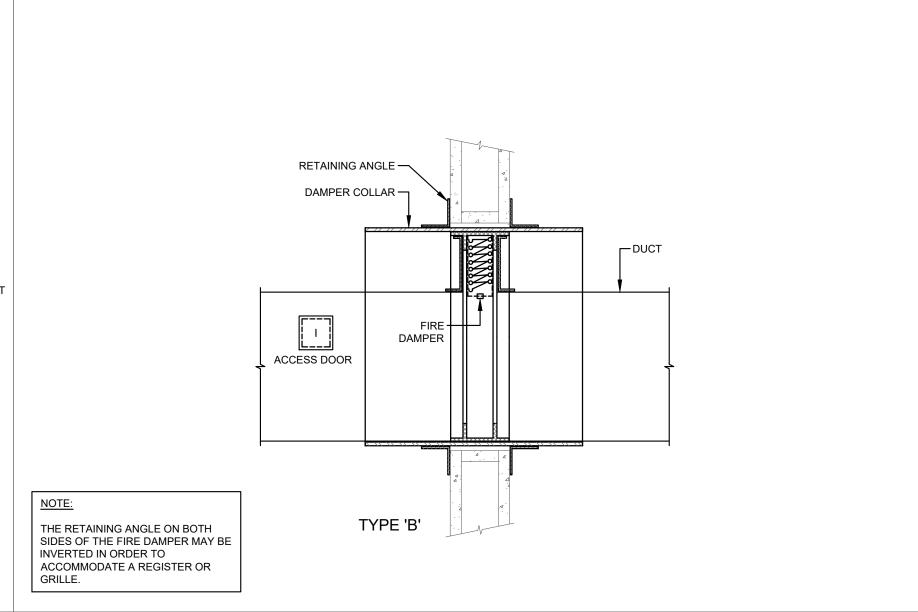

4 EXHAUST M-500 SCALE: N.T.S.

ROOF MOUNT UTILITY EXHAUST FAN SCALE: N.T.S. M-500

FIRE DAMPER (TYPE B) M-500 SCALE: N.T.S.

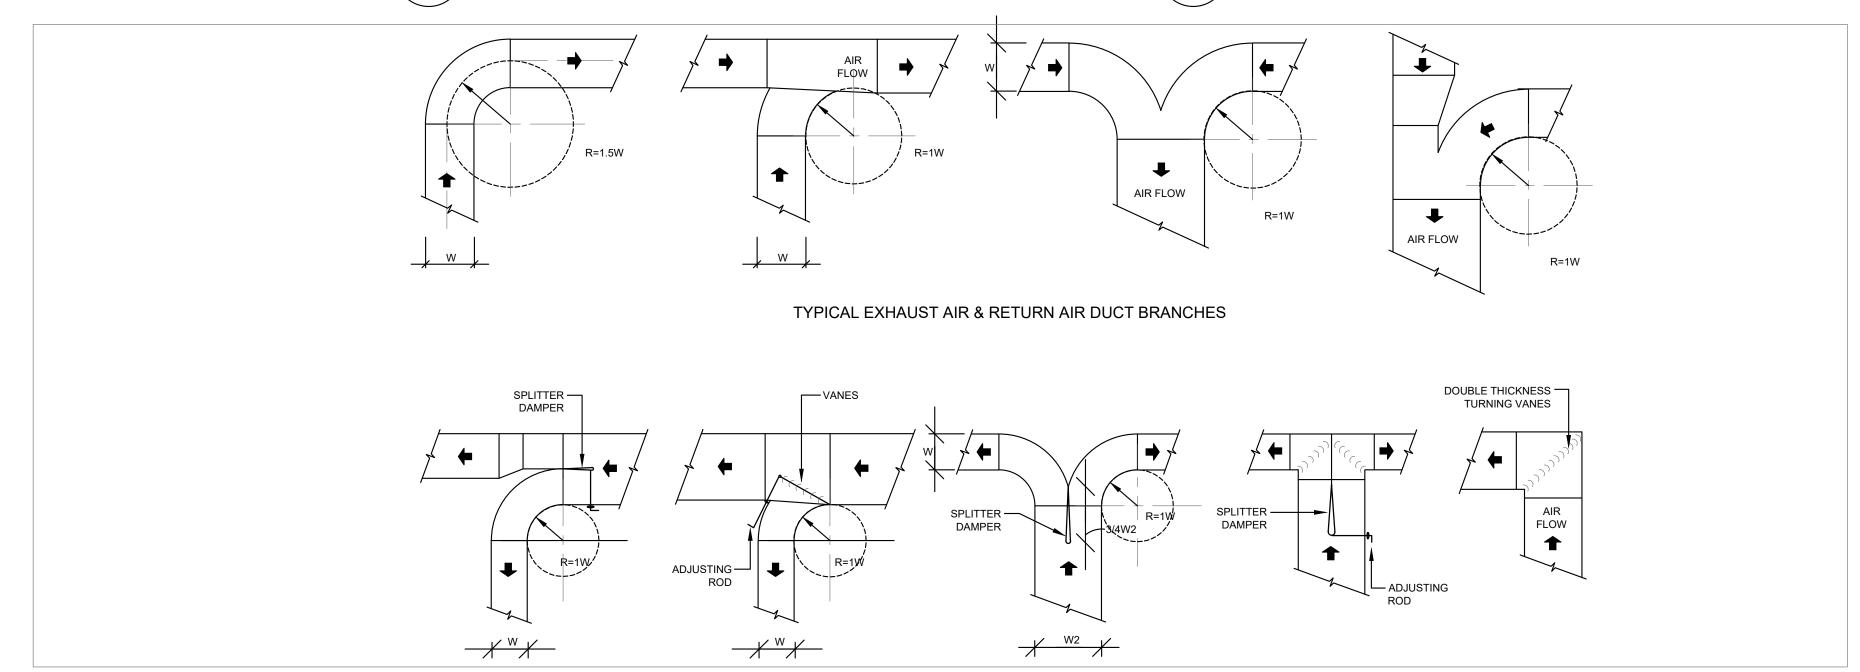







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SCALE:	
DATE:	JUNE.2025

ISSUE DATE:

CONSULTANT PROJECT NO.

2025-09-18 IFT 4 2025-07-14 ISSUED FOR PERMIT 3 2025-06-27 ISSUED FOR PERMIT REVIEW 2 | 2025-06-11 | ISSUED FOR REVIEW 1 | 2025-06-09 | ISSUED FOR COORDINATION

2025-0012





THE REGIONAL MUNICIPALITY OF DURHAM

WORKS DEPARTMENT DESIGN, CONSTRUCTION & ASSET MANAGEMENT

PROJECT:

PHASE 2 RENOVATIONS

1635 DUNDAS STREET EAST WHITBY, ONTARIO

SHEET TITLE:


MECHANICAL DETAILS


PROPERTY NO. RP-W-42


FACILITY CODE SS-W-02

FACILITIES PROJECT NO. SS-W-02-23-01

CONTRACT NO. RFP-1048-2025

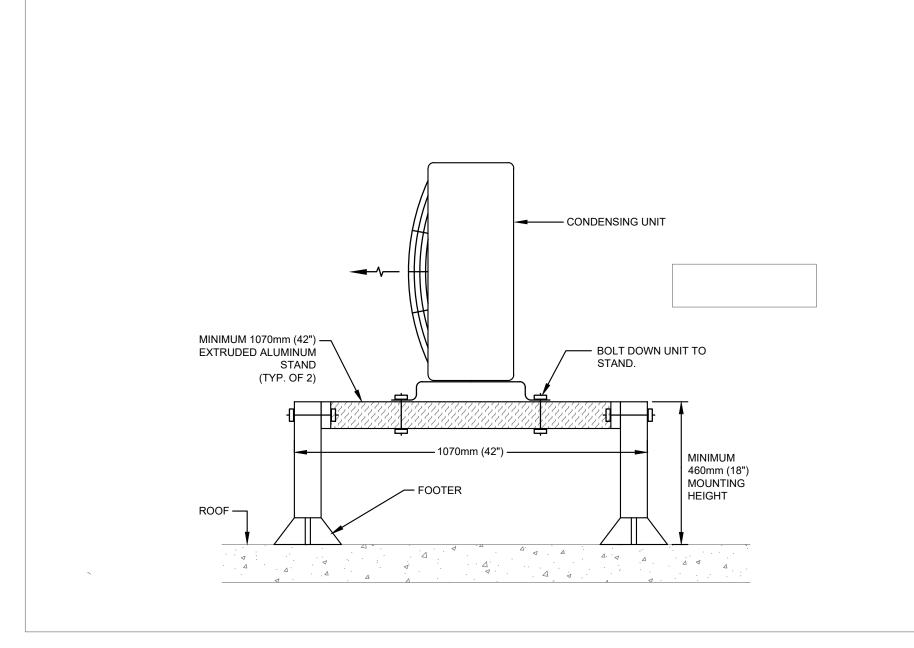

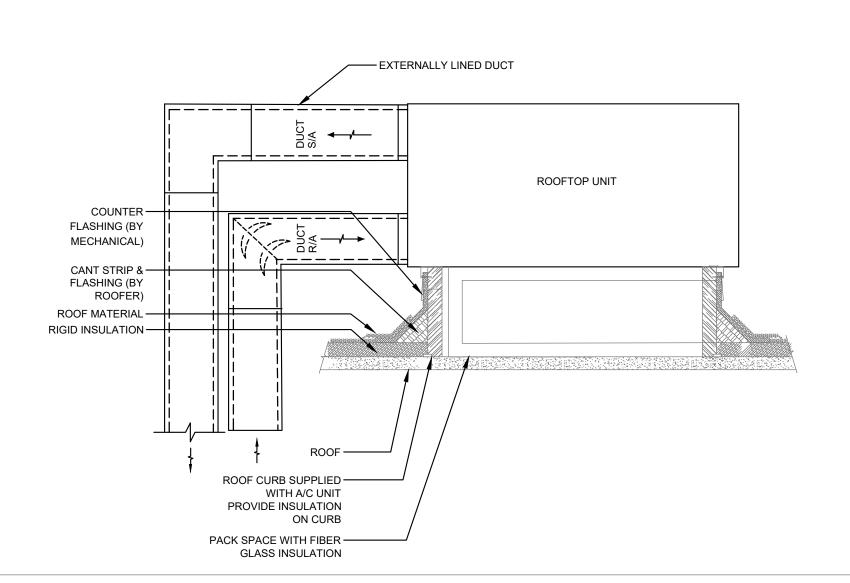


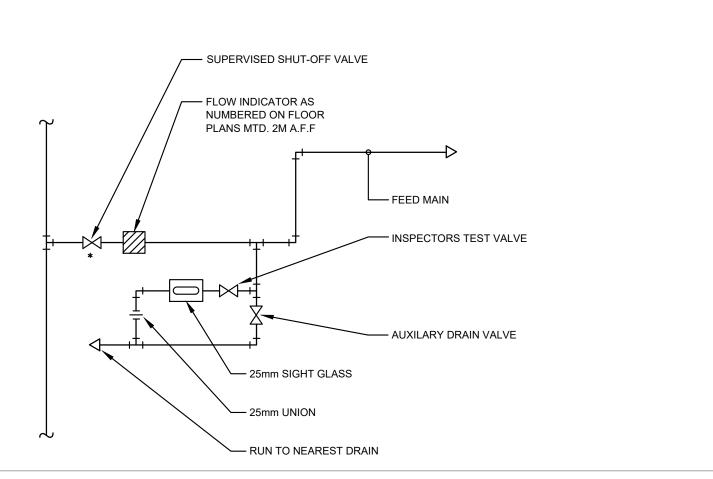




2 ROOFTOP UNIT INSTALLATION - SIDE CONNECTION SCALE: N.T.S.


3 SPRINKLER ZONE VALVE ASSEMBLY
SCALE: N.T.S.

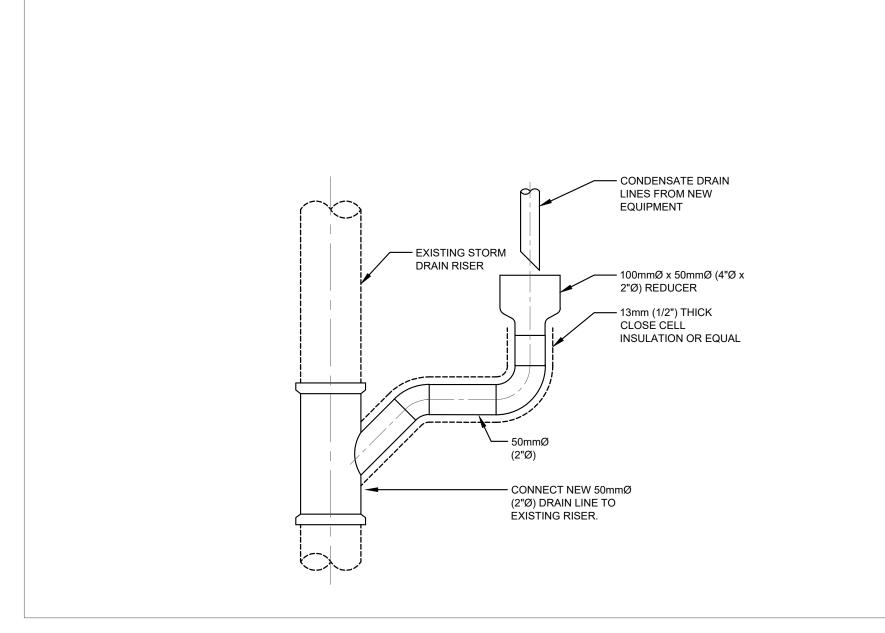



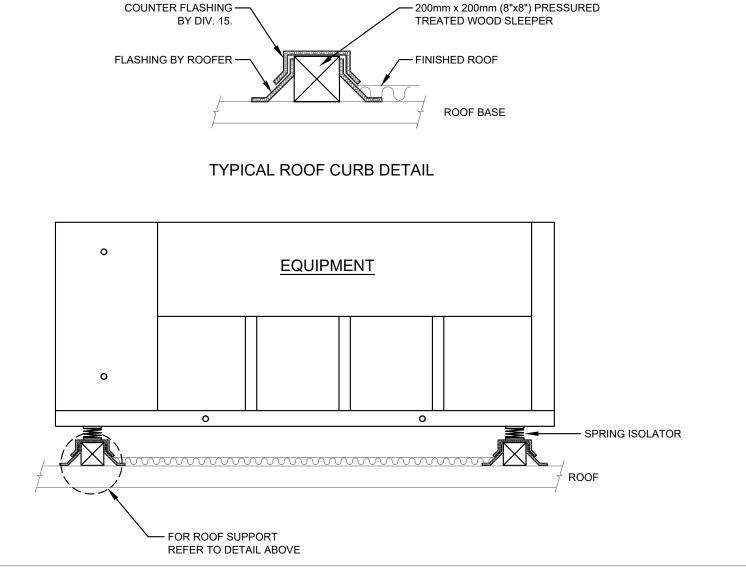


5 ROOF MOUNTED EQUIPMENT - MOUNTING
SCALE: N.T.S.

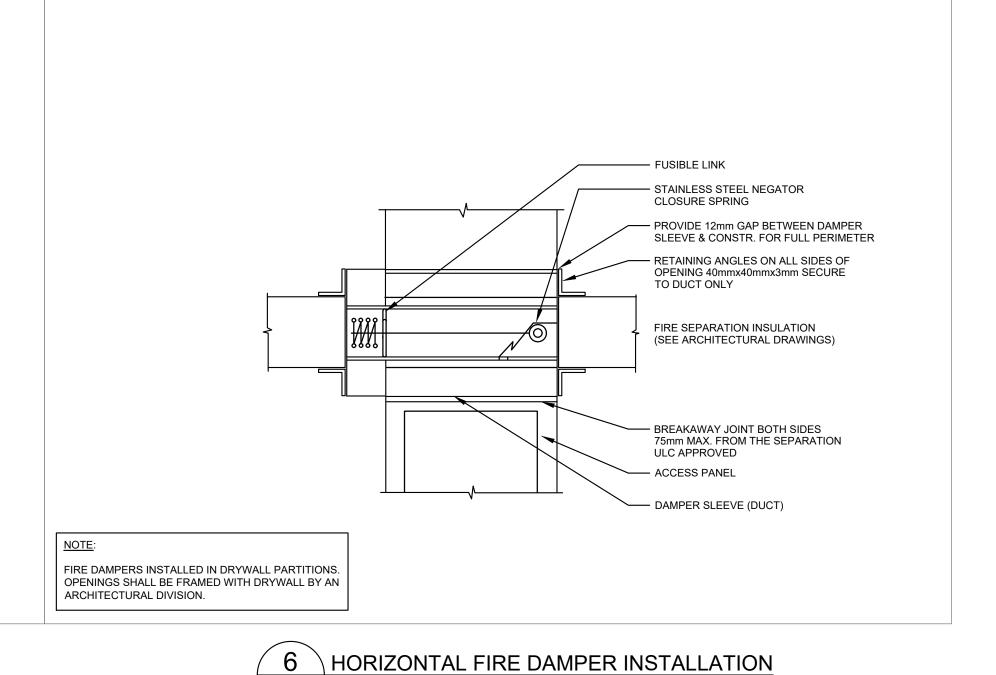

SCALE: N.T.S.

M-501

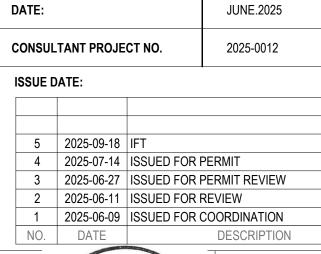

HA

MS

HIDI t. 416 364 2100 | HIDI.com

PRIME CONSULTANT

lga-ap.com

DESIGN BY:

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CHECKED BY:

APPROVED BY:

SCALE:

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Toronto, Ontario, Canada M5T 2E8

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PHASE 2 RENOVATIONS

1635 DUNDAS STREET EAST WHITBY, ONTARIO

SHEET TITLE:

MECHANICAL DETAILS

PROPERTY NO. FACILITY CODE SS-W-02

FACILITIES PROJECT NO. SS-W-02-23-01

01 RFP-1048-2025

CONTRACT NO.

												MAKE.	-UP (VI	ENTILA	ATION) A	AIR UNIT	SCHE	EDULE																
								SUPPLY FAN							EXHAUST FAN				CO	OLING COIL	PERFORM	IANCE	HEATI	NG - PRIMAF	RY (HEAT P	UMP) HE	EATING - AUX	ILIARY (ELEC	CTRIC)	REHEAT PERFORM	Γ COIL MANCE		ELECTRICAL	
TAG	SERVICE	LOCATION	MANUFACTURER	MODEL No.	AIR FLOW (L/S)	ESP (Pa)	SPEED (RPM)	MOTOR POWER (HP)	BHP (HP)	ELEC. (V/PH/Hz)	VFD/ STARTER	AIR FLOW (L/S)	ESP (Pa)	SPEED (RPM)	MOTOR POWER (HP)	BHP (HP) (\	ELEC. //PH/Hz) \$	VFD/ STARTER	TOTAL COOLING CAPACITY (kW)	SENSIBLE COOLING CAPACITY (kW)		AIR SIDE	WB (kW)	IG TY EAT (°C) LA	Γ (°C) CAF	ATING PACITY EA	.T (°C) L		HEATING CAPACITY – (kW)	AIR SIDE	VOLTAGE (V/PH/Hz)	MCA (A)	MOP (A)
NU-2	KITCHEN	ROOFTOP	YORK	JROH084B2	854	248.8	1902	1.5	0.92	575/3/60	STARTER	-	-	-	-	-	-	-	26.3	17.0	32.2/22.8	3 14.5/14.5	17.5	-8.3	3	7.78	50.0	-20	23.8	6.77	20.8	575/3/60	31.6	40.0
		ENERGY RECOVER	YY				ENERGY R	ECOVERY WHE	EL - SUPPLY				ENE	ERGY RECOV	/ERY WHEEL - I	EXHAUST	ST MAXIMUM FAN SOUND POWER LEVEL OF SPECIFIED EQUIPMENT MAX. PWL IN DB RE 10W^(-12)							MAXIMUM FAN SOUND POWER LEVEL OF SPECIFIED EQUIPMENT MAX. PWL IN DB RE 10W^(-12)										
-AG	MOTOR POWER	ELEC. (V/PH/Hz)	VFD/ STARTER	PURGE AIR FLOW	RECO	ENERGY OVERED (kW)	EFFEC	TIVENESS	E DB/V	AT /B (°C)	L DB/W	.AT VB (°C)	DB	EAT 3/WB (°C)	DE	LAT B/WB (°C)		ACTIVE BAND SOUND POWER LABEL (SUPPLY)					ACTIVE BAND SOUND POWER LABEL (CONDENSER) ACTIVE BAND SOUND POWER LABEL (CONDENSER) FILTERS MAX WEIGHT (KG) NOR					EMERGENCY NORMAL POW	OR VER REMARKS					
	(HP)	(V/PП/ПZ)		(L/S)	SUMMER	WINTER	SUMMER SENS/TOTA	WINTER L SENS/TOTAL	SUMMER	WINTER	SUMMER	WINTER	SUMMER	WINTER	R SUMMER	R WINTER	63	125	250 50	00 100	0 2000	0 4000	8000	63	125 2	50 500	1000	2000	4000 8	3000				
U-2	-	-	_	_	_	_	_	_	_	_	_	_	_	_	_	_	49	56	67 6	67	68	65	59	66.5	84.1 8	32 86.9	85.3	80.5	75	69.8 ME	ERV 13	951	NORMAL	C/W R454B REFRIGERANT, HORIZONTAL DISCHARGE CONFIG., 24" ROOF CURB, POWER DISCONNECT, CO DUTLET, BACNET CONTROLLER. INTERLOCK WITH KITCHEN EXHAUST FAN.

APPROVED ALTERNATIVES: VENMAR, DAIKIN, AAON

	EXHAUST FAN SCHEDULE																							
					AUD EL OW	54M 00550		TOD 0175		E1 E0	FLA		WHEEL		EMERGENCY	1		(IMUM FAN SOUND POWER LEVEL OF SPECIFIED EQUIPMENT MAX. PWL IN DB RE 10W^(-12)		IPMENT				
TAG	FAN TYPE CLASS	LOCATION	MANUFACTURER	MODEL No.	(L/S)	(RPM)	ESP (Pa) MOT	TOR SIZE (HP)	BHP (HP)	ELEC. (V/PH/Hz)	FLA (A)	VFD/ STARTER	DIAMETER (MM)	WEIGHT (KO	OR NORMAL POWER	BAS CONTROL		ACTIV	E BAND II	ILET SOUND	POWER L	ABEL		REMARKS
																	63	125	250	500 1000	2000	4000	8000	
EF-1	CENTRIFUGAL BLOWER	ROOF	COOK	150 CPV	897	1561	250	1	0.564	575/3/60	1.7	STARTER	487.5	89	NORMAL	LOCAL	73	77	797	3 69	69	65	58	ULC 762 RATED, SIDE INTAKE/UPBLAST, WEATHERPROOF MOTOR CASE. C/W GREASE TROUGH, MOUNTING RAILS.
EF-2	INLINE FAN	FIRST FLOOR TRAINING KITCHEN	соок	GN-126	34	530	25	-	-	120/1/60	0.18	SWITCH	-	5.9	NORMAL	LOCAL	-	-	-		-	-	-	C/W EXTERNAL SPEED CONTROLLER, VIBRATION ISOLATORS, INTEGRATED BACKDRAFT DAMPER
NOTE:							•											-						

APPROVED ALTERNATIVES: GREENHECK, TWINCITY FANS, LOREN COOK

		VARIABLE REFRIGERANT FLOW SYSTEMS															MS								
	OUTDOOR UNIT																								
BOL	OEDVIOE	U	INIT		COOLING			HEAT			ELECT		REF	RIGERANT	WEIGHT	BOL	UI	TIV	coo	LING	HEAT	OFM	FLEOT	WEIGHT	DEMARKS.
SYM	SERVICE	MFGR.	CAT. NO.	TOTAL (MBH)	OAT (°F)	EER/SEER	MBH	OAT (°F)	COP	V/PH/Hz	MCA	МОР	TYPE	CHARGE AMOUNT (LB)	LBS	SYM	MFGR.	CAT. NO.	TOTAL MBH	SENS. MBH	МВН	CFM	ELECT	LBS	REMARKS
VRF-1	GROUND FLOOR	YORK	YVAHP048B21S	48.0	88.0	16.7/24.10	54.0	47.0	4.56	208/1/60	31.0	40.0	R410A	7.9	267	AC-1x	YORK	TIWM006B22S	6.2	5.1	6.9	353	208/1/60	22	C/W LOW AMBIENT BAFFLE KIT, CONDENSER STAND, WALL-MOUNTED CONTROLLER (CIW01), MULTI-KIT (MW-NP282A3), CONDENSATE PUMP
VKF-1	GROUND FLOOR	TORK	1 VARP046B21S	46.0	88.0	16.7/24.10	54.0	47.0	4.56	200/1/00	31.0	40.0	K410A	7.9	207	AC-2x	YORK	TIWM012B22S	12.3	9.5	13.9	494	208/1/60	24	C/W LOW AMBIENT BAFFLE KIT, CONDENSER STAND, WALL-MOUNTED CONTROLLER (CIW01), MULTI-KIT (MW-NP282A3), CONDENSATE PUMP
XX																									
NOTE:	ED ALTERNATIVES: DAIKIN, MITS, LG																								

	STARTERS
TYPE	DESCRIPTION
MS-1	MAU-2 NON-REVERSING MAGNETIC STARTER, 600V, 45A MIN., NEMA 1 ENCLOSURE, HOA W/ RUN LIGHT, 5A MAX. CONTACT CIRCUIT
MS-2	EF-1 NON-REVERSING MAGNETIC STARTER, 600V, 5A MIN., NEMA 1 ENCLOSURE, HOA W/RUN LIGHT

MECHANICAL CONTRACTOR TO COORDINATE WITH STARTER MANUFACTURER AND MAKE-UP AIR UNIT MANUFACTURER ANY MODIFICATIONS REQUIRED TO BE MADE TO MAU-2 TO ENSURE COMPATIBILITY WITH THE PANEL.

MECHANICAL CONTRACTOR TO FORWARD STARTER DESIGNATION AND ITEM DATE (AS LISTED ON THE EQUIPMENT SCHEDULE) TO THE STARTER MANUFACTURER. APPROVED VENDORS: GE, ABB, EATON, SIEMENS

MISCELLANEOUS EQUIPMENT
DESCRIPTION
STELPRO ELECTRIC BASEBOARD HEATER MODEL NO. B1258W, 1250W ,208/1/60, 57 IN. LONG, BUILT-IN SINGLE POLE THERMOSTAT
STELPRO ELECTRIC BASEBOARD HEATER MODEL NO. B1008W, 1000W, 208/1/60, 47 IN. LONG, BUILT-IN SINGLE POLE THERMOSTAT

					DIFF	USERS	& GRIL	LES
OL		UNIT		DAM	PER			
SYMBOL	CAT. NO.	APPLICATION	SUPPLY RETURN EXHAUST	PART OF UNIT	REMOTE IN DUCT	MATERIAL	FINISH	REMARKS
Р	SPD	CORRIDOR	SUPPLY	N	Y	ALUMINUM	WHITE	
E	80	SANITARY EXHAUST	EXHAUST	N	Y	ALUMINUM	WHITE	
G	530	GENERAL RETURN	RETURN	N	Y	STEEL	WHITE	
S	510	GENERAL SUPPLY	SUPPLY	N	Y	STEEL	WHITE	
XX								
NOTE:				•				





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DESCRIPTION





THE REGIONAL **MUNICIPALITY OF** DURHAM

WORKS DEPARTMENT DESIGN, CONSTRUCTION & ASSET MANAGEMENT

PROJECT:

PHASE 2 RENOVATIONS

1635 DUNDAS STREET EAST WHITBY, ONTARIO

SHEET TITLE:

MECHANICAL SCHEDULES

PROPERTY NO.	FACILITY CODE	
RP-W-42	SS-W-02	
FACILITIES PROJECT NO.	CONTRACT NO.	
SS-W-02-23-01	RFP-1048-2025	