

- GENERAL NOTES:**
- ALL WORK TO COMPLY WITH ALL APPLICABLE BUILDING CODES AND BY-LAWS.
 - THE CONTRACTOR SHALL VERIFY ALL DIMENSIONS ON SITE, AND BRING ANY DISCREPANCIES FORWARD BEFORE TENDER OR SUBMITTING A QUOTE.
 - THE CONTRACTOR SHALL BE RESPONSIBLE FOR REFINISHING ALL DAMAGED SURFACES OF ADJACENT AREAS AND NEW AREAS.
 - THESE DRAWINGS SHALL NOT BE SCALED UNLESS OTHERWISE AND SPECIFICALLY NOTED. ACCURACY OF ANY SCALES PROVIDED ARE NOT GUARANTEED.
 - INSTALL ALL PRODUCTS IN CONFORMANCE WITH MANUFACTURER'S SPECIFICATIONS.
 - REMOVE ALL REDUNDANT EQUIPMENT AND MATERIALS FROM SITE AND DISPOSE OF IN AN APPROVED MANNER. REDUNDANT EQUIPMENT AND MATERIALS SHALL NOT BE ABANDONED IN PLACE.
 - THE CONTRACTOR SHALL PRICE, SUPPLY, & INSTALL ALL PRODUCTS NOTED THROUGHOUT THIS DRAWING SET UNLESS OTHERWISE STATED AS: "*SUPPLIED BY*" AND/OR "*INSTALLED BY*," THE "*OWNER*," "*DDSB*", AND/OR "*OTHERS*".
 - ITEMS TO BE TURNED OVER TO OWNER (*DDSB*) ARE TO BE DELIVERED TO THE MAINTENANCE SHOP (710 BAYLY STREET, AJAX) IF TURN OVER AT THE EDUCATION CENTRE IS NOT ACCEPTABLE OR APPROPRIATE.
 - AT NO TIME SHALL MASONRY DRY CUTTING TAKE PLACE. ALL MASONRY TO BE WET-CUT ONLY.
 - UNLESS OTHERWISE PROVIDED BY THE MANUFACTURER, A MINIMUM OF 1 YEAR WARRANTY SHALL BE PROVIDED FOR ALL NEW INSTALLATIONS.
 - THE CONTRACTOR SHALL BE RESPONSIBLE FOR THE TEMPORARY REMOVAL OF DOOR COMPONENTS IN ANY UNFORESEEN SITUATION(S) WHICH ARISE FROM MATERIAL / PRODUCT SIZE BEING INCOMPATIBLE WITH THE EXISTING, UNALTERED OPENING(S).
 - THE GENERAL CONTRACTOR SHALL CARRY A CASH ALLOWANCE OF FOURTY-FIVE THOUSAND DOLLARS (\$45,000) FOR *MECHANICAL & ELECTRICAL WORK*.

SYMBOLS LEGEND

DRAWING TAG: DRAWING NUMBER | DRAWING NAME
PAGE NUMBER | DWG. DESCRIPTION SCALE

ELEVATION TAG: PAGE NUMBER |
DRAWING NUMBER |

SECTION TAG: DRAWING NUMBER |
PAGE NUMBER |

INTERIOR ELEV. TAG: DRAWING NUMBER |
PAGE NUMBER |

EXISTING DOOR & FRAME TO REMAIN:
EXISTING DOOR & HM FRAME TO BE REMOVED:
NEW DOOR & FRAME:

REVISION BUBBLE:

DEMOLITION TAG:

PROPOSED WORK TAG:

TYPE TAG:

W = WINDOWS & SCREENS
MW = MILLWORK
D = DOOR
P = PARTITION / WALL TYPE
PT = PAINT FINISH
B = BASEBOARD

GENERAL ELECTRICAL NOTES:

- NO SURFACE MOUNT BOXES TO BE INSTALLED AS PART OF NEW WORK.
- GFCI RECEPTACLES TO BE USED IN PROXIMITY TO SINKS AND OTHER PLUMBING FIXTURES.
- CUTOUTS TO BE COORDINATED BETWEEN ELECTRICAL & GENERAL CONTRACTORS.
- ALL NEW POWER & DATA TO BE RUN IN ¾" EMT CONDUIT WHERE EVER POSSIBLE. CONSULT WITH *DDSB PROJECT SUPERVISOR* WHERE EVER NOT POSSIBLE.
- ALL THERMOSTATS / CONTROLS SHALL BE DISCONNECTED, RELOCATED, ALTERED, REINSTALLED, AND/OR OTHERWISE HANDLED BY A CERTIFIED *CONTROLS CONTRACTOR*. NO WIRES SHALL BE CUT, UNLESS REQUIRED AND NOTED AS PART OF THE SCOPE OF WORK. DISCONNECT ALL EQUIPMENT APPROPRIATELY, SECURE AND BAG ABOVE CEILING AS NEEDED FOR RELOCATES AND TEMPORARY UNINSTALLS.
- ALL NEW DATA LINES SHALL BE PLENUM RATED CAT6A. INCLUDE SUPPLY & INSTALL OF FACEPLATE, CABLE TO NEAREST SERVER RACK, AND KEYSTONE. CONFIRM KEYSTONE TYPE, LABEL FACEPLATE & KEYSTONE ACCORDINGLY, COORDINATE WITH THE *DDSB PROJECT SUPERVISOR* PRIOR TO FINAL INSTALL & LABELING TO ENSURE *DDSB ITS DEPARTMENT* IS SATISFIED. *DDSB ITS DEPARTMENT* SHALL PATCH LINES INTO SERVER W THEIR PATCH CORD.
- ALL DATA CABLES SHALL BE INSTALLED BY A PANDUIT CERTIFIED CONTRACTOR.

ELECTRICAL LEGEND

SYMBOL	DESCRIPTION	MAKE / MODEL
	15A 120V 1PH GROUNDED DUPLEX RECEPTACLE • "USB" DENOTES ADDITION OF TWO (2) MIX-USB PORTS ON FACEPLATE, (x1) USB-A & (x1) USB-C, ON SAME RECEPTACLE	
	15A 120V 1PH GROUNDED QUAD RECEPTACLE • "USB" DENOTES ADDITION OF TWO (2) MIX-USB PORTS ON FACEPLATE, (x1) USB-A & (x1) USB-C, ON SAME RECEPTACLE	
	DATA ONLY OUTLET BOX	NEW: CAT6a CABLE
	OCCUPANCY SENSOR	
	FIRE ALARM HORN AND/OR STROBE	
	THERMOSTAT	
	WALL-MOUNTED LIGHT SWITCH • "3" DENOTES 3-WAY LAMP • MOUNTING HEIGHT TO COMPLY WITH CODE FOR ANY NEW	

CEILING PLAN LEGEND

TAG	DESCRIPTION
	2x4 CEILING-MOUNTED LIGHT FIXTURE • NEW PRODUCT: MATCH EXISTING
	REMOTE EMERGENCY LIGHTING HEAD(S)
	2x2 AIR DIFFUSER • NEW PRODUCT: SCD - 31 - 33, WHITE IN COLOUR, <i>PRICE INDUSTRIES</i>
	HEAT / SMOKE DETECTOR
	EMERGENCY EXIT SIGN • FILLED IN QUADRANT DENOTES FACING • ARROWS DENOTE DIRECTION OF EXIT SIGN
	CEILING MOUNTED P.A. SPEAKER
	SPRINKLER HEAD

WALL TYPES

LABEL	DESCRIPTION
	NEW INTERIOR PARTITION: <ul style="list-style-type: none">1/2" GYPSUM BOARD,1/2" PLYWOOD,3 5/8" METAL STUD LAYER, FILL WITH ROXUL INSULATION1/2" PLYWOOD,1/2" GYPSUM BOARD
NOTES <ul style="list-style-type: none">STUDS: FLOOR TO UNDERSIDE OF DECK.GYPSUM& PLYWOOD: FLOOR TO 6" ABOVE CEILING.TAPE, MUD, & SAND GYPSUM PRIOR TO APPLYING PRIMER / PAINT.FILL METAL STUDS WITH ROXUL INSULATION FOLLOWING INSTALL OF ANY ELECTRICAL, ETC...	


1 KEY PLAN
SK0 SINCLAIR SECONDARY SCHOOL - SECOND FLOOR

NTS

DENOTES 144mm PARTITION W:
13mm GYPSUM,
13mm PLYWOOD,
92mm METAL STUD FILLED
WITH ROXUL INSULATION,
13mm PLYWOOD,
13mm GYPSUM.

ABBREVIATIONS / ACRONYMS:			
ACSTC.	ACOUSTIC		
ACT	ACOUSTIC CEILING TILE		
AFF	ABOVE FINISHED FLOOR		
AKA	ALSO KNOWN AS		
AP	ACCESS POINT		
ACSTC.	APPROXIMATELY		
BTM.	BOTTOM		
CJ	CONTROL JOINT		
CP	CONTROL PANEL		
DDSB	DURHAM DISTRICT SCHOOL BOARD		
DIM(S)	DIMENSION(S)		
DWG.	DRAWING		
E.Q.	EQUAL		
EX.	EXISTING		
EXIST.	EXISTING		
FIN.	FINISH		
F.R.R.	FIRE RESISTANCE RATING		
FT²	SQUARE FEET		
HM	HOLLOW METAL		
INSUL.	INSULATION		
LIN. FT.	LINEAR FEET		
LVT	LUXURY VINYL TILE		
NA	NOT APPLICABLE		
PROP.	PROPOSED		
PT	PAINT		
RCP	REFLECTED CEILING PLAN		
RM	ROOM		
T.B.D.	TO BE DETERMINED /DISCUSSED		
VP	VISION PANEL		
W	WITH		
@	AT		
&	AND		
0'-0"	FOOT - INCH (imperial measurements)		
[00.00]	MILLIMETERS (mm) (metric measurements)		

These drawings were prepared by the *Durham District School Board*, referred to as *DDSB* or The Board throughout, and are intended to be used for the purpose of completing alterations on one of its properties.

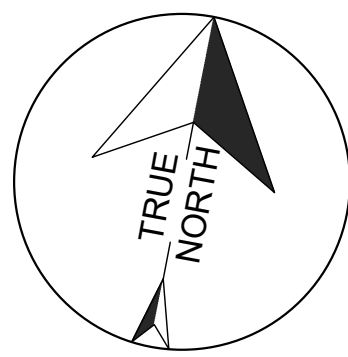

PROJECT: Sinclair SS PLP Classroom Alterations Project No: T25-51	
Scale:	AS NOTED
Drawn by:	Iain Meldrum
Checked by:	Chris Thaler
Address:	380 Taunton Rd E, Whitby, ON L1R 2K5
TITLE: GENERAL NOTES & KEY PLAN	
	DRAWING No: SK0

#

DEMOLITION NOTES:

- DEMOLISH EXISTING INTERIOR PARTITION AS SHOWN & NOTED, IN ITS ENTIRETY.
- UNINSTALL EXISTING HM FRAME, WOOD DOOR, AND ANY/ALL HARDWARE AND GLAZING. SEE (SK3) FOR DOOR SCHEDULE & MORE INFORMATION. TURN OVER REDUNDANT MATERIAL.
- REMOVE AND DISPOSE OF EXISTING LVT FLOORING, THROUGHOUT.
- REMOVE AND DISPOSE OF EXISTING *RUBBER BASE* ALONG BOTTOM PERIMETER OF WALL(S).
- REMOVE AND DISPOSE OF EXISTING *MILLWORK*, THROUGHOUT. LOOSE FURNITURE AND ITEMS SHALL BE REMOVED PRIOR TO PROJECT START BY THE *SCHOOL*.
- ALLOW FOR ADJUSTMENTS TO EXISTING ELECTRICAL, DATA, AND/OR LIFE SAFETY SYSTEM DEVICES UNDER THE *CASH ALLOWANCE*. EXACT DEVICES, LOCATIONS, & SCOPE OF WORK SHALL BE DETERMINED BY THE *DDSB PROJECT SUPERVISOR*.
- EXISTING ELECTRICAL PANEL(S) SHALL BE RELOCATED TO ACCOMMODATE WALL DEMOLITION. THIS WORK SHALL ALSO BE CARRIED UNDER THE *CASH ALLOWANCE*.
- REMOVE EXISTING LOCKERS WITHIN CORRIDOR TO ACCOMMODATE NEW DOOR OPENING.
- CREATE NEW DOOR OPENING WITHIN CORRIDOR WALL. LINTEL AS REQUIRED.

#

PROPOSED NOTES:


- PROVIDE AND INSTALL MATERIAL TO CONSTRUCT NEW INTERIOR PARTITION AS PER WALL TYPE: [P-1]. FLOOR TO UNDERSIDE OF DECK.
- INFILL EXISTING WALL OPENING, MATCH SURROUNDING MATERIALS AND THICKNESS.
- ALLOW FOR REINSTALL OF EXISTING HM FRAME, WOOD DOOR, AND ANY/ALL HARDWARE AND GLAZING. REFER TO (SK3) FOR DOOR SCHEDULE AND MORE INFO.
- PROVIDE AND INSTALL NEW VCT FLOORING, THROUGHOUT. FOR PRODUCTS & LOCATIONS, SEE (1/SK3).
- PROVIDE AND INSTALL NEW *RUBBER BASE* ALONG BOTTOM PERIMETER OF WALL(S). FOR PRODUCTS, SEE (SK3).
- ALLOW FOR ADJUSTMENTS TO EXISTING AND PROVIDE & INSTALL NEW ELECTRICAL, DATA, AND LIFE SAFETY SYSTEM DEVICES UNDER THE *CASH ALLOWANCE*. EXACT DEVICES, LOCATIONS, & SCOPE OF WORK SHALL BE DETERMINED BY THE *DDSB PROJECT SUPERVISOR*.
- REINSTALL EXISTING ELECTRICAL PANEL(S) UNDER THE *CASH ALLOWANCE*.
- PATCH, PRIME, AND PAINT ALL WALLS & HOLLOW METAL FRAMES (BOTH SIDES). FINISHES AND LOCATIONS SHALL BE GOVERNED BY (1/SK3).
- REPAIR TERRAZZO FLOORING & BASE WITHIN CORRIDOR WHERE LOCKERS REMOVED & NEW OPENING CREATED.
- PROVIDE AND INSTALL NEW CUSTOM MILLWORK CONTROL PANEL.

P-1

DENOTES 144mm PARTITION W:
13mm GYPSUM,
13mm PLYWOOD,
92mm METAL STUD FILLED
WITH ROXUL INSULATION,
13mm PLYWOOD,
13mm GYPSUM.

ABBREVIATIONS / ACRONYMS:


ACSTC.	ACOUSTIC
ACT	ACOUSTIC CEILING TILE
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AKA	ALSO KNOWN AS
AP	ACCESS POINT
ACSTIC.	APPROXIMATELY
BTTM.	BOTTOM
CJ	CONTROL JOINT
CP	CONTROL PANEL
DDSB	DURHAM DISTRICT SCHOOL BOARD
DIM(S)	DIMENSION(S)
DWG.	DRAWING
E.Q.	EQUAL
EX.	EXISTING
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LIN. FT.	LINEAR FEET
LVT	LUXURY VINYL TILE
NA	NOT APPLICABLE
PROP.	PROPOSED
PT	PAINT
RCP	REFLECTED CEILING PLAN
RM	ROOM
T.B.D.	TO BE DETERMINED /DISCUSSED
VP	VISION PANEL
W	WITH
@	AT
&	AND
0'-0"	FOOT - INCH
[00.00]	(imperial measurements) MILLIMETERS (mm) (metric measurements)

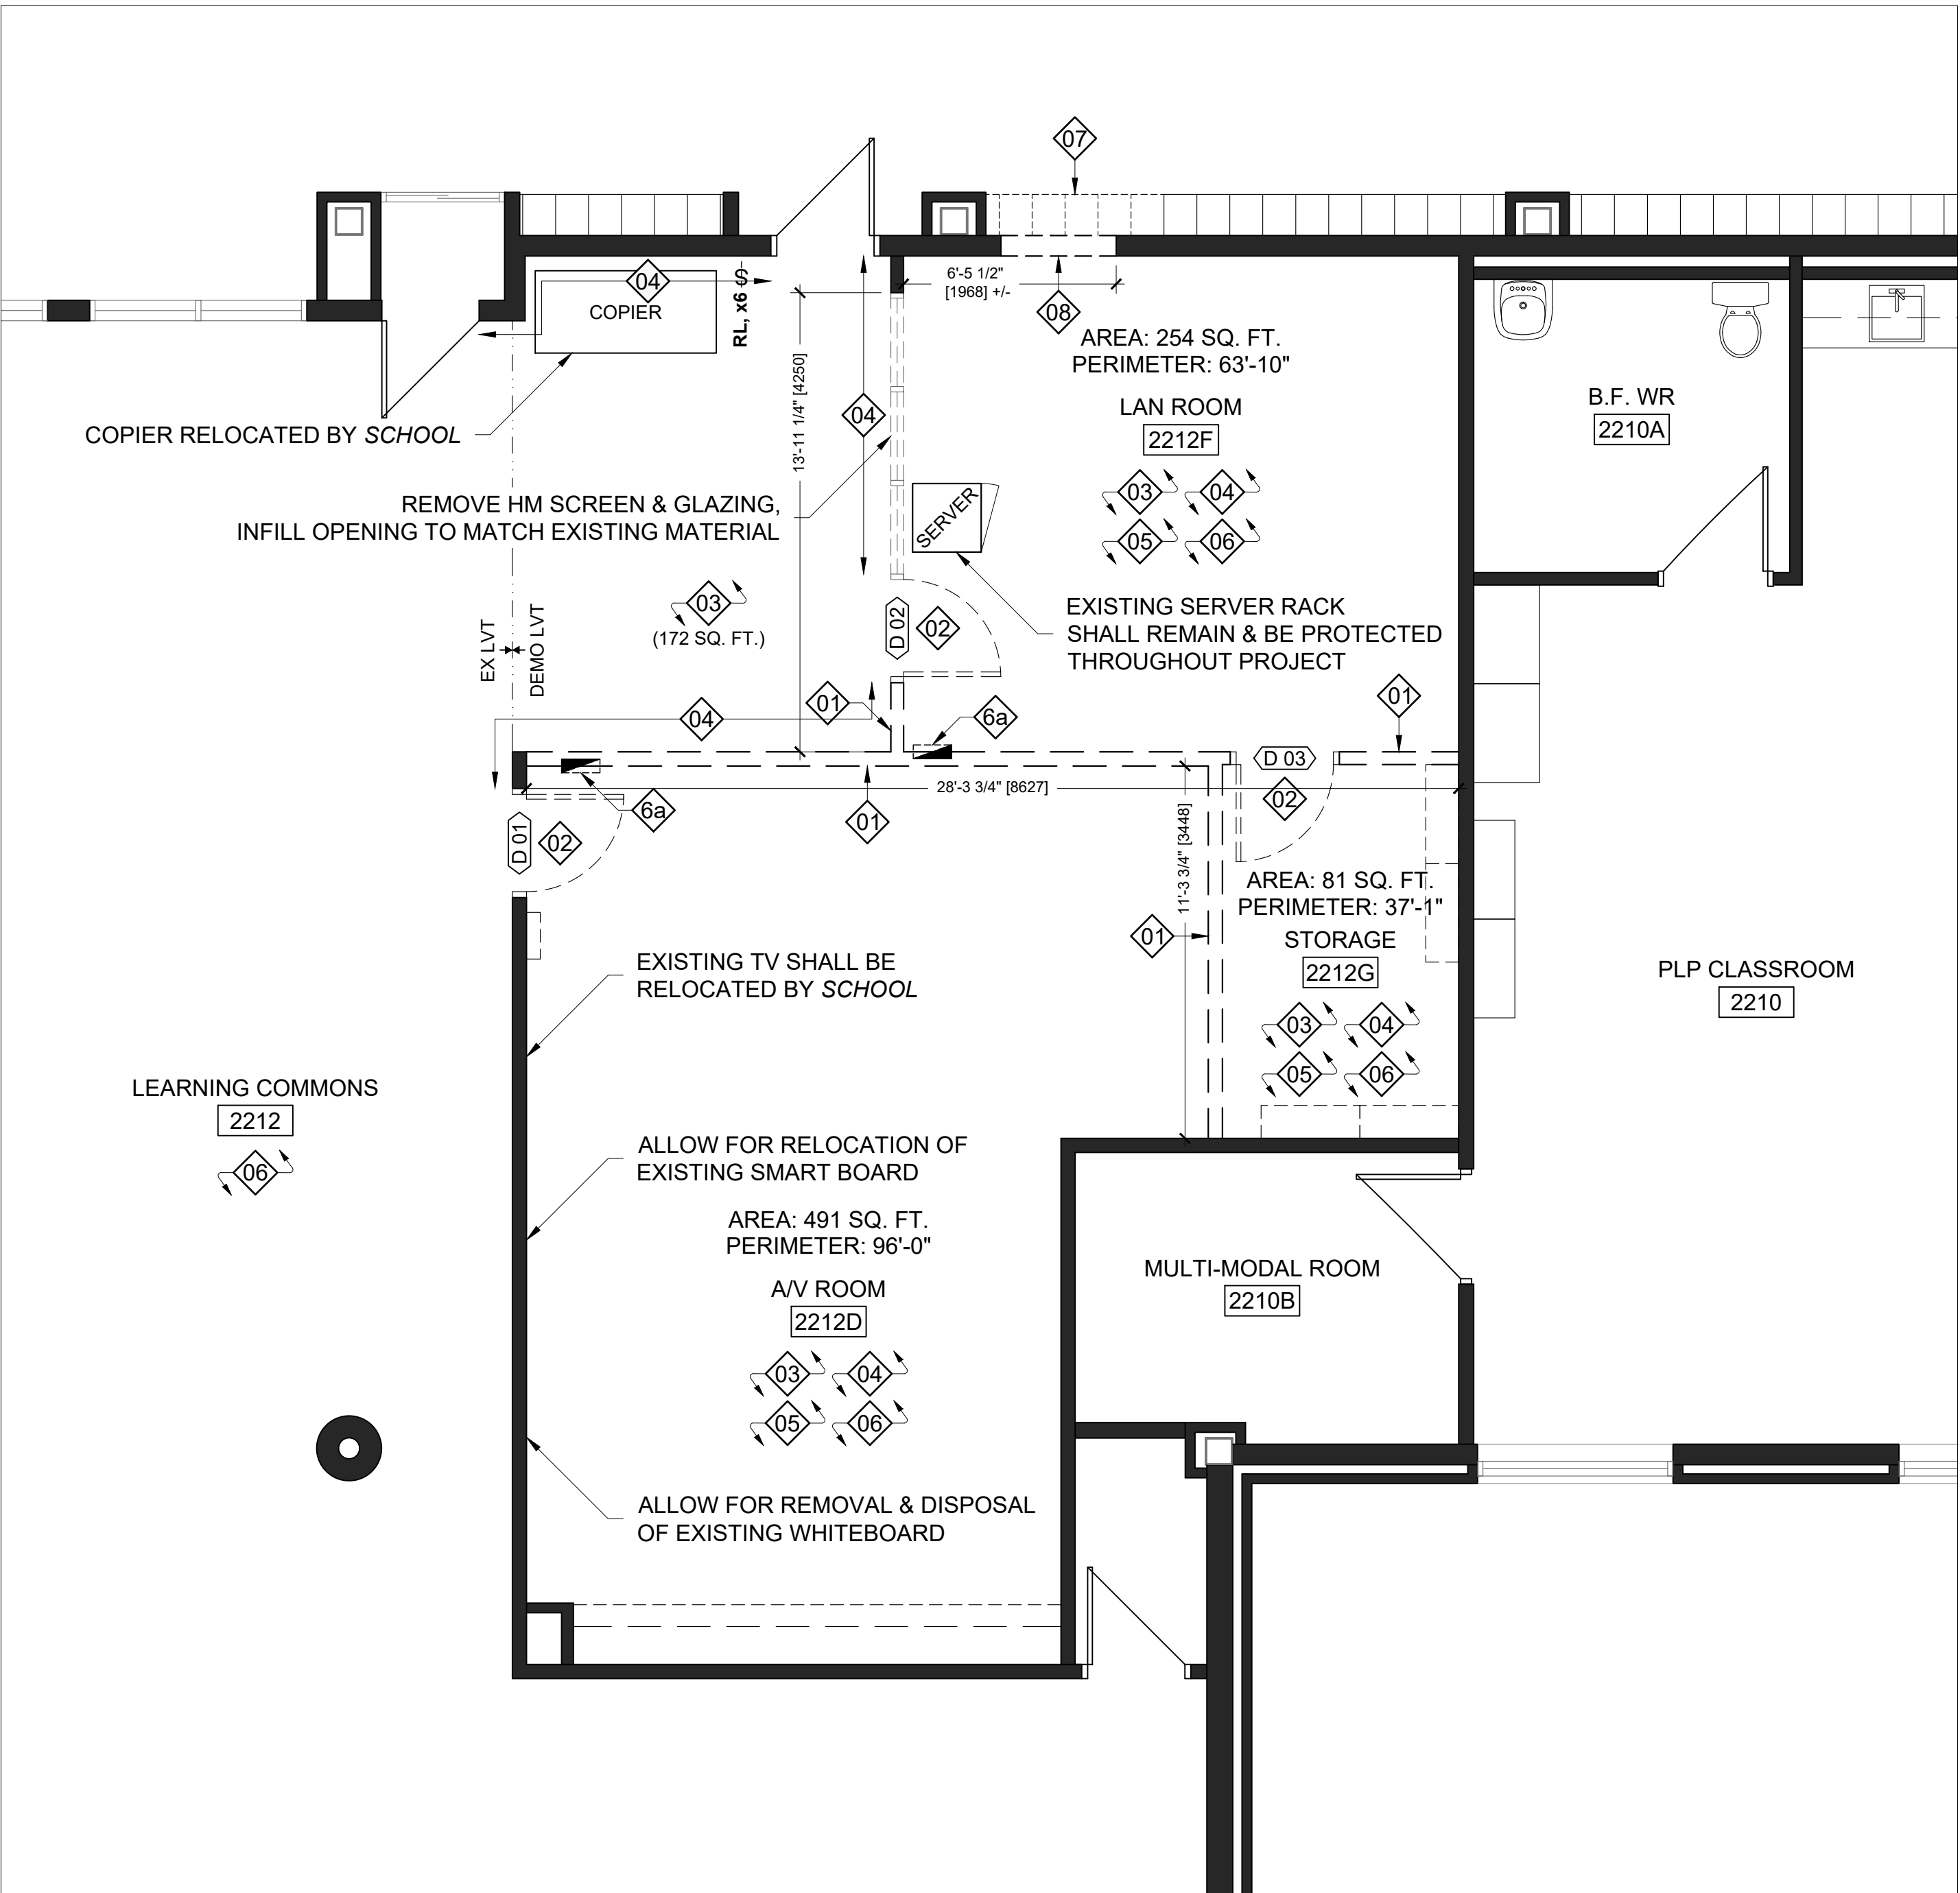

1

DEMOLITION PLAN
SK1 SINCLAIR SS- SECOND FLOOR


1/4" = 1'-0"

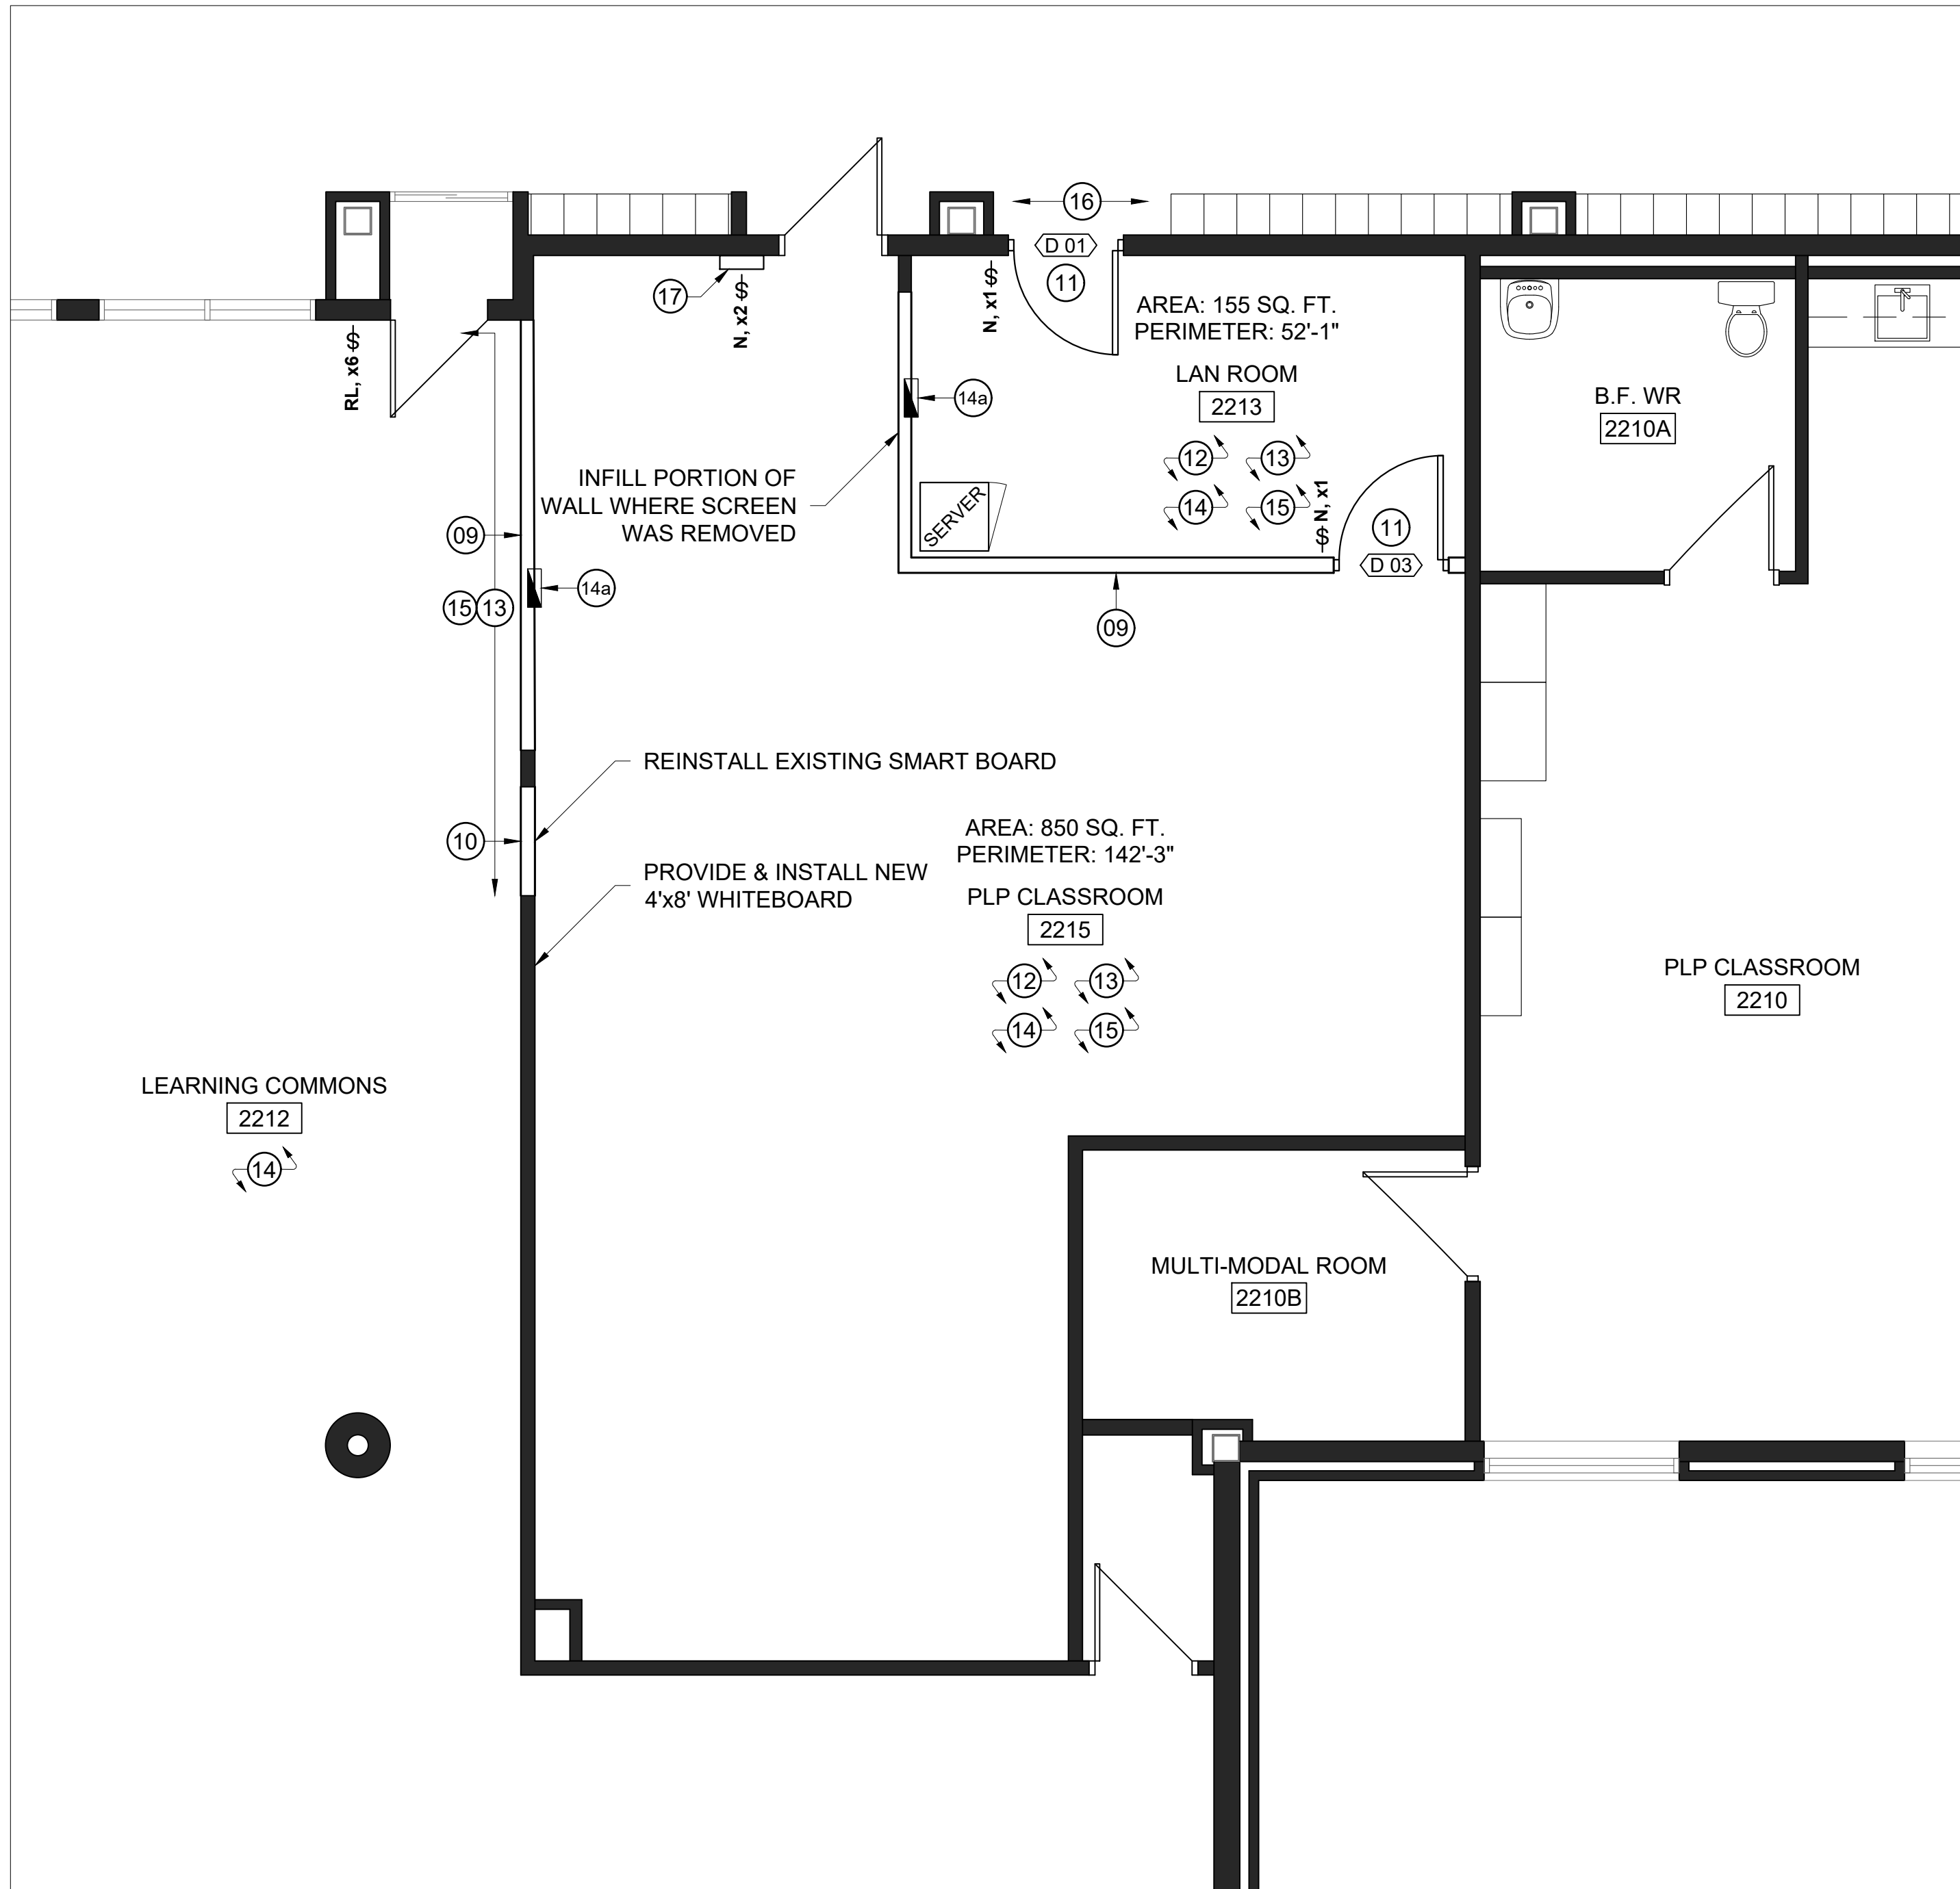

2

PROPOSED PLAN
SK1 SINCLAIR SS- SECOND FLOOR

1/4" = 1'-0"

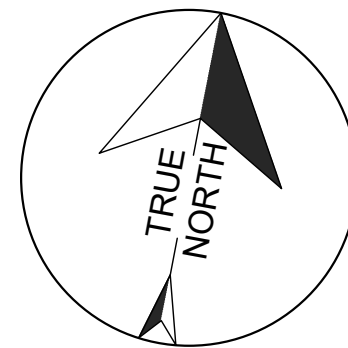

PROJECT:

Sinclair SS PLP Classroom Alterations

Project No: T25-51

Scale: AS NOTED

Drawn by: Iain Meldrum

Checked by: Chris Thaler

Address: 380 Taunton Rd E, Whitby, ON L1R 2K5

TITLE:

DEMOLITION & PROPOSED PLANS



DRAWING No:

SK1

##

DEMOLITION REFLECTED CEILING PLAN NOTES:

1. REMOVE AND DISPOSE OF EXISTING CEILING GRID & TILE, THROUGHOUT.
2. WIRELESS ACCESS POINTS SHALL BE REMOVED BY *DDSB IT DEPARTMENT* STAFF PRIOR TO CONSTRUCTION START.
3. ALLOW FOR RELOCATION OF EXISTING LIGHT FIXTURE. ALL WORK INVOLVED SHALL BE COVERED UNDER THE *CASH ALLOWANCE*.
4. ALLOW FOR RELOCATION OF EXISTING AIR DIFFUSER. ALL WORK INVOLVED SHALL BE COVERED UNDER THE *CASH ALLOWANCE*.
5. ALLOW FOR RELOCATION OF EXISTING CEILING-MOUNTED ELECTRICAL AND/OR LIFE SAFETY SYSTEMS DEVICE. ALL WORK INVOLVED SHALL BE COVERED UNDER THE *CASH ALLOWANCE*.
6. ALLOW FOR RELOCATION OF EXISTING SPRINKLER HEAD AND SERVICE LINE AS REQUIRED. ALL WORK INVOLVED SHALL BE COVERED UNDER THE *CASH ALLOWANCE*, AND *ROHEN FIRE PROTECTION LTD.* SHALL COMPLETE THIS WORK.
7. UNINSTALL EXISTING AIR RETURN "EGG-CRATE" GRILLE FOR REINSTALL OR TURN OVER TO *DDSB*.

##

PROPOSED REFLECTED CEILING PLAN NOTES:



8. PROVIDE AND INSTALL NEW T-BAR GRID AND ACOUSTIC CEILING TILES THROUGHOUT. MATCH EXISTING HEIGHT AND LAYOUT WHERE APPROPRIATE. SEE (SK3) FOR PRODUCTS.
9. WIRELESS ACCESS POINTS SHALL BE REINSTALLED BY *DDSB IT DEPARTMENT* STAFF IN TAIL END OF PROJECT OR POST COMPLETION.
10. ALLOW FOR REINSTALL OF EXISTING LIGHT FIXTURE. ALL WORK, INCLUDING SWITCHING, SHALL BE COVERED UNDER THE *CASH ALLOWANCE*.
11. ALLOW FOR REINSTALL OF EXISTING AIR DIFFUSER. ALL WORK, INCLUDING ALTERATIONS OR ADDITIONS TO DUCT WORK, SHALL BE COVERED UNDER THE *CASH ALLOWANCE*.
12. ALLOW FOR REINSTALL OF EXISTING CEILING-MOUNTED ELECTRICAL AND/OR LIFE SAFETY SYSTEMS DEVICE. ALL WORK INVOLVED SHALL BE COVERED UNDER THE *CASH ALLOWANCE*.
13. NEW LOCATION FOR EXISTING SPRINKLER HEAD. ALLOW FOR ALTERATIONS TO SERVICE LINE AS REQUIRED. ALL WORK INVOLVED SHALL BE COVERED UNDER THE *CASH ALLOWANCE*, AND *ROHEN FIRE PROTECTION LTD.* SHALL COMPLETE THE WORK.
14. REINSTALL EXISTING AIR RETURN "EGG-CRATE" GRILLE. TURN OVER REDUNDANT MATERIAL TO *DDSB*.

P-1

DENOTES 144mm PARTITION W:
13mm GYPSUM,
13mm PLYWOOD,
92mm METAL STUD FILLED
WITH ROXUL INSULATION,
13mm PLYWOOD,
13mm GYPSUM.

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BTTM. BOTTOM
CJ CONTROL JOINT
CP CONTROL PANEL
DDSB DURHAM DISTRICT SCHOOL BOARD
DIM(S) DIMENSION(S)
DWG. DRAWING
E.Q. EQUAL
EX. EXISTING
EXIST. EXISTING
FIN. FINISH
F.R.R. FIRE RESISTANCE RATING
FT² SQUARE FEET
HM HOLLOW METAL
INSUL. INSULATION
LIN. FT. LINEAR FEET
LVT LUXURY VINYL TILE
NA NOT APPLICABLE
PROP. PROPOSED
PT PAINT
RCP REFLECTED CEILING PLAN
RM ROOM
T.B.D. TO BE DETERMINED /DISCUSSED
VP VISION PANEL
W WITH
@ AT
& AND
0'-0" FOOT - INCH
[00.00] (imperial measurements)
(metric measurements)

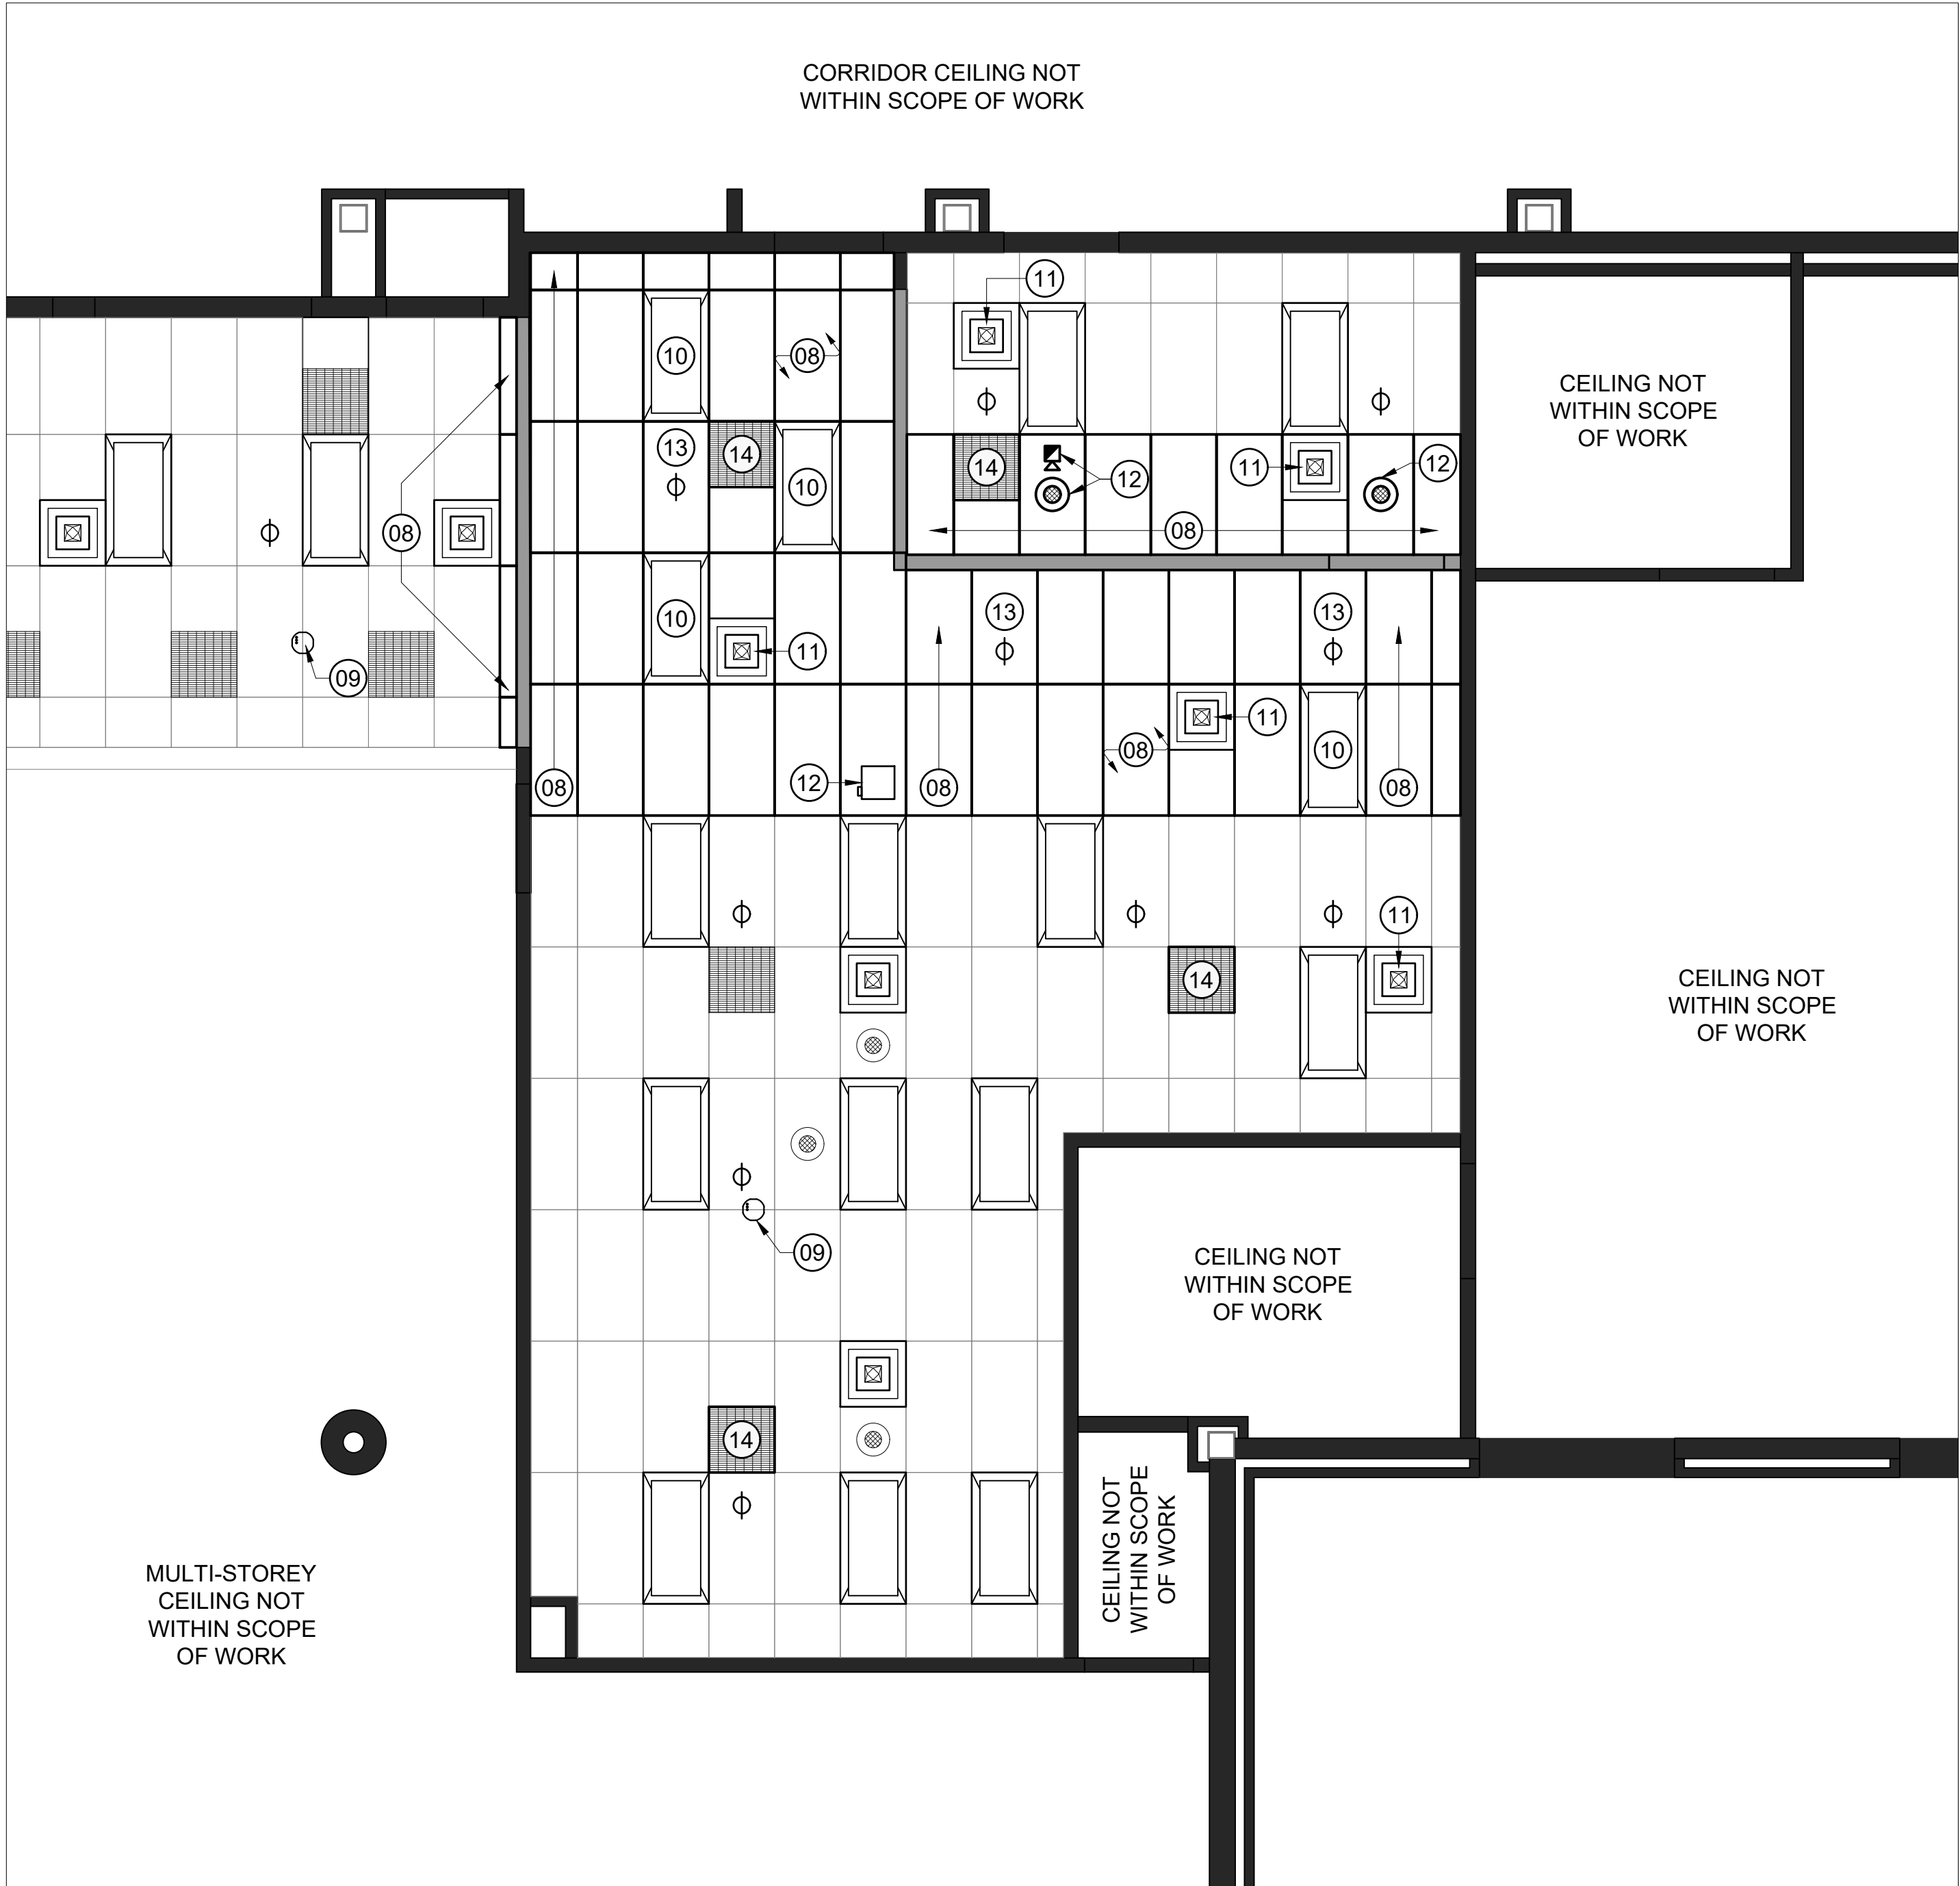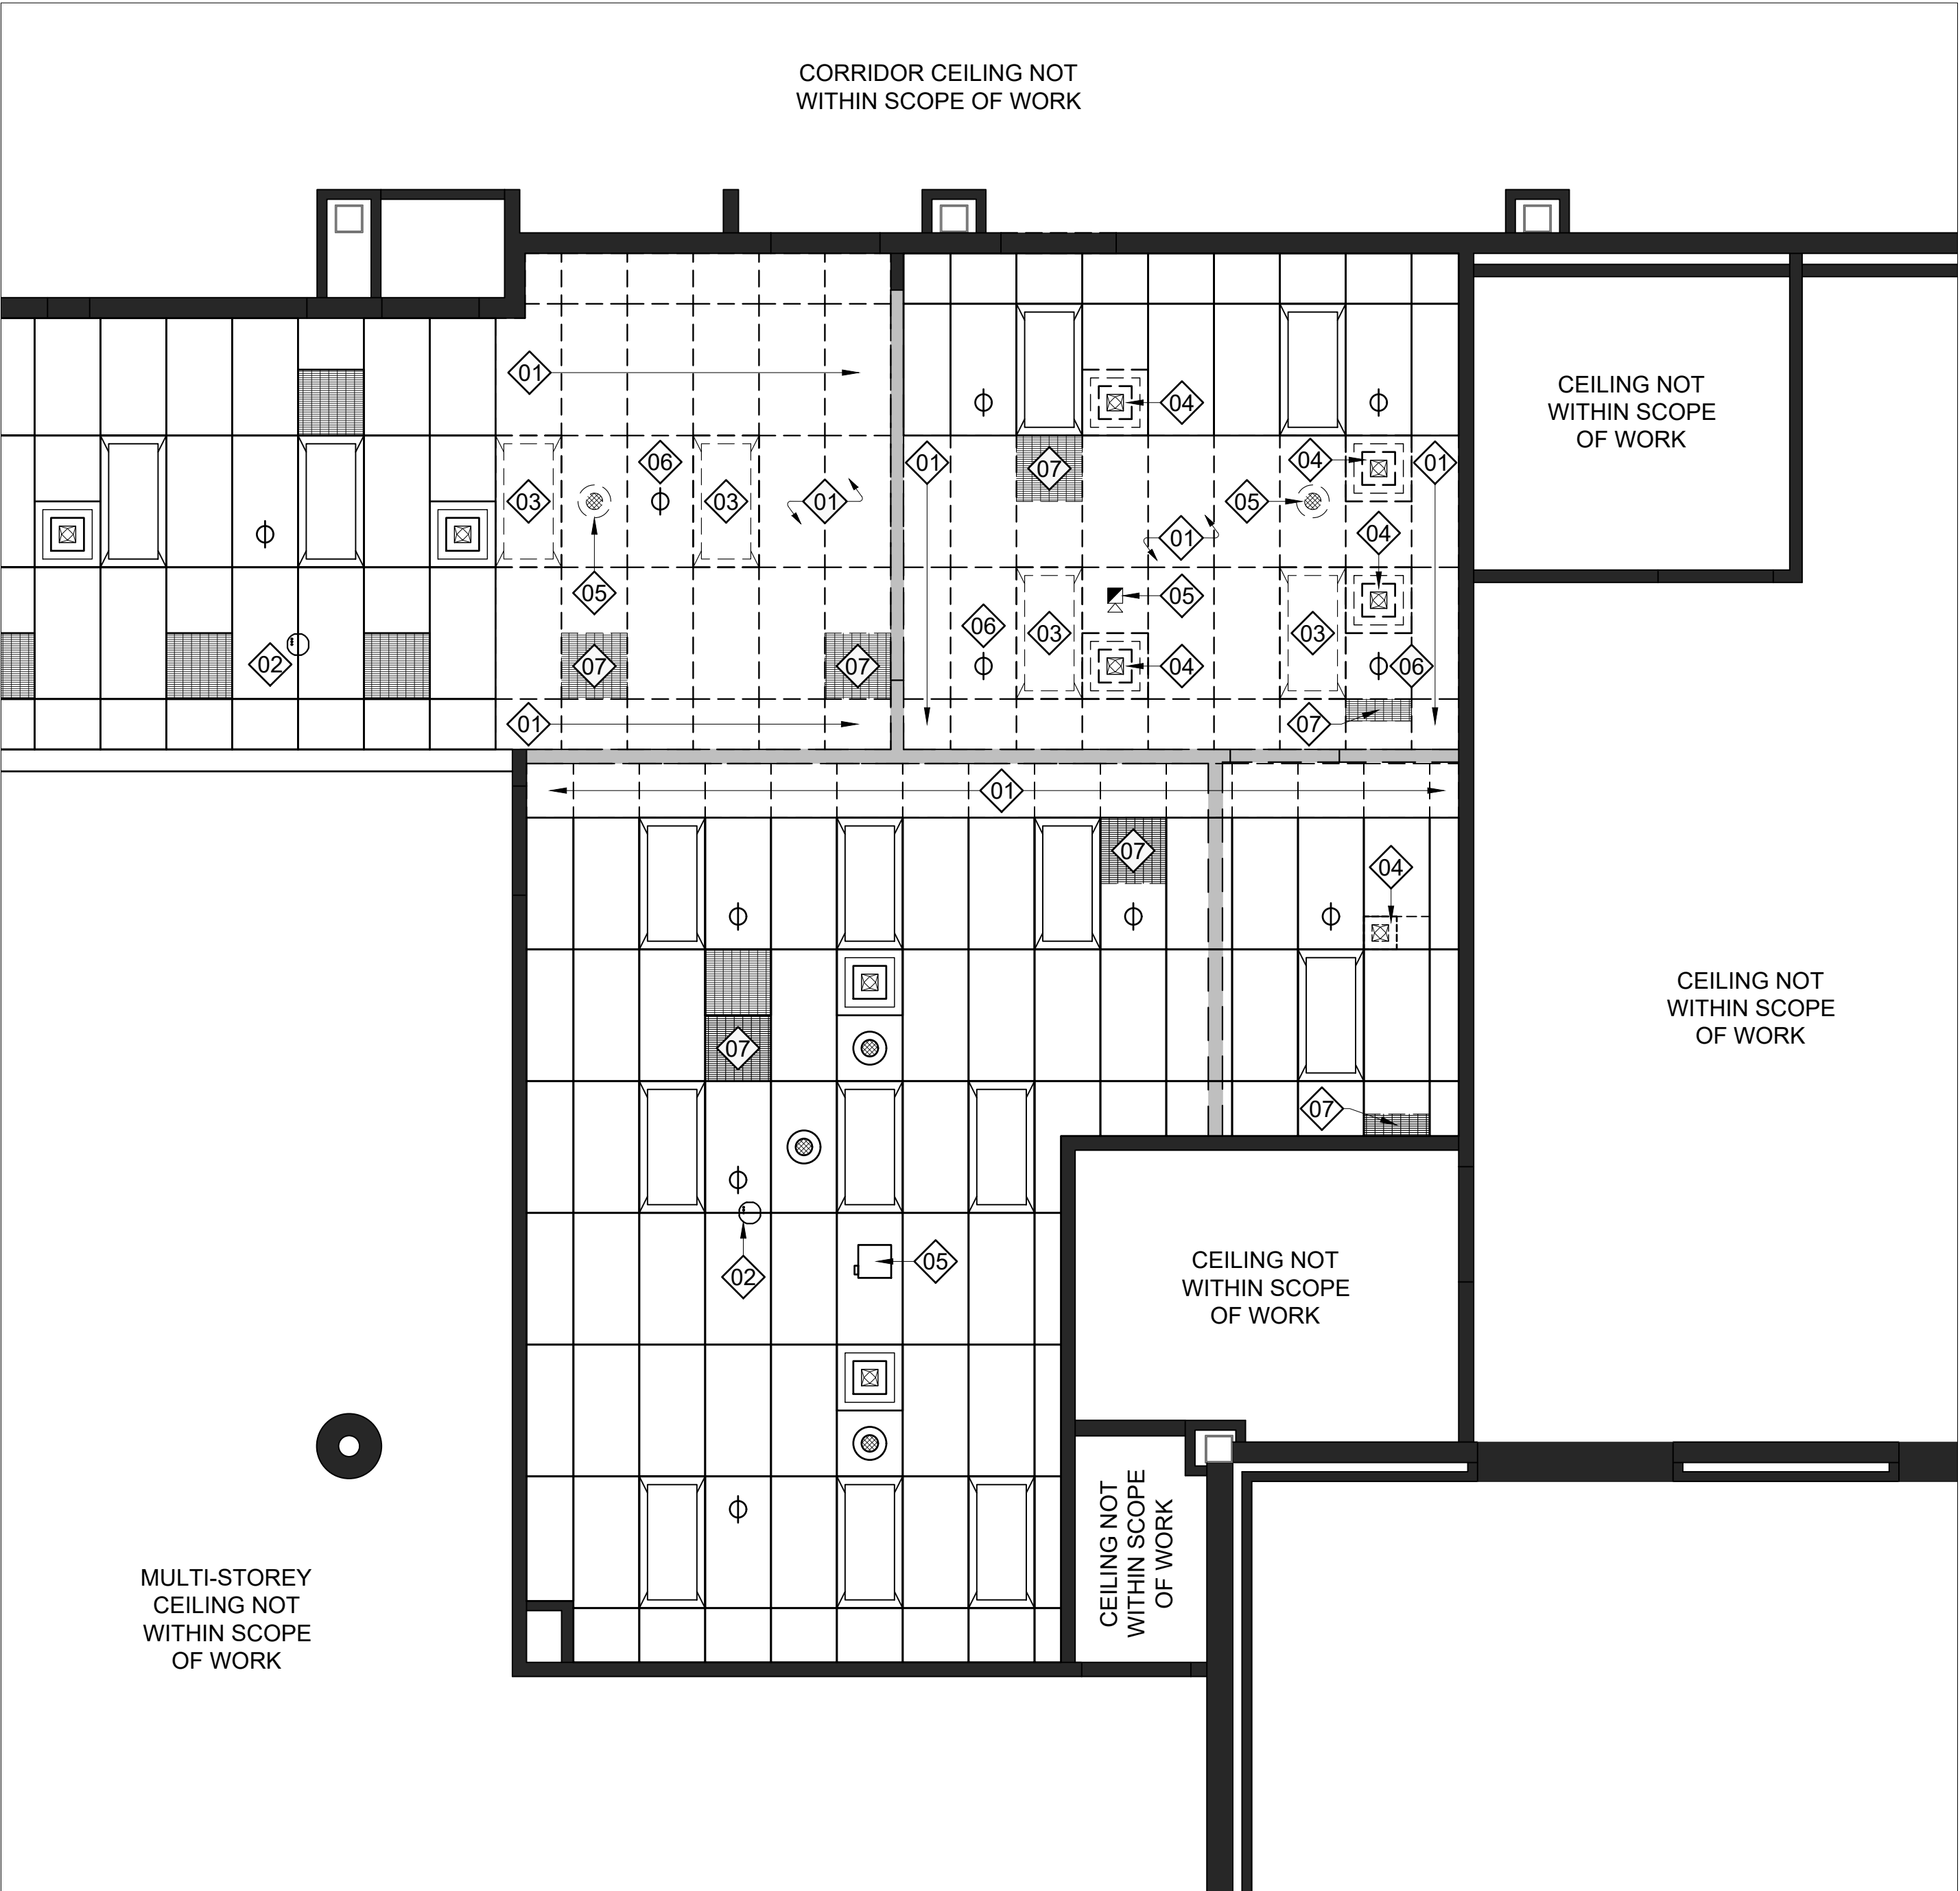

1

DEMOLITION REFLECTED CEILING PLAN
SINCLAIR SS- SECOND FLOOR

1/4" = 1'-0"

2

PROPOSED REFLECTED CEILING PLAN
SINCLAIR SS- SECOND FLOOR

1/4" = 1'-0"

PROJECT:

**Sinclair SS PLP Classroom
Alterations**

Project No: T25-51

Scale: AS NOTED

Drawn by: Iain Meldrum

Checked by: Chris Thaler

Address: 380 Taunton Rd E, Whitby, ON L1R 2K5

TITLE:


**DEMOLITION & PROPOSED REFLECTED
CEILING PLANS**

DRAWING No:



SK2

DOOR SCHEDULE																
TAG NUMBER	STATUS				DOOR FRAME					DOOR					MISCELLANEOUS	
	LEFT HAND	RIGHT HAND	ORIGIN	DESTINATION	WIDTH	HEIGHT	MATERIAL	SIDELITE	PAINT	WIDTH	HEIGHT	MATERIAL	HARDWARE	GLASS	DWG #	NOTES
D 01	●		A/V ROOM - 2212D	LAN - 2213 / CORR.	EXIST.	EXIST.	HM	NO	YES	EXIST.	EXIST.	EX - P/LAM	EXISTING	EX - x2 VISION P.	NA	UNINSTALL EXISTING FRAME, DOOR, GLAZING, & HARDWARE. INCLUDING ANY DOOR STOP. RELOCATE & REINSTALL ALL COMPONENTS TO NEW LOCATION AS PER SCHEDULE.
D 02		●	LAN - 2212F	REMOVE	EXIST	EXIST	HM	SCREEN	NO	EXIST	EXIST	EX - P/LAM	EXISTING	NO	NA	UNINSTALL EXISTING FRAME, DOOR, GLAZING, & HARDWARE. INCLUDING ANY DOOR STOP. TURN OVER TO DDSB.
D 03		●	STORAGE - 2212G	LAN - 2213 / PLP - 2215	EXIST	EXIST	HM	NO	YES	EXIST	EXIST	EX - P/LAM	EXISTING	NO	NA	UNINSTALL EXISTING FRAME, DOOR, GLAZING, & HARDWARE. INCLUDING ANY DOOR STOP. RELOCATE & REINSTALL ALL COMPONENTS TO NEW LOCATION AS PER SCHEDULE.

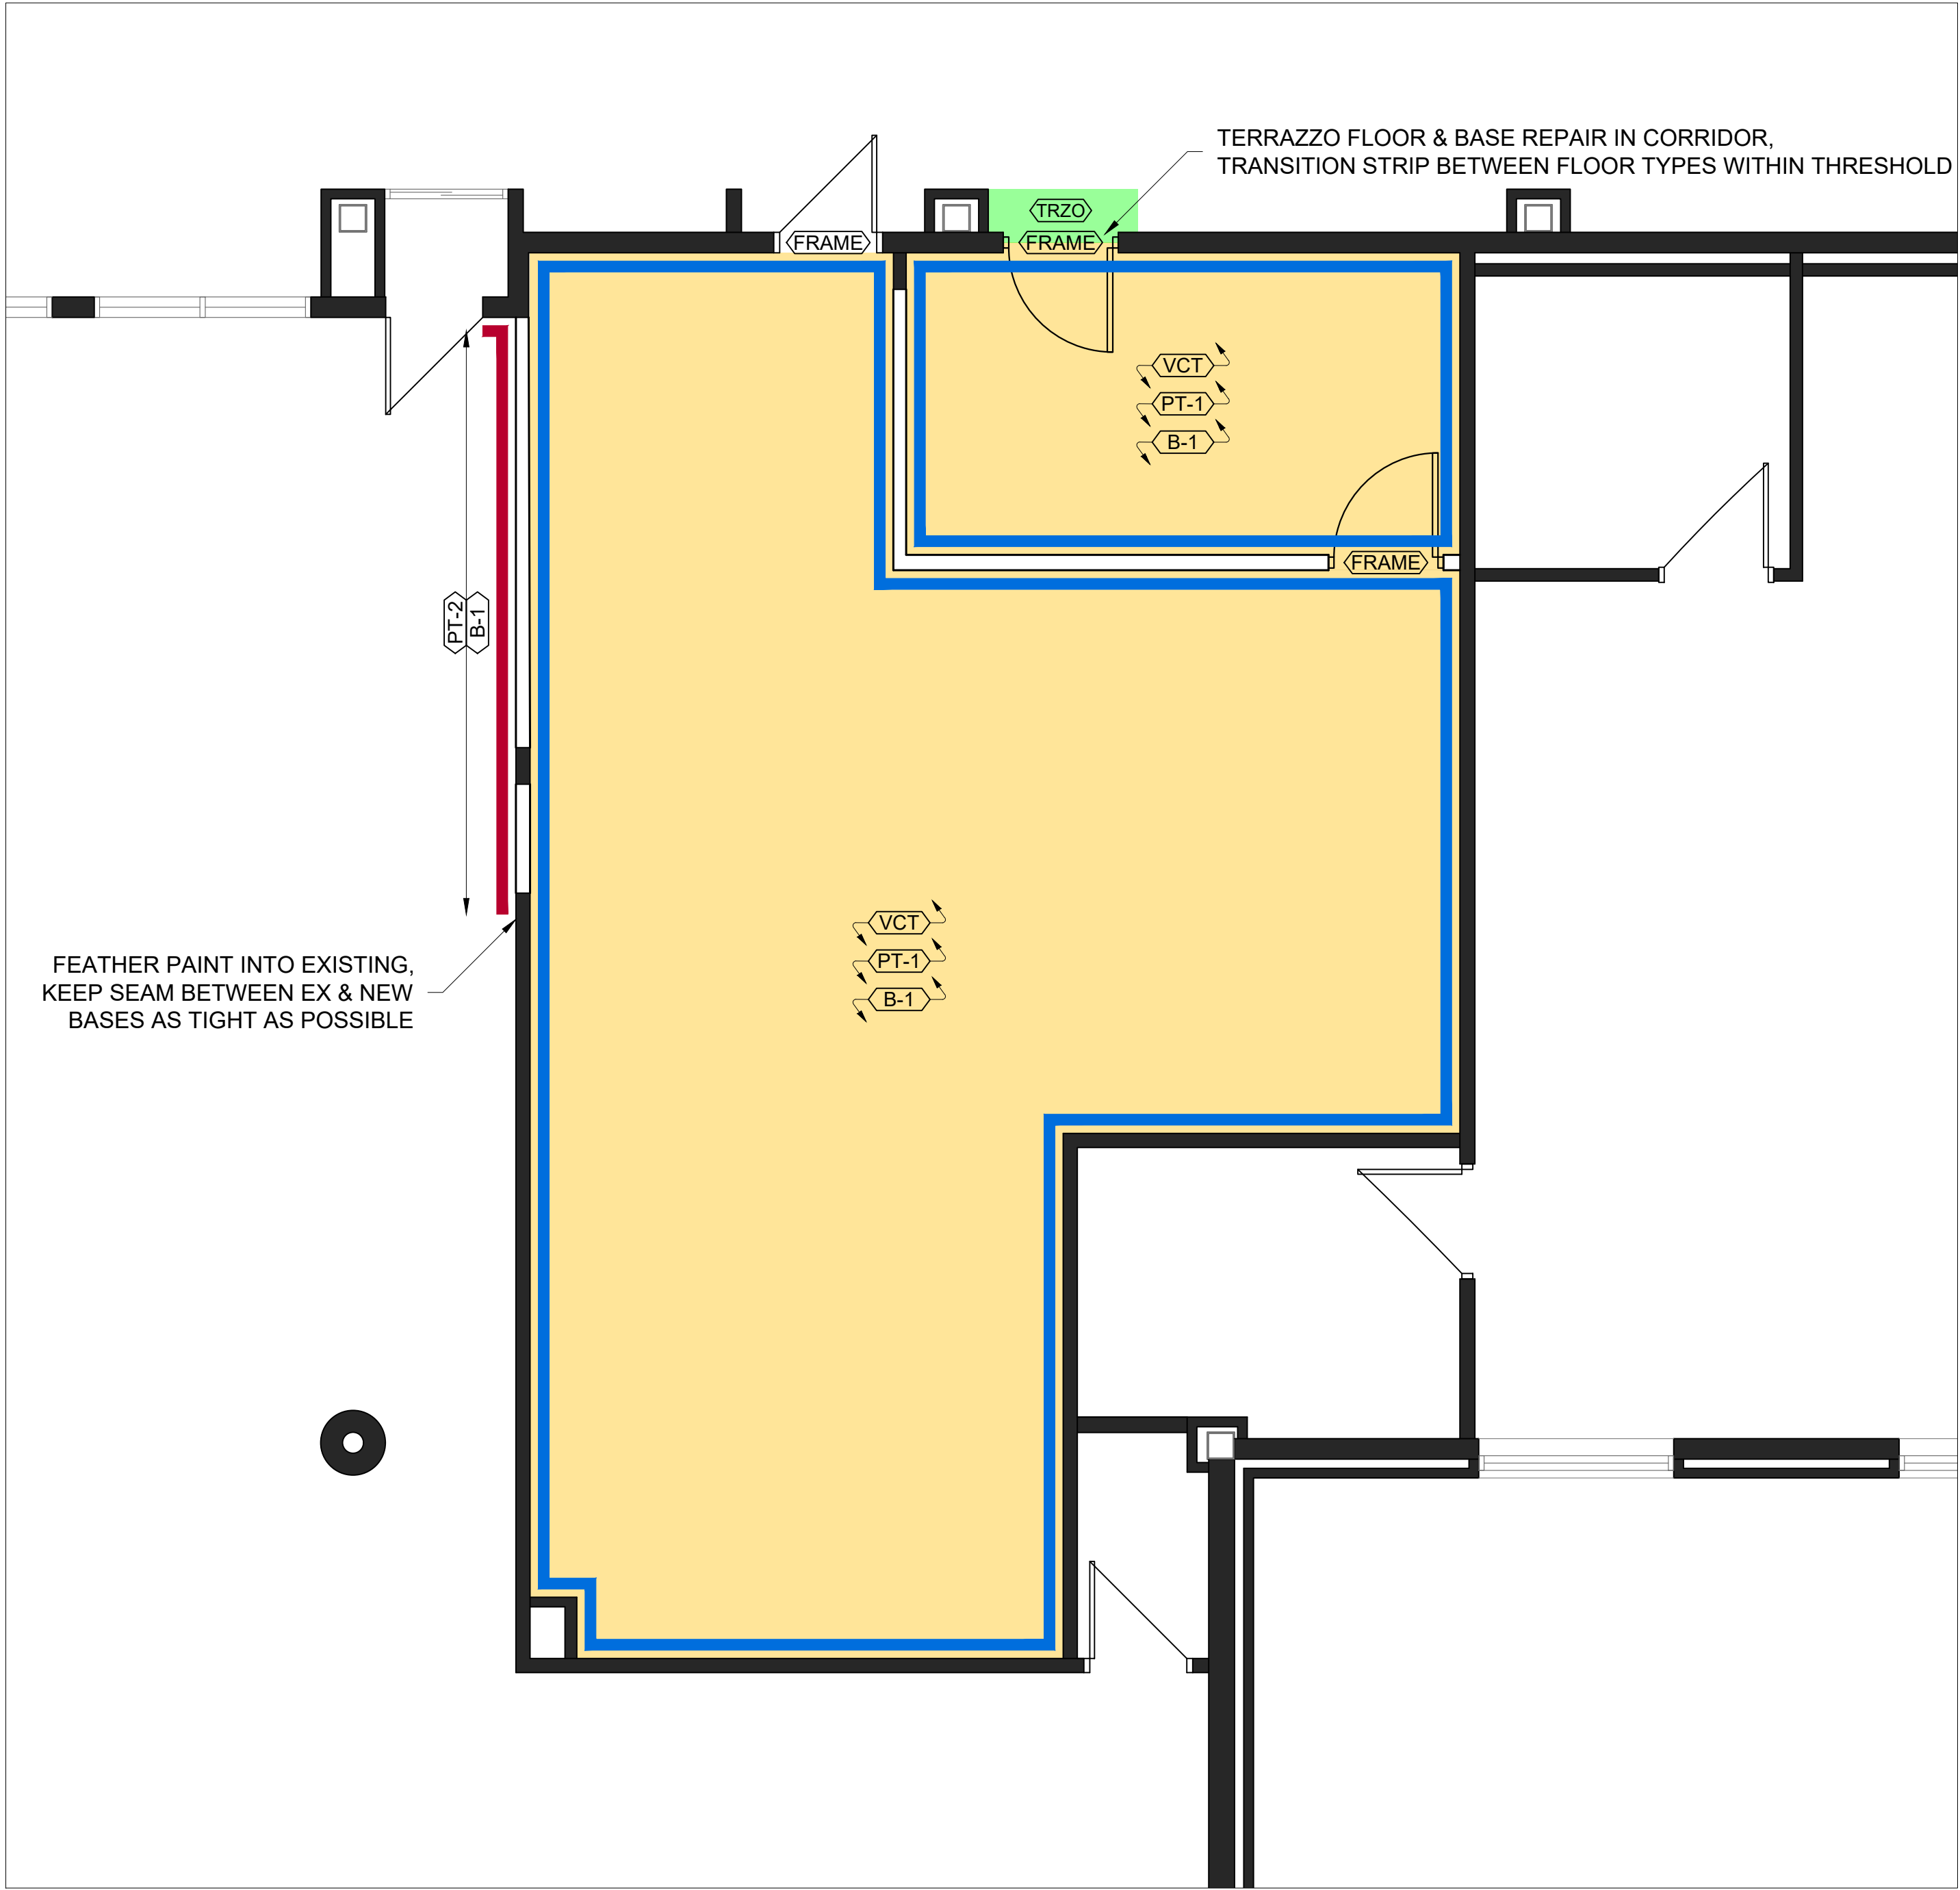

FLOORING FINISHES		
VCT	WARM SOFT GRAY [51861] FROM ARMSTRONG*	
TERRAZZO	TERRAZZO FLOOR REPAIR. COLOUR MATCH TO EXISTING SURROUNDING TERRAZZO.	
*OR APPROVED ALTERNATE		


PAINT FINISHES		
PT 1	COLOUR TO BE DETERMINED BY THE <i>DDSB PROJECT SUPERVISOR*</i>	
PT 2	COLOUR MATCH SURROUNDING & BLEND EDGES OF NEW & EXISTING	
FRAME	COLOUR MATCH SURROUNDING DOORS, BLUE	
<i>*OR APPROVED ALTERNATE</i>		

BASEBOARD FINISHES	
B - 1	BLACK [40] 4" RUBBER BY JOHNSONITE*
TRZO	MATCH, OR REUSE, EXISTING TERRAZZO TILE BASE*
*OR APPROVED ALTERNATE	

CEILING FINISHES	
ACT	<p>ACOUSTIC PANELS: NON FIRE RATED CEILINGS TO CAN/CGSB-92.1 TYPE: MINERAL COMPOSITION & SAG RESISTANT. PATTERN: NON-DIRECTIONAL FISSURES. EDGE TYPE: SQUARE. COLOUR: WHITE. SIZE: 16mm MINIMUM THICKNESS, 610mm X 1220mm. SHAPE: RECTANGLE. ACCEPTABLE PRODUCTS*:</p> <ol style="list-style-type: none"> 1. <i>ARMSTRONG WORLD INDUSTRIES CANADA LTD.:</i> FINE FISSURED 1729. 2. <i>CERTAINTED CEILINGS:</i> FINE FISSURED HHF-497 HNRXC. 3. <i>CGC INC:</i> RADAR 2410.
GRID	<p>TYPE 1 (T-BAR - 1) TWO DIRECTIONAL EXPOSED TEE-BAR GRID, DOUBLE WEB. ARMSTRONG WORLD INDUSTRIES CANADA LTD: PRELUDE XL EXPOSED TEE SYSTEM* COLOUR: <i>NATURAL ALUMINUM</i></p>
*OR APPROVED ALTERNATE	

01	CHANGE TO WALL COMPOSITION, + BLIND SPECS	IM	20/MAR/2025
No.	DESCRIPTION	BY	DATE
REVISIONS / STATUS			

These drawings were prepared by the *Durham District School Board*, referred to as DDSB or The Board throughout, and are intended to be used for the purpose of completing alterations on one of its properties.

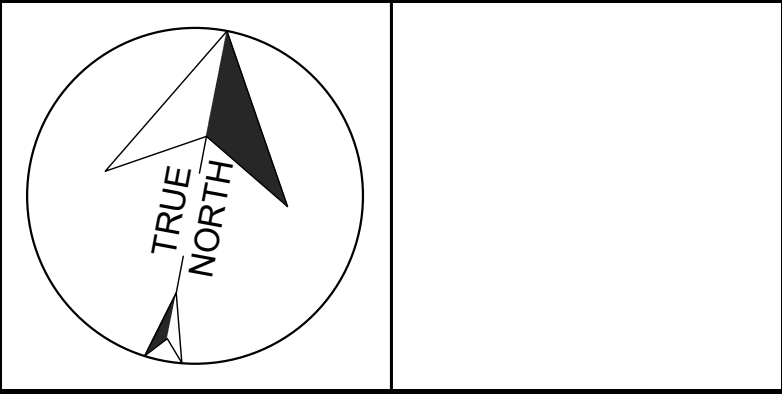

PROJECT:	
Sinclair SS PLP Classroom Alterations	
Project No: T25-1	
Scale:	AS NOTED
Drawn by:	Iain Meldrum
Checked by:	Chris Thaler
Address:	380 Taunton Rd E, Whitby, ON L1R 2K5
TITLE:	
DOOR & FINISH SCHEDULE	
	DRAWING No:
	SK3