

THE REGIONAL MUNICIPALITY OF DURHAM

AECOM

WORKS DEPARTMENT DESIGN, CONSTRUCTION & ASSET MANAGEMENT

Q-303-2020-A-007 OSHAWA WATER SUPPLY PLANT SEDIMENT TANK WALL REPAIR

1540 RITSON RD S, OSHAWA, ON L1J 3M3



DRAWING INDEX

STRUCTURAL **GENERAL NOTES** TYPICAL DETAILS PLAN AND ELEVATION **REMOVAL-**

> REMOVAL AND **REINSTATEMENT-**

DETAIL

PLAN AND ELEVATION

SHEET NO.

FACILITY CODE

WSP-0-001 WSP-E28-0010 FACILITIES PROJECT NO. CONTRACT NO. WSP-0-001-20-01 Q-303-2020-A-007

GENERAL NOTES

- CHECK AND VERIFY ALL EXISTING SITE DIMENSIONS AND DETAILS AND REPORT ANY DISCREPANCIES TO THE CONSULTANT PRIOR TO PROCEEDING WITH THE WORK.
- 2. SCAN EXISTING CONCRETE SLAB AND WALLS AND LOCATE UTILITIES PRIOR TO CONSTRUCTION. DOCUMENT AND SUBMIT LOCATION OF UTILITIES TO THE CONSULTANT AND OWNER'S REPRESENTATIVE FOR REVIEW.
- 3. ANY DAMAGE TO EXISTING STRUCTURES, SERVICES, AND UTILITIES DURING CONSTRUCTION SHALL BE REPAIRED BY THE CONTRACTOR TO THE SATISFACTION OF THE OWNER AND AT NO COST TO THE PROJECT.
- 4. SMOOTH AND EVEN FINISHED SHALL BE APPLIED TO ALL CONCRETE REPAIR SURFACES.

CLASS OF CONCRETE

1. ALL CONCRETE 35 MPa, EXPOSURE CLASS C-1

SCOPE OF REHABILITATION WORK

- INSTALL, MAINTAIN, AND CONTROL TEMPORARY TRAFFIC SYSTEM DURING CONSTRUCTION. PROVIDE AS REQUIRED ALL TRAFFIC PROTECTION AND BARRIER TO DELINEATE THE CONSTRUCTION AREA FROM THE SURFACE DRIVE AISLE AND LOADING AREA.
- 2. INSTALL AND MAINTAIN WORK AREA AT FACILITY, TO CONTROL DUST, SLURRY, AND SURFACE RUN OFF DURING THE WORK AS REQUIRED.
- 3. EXCAVATE AND REINSTATE THE PERIMETER EMBANKMENT SOIL AT AREAS OF REPAIR AS REQUIRED. REMOVE AND REINSTATE THE PERIMETER WALL BUILDING ASSEMBLY SYSTEM (CLADDING, INSULATION, POLYETHYLENE SHEET AND GIRTS) TO EXPOSE THE EXISTING CONCRETE WALL SURFACE WHERE INDICATED ON THE DRAWINGS.
- 4. PREPARE AND INJECT ALL LEAKING AND NON-LEAKING STRUCTURAL CRACKS.
- 5. REPLACE ALL DAMAGED, MISSING, OR SEVERELY CORRODED REINFORCING STEEL.
 EXISTING TOP REINFORCING STEEL EXPOSED DURING CONCRETE REMOVAL SHALL BE
 ABRASIVE BLAST CLEAN AND FREE OF LAITEN CONCRETE AND CORROSION.
- 6. REMOVE AND REPAIR ALL UNSOUND/ DELAMINATED CONCRETE AREAS (SURFACE,

REINFORCING STEEL

- 1. REINFORCING STEEL SHALL BE GRADE 400W, UNLESS OTHERWISE SPECIFIED.
- 2. UNLESS SHOWN OTHERWISE TENSION LAP SPLICES SHALL BE CLASS B.

CONSTRUCTION NOTES

- 1. IT IS THE RESPONSIBILITY OF THE CONTRACTOR TO INFORM THEMSELVES OF THE EXACT LOCATION OF, AND ASSUME ALL LIABILITY FOR DAMAGE TO ALL UTILITIES, SERVICES AND STRUCTURES WHETHER ABOVE GROUND OR BELOW GRADE BEFORE COMMENCING THE WORK. SUCH INFORMATION IS NOT NECESSARILY SHOWN ON THE DRAWING, AND WHERE SHOWN, THE ACCURACY CANNOT BE GUARANTEED.
- 2. NO ELEVATION INDICATED OR ASSUMED HEREON IS TO BE USED AS A REFERENCE ELEVATION FOR
- 3. SAWCUTS IN CONCRETE, WHERE DESIGNATED, SHALL BE 1" (25mm) DEEP OR TO FIRST LAYER OF REINFORCING STEEL. WHICHEVER IS LESS.
- 4. THE CONTRACTOR SHALL VERIFY ALL DIMENSIONS OF THE EXISTING WORK AND DETAILS ON THE SITE AGAINST THE PREPARED WORK AND REPORT ANY DISCREPANCIES TO THE ENGINEER BEFORE PROCEEDING WITH THE WORK.
- 5. ALL CONCRETE TO BE REMOVED BY HAND CHIPPING. ALL REBAR SHOULD NOT BE DAMAGED. ANY REBAR DAMAGED BY THE CONTRACTOR IS TO BE REPLACED BY THE CONTRACTOR AT NO COST TO THE CLIENT. SEVERELY CORRODED REBAR SHALL BE REPORTED TO THE ENGINEER.
- 6. FOR ALL REPAIRS, CONTRACTOR TO STORE ALL EQUIPMENT, SUPPLIES, MATERIAL WITHIN HOARDING AREA OR REMOVED OFF SITE DAILY.
- 7. PROVIDE ADEQUATE PROTECTION AND ACCESS FOR ENGINEER TO INSPECT THE REPAIR WORK DURING CONSTRUCTION AND AT COMPLETION.
- 8. UTILITIES ARE TO BE TEMPORARILY RELOCATED AND PROTECTED AS REQUIRED. CONTRACTOR TO CONFIRM WITH THE OWNER PRIOR TO ANY UTILITIES WORK.

REFERENCE DRAWINGS

 DETAILS OF THE EXISTING STRUCTURE HAVE BEEN DERIVED FROM DRAWINGS PREPARED BY THE REGIONAL MUNICIPALITY OF DURHAM - WORKS DEPARTMENT DESIGN, CONSTRUCTION AND ASSET MANAGEMENT DATED 1953.


LEGEND

EL. DENOTES ELEVATION
N.T.S. DENOTES NOT TO SCALE
N. DENOTES NORTH
S. DENOTES SOUTH

APPLICABLE MTO STANDARD DRAWINGS AND SPECIFICATIONS

OPSS 902	EXCAVATING AND BACKFILLING - STRUCTURES
OPSS 905	STEEL REINFORCEMENT FOR CONCRETE
OPSS 928	STRUCTURE REHABILITATION - CONCRETE REMOVAL
OPSS 929	ABRASIVE BLAST CLEANING - CONCRETE CONSTRUCTION
OPSS 930	STRUCURE REHABILITATION - CONCRETE PATCHES AND OVERLAYS

ALL MEASUREMENTS ARE TO BE VERIFIED BY THE CONTRACTOR ON SITE AND ANY DISCREPANCIES ARE TO BE REPORTED BEFORE PROCEEDING WITH THE WORK. THE REGION OF DURHAM ASSUMES NO RESPONSIBILITY FOR THE ACCURACY OF THE LOCATION OF EXISTING SERVICES AS INDICATED ON THIS DRAWING. DO NOT SCALE DRAWINGS.

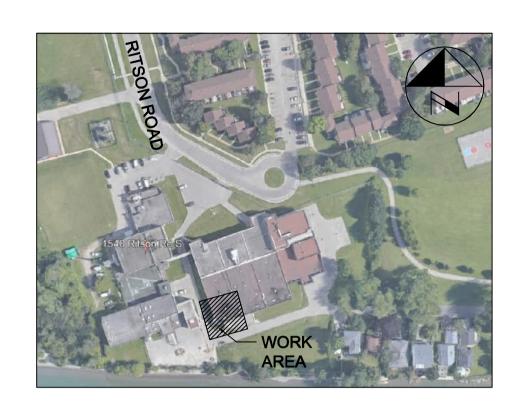

<u>KEY PLAN</u>

NO. DATE NAME REVISIONS

PRIME CONSULTANT





SUB-CONSULTANT

DESIGN BY: — Y.H.

DRAWN BY: — A.C.

DATE: 2022—09—23

CHECKED BY: — H.H.

CONSULTANT PROJECT NO. 60642850

APPROVED BY: — K.D.

QUOTE NO.
Q—303—2020—A—007—DCAM

1 22/09/23 ACL ISSUED FOR TENDER

0 21/04/13 ACL 90% DESIGN SUBMISSION

NO. DATE NAME REVISIONS



THE REGIONAL MUNICIPALITY OF DURHAM

WORKS DEPARTMENT


DESIGN, CONSTRUCTION & ASSET MANAGEMENT

OSHAWA WATER SUPPLY PLANT SEDIMENT TANK WALL REPAIR

GENERAL NOTES

WSP-E28-0010	WSP-0-001	WSP-0-001-20-0
CONTRACT NO.	DRAWING NO.	SHEET NO.
Q-303-2020-A-007	S-001	01 OF 05




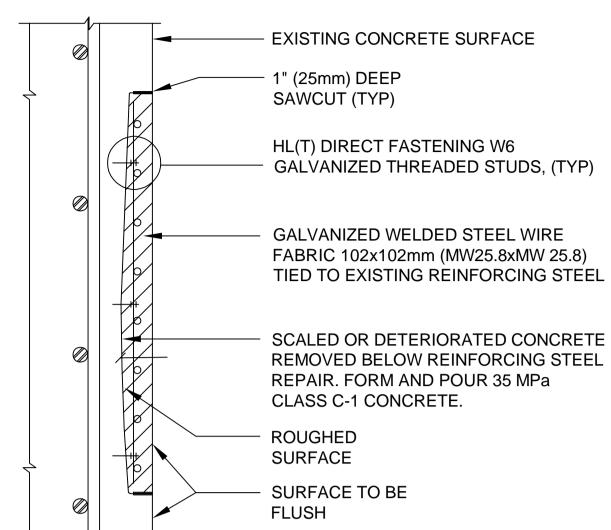

LOCAL CONCRETE REPAIR
DETAIL FOR EXISTING
REBAR NOT EXPOSED



- 1. CONFORM TO OPSD 932.
- 2. SAW CUT PERIMETER TO A DEPTH OF 1" (25mm) OR TO TOP LAYER OF REINFORCING STEEL (WHICHEVER IS LESS).
- 3. CHIP AND REMOVE ALL LOOSE AND DETERIORATED CONCRETE TO A MINIMUM DEPTH OF 1" (25mm) BELOW TOP LAYER OF REBAR.
- 4. RE-TIE OR WELD EXPOSED REINFORCING STEEL AS REQUIRED.
 REINFORCE BADLY CORRODED OR DAMAGED REINFORCING STEEL OR
 BARS AS DIRECTED.
- 5. ABRASIVE BLAST CLEAN CONCRETE AND REINFORCING STEEL PRIOR TO PLACEMENT OF NEW CONRETE.
- 6. PLACE WELDED STEEL WIRE FABRIC OF 102X102mm (MW 5.6x MW 5.6) CSA SPEC G30.6.
- 7. COAT CONCRETE AND EXPOSED REINFORCING STEEL WITH BONDING AGENT.
- 8. SUPPLY, PLACE, FINISH AND CURE 35 MPa LOW-SHRINK CONCRETE (10 mm MAX. SIZE AGGREGATE).
- 9. SUPPLY, PLACE, FINISH AND CURE REPAIR MORTAR FOR VERTICAL SURFACE REPAIRS.
- 10. REMOVE FORMWORK.

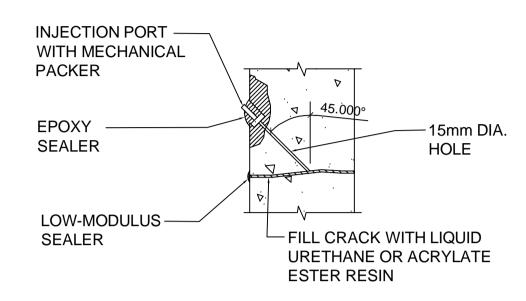

CRACK INJECTION DETAIL

N.T.S.

CRACK INJECTION NOTES

- 1. CONFORM TO OPSS 932.
- 2. REMOVE LOOSE MATERIAL FROM CRACK.
- 3. DRILL 15mm DIA. INJECTION PORTS AT 45° ANGLE TO CRACK, AT 300mm c/c ALTERNATING SIDES.
- 4. INSTALL MECHANICAL PACKER IN INJECTION PORT.
- 5. SEAL SURFACE OF CRACK WITH LOW-MODULUS GEL IF CRACK IS ACTIVELY LEAKING.
- 6. FLUSH CRACK WITH CLEAN WATER.
- 7. FLUSH CRACK WITH AIR TO REMOVE ALL OF THE FREE WATER.
- 8. INJECT LIQUID URETHANE OR ACRYLATE ESTER RESIN INTO LOWEST MECHANICAL PACKER WITH HAND OPERATED HYDRAULIC PUMP UNTIL GROUT CAN BE SEEN AT THE NEXT INJECTION PORT UP.
- 9. REPEAT PROCESS UNTIL ENTIRE CRACK IS INJECTED.
- 10. RE-GROUTING MAY BE PERFORMED FOR UP TO A WEEK AFTER INITIAL GROUTING.
- 11. REMOVE INJECTION PORT, GRIND SMOOTH AND RE-PATCH TO MATCH EXISTING CONCRETE SURFACE.

ALL MEASUREMENTS ARE TO BE VERIFIED BY THE CONTRACTOR ON SITE AND ANY DISCREPANCIES ARE TO BE REPORTED BEFORE PROCEEDING WITH THE WORK. THE REGION OF DURHAM ASSUMES NO RESPONSIBILITY FOR THE ACCURACY OF THE LOCATION OF EXISTING SERVICES AS INDICATED ON THIS DRAWING. DO NOT SCALE DRAWINGS.



<u>KEY PLAN</u>

NO. DATE NAME REVISIONS

PRIME CONSULTANT





SUB-CONSULTANT

DESIGN BY: — Y.H.

DRAWN BY: — A.C.

DATE: 2022—09—23

CHECKED BY: — H.H.

CONSULTANT PROJECT NO. 60642850

APPROVED BY: — K.D.

QUOTE NO.
Q—303—2020—A—007—DCAM

1 22/09/23 ACL ISSUED FOR TENDER

0 21/04/13 ACL 90% DESIGN SUBMISSION

NO. DATE NAME

REVISIONS



THE REGIONAL MUNICIPALITY OF DURHAM

WORKS DEPARTMENT

DESIGN, CONSTRUCTION & ASSET MANAGEMENT

OSHAWA WATER SUPPLY PLANT SEDIMENT TANK WALL REPAIR

TYPICAL DETAILS

PROPERTY NO. WSP-E28-0010 WSP-O-001 FACILITY CODE WSP-O-001-20-01 CONTRACT NO. DRAWING NO. SHEET NO. Q-303-2020-A-007 S-002 02 OF 05

ALL MEASUREMENTS ARE TO BE VERIFIED BY THE CONTRACTOR



NO. DATE NAME REVISIONS

AECOM



SUB-CONSULTANT

PRIME CONSULTANT

	DESIGN BY: - Y.H. DRAWN BY: - A.C. CHECKED BY: - H.H. APPROVED BY: - K.D.			′.H.		scale — AS NOTED	
				۸.C.		DATE: 2022-09-23	
				н.н.		CONSULTANT PROJECT NO. 60642850	
				(.D.		QUOTE NO. Q-303-2020-A-007-DCAM	
	,						
	REVISIONS						
	EVIS						
	.						
	RAC						
	CONTRACT	1	22/09/23	ACL	ISSUED FOR	RTENDER	
	0	0	21/04/13	ACL	90% DESIGN	N SUBMISSION	



THE REGIONAL MUNICIPALITY OF DURHAM


REVISIONS

WORKS DEPARTMENT

DESIGN, CONSTRUCTION & ASSET MANAGEMENT

OSHAWA WATER SUPPLY PLANT SEDIMENT TANK WALL REPAIR EXISTING CONDITION-PLAN AND ELEVATION

PROPERTY NO. WSP-E28-0010	FACILITY CODE WSP-0-001	FACILITIES PROJECT NO. WSP-0-001-20-0
CONTRACT NO.	DRAWING NO.	SHEET NO.
Q-303-2020-A-007	S-003	03 OF 05
	WSP-E28-0010 CONTRACT NO.	WSP-E28-0010 WSP-0-001

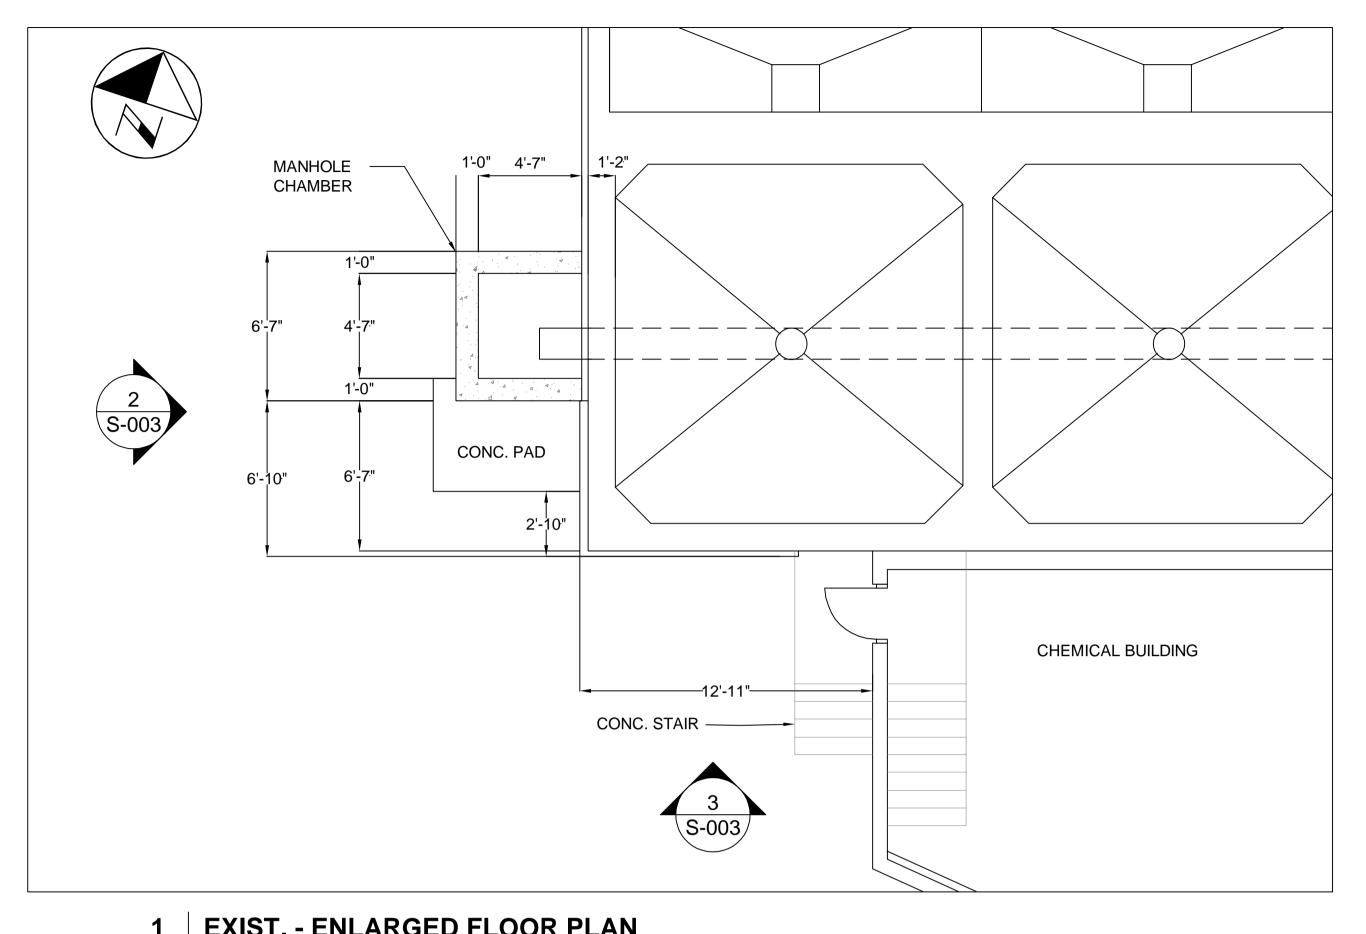

----4'-7"------3'-7"----4'-9"---TOP OF CHEMICAL **BUILDING ROOF** 17'-11" CHEMICAL BUILDING 1-1 INCH -CONDUCTS EL. 263.88 2 INCHES DEEP NO REBAR - 5-1 INCH CONDUCTS - RAILING — 1 ½ INCH DEEP NO REBAR CONC. PAD - CONC. STAIR – LEDGE WALL └─ EX. GRADING **VARIES**

EXIST. - SOUTH ELEVATION

EXIST. - ENLARGED FLOOR PLAN Scale: NTS

MANHOLE CHAMBER TOP ROOF CHEMICAL BUILDING (BEYOND) EL. 259.81 CONC. STAIR CONCRETE — 3 INCHES DEEP, CRACK NO REBAR CONDUCTS 2'-10" 1-1 INCH - LEDGE WALL CONDUCTS - GRADING - CONCRETE **VARIES** PAD 1 INCHES DEEP, NO REBAR

<u>LEGENDS</u>

SPALL

CONCRETE

DELAMINATION

CONCRETE CRACKS

NOTES:

1. REFER TO S-002 FOR TYPICAL CONCRETE REPAIR DETAILS.

2. THE CONTRACTOR TO REMOVE THE EXTERIOR WALL ASSEMBLY AS REQUIRED TO CONFIRM THE LOCATION OF CRACK REPAIRS DURING CONSTRUCTION AND TO BE CONFIRMED BY ENGINEER.


3. CONDUITS TO BE PROTECTED OR RELOCATED PRIOR TO CONCRETE REPAIR WORK. CONTRACTOR TO VERIFY SITE CONDITIONS PRIOR TO START OF CONSTRUCTION.

EXIST. - WEST ELEVATION

---12'-11"----


CONC. STAIR ———

1 REMOVAL - ENLARGED FLOOR PLAN
S-004 Scale: NTS

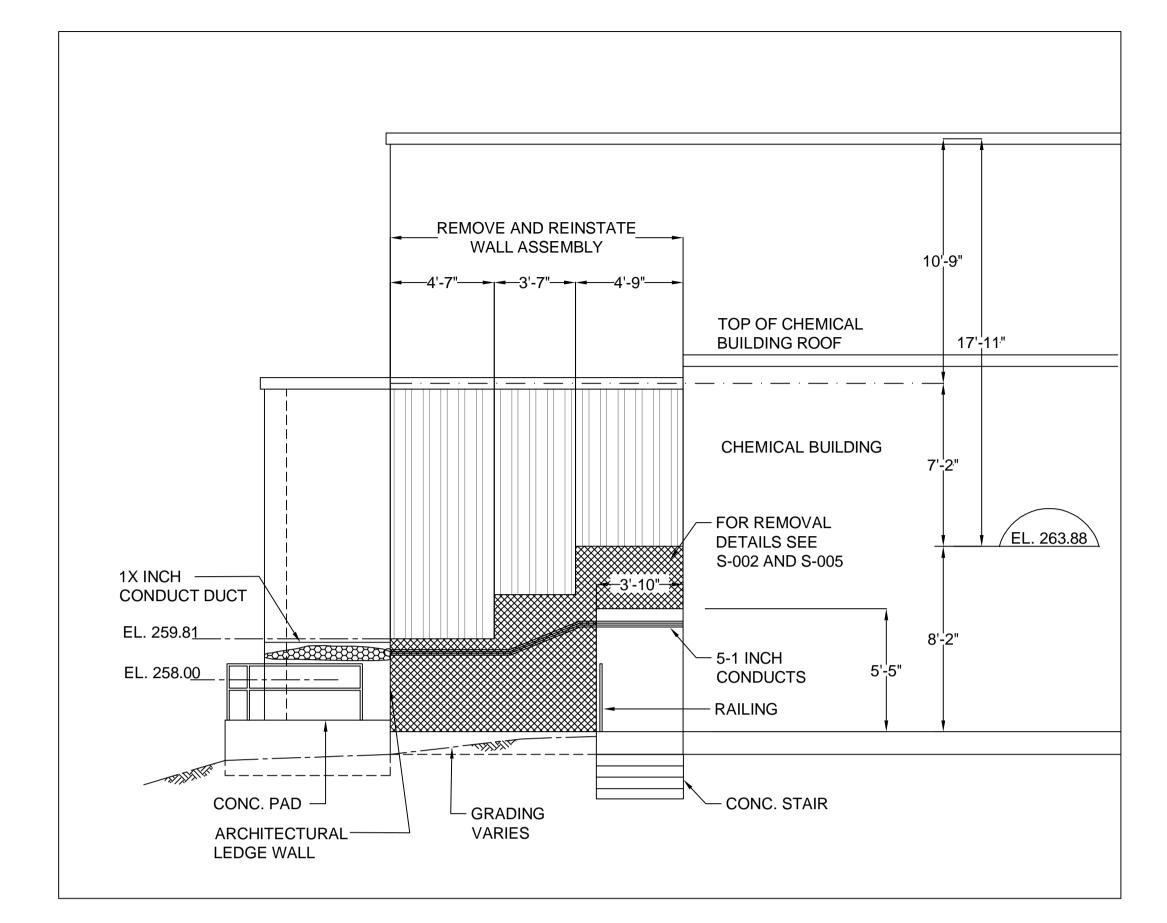

REMOVAL - SOUTH ELEVATION

Scale: NTS

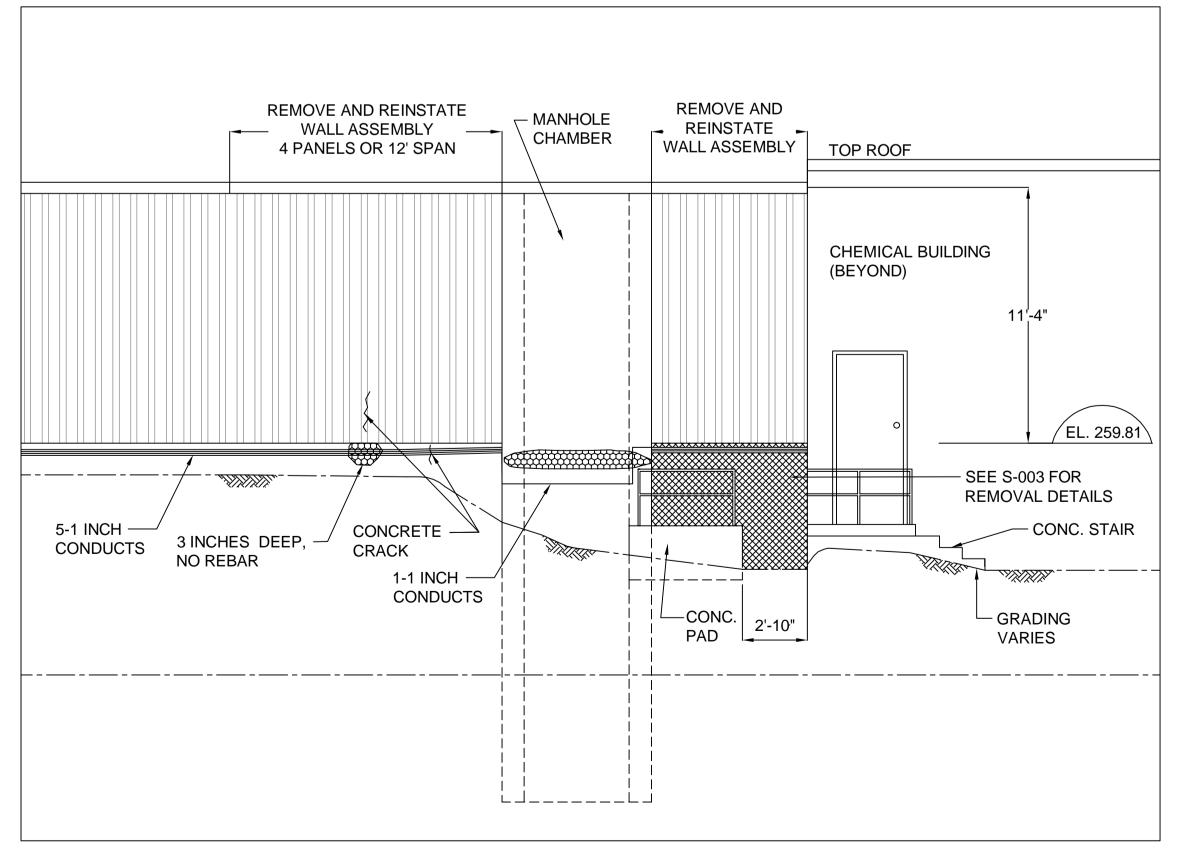

LEGENDS

CHEMICAL BUILDING

PARTIAL DEPTH REMOVAL


SP

CONCRETE CRACKS

NOTES:

- 1. REFER TO S-002 FOR TYPICAL CONCRETE REPAIR DETAILS.
- 2. THE CONTRACTOR TO REMOVE THE EXTERIOR WALL ASSEMBLY AS REQUIRED TO CONFIRM THE LOCATION OF CRACK REPAIRS DURING CONSTRUCTION AND TO BE CONFIRMED BY ENGINEER.
- 3. CONDUITS TO BE PROTECTED OR RELOCATED PRIOR TO CONCRETE REPAIR WORK. CONTRACTOR TO VERIFY SITE CONDITIONS PRIOR TO START OF CONSTRUCTION.
- 4. REMOVE AND REINSTATE THE EXISTING BUILDING ASSEMBLY (CLADDING, GIRTS, INSULATION, POLYETHYLENE SHEET) AS REQUIRED TO EXPOSE THE CONCRETE SURFACE. PREPARE AND INJECT ALL NON-LEAKING AND LEAKING STRUCTURAL CONCRETE CRACKS.

ALL MEASUREMENTS ARE TO BE VERIFIED BY THE CONTRACTOR ON SITE AND ANY DISCREPANCIES ARE TO BE REPORTED BEFORE PROCEEDING WITH THE WORK. THE REGION OF DURHAM ASSUMES NO RESPONSIBILITY FOR THE ACCURACY OF THE LOCATION OF EXISTING SERVICES AS INDICATED ON THIS DRAWING. DO NOT SCALE DRAWINGS.

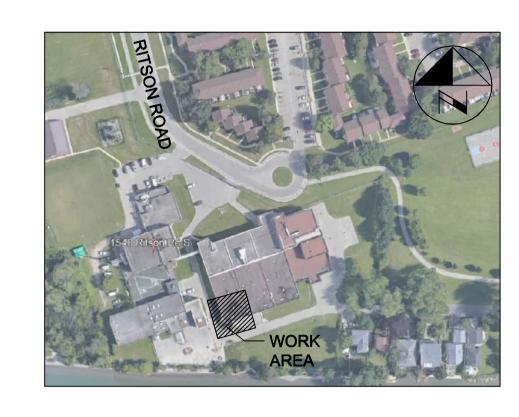

<u>KEY PLAN</u>

NO. DATE NAME REVISIONS

PRIME CONSULTANT

AECOM

ROFESSIONAL CHILD AND THE SEPT. 23,2022

SUB-CONSULTANT

DESIGN BY: — Y.H.

DRAWN BY: — A.C.

DATE: 2022—09—23

CHECKED BY: — H.H.

CONSULTANT PROJECT NO. 60642850

APPROVED BY: — K.D.

QUOTE NO.
Q—303—2020—A—007—DCAM

1 22/09/23 ACL ISSUED FOR TENDER

0 21/04/13 ACL 90% DESIGN SUBMISSION

NO. DATE NAME REVISIONS



THE REGIONAL MUNICIPALITY OF DURHAM

WORKS DEPARTMENT


DESIGN, CONSTRUCTION & ASSET MANAGEMENT


OSHAWA WATER SUPPLY PLANT SEDIMENT TANK WALL REPAIR REMOVAL — PLAN AND ELEVATION

PROPERTY NO. WSP-E28-0010 FACILITY CODE WSP-O-001 WSP-O-001-20-01 CONTRACT NO. DRAWING NO. SHEET NO. Q-303-2020-A-007 S- 004 04 0F 05

____3

REMOVAL - WEST ELEVATION

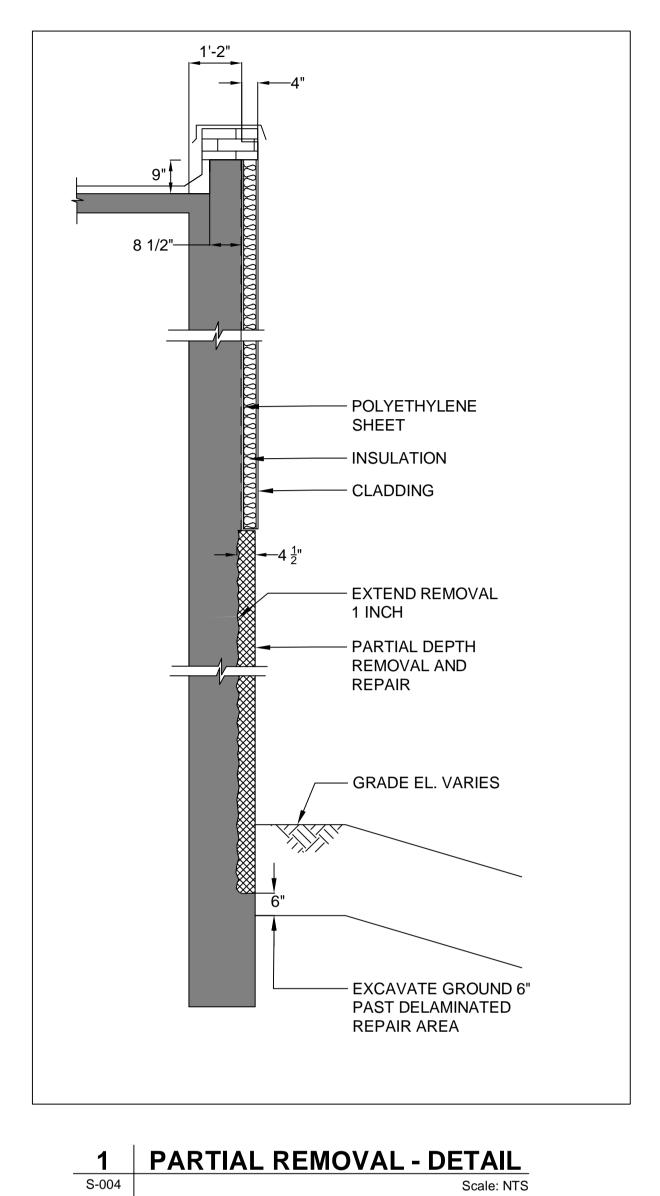

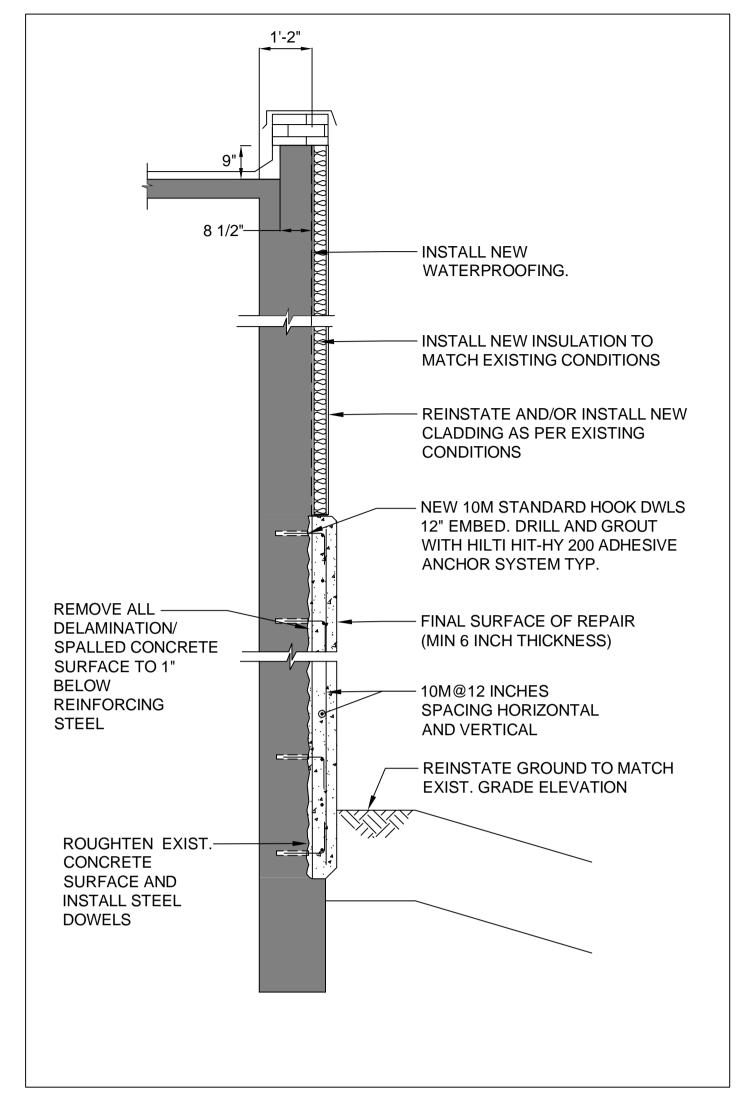


LEGENDS

PARTIAL REMOVAL

2 R

2 REINSTATEMENT - DETAIL
S-004 Scale: NTS

ALL MEASUREMENTS ARE TO BE VERIFIED BY THE CONTRACTOR ON SITE AND ANY DISCREPANCIES ARE TO BE REPORTED BEFORE PROCEEDING WITH THE WORK. THE REGION OF DURHAM ASSUMES NO RESPONSIBILITY FOR THE ACCURACY OF THE LOCATION OF EXISTING SERVICES AS INDICATED ON THIS DRAWING. DO NOT SCALE DRAWINGS.

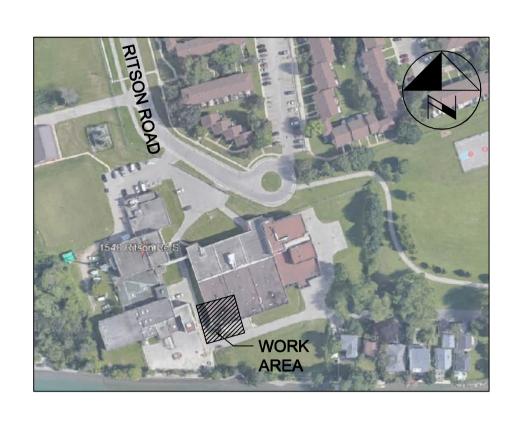

KEY PLAN

SONOIS NO. DATE NAME REVISIONS

PRIME CONSULTANT



K.T.D. DUONG 100055126
Sept.23,2022

SUB-CONSULTANT

	ESIGN	BY: Y	′.H.		scale — AS NOTED
0	DRAWN BY: — A.C.				DATE: 2022-09-23
C	CHECKED BY: — H.H.				CONSULTANT PROJECT NO. 60642850
A	APPROVED BY: - K.D.				QUOTE NO. Q-303-2020-A-007-DCAM
ONS					
REVISIONS					
1.					
RAC					
CONTRACT	1	22/09/23	ACL	ISSUED FOR	TENDER
Ŏ	0	21/04/13	ACL	90% DESIGN	SUBMISSION
	NO.	DATE	NAME	REVISIONS	



THE REGIONAL MUNICIPALITY
OF DURHAM

WORKS DEPARTMENT

DESIGN, CONSTRUCTION & ASSET MANAGEMENT

OSHAWA WATER SUPPLY PLANT SEDIMENT TANK WALL REPAIR REMOVAL AND REINSTATEMENT—DETAIL

WSP-E28-0010	WSP-0-001	WSP-0-001-20-01
CONTRACT NO.	DRAWING NO.	SHEET NO.
Q-303-2020-A-007	S- 005	05 OF 05