FI	XTURE SCHEDULE		
NOT	<u></u>		
1.	CONTRACTOR AND FIXTURE SUPPLIER ARE RESPONSIBLE TO F PLASTER AND FINISHING FRAMES, MOUNTING HARDWARE, AND TO SUIT ARCHITECTURAL CEILING SCHEDULE.		
2.	CONTRACTOR TO PROVIDE DIMMING SWITCHES THAT ARE COM THE SPECIFIED DIMMING DRIVERS.	PATIBLE	WITH
TYPE	DESCRIPTION	LAMPS	MTG
AA	2X2 LED LUMINAIRE C/W WHITE FLAT EDGE LIT PMMA DIFFUSER, EXTRUDED ALUMINUM FRAME, METAL BACK PLATE, MATTE WHITE POLYESTER POWDER COATING, 3500°K, 80CRI AND 0-10V DIMMING DRIVER.	3860 LUMEN LED @30W	RECESS T-BAR
	LITELINE CAT No. LEDP-22-WH-L-3530120 OR APPROVED EQUIVALENT BY LITHONIA, ECO POWER, C-LITE		
ΒA	1220mm LONG LED CHAIN HUNG STRIP LIGHT C/W DIFFUSED ACRYLIC LENS, BAKED WHITE ENAMEL FINISH, 3500% LAMPS AND 120V DRIVER	4000 LUMEN LED @31W	SURFACE / CHAIN HUNG
	SIGNIFY CAT. No. FSS440L835UNV + FKR-126 OR APPROVED EQUIVALENT BY COOPER, VISIONEERING, COLUMBIA		

LEG	END	
SYMBOL		мтант е *"
	FIRE ALARM BELL (150mm DIAMETER UNLESS OTHERWISE NOTED)	(*)
	HEAT DETECTOR - RATE OF RISE & FIXED TEMP	CEILING
	SMOKE DETECTOR	CEILING
	DUCT TYPE SMOKE DETECTOR	DUCT
•	FIXED TEMPERATURE HEAT	CEILING
S	FIRE ALARM STROBE LIGHT	*" (*)
□FS	FLOW SWITCH	
□PS	PRESSURE SWITCH	
ZESV	ELECTRICALLY SUPERVISED VALVE	
A	ALARM OUTLET	
CR	CARD READER	
DC	DOOR CONTACT	
DS	ELECTRIC DOOR STRIKE	
GT	GUARD TOUR	
KP	KEY PAD	
MD	MOTION DETECTOR	
<u>CCTV</u> ⊲	CLOSED CIRCUIT TELEVISION CAMERA	
Θ	DOOR SECURITY TAG	
CL	CEILING MOUNTED	
ED	EXTRA DUTY	
ER	EXISTING TO BE REMOVED	
EX	EXISTING TO REMAIN	
FR	FRIDGE	
GF	GROUND FAULT INTERRUPTING	
мw	MICROWAVE	
ос	OVER COUNTER	
РС	PHOTOCELL CONTROLLED	
REL	EXISTING TO BE RELOCATED	
REP	REPLACE EXISTING WITH NEW	
UC	UNDER COUNTER	
WP	WEATHER PROOF	
VR	VANDAL RESISTANT	
	ELECTRIC HEATER	
•	WIREMOLD - VERTICAL	
	WREMOLD - HORZONTAL	
	VANDAL RESISTANT	
[KP]	KEYPAD C/W 3/4" CONDUIT WITH PULL WIRE TO ACCESSIBLE CEILING	43 " (1100)
		(1100)

LEG		
	THIS LEGEND OF SYMBOLS REPRESENTS	
STAND	VANDERWESTEN RUTHERFORD ASSOCIATES INC. ARD/GENERIC LEGEND. ALL SYMBOLS MAY NOT APPEAR ON THE D	RAWINGS.
SYMBOL	DESCRIPTION	мта нт ф
	LIGHTING FIXTURE	AS NOTED
X	DOWNLIGHTING FIXTURE	AS NOTED
	CROSS-HATCHED OR SHADED LIGHTING FIXTURE SHALL INDICATE CONNECTED TO EMERGENCY (ESSENTIAL) POWER	
\$	15A, 125V SINGLE POLE SWITCH, $\$_2$ (TWO POLE), $\$_3$ (3-WAY), $\$_4$ (4-WAY), $\$_k$ (KEY OPERATED), $\$_D$ (DIMMER), $\$_{PL}$ (C/W PILOT LIGHT), $\$_{LV}$ (LOW VOLTAGE), $\$_T$ (TIMER), $\$_s$ (OCCUPANCY SENSOR SWITCH) \$ (SINGLE GANG), $$$ (DOUBLE GANG), $$$ (TRIPLE GANG), $\$$ (FOUR GANG), \ddagger (FIVE GANG), \ddagger (SIX GANG) a,b,c DESIGNATES SWITCHING	43" (1100)
\$ LVD	LOW VOLTAGE DIMMER SWITCH	43 " (1100)
۲	120V OCCUPANCY DUAL TECHNOLOGY SENSOR	CEILING
⊙→	120V OCCUPANCY DUAL TECHNOLOGY SENSOR	WALL OR CEILING
● _{LV}	LOW VOLTAGE OCCUPANCY DUAL TECHNOLOGY SENSOR	CEILING
©₊ LV	LOW VOLTAGE OCCUPANCY DUAL TECHNOLOGY SENSOR	WALL OR CEILING
D1	LOW VOLTAGE DIMMING MODULE SINGLE RELAY	
EM	LOW VOLTAGE EMERGENCY MODULE	
[M]	INPUT MODULE	
LB	LOW VOLTAGE LIGHTING BRIDGE	
-	WALL MOUNT BRACKET	
Ð	15AMP 125VOLT U-GROUND DUPLEX RECEPTACLE	18 " (457)
⊖= 20A	20AMP 125VOLT U-GROUND DUPLEX RECEPTACLE	18 " (457)
۲	SPECIAL RECEPTACLE (REFER TO DRAWINGS)	AS NOTED
•	DIRECT CONNECTION (REFER TO DRAWINGS)	AS NOTED
	ELECTRICAL PANEL	το τορ
Ø	MOTOR CONNECTION (SINGLE OR THREE PHASE)	78" (1981)
Q-	MOTOR/DISCONNECT CONNECTION (SINGLE OR THREE PHASE)	
Ū	DISCONNECT SWITCH	50 " (1270)
	MANUAL MOTOR STARTER	46" (1170)
Ø	MAGNETIC MOTOR STARTER	46 " (1170)
Ð	COMBINATION STARTER AND DISCONNECT	50 " (1270)
<i>∽####</i>	MOTORIZED DAMPER	
T	THERMOSTAT WALLBOX AND 3/4" CONDUIT WITH PULLWIRE TO ACCESSIBLE CEILING	47 " (1200)
Θ	HUMIDISTAT WALLBOX AND 3/4" CONDUIT WITH PULLWIRE TO ACCESSIBLE CEILING	47 " (1200)
I	JUNCTION BOX (REFER TO DRAWINGS)	
	SPEED CONTROL	46" (1168)
▼ ▽	TELEPHONE OUTLET C/W 3/4" (19mm) CONDUIT TO ACCESSIBLE CORRIDOR CEILING SPACE OR CABLE TRAY DATA OUTLET C/W 3/4" (19mm) CONDUIT TO ACCESSIBLE CORRIDOR CEILING SPACE OR CABLE TRAY	18" (457) 18" (457)
		AS NOTED
	LADDER CABLE BASKET	
++++	BASKET CABLE TRAY	
JJJ	'J' HOOKS	
999	DOUBLE 'J' HOOKS	

ELECTRICAL DRAWING LIST

- E100 DRAWING LIST, LEGEND, SCHEDULE NOTES AND DETAILS
 E200 PARTIAL FLOOR PLAN - DEMOLITION - ELECTRICAL
 E300 PARTIAL FLOOR PLAN - LIGHTING
- E400 PARTIAL FLOOR PLA POWER AND SYSTEMS
- E500 SINGLE LINE DIAGRAM, PANEL SCHEDULE

GENERAL NOTES


- 1. DO NOT SCALE DRAWINGS FOR INSTALLATION PURPOSES. OBTAIN ALL DIMENSIONS FROM ARCHITECTURAL PLANS, MANUFACTURER'S SHOP DRAWINGS, AND ON SITE INSPECTIONS.
- PRIOR TO INSTALLATION OF BOXES IN WALLS, VERIFY THAT NO INTERFERENCES EXIST. CHECK ARCHITECTURAL PLANS AND ELEVATIONS.
 MECHANICAL AND ELECTRICAL TRADES SHALL WORK IN CONJUNCTION WITH
- ONE ANOTHER SO AS TO AVOID INTERFERENCES BETWEEN PIPING, DUCTWORK, CONDUIT, LIGHTING FIXTURES, ETC.4. WORK IN CONJUNCTION WITH ARCHITECTURAL REFLECTED CEILING PLAN WHEN
- LOCATING LIGHT FIXTURES.
 ALL EXISTING DEAD WIRING AND CONDUIT IN RENOVATED AREAS SHALL BE REMOVED IN ITS ENTIRETY WHERE ACCESSIBLE. WHERE NOT ACCESSIBLE,
- WIRING ONLY SHALL BE REMOVED AND CONDUIT SHALL REMAIN.
 REWORK ALL EXISTING WIRING, CONDUIT, ETC. REMAINING IN USE AND
- FALLING WITHIN EXISTING WALLS WHICH ARE BEING REMOVED, TO NEAREST EXISTING WALLS REMAINING. ALL REWORKED WIRING SHALL BE CONCEALED.
 7. DISCONNECT AND REMOVE ANY ELECTRICAL EQUIPMENT IN CEILING SPACE
 7. DISCONNECT AND REMOVE ANY ELECTRICAL EQUIPMENT IN CEILING SPACE
- OR WALLS THAT CAUSES INTERFERENCES DURING RENOVATION WORK. ALL EQUIPMENT SHALL BE REPLACED AND RECONNECTED UPON COMPLETION OF RENOVATION WORK. 8. ELECTRICAL EQUIPMENT BEING REMOVED AND NOT BEING REUSED WILL BE
- STORED ON SITE AND REMAIN THE PROPERTY OF THE OWNER. ANY SUCH EQUIPMENT THE OWNER DOES NOT WISH TO RETAIN WILL BE REMOVED FROM SITE AND DISPOSED OF BY THIS TRADE.
- 9. REVIEW ARCHITECTURAL, MECHANICAL, AND STRUCTURAL DRAWINGS AND PROVIDE ON SITE INSPECTIONS TO DETERMINE FULL EXTENT OF PROJECT PRIOR TO SUBMITTING BID.
- 10. POWER AND CONTROL WIRING MUST RISE TO ROOFTOP EQUIPMENT WITHIN CURB OF UNIT UNLESS OTHERWISE APPROVED BY CONSULTANT. CONFIRM EXACT LOCATION ON SITE WITH CONSULTANT BEFORE INSTALLATION.


DEMOLITION NOTES

1. ELECTRICAL SYSTEMS SHOWN ON DEMOLITION PLANS ARE BASED ON INFORMATION OBTAINED FROM ORIGINAL CONSTRUCTION CONTRACT/TENDER DOCUMENTS. THESE DRAWINGS ARE NOT BASED ON 'AS-BUILT RECORDS' OR ON EXHAUSTIVE FIELD MEASUREMENT AND ARE PROVIDED TO ASSIST THE CONTRACTOR IN DETERMINING THE EXTENT OF WORK REQUIRED. THE CONTRACTOR SHALL MAKE ALLOWANCE IN THEIR TENDER PRICE FOR THE REMOVAL OF ADDITIONAL ABANDONED SERVICES AND THE PROTECTION OF EXISTING SERVICES THAT MUST REMAIN. RECORD THE LOCATION OF ALL EXISTING SERVICES THAT REMAIN ON AS-BUILT RECORD DRAWINGS.

FIRE ALARM SYSTEM NOTES


- A. PROVIDE FIRE ALARM SYSTEM REVISIONS AS INDICATED. CONNECT TO EXISTING CIRCUIT. WIRING AND CONDUIT SIZE TO BE AS PER MANUFACTURER'S RECOMMENDATIONS. INSTALL TO CAN/ULC-S524 (INSTALLATION OF FIRE ALARM SYSTEMS). VERIFICATION TO BE PERFORMED BY FIRE ALARM TECHNICIAN. RECORD SYSTEM PERFORMANCE AS PER CAN/ULC-S537 (VERIFICATION OF FIRE ALARM SYSTEMS), AND SUBMIT REPORT TO ELECTRICAL CONSULTANT FOR REVIEW. INCLUDE ADDITIONAL VERIFICATION TO BE WITNESSED BY AUTHORITIES HAVING JURISDICTION. ALL FIRE ALARM DEVICES SHALL BE PROVIDED BY BASE BUILDING FIRE ALARM SYSTEM CONTRACTOR.
- B. ON COMPLETION OF INSPECTION AND WHEN ALL ABOVE CONDITIONS HAVE BEEN COMPLIED WITH, MANUFACTURER SHALL ISSUE TO THE OWNER:
- a. COPY OF INSPECTING TECHNICIAN'S REPORT SHOWING LOCATION OF EACH DEVICE AND CERTIFYING TEST RESULTS OF EACH DEVICE.
- b. CERTIFICATE OF VERIFICATION CONFIRMING THAT INSPECTION HAS BEEN COMPETED AND SHOWING CONDITIONS UPON WHICH SUCH INSPECTION AND CERTIFICATION HAVE BEEN RENDERED.
- c. PROOF OF LIABILITY INSURANCE FOR INSPECTION.
- C. INFORM GENERAL TRADE/OWNER OF ANY FIRE ALARM ZONE OR DEVICE WHICH IS DISCONNECTED OR RENDERED INOPERATIVE, TO PREVENT FALSE ALARMS, AT THE BEGINNING OF THE WORK DAY. RECONNECT ALL FIRE ALARM ZONES AND DEVICES AT END OF WORK DAY AND INFORM GENERAL TRADE/OWNER.
- D. FIRE ALARM SYSTEM: COMPLY WITH CAN/CSA-S524 (INSTALLATION OF FIRE ALARM SYSTEMS), CAN/CSA-S537 (VERIFICATION OF FIRE ALARM SYSTEMS), AND OBC.

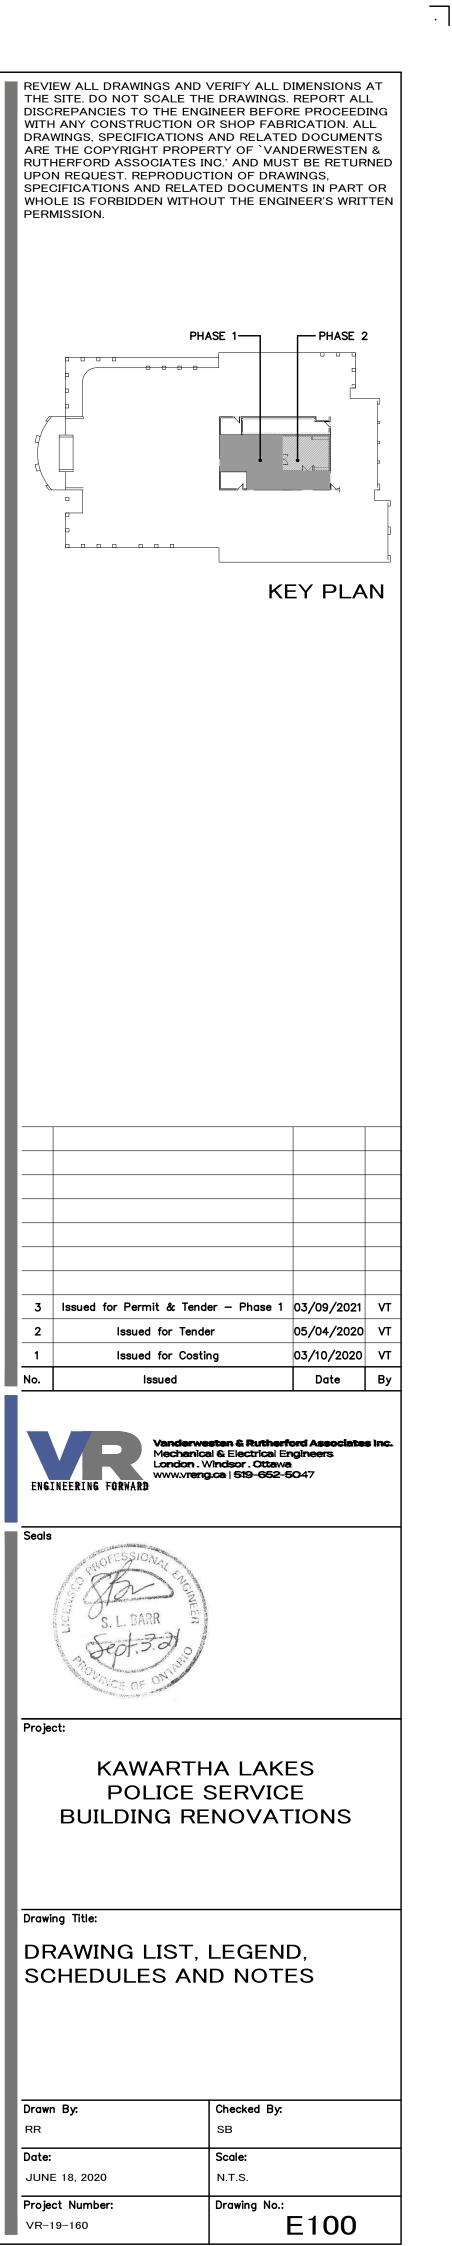

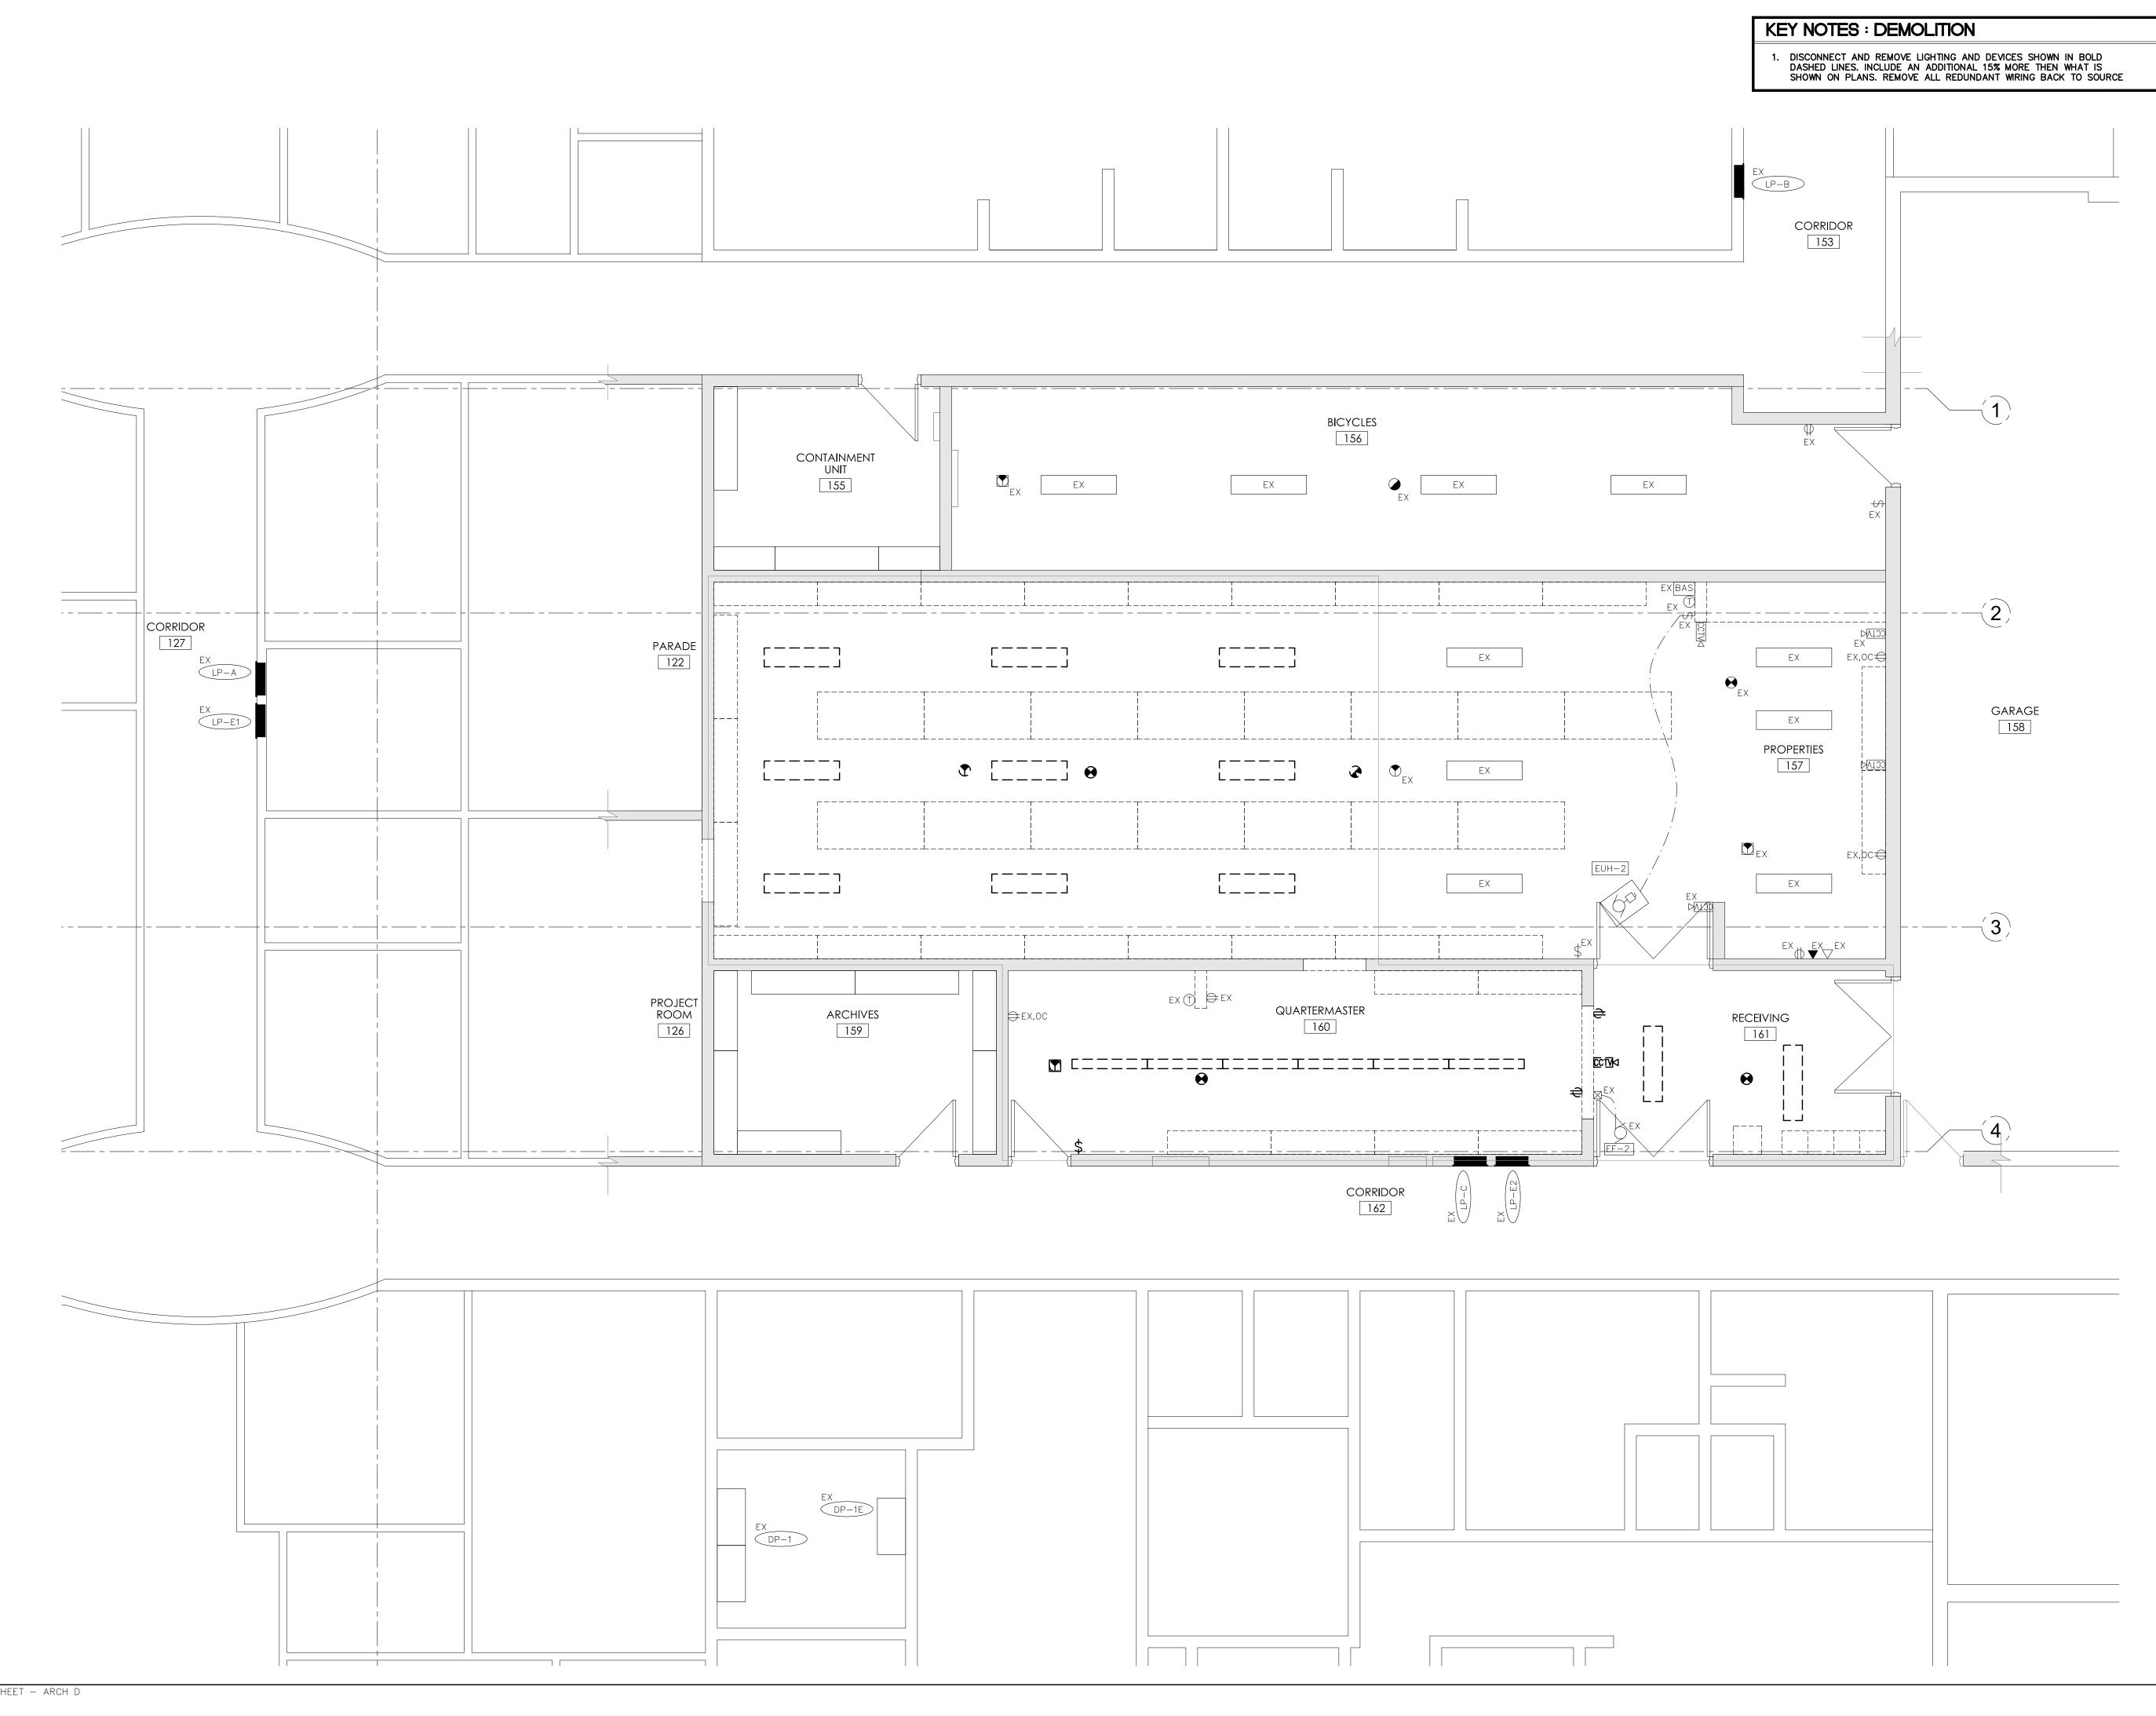


ORIGINAL SHEET – ARCH D

WITH ANY CONSTRUCTION C DRAWINGS, SPECIFICATIONS ARE THE COPYRIGHT PROPE RUTHERFORD ASSOCIATES I UPON REQUEST. REPRODUCT SPECIFICATIONS AND RELAT	E DRAWINGS. REPORT ALL GINEER BEFORE PROCEEDING OR SHOP FABRICATION. ALL AND RELATED DOCUMENTS ERTY OF `VANDERWESTEN & NC.' AND MUST BE RETURNED
PH	ASE 1 PHASE 2
3 Issued for Permit & Tend 2 Issued for Tend 1 Issued for Cost No. Issued	er 05/04/2020 VT
Mechanic London	esten & Rutherford Associates Inc. al & Electrical Engineers Windsor . Ottawa g.ca 519-652-5047
Seals	N
POLICE	HA LAKES SERVICE ENOVATIONS
Drawing Title: PARTIAL FLOOF DEMOLITION - I	
Drawn By: RR	Checked By: SB
Date: JUNE 18, 2020	Scale: 1/4″=1'-0″
Project Number: VR-19-160	Drawing No.: E200

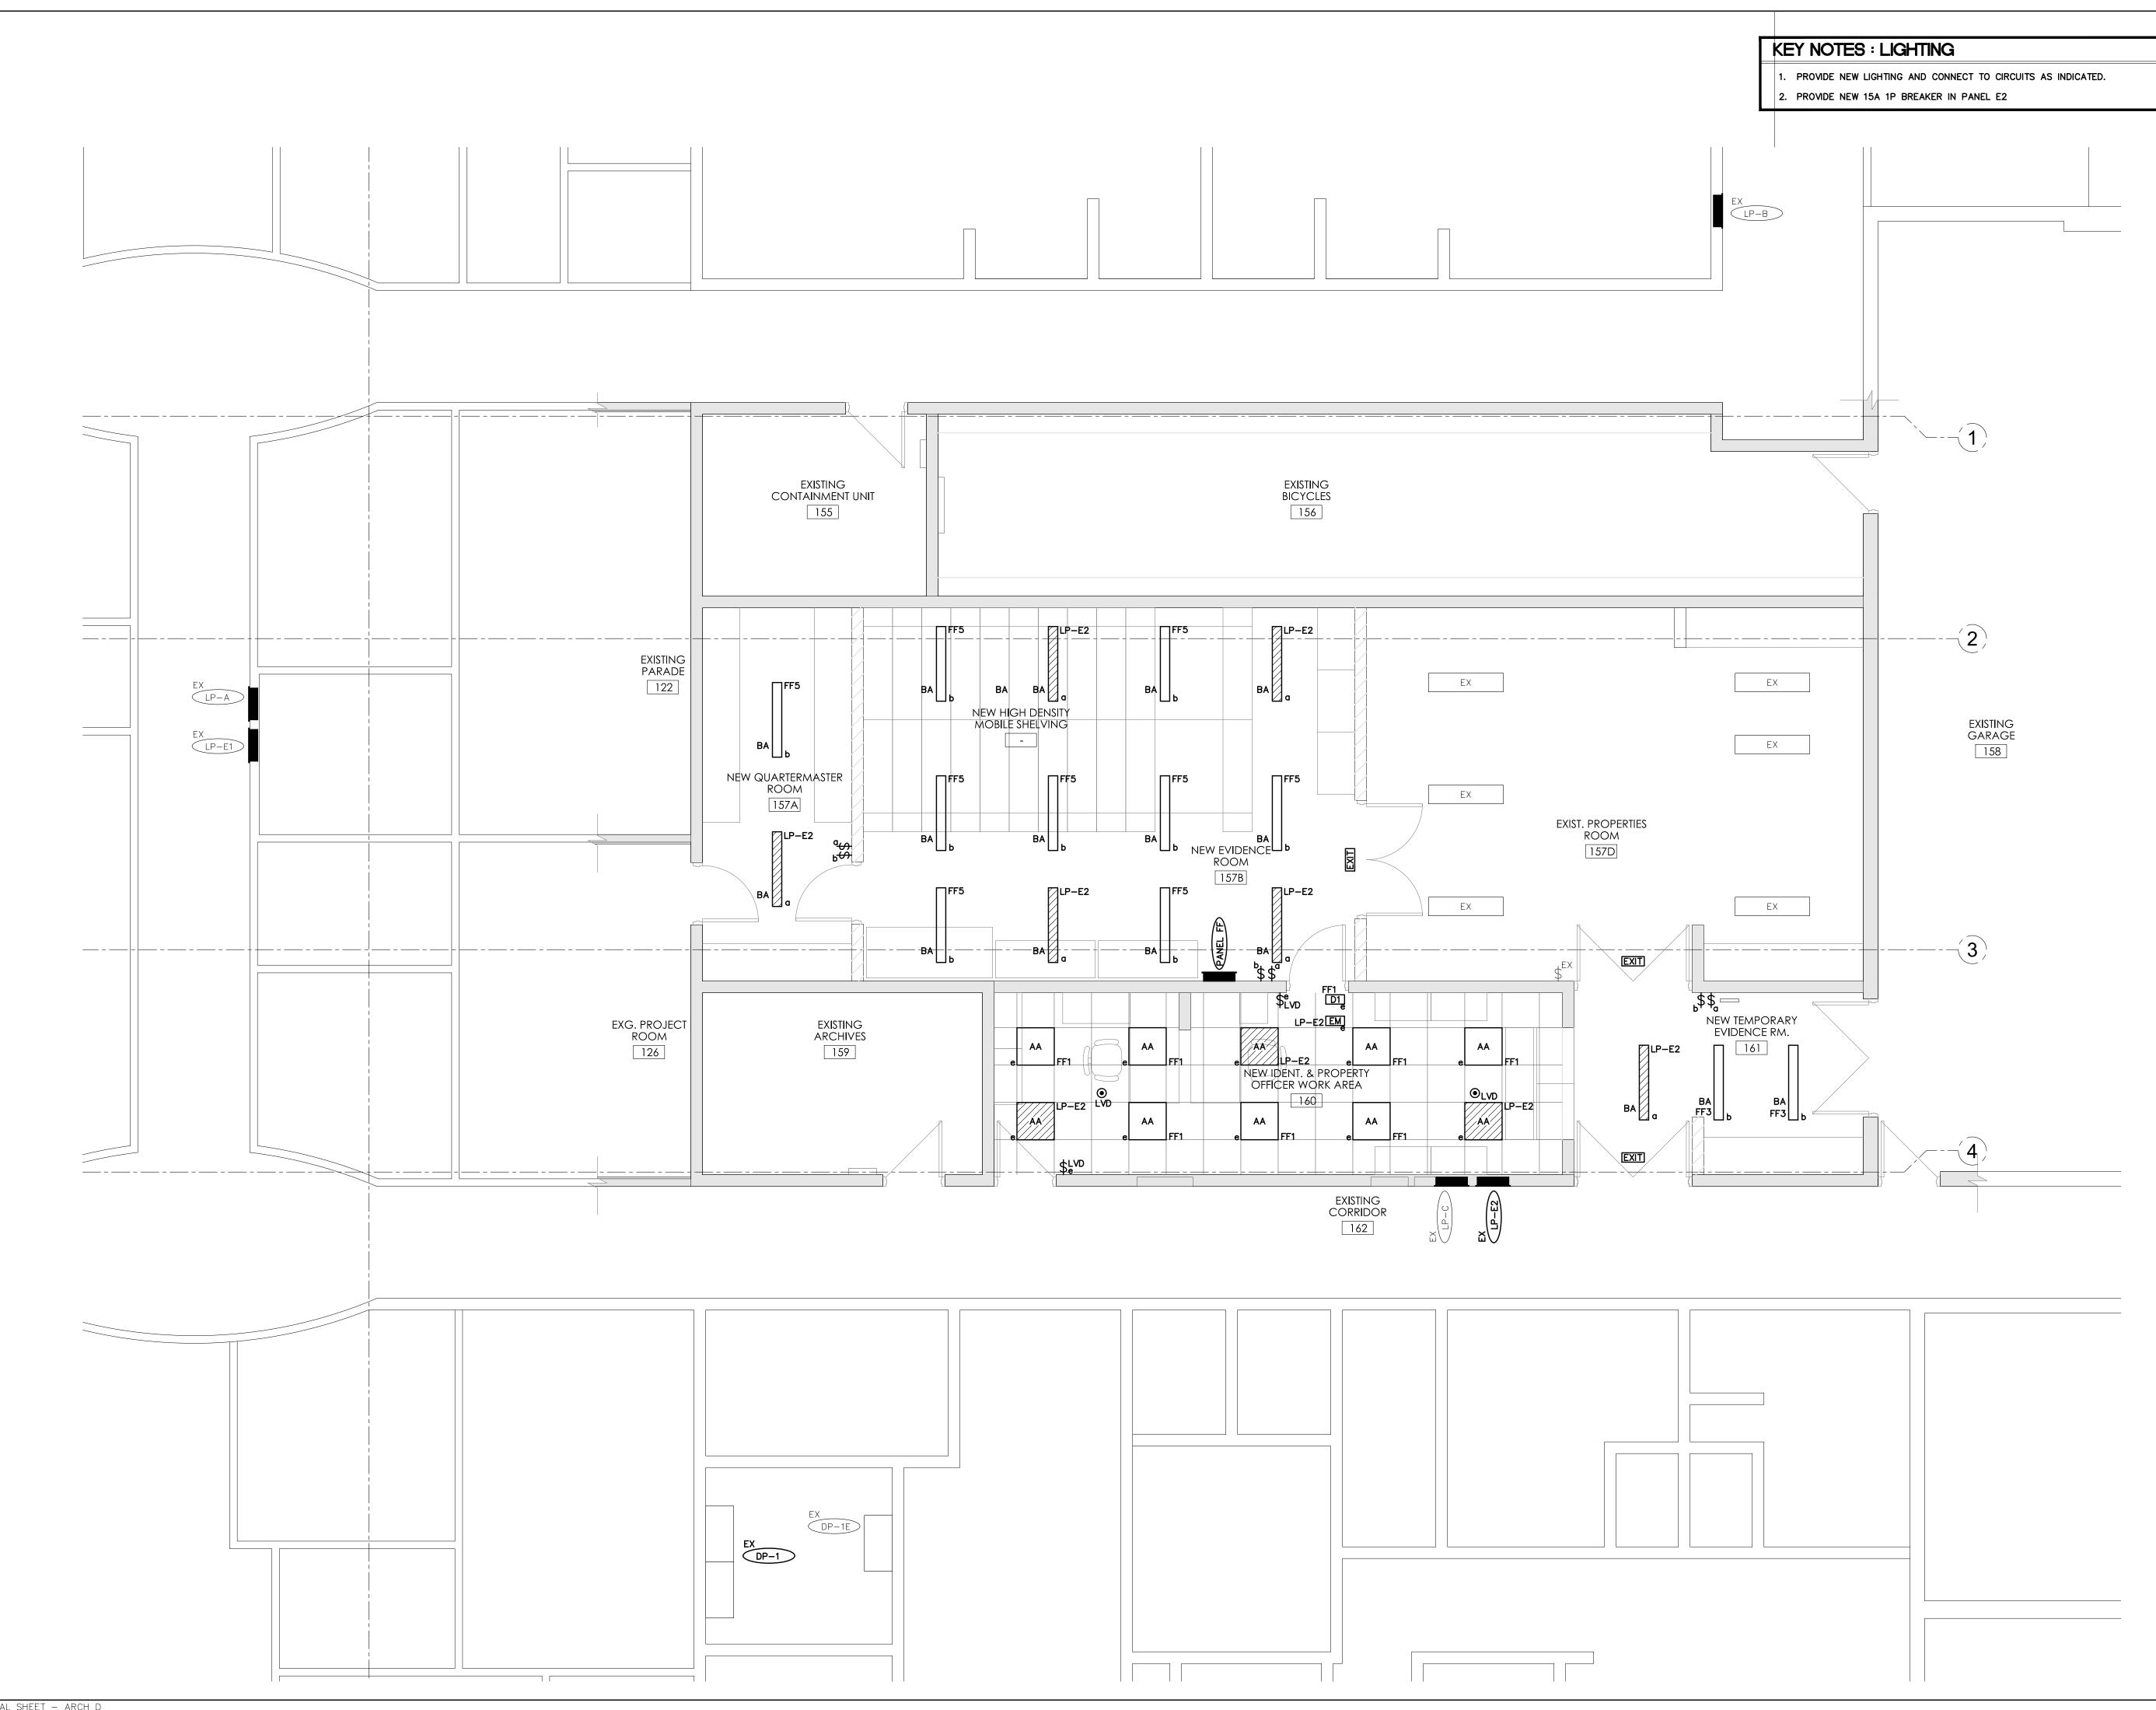

ORIGINAL SHEET – ARCH D

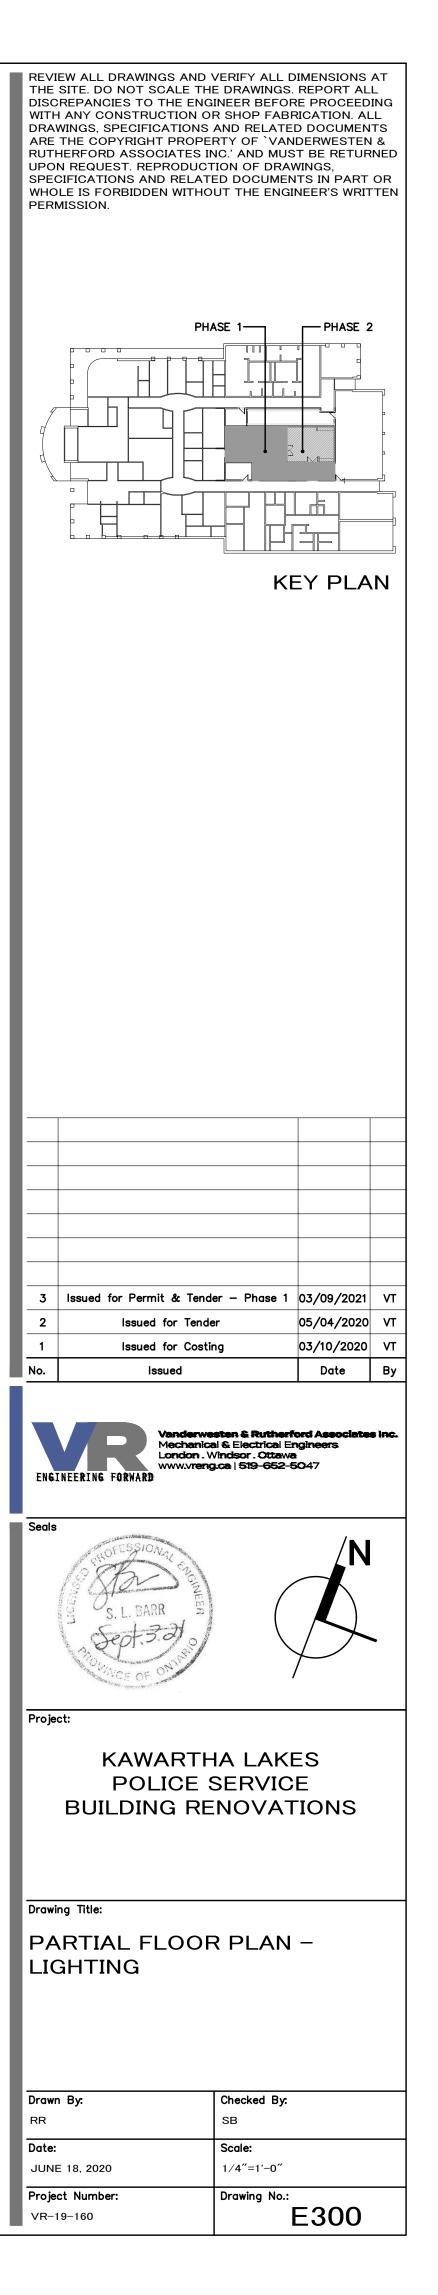



: J:\Drawings\19-160 Kawartha Lakes Police Service Bldg Renovation\3-Working Documents\E\E400 POWER AND SYSTEMS NEV tember 0.3. 2021 - 11:4.3am Plotted by: vr-cad.3

KEY NOTES : POWER AND SYSTEMS

1. PROVIDE NEW PANEL AND FEED FROM EXISTING DP-1. PROVIDE 100A, 3P BREAKER AND FEEDER (4-#3+GND,41MMC) IN NEXT AVAILABLE SPACE. COORDINATE ONSITE TO MATCH EXISTING (FPE SWITCHGEAR UNIT).

2. PROVIDE NEW DEVICES AS INDICATED.

(2)

existing


GARAGE


 $\mathbf{3}$


- ____ _ ___

3. PROVIDE 20A DEDICATED GF/WP RECEPTACLE AT ROOF, WITHIN 7.5M OF HVAC EQUIPMENT. CONNECT TO CIRCUIT FF9.

REVIEW ALL DRAWINGS AND VERIFY ALL DIMENSIONS AT THE SITE. DO NOT SCALE THE DRAWINGS. REPORT ALL DISCREPANCIES TO THE ENGINEER BEFORE PROCEEDING WITH ANY CONSTRUCTION OR SHOP FABRICATION. ALL DRAWINGS, SPECIFICATIONS AND RELATED DOCUMENTS ARE THE COPYRIGHT PROPERTY OF `VANDERWESTEN & RUTHERFORD ASSOCIATES INC.' AND MUST BE RETURNED UPON REQUEST. REPRODUCTION OF DRAWINGS, SPECIFICATIONS AND RELATED DOCUMENTS IN PART OR WHOLE IS FORBIDDEN WITHOUT THE ENGINEER'S WRITTEN PERMISSION.

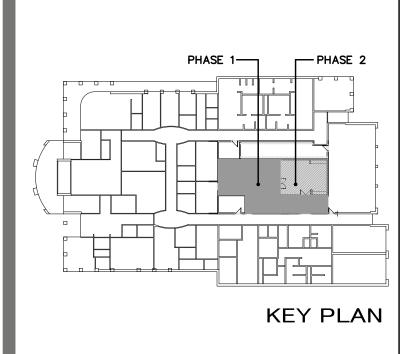


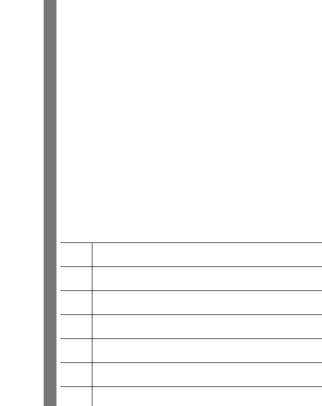


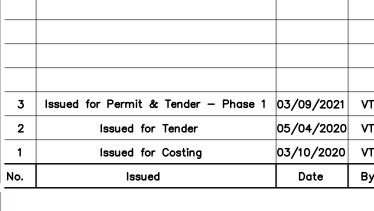



Mechanical & Electrical Engineers London . Windsor . Ottawa www.vreng.ca | 519-652-5047

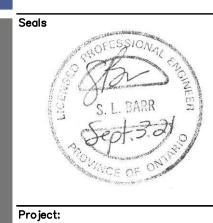

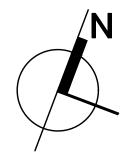

KAWARTHA LAKES POLICE SERVICE BUILDING RENOVATIONS

Drawing Title: PARTIAL FLOOR PLAN – POWER AND SYSTEMS

Drawn By: RR Date: JUNE 18, 2020 Project Number:

VR-19-160

Checked By: SB Scale: 1/4"=1'-0" Drawing No.: E400


ORIGINAL SHEET – ARCH D

		22	5A 1:	20/20)8V 3	ø 4W			SURFAC	Ε ΜΤΙ
ΕX			SLP T			RIDOF		62	100A	, DP-
NATTS	FOR	P	AMP	ССТ	ССТ	AMP	P	FOR		WATT
				1	2	15	1	HEAT TRAG	CE CABLE (WEST)	*
*	HUMIDIFIERS	3	50	3	4	15	1	HEAT TRAG	CE CABLE (WEST)	*
				5	6	15	1	HEAT TRAG	CE CABLE (WEST)	k
	SPACE			7	8				SPACE	
				9	10					
				11	12					
				13	14					
*	HOT WATER TANK	1	15	15	16				4	
	SPACE			17	18					
				19	20	20	1	REC: COPIE	R. UTILITY RM	
				21	22	*	.			
				23	24	т	T .	HEATER IN	WMNS BATHRM.	
	NEL FF									\ UE-
) TYP					M 157B	1007	
VATTS	FOR	Ρ	AMP	ССТ	ССТ	AMP	Ρ	FOR	1007	WAT
VATTS 210	FOR LTG: RM 160	P 1	AMP 15	ССТ 1	ССТ 2	AMP 15	P 1	FOR RM 160		WAT 80
VATTS 210 62	FOR LTG: RM 160 LTG: RM 161	P 1 1	AMP 15 15	CCT 1 3	CCT 2 4	AMP 15 15	P 1 1	FOR RM 160 REC: RM	160	WAT 80 80
VATTS 210 62 279	FOR LTG: RM 160 LTG: RM 161 LTG: 157A,157B	P 1 1	AMP 15 15 15	CCT 1 3 5	CCT 2 4 6	AMP 15 15 15	P 1 1	FOR RM 160 REC: RM REC: RM	160 160&161	WAT 80 80 80
VATTS 210 62 279 800	FOR LTG: RM 160 LTG: RM 161 LTG: 157A,157B REC: RM 157B FRIDGE	P 1 1 1 1	AMP 15 15 15 15	CCT 1 3 5 7	CCT 2 4 6 8	AMP 15 15	P 1 1	FOR RM 160 REC: RM REC: RM	160	WAT 80 80 80
VATTS 210 62 279 800	FOR LTG: RM 160 LTG: RM 161 LTG: 157A,157B	P 1 1	AMP 15 15 15	CCT 1 3 5 7 9	CCT 2 4 6 8 10	AMP 15 15 15 15	P 1 1 1	FOR RM 160 REC: RM REC: RM REC: RM	160 160&161	WAT 80 80 80 40
VATTS 210 62 279 800 400	FOR LTG: RM 160 LTG: RM 161 LTG: 157A,157B REC: RM 157B FRIDGE REC: ROOFTOP	P 1 1 1 1 1	AMP 15 15 15 15 20	CCT 1 3 5 7 9 11	CCT 2 4 6 8 10 12	AMP 15 15 15	P 1 1 1	FOR RM 160 REC: RM REC: RM	160 160&161	WAT 80 80 80 40
VATTS 210 62 279 800 400 *	FOR LTG: RM 160 LTG: RM 161 LTG: 157A,157B REC: RM 157B FRIDGE REC: ROOFTOP *	P 1 1 1 1 1 *	AMP 15 15 15 15 20 *	CCT 1 3 5 7 9 11 13	CCT 2 4 6 8 10 12 14	AMP 15 15 15 15	P 1 1 1	FOR RM 160 REC: RM REC: RM REC: RM	160 160&161	WAT 80 80 80 40
VATTS 210 62 279 800 400 *	FOR LTG: RM 160 LTG: RM 161 LTG: 157A,157B REC: RM 157B FRIDGE REC: ROOFTOP * *	P 1 1 1 1 *	AMP 15 15 15 20 *	CCT 1 3 5 7 9 11 13 15	CCT 2 4 6 8 10 12 14 16	AMP 15 15 15 15 15	P 1 1 1 3	FOR RM 160 REC: RM REC: RM REC: RM FCU-2	160 160&161	WAT 80 80 40 60
VATTS 210 62 279 800 400 * * *	FOR LTG: RM 160 LTG: RM 161 LTG: 157A,157B REC: RM 157B FRIDGE REC: ROOFTOP * * *	P 1 1 1 1 * *	AMP 15 15 15 20 * * *	CCT 1 3 5 7 9 11 13	CCT 2 4 6 8 10 12 14	AMP 15 15 15 15	P 1 1 1 3	FOR RM 160 REC: RM REC: RM REC: RM	160 160&161	WAT 80 80 40 60
VATTS 210 62 279 800 400 * * * *	FOR LTG: RM 160 LTG: RM 161 LTG: 157A,157B REC: RM 157B FRIDGE REC: ROOFTOP * * *	P 1 1 1 1 * * * *	AMP 15 15 15 20 * * *	CCT 1 3 5 7 9 11 13 15 17	CCT 2 4 6 8 10 12 14 16 18	AMP 15 15 15 15 15	P 1 1 3 3	FOR RM 160 REC: RM REC: RM REC: RM FCU-2	160 160&161	WAT 80 80 40 60
VATTS 210 62 279 800 400 * * * * *	FOR LTG: RM 160 LTG: RM 161 LTG: 157A,157B REC: RM 157B FRIDGE REC: ROOFTOP * * * *	P 1 1 1 1 * * * *	AMP 15 15 15 20 * * * *	CCT 1 3 5 7 9 11 13 15 17 19	CCT 2 4 6 8 10 12 14 16 18 20	AMP 15 15 15 15 15 25	P 1 1 3 3	FOR RM 160 REC: RM REC: RM REC: RM FCU-2 CU-2	160 160&161	WAT 80 80 40 60
VATTS 210 62 279 800 400 * * * * * *	FOR LTG: RM 160 LTG: RM 161 LTG: 157A,157B REC: RM 157B FRIDGE REC: ROOFTOP * * * * * *	P 1 1 1 1 * * * * *	AMP 15 15 15 20 * * * * *	CCT 1 3 5 7 9 11 13 15 17 19 21	CCT 2 4 6 8 10 12 14 16 18 20 22	AMP 15 15 15 15 15 25 *	P 1 1 1 3 3	FOR RM 160 REC: RM REC: RM FCU-2 CU-2 *	160 160&161	WAT 80 80 40 60
/ATTS 210 62 279 800 400 * * * * * * * *	FOR LTG: RM 160 LTG: RM 161 LTG: 157A,157B REC: RM 157B FRIDGE REC: ROOFTOP * * * * * * *	P 1 1 1 1 * * * * * * * *	AMP 15 15 15 20 * * * * * *	CCT 1 3 5 7 9 11 13 15 17 19 21 23	CCT 2 4 6 8 10 12 14 16 18 20 22 24	AMP 15 15 15 15 15 25 *	P 1 1 1 3 3 *	FOR RM 160 REC: RM REC: RM FCU-2 CU-2 * *	160 160&161	WAT 80 80 40 60
VATTS 210 62 279 800 400 * * * * * * * * *	FOR LTG: RM 160 LTG: RM 161 LTG: 157A,157B REC: RM 157B FRIDGE REC: ROOFTOP * * * * * * * * *	P 1 1 1 * * * * * * * *	AMP 15 15 15 20 * * * * * * *	CCT 1 3 5 7 9 11 13 15 17 19 21 23 25	CCT 2 4 6 8 10 12 14 16 18 20 22 24 26 28 30	AMP 15 15 15 15 25 * *	P 1 1 3 3 * *	FOR RM 160 REC: RM REC: RM FCU-2 CU-2 * *	160 160&161	WAT 80 80 40 60 580
VATTS 210 62 279 800 400 * * * * * * * * * * * * * *	FOR LTG: RM 160 LTG: RM 161 LTG: 157A,157B REC: RM 157B FRIDGE REC: ROOFTOP * * * * * * * * * * * * *	P 1 1 1 1 * * * * * * * * * * *	AMP 15 15 15 20 * * * * * * * * *	CCT 1 3 5 7 9 11 13 15 17 19 21 23 25 27	CCT 2 4 6 8 10 12 14 16 18 20 22 24 22 24 26 28	AMP 15 15 15 15 25 * * *	P 1 1 1 3 3 * *	FOR RM 160 REC: RM REC: RM FCU-2 CU-2 * * *	160 160&161	WAT 80 80 40 60 580
VATTS 210 62 279 800 400 * * * * * * * * * * * * * * * * *	FOR LTG: RM 160 LTG: RM 161 LTG: 157A,157B REC: RM 157B FRIDGE REC: ROOFTOP * * * * * * * * * * * * *	P 1 1 1 1 * * * * * * * * * * * * *	AMP 15 15 15 20 * * * * * * * * * * *	CCT 1 3 5 7 9 11 13 15 17 19 21 23 25 27 29	CCT 2 4 6 8 10 12 14 16 18 20 22 24 26 28 30	AMP 15 15 15 15 25 * * * *	P 1 1 1 3 3 * * *	FOR RM 160 REC: RM REC: RM FCU-2 CU-2 * * * *	160 160&161	WAT 80 80 40 60
VATTS 210 62 279 800 400 * * * * * * * * * * * * * * * * *	FOR LTG: RM 160 LTG: RM 161 LTG: 157A,157B REC: RM 157B FRIDGE REC: ROOFTOP * * * * * * * * * * * * *	P 1 1 1 1 * * * * * * * * * * * * * * *	AMP 15 15 15 20 * * * * * * * * * * * *	CCT 1 3 5 7 9 11 13 15 17 19 21 23 25 27 29 31	CCT 2 4 6 8 10 12 14 16 18 20 22 24 26 28 30 32	AMP 15 15 15 15 25 * * * *	P 1 1 1 3 3 * * * * * *	FOR RM 160 REC: RM REC: RM REC: RM FCU-2 CU-2 * * * * * *	160 160&161	WAT 80 80 40 60 580
VATTS 210 62 279 800 400 * * * * * * * * * * * * * * * * *	FOR LTG: RM 160 LTG: RM 161 LTG: 157A,157B REC: RM 157B FRIDGE REC: ROOFTOP * * * * * * * * * * * * *	P 1 1 1 1 * * * * * * * * * * * * * * *	AMP 15 15 15 20 * * * * * * * * * * * * *	CCT 1 3 5 7 9 11 13 15 17 19 21 23 25 27 29 31 33	CCT 2 4 6 8 10 12 14 16 18 20 22 24 26 28 30 32 34	AMP 15 15 15 15 25 * * * * *	P 1 1 1 1 3 3 * * * * * * *	FOR RM 160 REC: RM REC: RM REC: RM FCU-2 CU-2 * * * * * * *	160 160&161	WAT
VATTS 210 62 279 800 400 * * * * * * * * * * * * * * * * *	FOR LTG: RM 160 LTG: RM 161 LTG: 157A,157B REC: RM 157B FRIDGE REC: ROOFTOP * * * * * * * * * * * * *	P 1 1 1 1 * * * * * * * * * * * * * * *	AMP 15 15 15 20 * * * * * * * * * * * * *	CCT 1 3 5 7 9 11 13 15 17 19 21 23 25 27 29 31 33 35	CCT 2 4 6 8 10 12 14 16 18 20 22 24 26 28 30 32 34 36	AMP 15 15 15 15 25 * * * * * * *	P 1 1 1 3 3 *** * * * * * * * *	FOR RM 160 REC: RM REC: RM FCU-2 CU-2 * * * * * * *	160 160&161	WAT 80 80 60 580

FΧ)8V 3			FLUS
		_	BLP T			RIDOR	_	,
WATTS	FOR	Ρ	AMP	CCT		AMP	Ρ	FOR
*	LTG: WOMENS CHNG RM.	1	15	1	2	15	1	SPARE
*	LTG: MENS CHNG RM	1	15	3	4	15	1	SPARE
*	LTG: KITCHEN	1	15	5	6	15	1	SPARE
*	LTG: PROP/BICY.CONTM	1	15	7	8	15	1	REC: PROJ.RM/RESOURCE
*	LTG: PROPERTIES	1	15	9	10	15		REC: PARADE/PROJ.RM
*	LTG: GARAGE	1	15	11	12	15		REC: REPORT WRITING
*	SPLIT REC: KITCHEN	2	15	13	14	15		REC: CONTAINMENT/HALL
		_		15	16	15	1	REC: MEN & WOMEN WSHRM
*	SPLIT REC: KITCHEN	2	15	17	18	15	1	REC: MEN & WOMEN WSHRM
				19	20	15	1	REC: MW KITCHEN
*	SPARE	1	15	21	22	15	1	REC: FRIDGE IN KITCH.
*	SPARE	1	15	23	24	15		REC: EXTERIOR/GARAGE
*	EXHAUST FAN #5	1	15	25	26	15	1	HEATING UNIT 24/VEST.
*	SPARE	1	15	27	28	15	1	SPARE – TURNED OFF
*	HEATING CABLE ROOF	1	15	29	30	15	1	SPARE – TURNED OFF
	SPACE	*	*	31	32			SPACE
		*	*	33	34			↓
		*	*	35	36			
		*	*	37	38	*	2	REC: STOVE KITCHEN
		*	*	39	40		~	
		*	*	41	42			SPACE
		*	*	43	44			
		*	*	45	46			
		*	*	47	48			
		*	*	49	50			
		*	*	51	52			
		*	*	53	54			
		*	*	55	56			
		*	*	57	58			
		*	*	59	60			
		*	*	61	62			
	The second secon	*	*	63	64			
		*	*	65	66			
FX)8V 3			FLUS
		_	BLP T			RIDOR	_	
WATTS		P	AMP			AMP		
*	LTG: ARCHIVES/QUARTMASTER	1	15	1	2	15	1	REC: BATTERY UNIT#3
*	LTG: MECH. RM	1	15	3	4	15	1	
*	LTG: STORAGE/SALLY PORT	1	15	5	6	15	1	REC:
*	REC: PROPERTIES/RECEIVING		15	7	8	4 5	_	SPACE
*	REC: PROPERTIES/RECEIVING		15	9	10	15	1	REC: SOLICITOR RM
*	REC: ARCHIVES/QUARTMASTER	1	15	11	12	15		REC: FINGER PRT./BREATZR
*	REC: HALL	1	15	13	14	15		REC: SALLY PORT/STOR.RM
*	EXHAUST FAN #8/ROOF #7	1	15	15	16	15		REC: EXT.GARAGE
*	EXHAUST FAN #6	1	15	17	18	15		REC: CELL AREA
*	FRIDGE IN CHEMICAL RM	1	15	19	20	15	1	
*	REC: CHEMICAL RM	1	15	21	22	15	1	"
*	REC: IDENTIFICATION/DRY RM	1	15	23	24	15	1	HEATING CABLE ROOF TOP
*	EXHAUST FAN #9	1	15	25	26			SPACE
	HEATER: FORENSIC ID	2	15	27	28	15	1	REC: BATTERY UNIT#1
		<u> </u>	· · ·	29	30	15	2	FORENSIC ID AC
	CHEMICAL BAY#2 208V REC	2	15	31	32		-	
		<u> </u>		33	34			SPACE
ļ	SPACE		45	35	36			
*	EXISTING	1	15	37	38			
*	EXISTING	1	15	39	40			
*	SPACE			41	42			l l

	WATTS	PANEL LP-E2	P	BLP T	ССТ		RIDOF			WAT
rs *		LTG: MECH.RM/PROP	1		1	2	*	*		
*		LTG: MECH/GARAGE	1		3	4	*	*	SPACE	
*		LTG: CORR./BREATHALIZE			5	6	15		PWR: STEEL GATE DRS	ŝ
*		LTG: YOUTH CELL/MUGH SHO	_	15	7	8	*	*	SPARE	
	*	LTG: CELL AREA	1	15	9	10	*	*	SPARE	
<	*	LTG: MUGSHOT/TELEPHON	E 1	15	11	12	*	*	SPARE	
ĸ					13	14	*	*	HWT LAB	
<	*	OH DOORS:1&2 SALLY PORT	3	15	15	16	*	*	CCTV IN SALLY PORT	
*			+		17	18	*		CAM.FOUR BAY/STAFF ENT	Г
k 			_		19	20	*	*		
	*	OH DOORS: 1&2 SALLY PORT	3	20	21	22	*		REC: QUARTERMASTER	
			+		23 25	24 26	*	*	CECOIL MICO/ COOL MILEN	
-	*	OH DOORS: 1&2 SALLY PORT	3	15	25	20	*		VAV BOXES ABOVE CL	
-		UN DUURS. 10.2 SALLI PURT	5	13	29	30	*	-	LTG: LAB	
-	207	LTG: 157A&B,160,161	1	15	31	32	*		REC: LAB	
		DRUG CABINET RM 157B	_		33	34			SPACE	
		DRUG CABINET RM 1578			35	36				
-	200	SPACE	+		37	38				
					39	40				
		l l			41	42				
*	_		0.0				a 111		FLUC	
*	I EX	.PANEL LP-A		25a t. BLP T)8V 3	ø 4₩ RIDOF		62 FLUS 62 200A	
ĸ		1			CCT					-
k	WATTS *			-						WAT
с с		LTG: 101	1		1	2	15	-	LTG: 118 RECORDS	
		SPACE	1	1.0	3 5	4	15		LTG: RECORDS/INTERVIEW	,
		LTG: ISSUE/REPORT WRITIN	_		5 7	6 8	15 15		LTG: PARADE/XEROX/PROJ.RN	1
		LTG: ISSUE/REPORT WRITIN	_		9				LTG: C.I.B/C.I.B. OFF. LTG: IDENT/CHEM.RM/DRY RM	
		LTG: REP.WRT/RESRC/INTRV LTG: MAIN FOYER/OFF.MAN	1		11	10 12	15 15		LTG: STRG/WSHRM/KTCH/WSHRM	
¢					13	14	15			
ĸ		LTG: COMM.SERV/P.WSHRM LTG: VICTIM INT/OFF.MAN	1		15	16	15	-	LTG: CHIEF OF POLICE LTG: DEPUTY	
		LTG: CORRIDOR		15					LTG: RECEPTION	
)		REC: LASER PRINTER	1		19	20	15		LTG: CORRIDOR	
1		REC: PHOTOCOPIER		15	21	20	15		SPARE	
S	*	SPARE	1		23	24	15		REC: RECORDS/OFF.MAN	
*	*	REC: SHREDDER	1	15	25	26	15	-	REC: RECORDS	
*		FLOOR BOX/ICON RM	1		27	28	15		REC: OFF.MAN/COMM.SER./DEPUTY	/
			1		29	30	15		REC: EXTERIOR	
*		IREU: UHE PULIUE/BRURM								
¢	*	REC: CHF POLICE/BRDRM REC: FAX MACHINE	1			-		1	REC: INSPECTOR	
<	*	REC: FAX MACHINE	-	15	31 33	32 34	15 15	-	REC: INSPECTOR REC: INSPECTOR/COMM.RM	
	* * *	,	-	15 15	31	32	15	1		1
	* * * *	REC: FAX MACHINE REC: DEPUTY/WSHRM/C.I.B REC: MW KITCHEN	. 1	15 15 15	31 33	32 34	15 15	1 1	REC: INSPECTOR/COMM.RM	
:	* * * *	REC: FAX MACHINE REC: DEPUTY/WSHRM/C.I.B	. 1	15 15 15	31 33 35	32 34 36	15 15 15	1 1 1	REC: INSPECTOR/COMM.RM REC: HALL/JAN/CORR/WSHRM	-
	* * * *	REC: FAX MACHINE REC: DEPUTY/WSHRM/C.I.B REC: MW KITCHEN	. 1 1 2	15 15 15 15	31 33 35 37	32 34 36 38	15 15 15 15	1 1 1	REC: INSPECTOR/COMM.RM REC: HALL/JAN/CORR/WSHRM REC: INSPECTOR/N.C.O./ISSUE	-
	* * * * *	REC: FAX MACHINE REC: DEPUTY/WSHRM/C.I.B REC: MW KITCHEN SPLIT REC: KITCHEN REC: FRIDGE KITCHEN REC: ISSUE	. 1 1 2	15 15 15 15 15 15 15	31 33 35 37 39	32 34 36 38 40 42 44	15 15 15 15 15	1 1 1 1	REC: INSPECTOR/COMM.RM REC: HALL/JAN/CORR/WSHRW REC: INSPECTOR/N.C.O./ISSUE REC: ISSUE/N.C.O./INTERVIEW	-
	* * * * *	REC: FAX MACHINE REC: DEPUTY/WSHRM/C.I.B REC: MW KITCHEN SPLIT REC: KITCHEN REC: FRIDGE KITCHEN REC: ISSUE REC: ISSUE	. 1 1 2	15 15 15 15 15 15 15 15	31 33 35 37 39 41 43 45	32 34 36 38 40 42 44 46	15 15 15 15 15 15 15 15	1 1 1 1 1 1 1	REC: INSPECTOR/COMM.RM REC: HALL/JAN/CORR/WSHRM REC: INSPECTOR/N.C.O./ISSUE REC: ISSUE/N.C.O./INTERVIEW SPARE REC: XEROX/INTERVIEW REC: C.I.B./C.I.B. OFF.	-
	* * * * * *	REC: FAX MACHINE REC: DEPUTY/WSHRM/C.I.B REC: MW KITCHEN SPLIT REC: KITCHEN REC: FRIDGE KITCHEN REC: ISSUE REC: ISSUE SPARE	. 1 1 2 1 1 1 1 1	15 15 15 15 15 15 15 15 15 15 15	31 33 35 37 39 41 43 45 47	32 34 36 38 40 42 44 46 48	15 15 15 15 15 15 15 15 15 15	1 1 1 1 1 1 1	REC: INSPECTOR/COMM.RM REC: HALL/JAN/CORR/WSHRM REC: INSPECTOR/N.C.O./ISSUE REC: ISSUE/N.C.O./INTERVIEW SPARE REC: XEROX/INTERVIEW REC: C.I.B./C.I.B. OFF. REC: C.I.B./C.I.B. OFF.	-
	* * * * * *	REC: FAX MACHINE REC: DEPUTY/WSHRM/C.I.B REC: MW KITCHEN SPLIT REC: KITCHEN REC: FRIDGE KITCHEN REC: ISSUE REC: ISSUE SPARE REC: VICTM INT/RCRDS/11.	. 1 1 2 1 1 1 1 1	15 15 15 15 15 15 15 15 15 15	31 33 35 37 39 41 43 45 47 49	32 34 36 38 40 42 44 46 48 50	15 15 15 15 15 15 15 15 15 15	1 1 1 1 1 1 1 1 1	REC: INSPECTOR/COMM.RM REC: HALL/JAN/CORR/WSHRW REC: INSPECTOR/N.C.O./ISSUE REC: ISSUE/N.C.O./INTERVIEW SPARE REC: XEROX/INTERVIEW REC: C.I.B./C.I.B. OFF. REC: C.I.B./C.I.B. OFF. REC: MW KITCHEN	-
	* * * * * * *	REC: FAX MACHINE REC: DEPUTY/WSHRM/C.I.B REC: MW KITCHEN SPLIT REC: KITCHEN REC: FRIDGE KITCHEN REC: ISSUE REC: ISSUE SPARE REC: VICTM INT/RCRDS/113 REC: RECORDS DESK	. 1 1 2 1 1 1 1 3 1 1 3	15 15 15 15 15 15 15 15 15 15 15	31 33 35 37 39 41 43 45 47 49 51	32 34 36 38 40 42 44 46 48 50 52	15 15 15 15 15 15 15 15 15 15	1 1 1 1 1 1 1 1 1	REC: INSPECTOR/COMM.RM REC: HALL/JAN/CORR/WSHRM REC: INSPECTOR/N.C.O./ISSUE REC: ISSUE/N.C.O./INTERVIEW SPARE REC: XEROX/INTERVIEW REC: C.I.B./C.I.B. OFF. REC: C.I.B./C.I.B. OFF.	-
	* * * * * * * * * * *	REC: FAX MACHINE REC: DEPUTY/WSHRM/C.I.B REC: MW KITCHEN SPLIT REC: KITCHEN REC: FRIDGE KITCHEN REC: ISSUE REC: ISSUE SPARE REC: VICTM INT/RCRDS/113 REC: RECORDS DESK HEATER: FRONT VEST	. 1 1 2 1 1 1 1 3 1 . 1	15 15 15 15 15 15 15 15 15 15 15	31 33 35 37 39 41 43 45 47 49 51 53	32 34 36 38 40 42 44 46 48 50 52 52 54	15 15 15 15 15 15 15 15 15 15 15	1 1 1 1 1 1 1 1 1 1	REC: INSPECTOR/COMM.RM REC: HALL/JAN/CORR/WSHRW REC: INSPECTOR/N.C.O./ISSUE REC: ISSUE/N.C.O./INTERVIEW SPARE REC: XEROX/INTERVIEW REC: C.I.B./C.I.B. OFF. REC: C.I.B./C.I.B. OFF. REC: MW KITCHEN REC: CHIEFS KTCH-FRIDGE	-
	* * * * * * * * * * *	REC: FAX MACHINE REC: DEPUTY/WSHRM/C.I.B REC: MW KITCHEN SPLIT REC: KITCHEN REC: FRIDGE KITCHEN REC: ISSUE REC: ISSUE SPARE REC: VICTM INT/RCRDS/113 REC: RECORDS DESK HEATER: FRONT VEST REC: XEROX COPIER	. 1 1 2 1 1 1 1 3 1 1 3	15 15 15 15 15 15 15 15 15 15 15 15	31 33 35 37 39 41 43 45 47 49 51 53 55	32 34 36 38 40 42 44 46 48 50 52 54 56	15 15 15 15 15 15 15 15 15 15	1 1 1 1 1 1 1 1 1 1	REC: INSPECTOR/COMM.RM REC: HALL/JAN/CORR/WSHRM REC: INSPECTOR/N.C.O./ISSUE REC: ISSUE/N.C.O./INTERVIEW SPARE REC: XEROX/INTERVIEW REC: C.I.B./C.I.B. OFF. REC: C.I.B./C.I.B. OFF. REC: MW KITCHEN REC: CHIEFS KTCH-FRIDGE SPLIT REC: CHIEF KITCHEN	-
	* * * * * * * * * * *	REC: FAX MACHINE REC: DEPUTY/WSHRM/C.I.B REC: MW KITCHEN SPLIT REC: KITCHEN REC: FRIDGE KITCHEN REC: ISSUE REC: ISSUE SPARE REC: VICTM INT/RCRDS/113 REC: RECORDS DESK HEATER: FRONT VEST	. 1 1 2 1 1 1 1 3 1 . 1	15 15 15 15 15 15 15 15 15 15 15	31 33 35 37 39 41 43 45 47 49 51 53 55 57	32 34 36 38 40 42 44 46 48 50 52 54 56 58	15 15 15 15 15 15 15 15 15 15 15	1 1 1 1 1 1 1 1 1 1	REC: INSPECTOR/COMM.RM REC: HALL/JAN/CORR/WSHRW REC: INSPECTOR/N.C.O./ISSUE REC: ISSUE/N.C.O./INTERVIEW SPARE REC: XEROX/INTERVIEW REC: C.I.B./C.I.B. OFF. REC: C.I.B./C.I.B. OFF. REC: MW KITCHEN REC: CHIEFS KTCH-FRIDGE	-
	* * * * * * * * * *	REC: FAX MACHINE REC: DEPUTY/WSHRM/C.I.B REC: MW KITCHEN SPLIT REC: KITCHEN REC: FRIDGE KITCHEN REC: ISSUE REC: ISSUE SPARE REC: VICTM INT/RCRDS/113 REC: RECORDS DESK HEATER: FRONT VEST REC: XEROX COPIER	. 1 1 2 1 1 1 1 3 1 . 1	15 15 15 15 15 15 15 15 15 15 15	31 33 35 37 39 41 43 45 47 49 51 53 55 57 59	32 34 36 38 40 42 44 46 48 50 52 54 56 58 60	15 15 15 15 15 15 15 15 15 15 15	1 1 1 1 1 1 1 1 1 1	REC: INSPECTOR/COMM.RM REC: HALL/JAN/CORR/WSHRM REC: INSPECTOR/N.C.O./ISSUE REC: ISSUE/N.C.O./INTERVIEW SPARE REC: XEROX/INTERVIEW REC: C.I.B./C.I.B. OFF. REC: C.I.B./C.I.B. OFF. REC: MW KITCHEN REC: CHIEFS KTCH-FRIDGE SPLIT REC: CHIEF KITCHEN	-
	* * * * * * * * *	REC: FAX MACHINE REC: DEPUTY/WSHRM/C.I.B REC: MW KITCHEN SPLIT REC: KITCHEN REC: FRIDGE KITCHEN REC: ISSUE REC: ISSUE SPARE REC: VICTM INT/RCRDS/11. REC: RECORDS DESK HEATER: FRONT VEST REC: XEROX COPIER SPACE	. 1 1 2 1 1 1 1 1 3 1 . 1 1 . 1	15 15 15 15 15 15 15 15 15 15 15 15	31 33 35 37 39 41 43 45 47 49 51 53 55 57 59 61	32 34 36 38 40 42 44 46 48 50 52 54 56 58 60 62	15 15 15 15 15 15 15 15 15 15 15	1 1 1 1 1 1 1 1 1 1	REC: INSPECTOR/COMM.RM REC: HALL/JAN/CORR/WSHRM REC: INSPECTOR/N.C.O./ISSUE REC: ISSUE/N.C.O./INTERVIEW SPARE REC: XEROX/INTERVIEW REC: C.I.B./C.I.B. OFF. REC: C.I.B./C.I.B. OFF. REC: MW KITCHEN REC: CHIEFS KTCH-FRIDGE SPLIT REC: CHIEF KITCHEN	-
	* * * * * * * * * * *	REC: FAX MACHINE REC: DEPUTY/WSHRM/C.I.B REC: MW KITCHEN SPLIT REC: KITCHEN REC: FRIDGE KITCHEN REC: ISSUE REC: ISSUE SPARE REC: VICTM INT/RCRDS/111 REC: RECORDS DESK HEATER: FRONT VEST REC: XEROX COPIER SPACE REC: IG PARADE RM	. 1 1 2 1 1 1 1 3 1 . 1 1 1 . 1 . 1 . 1 . 1 . 1 . 1 . 1 . 1 . 1	15 15	31 33 35 37 39 41 43 45 47 49 51 53 55 57 59 61 63	32 34 36 38 40 42 44 46 48 50 52 54 56 58 60 62 64	15 15 15 15 15 15 15 15 15 15 15	1 1 1 1 1 1 1 1 1 1	REC: INSPECTOR/COMM.RM REC: HALL/JAN/CORR/WSHRW REC: INSPECTOR/N.C.O./ISSUE REC: ISSUE/N.C.O./INTERVIEW SPARE REC: XEROX/INTERVIEW REC: C.I.B./C.I.B. OFF. REC: C.I.B./C.I.B. OFF. REC: MW KITCHEN REC: CHIEFS KTCH-FRIDGE SPLIT REC: CHIEF KITCHEN	-
	* * * * * * * * * * * * *	REC: FAX MACHINE REC: DEPUTY/WSHRM/C.I.B REC: MW KITCHEN SPLIT REC: KITCHEN REC: FRIDGE KITCHEN REC: ISSUE REC: ISSUE SPARE REC: VICTM INT/RCRDS/113 REC: RECORDS DESK HEATER: FRONT VEST REC: XEROX COPIER SPACE REC: IG PARADE RM REC: IG PARADE RM	. 1 1 2 1 1 1 1 1 3 1 1 . 1 1 1 1 1 1	15 15 15 15 15 15 15 15 15 15 15 15 15 1	31 33 35 37 39 41 43 45 47 49 51 53 55 57 59 61 63 65	32 34 36 38 40 42 44 46 48 50 52 52 54 56 58 60 62 64 66	15 15 15 15 15 15 15 15 15 15 15	1 1 1 1 1 1 1 1 1 1 1 2	REC: INSPECTOR/COMM.RM REC: HALL/JAN/CORR/WSHRW REC: INSPECTOR/N.C.O./ISSUE REC: ISSUE/N.C.O./INTERVIEW SPARE REC: XEROX/INTERVIEW REC: C.I.B./C.I.B. OFF. REC: C.I.B./C.I.B. OFF. REC: C.I.B./C.I.B. OFF. REC: CHIEFS KTCH–FRIDGE SPLIT REC: CHIEF KITCHEN SPACE	-
	* * * * * * * * * * * * *	REC: FAX MACHINE REC: DEPUTY/WSHRM/C.I.B REC: MW KITCHEN SPLIT REC: KITCHEN REC: FRIDGE KITCHEN REC: ISSUE REC: ISSUE SPARE REC: VICTM INT/RCRDS/113 REC: RECORDS DESK HEATER: FRONT VEST REC: XEROX COPIER SPACE REC: IG PARADE RM REC: IG PARADE RM REC: IG PARADE RM	. 1 1 2 1 1 1 1 3 1 . 1 1 1 . 1 . 1 . 1 . 1 . 1 . 1 . 1 . 1 . 1	15 15	31 33 35 37 39 41 43 45 47 49 51 53 55 57 59 61 63 65 67	32 34 36 38 40 42 44 46 48 50 52 52 54 56 58 60 62 64 66 68	15 15 15 15 15 15 15 15 15 15 15	1 1 1 1 1 1 1 1 1 1 1 2	REC: INSPECTOR/COMM.RM REC: HALL/JAN/CORR/WSHRW REC: INSPECTOR/N.C.O./ISSUE REC: ISSUE/N.C.O./INTERVIEW SPARE REC: XEROX/INTERVIEW REC: C.I.B./C.I.B. OFF. REC: C.I.B./C.I.B. OFF. REC: C.I.B./C.I.B. OFF. REC: CHIEFS KTCH-FRIDGE SPLIT REC: CHIEF KITCHEN SPACE REC: PARADE RM PRINTER	-
	* * * * * * * * * * * * *	REC: FAX MACHINE REC: DEPUTY/WSHRM/C.I.B REC: MW KITCHEN SPLIT REC: KITCHEN REC: FRIDGE KITCHEN REC: ISSUE REC: ISSUE SPARE REC: VICTM INT/RCRDS/113 REC: RECORDS DESK HEATER: FRONT VEST REC: XEROX COPIER SPACE REC: IG PARADE RM REC: IG PARADE RM	. 1 1 2 1 1 1 1 1 3 1 1 . 1 1 1 1 1 1	15 15	31 33 35 37 39 41 43 45 47 49 51 53 55 57 59 61 63 65 67 69	32 34 36 38 40 42 44 46 48 50 52 54 56 58 60 62 64 66 68 70	15 15 15 15 15 15 15 15 15 15 15	1 1 1 1 1 1 1 1 1 1 1 2	REC: INSPECTOR/COMM.RM REC: HALL/JAN/CORR/WSHRW REC: INSPECTOR/N.C.O./ISSUE REC: ISSUE/N.C.O./INTERVIEW SPARE REC: XEROX/INTERVIEW REC: C.I.B./C.I.B. OFF. REC: C.I.B./C.I.B. OFF. REC: C.I.B./C.I.B. OFF. REC: CHIEFS KTCH–FRIDGE SPLIT REC: CHIEF KITCHEN SPACE	-
	* * * * * * * * * * * * *	REC: FAX MACHINE REC: DEPUTY/WSHRM/C.I.B REC: MW KITCHEN SPLIT REC: KITCHEN REC: FRIDGE KITCHEN REC: ISSUE REC: ISSUE SPARE REC: VICTM INT/RCRDS/113 REC: RECORDS DESK HEATER: FRONT VEST REC: XEROX COPIER SPACE REC: IG PARADE RM REC: IG PARADE RM REC: IG PARADE RM	. 1 1 2 1 1 1 1 1 3 1 1 . 1 1 1 1 1 1	15 15	31 33 35 37 39 41 43 45 47 49 51 53 55 57 59 61 63 65 67 69 71	32 34 36 38 40 42 44 46 48 50 52 54 56 58 60 62 64 66 68 70 72	15 15 15 15 15 15 15 15 15 15 15	1 1 1 1 1 1 1 1 1 1 1 2	REC: INSPECTOR/COMM.RM REC: HALL/JAN/CORR/WSHRW REC: INSPECTOR/N.C.O./ISSUE REC: ISSUE/N.C.O./INTERVIEW SPARE REC: XEROX/INTERVIEW REC: C.I.B./C.I.B. OFF. REC: C.I.B./C.I.B. OFF. REC: C.I.B./C.I.B. OFF. REC: CHIEFS KTCH-FRIDGE SPLIT REC: CHIEF KITCHEN SPACE REC: PARADE RM PRINTER	-
	* * * * * * * * * * * * *	REC: FAX MACHINE REC: DEPUTY/WSHRM/C.I.B REC: MW KITCHEN SPLIT REC: KITCHEN REC: FRIDGE KITCHEN REC: ISSUE REC: ISSUE SPARE REC: VICTM INT/RCRDS/113 REC: RECORDS DESK HEATER: FRONT VEST REC: XEROX COPIER SPACE REC: IG PARADE RM REC: IG PARADE RM REC: IG PARADE RM	. 1 1 2 1 1 1 1 1 3 1 1 . 1 1 1 1 1 1	15 15	31 33 35 37 39 41 43 45 47 49 51 55 57 59 61 63 65 67 69 71 73	32 34 36 38 40 42 44 46 48 50 52 54 56 58 60 62 64 66 68 70 72 74	15 15 15 15 15 15 15 15 15 15 15	1 1 1 1 1 1 1 1 1 1 1 2	REC: INSPECTOR/COMM.RM REC: HALL/JAN/CORR/WSHRW REC: INSPECTOR/N.C.O./ISSUE REC: ISSUE/N.C.O./INTERVIEW SPARE REC: XEROX/INTERVIEW REC: C.I.B./C.I.B. OFF. REC: C.I.B./C.I.B. OFF. REC: C.I.B./C.I.B. OFF. REC: CHIEFS KTCH-FRIDGE SPLIT REC: CHIEF KITCHEN SPACE REC: PARADE RM PRINTER	-
	* * * * * * * * * * * * *	REC: FAX MACHINE REC: DEPUTY/WSHRM/C.I.B REC: MW KITCHEN SPLIT REC: KITCHEN REC: FRIDGE KITCHEN REC: ISSUE REC: ISSUE SPARE REC: VICTM INT/RCRDS/113 REC: RECORDS DESK HEATER: FRONT VEST REC: XEROX COPIER SPACE REC: IG PARADE RM REC: IG PARADE RM REC: IG PARADE RM	. 1 1 2 1 1 1 1 1 3 1 1 . 1 1 1 1 1 1	15 15	31 33 35 37 39 41 43 45 47 49 51 53 55 57 59 61 63 65 67 69 71 73 75	32 34 36 38 40 42 44 46 48 50 52 54 56 58 60 62 64 66 68 70 72 74 76	15 15 15 15 15 15 15 15 15 15 15	1 1 1 1 1 1 1 1 1 1 1 2	REC: INSPECTOR/COMM.RM REC: HALL/JAN/CORR/WSHRW REC: INSPECTOR/N.C.O./ISSUE REC: ISSUE/N.C.O./INTERVIEW SPARE REC: XEROX/INTERVIEW REC: C.I.B./C.I.B. OFF. REC: C.I.B./C.I.B. OFF. REC: C.I.B./C.I.B. OFF. REC: CHIEFS KTCH-FRIDGE SPLIT REC: CHIEF KITCHEN SPACE REC: PARADE RM PRINTER	-
	* * * * * * * * * * * * *	REC: FAX MACHINE REC: DEPUTY/WSHRM/C.I.B REC: MW KITCHEN SPLIT REC: KITCHEN REC: FRIDGE KITCHEN REC: ISSUE REC: ISSUE SPARE REC: VICTM INT/RCRDS/113 REC: RECORDS DESK HEATER: FRONT VEST REC: XEROX COPIER SPACE REC: IG PARADE RM REC: IG PARADE RM REC: IG PARADE RM	. 1 1 2 1 1 1 1 1 3 1 1 . 1 1 1 1 1 1	15 15 15 15 15 15 15 15 15 15 15 15 15 1	31 33 35 37 39 41 43 45 47 49 51 53 57 59 61 63 65 67 69 71 73 75 77	32 34 36 38 40 42 44 46 48 50 52 54 56 58 60 62 64 66 68 70 72 74 76 78	15 15 15 15 15 15 15 15 15 15 15	1 1 1 1 1 1 1 1 1 1 1 2	REC: INSPECTOR/COMM.RM REC: HALL/JAN/CORR/WSHRW REC: INSPECTOR/N.C.O./ISSUE REC: ISSUE/N.C.O./INTERVIEW SPARE REC: XEROX/INTERVIEW REC: C.I.B./C.I.B. OFF. REC: C.I.B./C.I.B. OFF. REC: C.I.B./C.I.B. OFF. REC: CHIEFS KTCH-FRIDGE SPLIT REC: CHIEF KITCHEN SPACE REC: PARADE RM PRINTER	-
	* * * * * * * * * * * * *	REC: FAX MACHINE REC: DEPUTY/WSHRM/C.I.B REC: MW KITCHEN SPLIT REC: KITCHEN REC: FRIDGE KITCHEN REC: ISSUE REC: ISSUE SPARE REC: VICTM INT/RCRDS/113 REC: RECORDS DESK HEATER: FRONT VEST REC: XEROX COPIER SPACE REC: IG PARADE RM REC: IG PARADE RM REC: IG PARADE RM	. 1 1 2 1 1 1 1 1 3 1 1 . 1 1 1 1 1 1	15 15 15 15 15 15 15 15 15 15 15 15 15 1	31 33 35 37 39 41 43 45 47 49 51 53 55 57 59 61 63 65 67 69 71 73 75	32 34 36 38 40 42 44 46 48 50 52 54 56 58 60 62 64 66 68 70 72 74 76	15 15 15 15 15 15 15 15 15 15 15	1 1 1 1 1 1 1 1 1 1 1 2	REC: INSPECTOR/COMM.RM REC: HALL/JAN/CORR/WSHRW REC: INSPECTOR/N.C.O./ISSUE REC: ISSUE/N.C.O./INTERVIEW SPARE REC: XEROX/INTERVIEW REC: C.I.B./C.I.B. OFF. REC: C.I.B./C.I.B. OFF. REC: C.I.B./C.I.B. OFF. REC: CHIEFS KTCH-FRIDGE SPLIT REC: CHIEF KITCHEN SPACE REC: PARADE RM PRINTER	-

REVIEW ALL DRAWINGS AND VERIFY ALL DIMENSIONS AT THE SITE. DO NOT SCALE THE DRAWINGS. REPORT ALL DISCREPANCIES TO THE ENGINEER BEFORE PROCEEDING WITH ANY CONSTRUCTION OR SHOP FABRICATION. ALL DRAWINGS, SPECIFICATIONS AND RELATED DOCUMENTS ARE THE COPYRIGHT PROPERTY OF `VANDERWESTEN & RUTHERFORD ASSOCIATES INC.' AND MUST BE RETURNED UPON REQUEST. REPRODUCTION OF DRAWINGS, SPECIFICATIONS AND RELATED DOCUMENTS IN PART OR WHOLE IS FORBIDDEN WITHOUT THE ENGINEER'S WRITTEN PERMISSION.

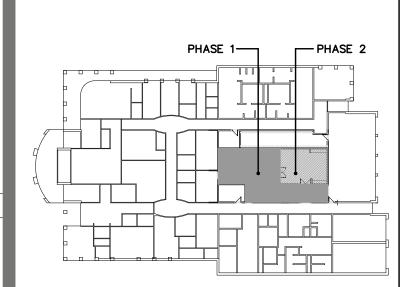

KEY PLAN

•



2

No.

Project:

Vanderwesten & Rutherford Assoc Mechanical & Electrical Engineers London . Windsor . Ottawa www.vreng.ca | 519-652-5047

05/04/2020 VT

03/10/2020 VT


Date By

3 Issued for Permit & Tender - Phase 1 03/09/2021 VT

Issued for Tender

Issued for Costing

Issued

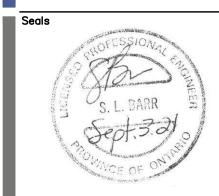

KAWARTHA LAKES POLICE SERVICE BUILDING RENOVATIONS

Drawing Title: SINGLE LINE DIAGRAM AND PANEL SCHEDULES

Drawn By: RR Date: JUNE 18, 2020 Project Number: VR-19-160

Checked By: SB Scale: N.T.S. Drawing No.: E500