
# CHRISTOPHER CATHOLIC SCHOOL ASPHALT PLAY AREA PLAYING FIELD ASPHALT PLAY AREA

1 SITE PLAN A1 SCALE 1:1000

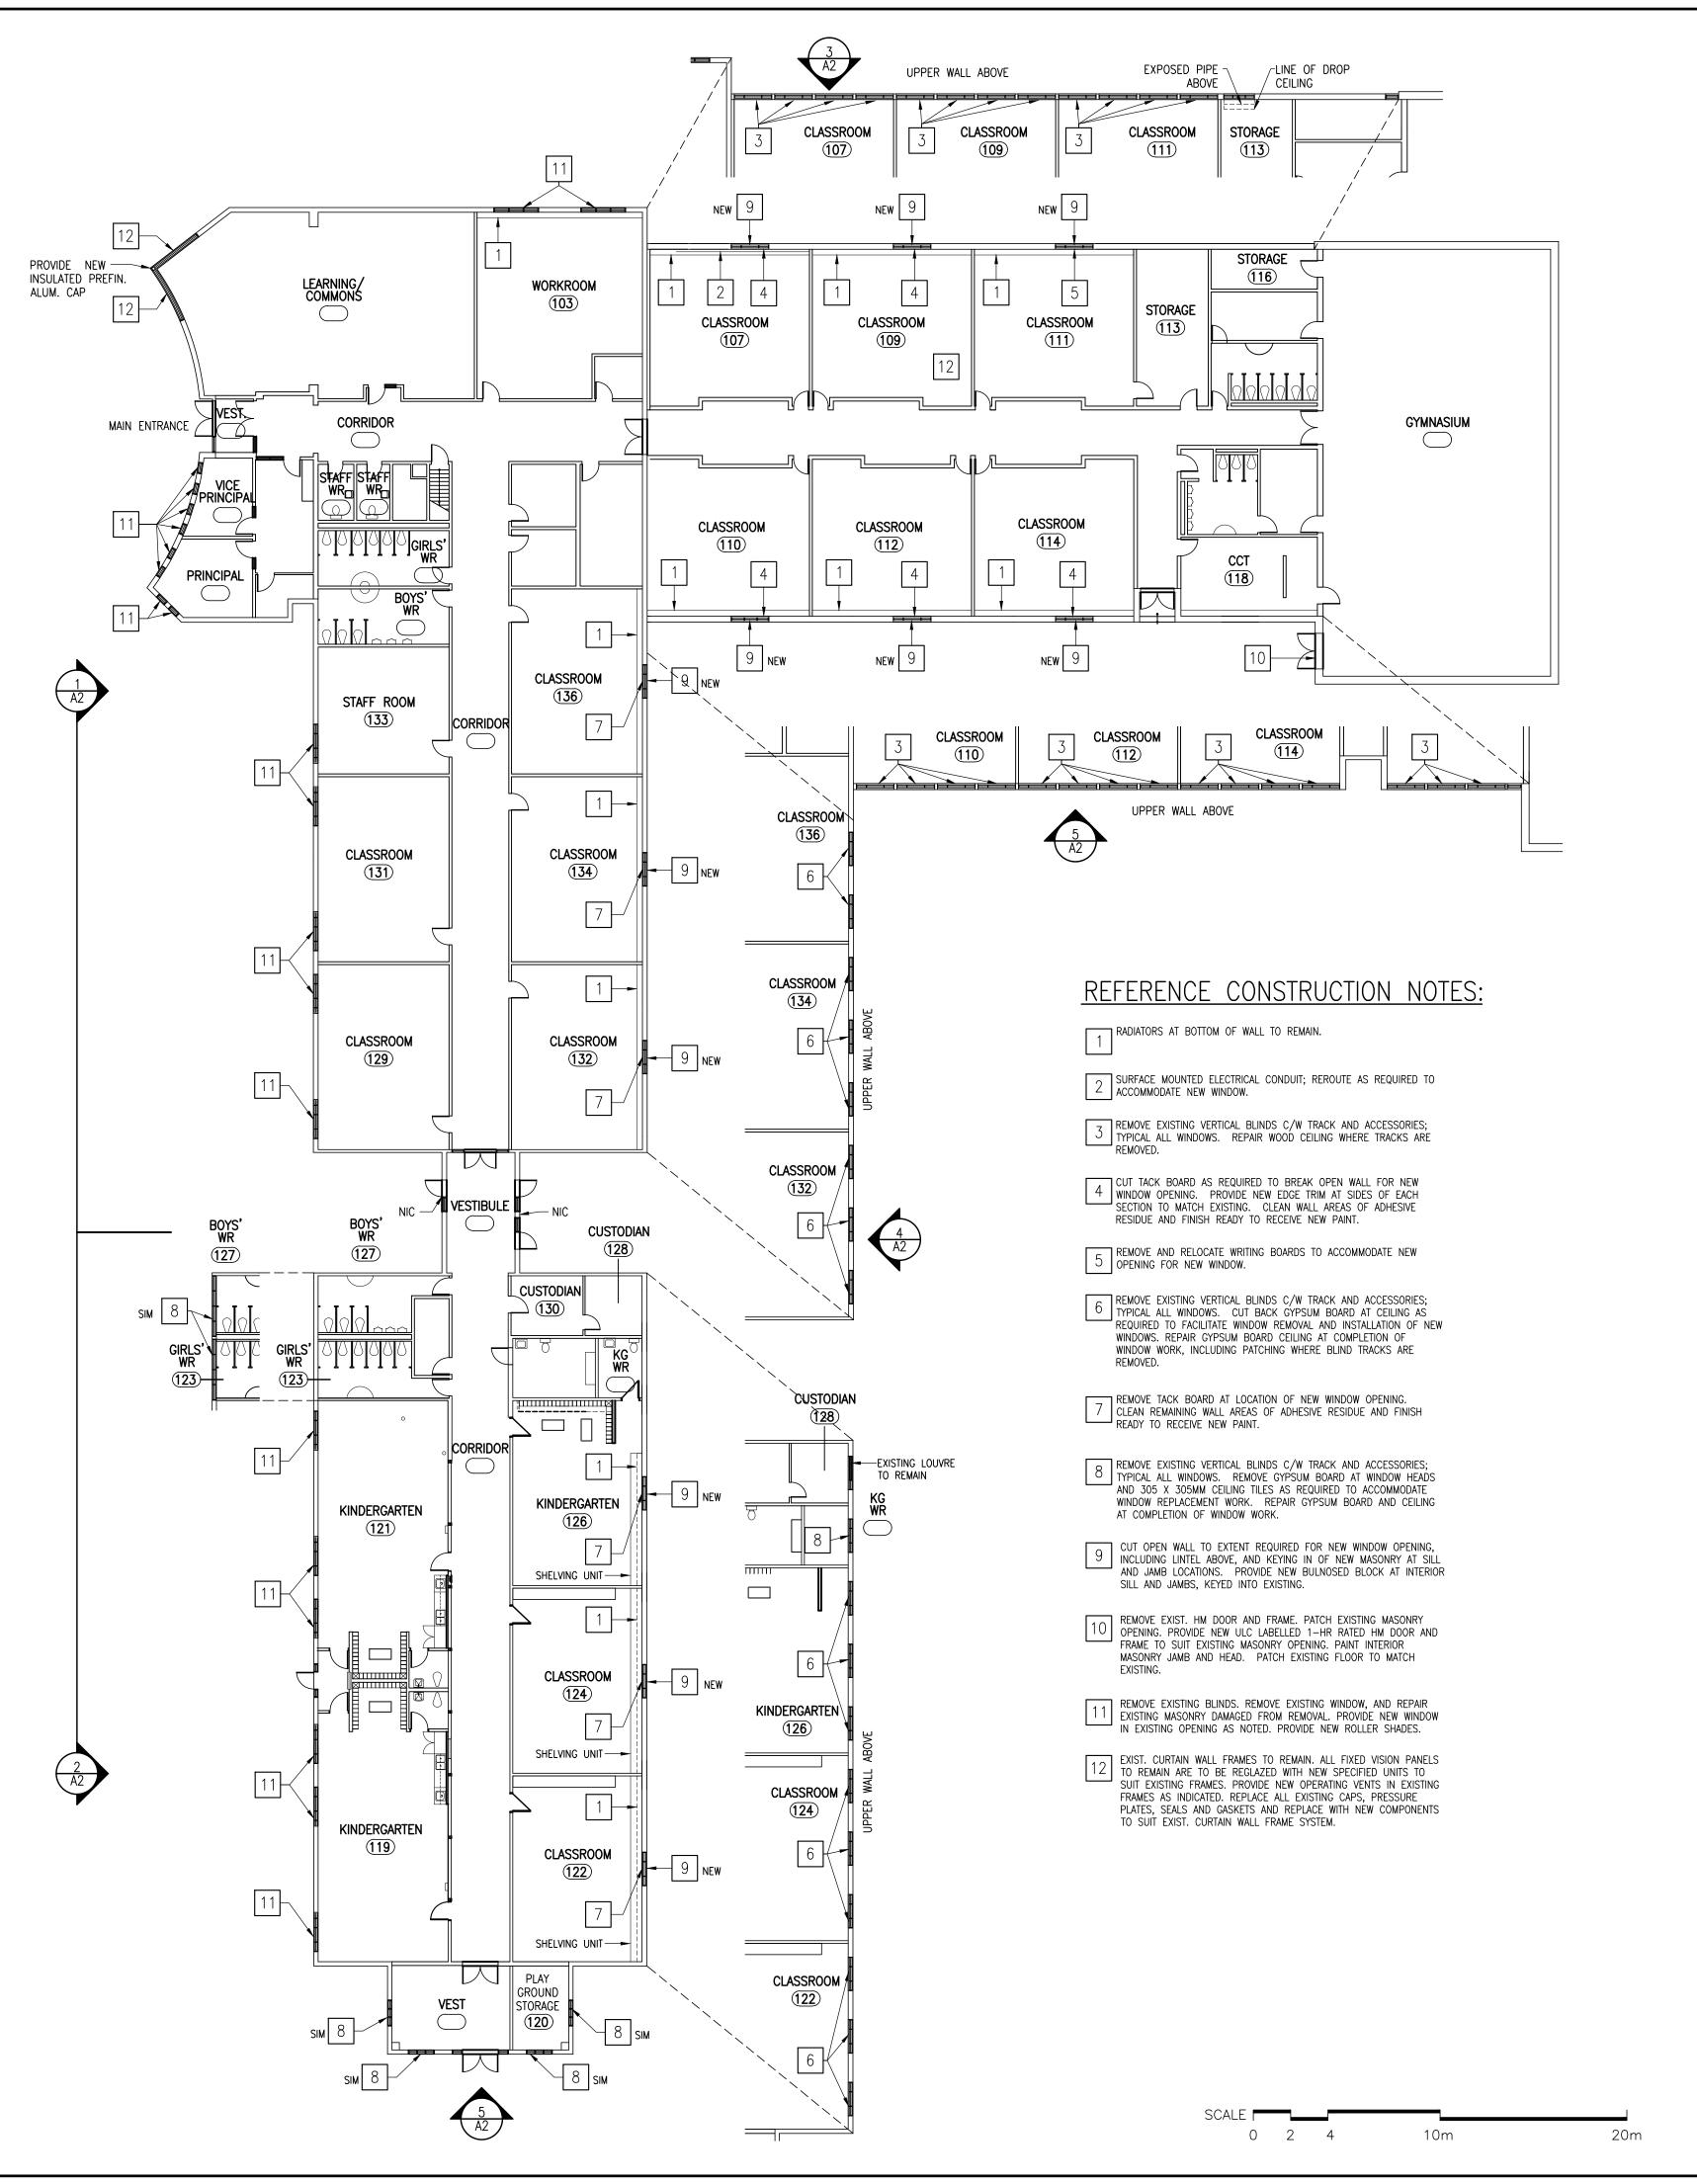


## TENDER NO. T20-40

## GENERAL NOTES

- 1) SITE VERIFY ALL EXISTING OPENINGS
- 2) DRAWINGS ARE BASED ON EXISTING DRAWINGS AVAILABLE AND NON-DESTRUCTIVE SITE OBSERVATIONS. DRAWINGS MAY NOT ACCURATELY REFLECT AS BUILT CONDITIONS; CONFIRM EXISTING CONDITIONS ON SITE.
- 3) NEW WINDOW BLINDS (BY CASH ALLOWANCE)
- 4) DRYWALL & WALLPAPER REPAIRS AT JAMBS AND SILLS IN ADMIN ALL DRYWALL TO BE ABUSE RESISTANT, MOULD RESISTANT BOARDS, AS SPECIFIED.
- 5) 25MM X 150MM DEEP FRAMES FOR WINDOWS
- 6) PATCH INTO EXISTING A/V BARRIER AT WINDOWS IF EXISTING

### **GENERAL DEMOLITION NOTES:**

- 1) ALL REFERENCES TO REMOVE MEANS REMOVE & DISPOSE OF UNLESS OTHERWISE NOTED.
- 2) SALVAGE AND HAND OVER BUILDING COMPONENTS AS SPECIFIED.
- 3) DO NOT STOCKPILE CONSTRUCTION MATERIALS ADJACENT TO THE EXISTING BUILDING.
- 4) ALL EXTERIOR ALUMINUM WINDOWS ARE TO BE REMOVED AND REPLACED UNLESS NOTED OTHERWISE. REFER TO EXTERIOR ELEVATIONS AND WINDOW SCHEDULE.
- 5) ALL EXISTING H.M. DOORS AND FRAMES ARE TO REMAIN UNLESS NOTED OTHERWISE.

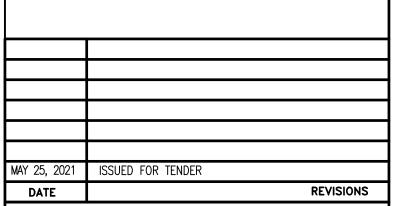

## ST. CHRISTOPHER CATHOLIC SCHOOL WINDOW REPLACEMENT 2021

456 ANNAPOLIS AVE.



GROUND FLOOR PLAN

O ARCHITECTS Z LICENCE

5052 DUNDAS ST. WEST ISLINGTON, ONT. M9A 1B9 TEL: (416) 239-2775 FAX: (416) 239-6729

TEL: FAX: EMAIL:


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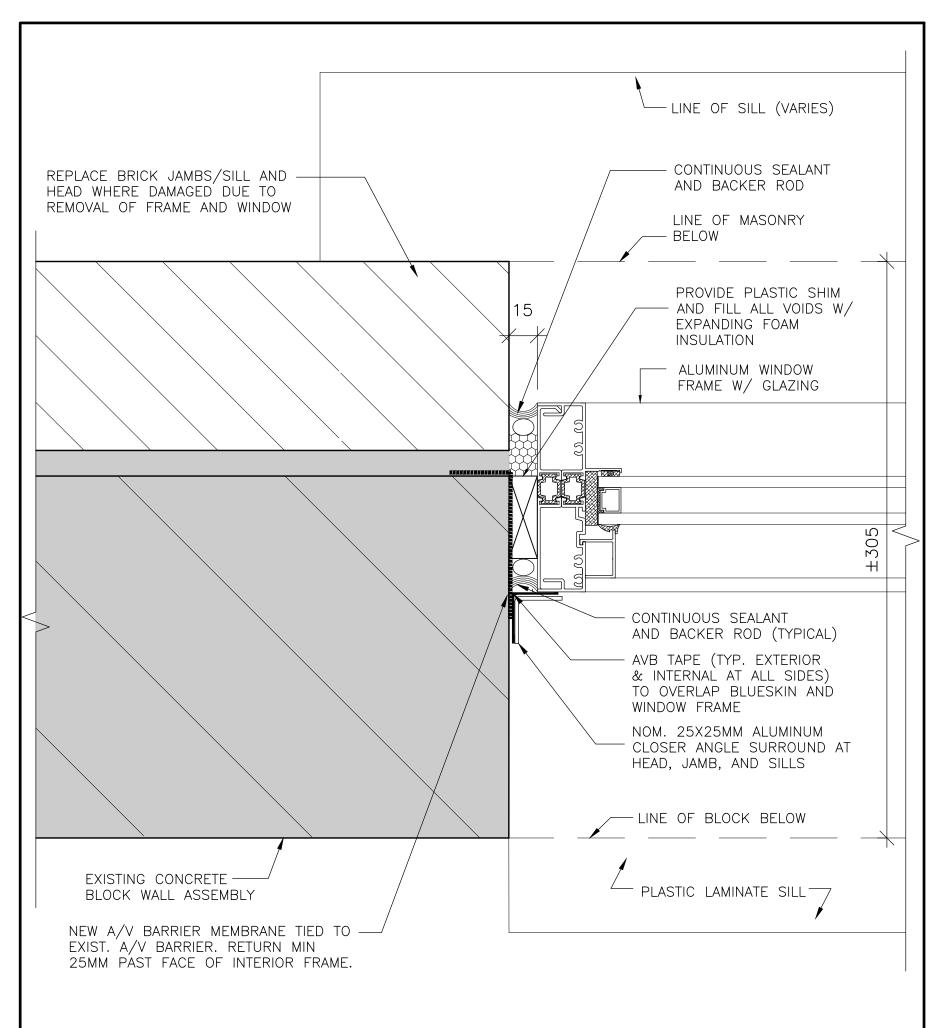
OSHAWA, ONTARIO

DRAWING


MOFFET & DUNCAN architects inc.

MAY 25, 2021




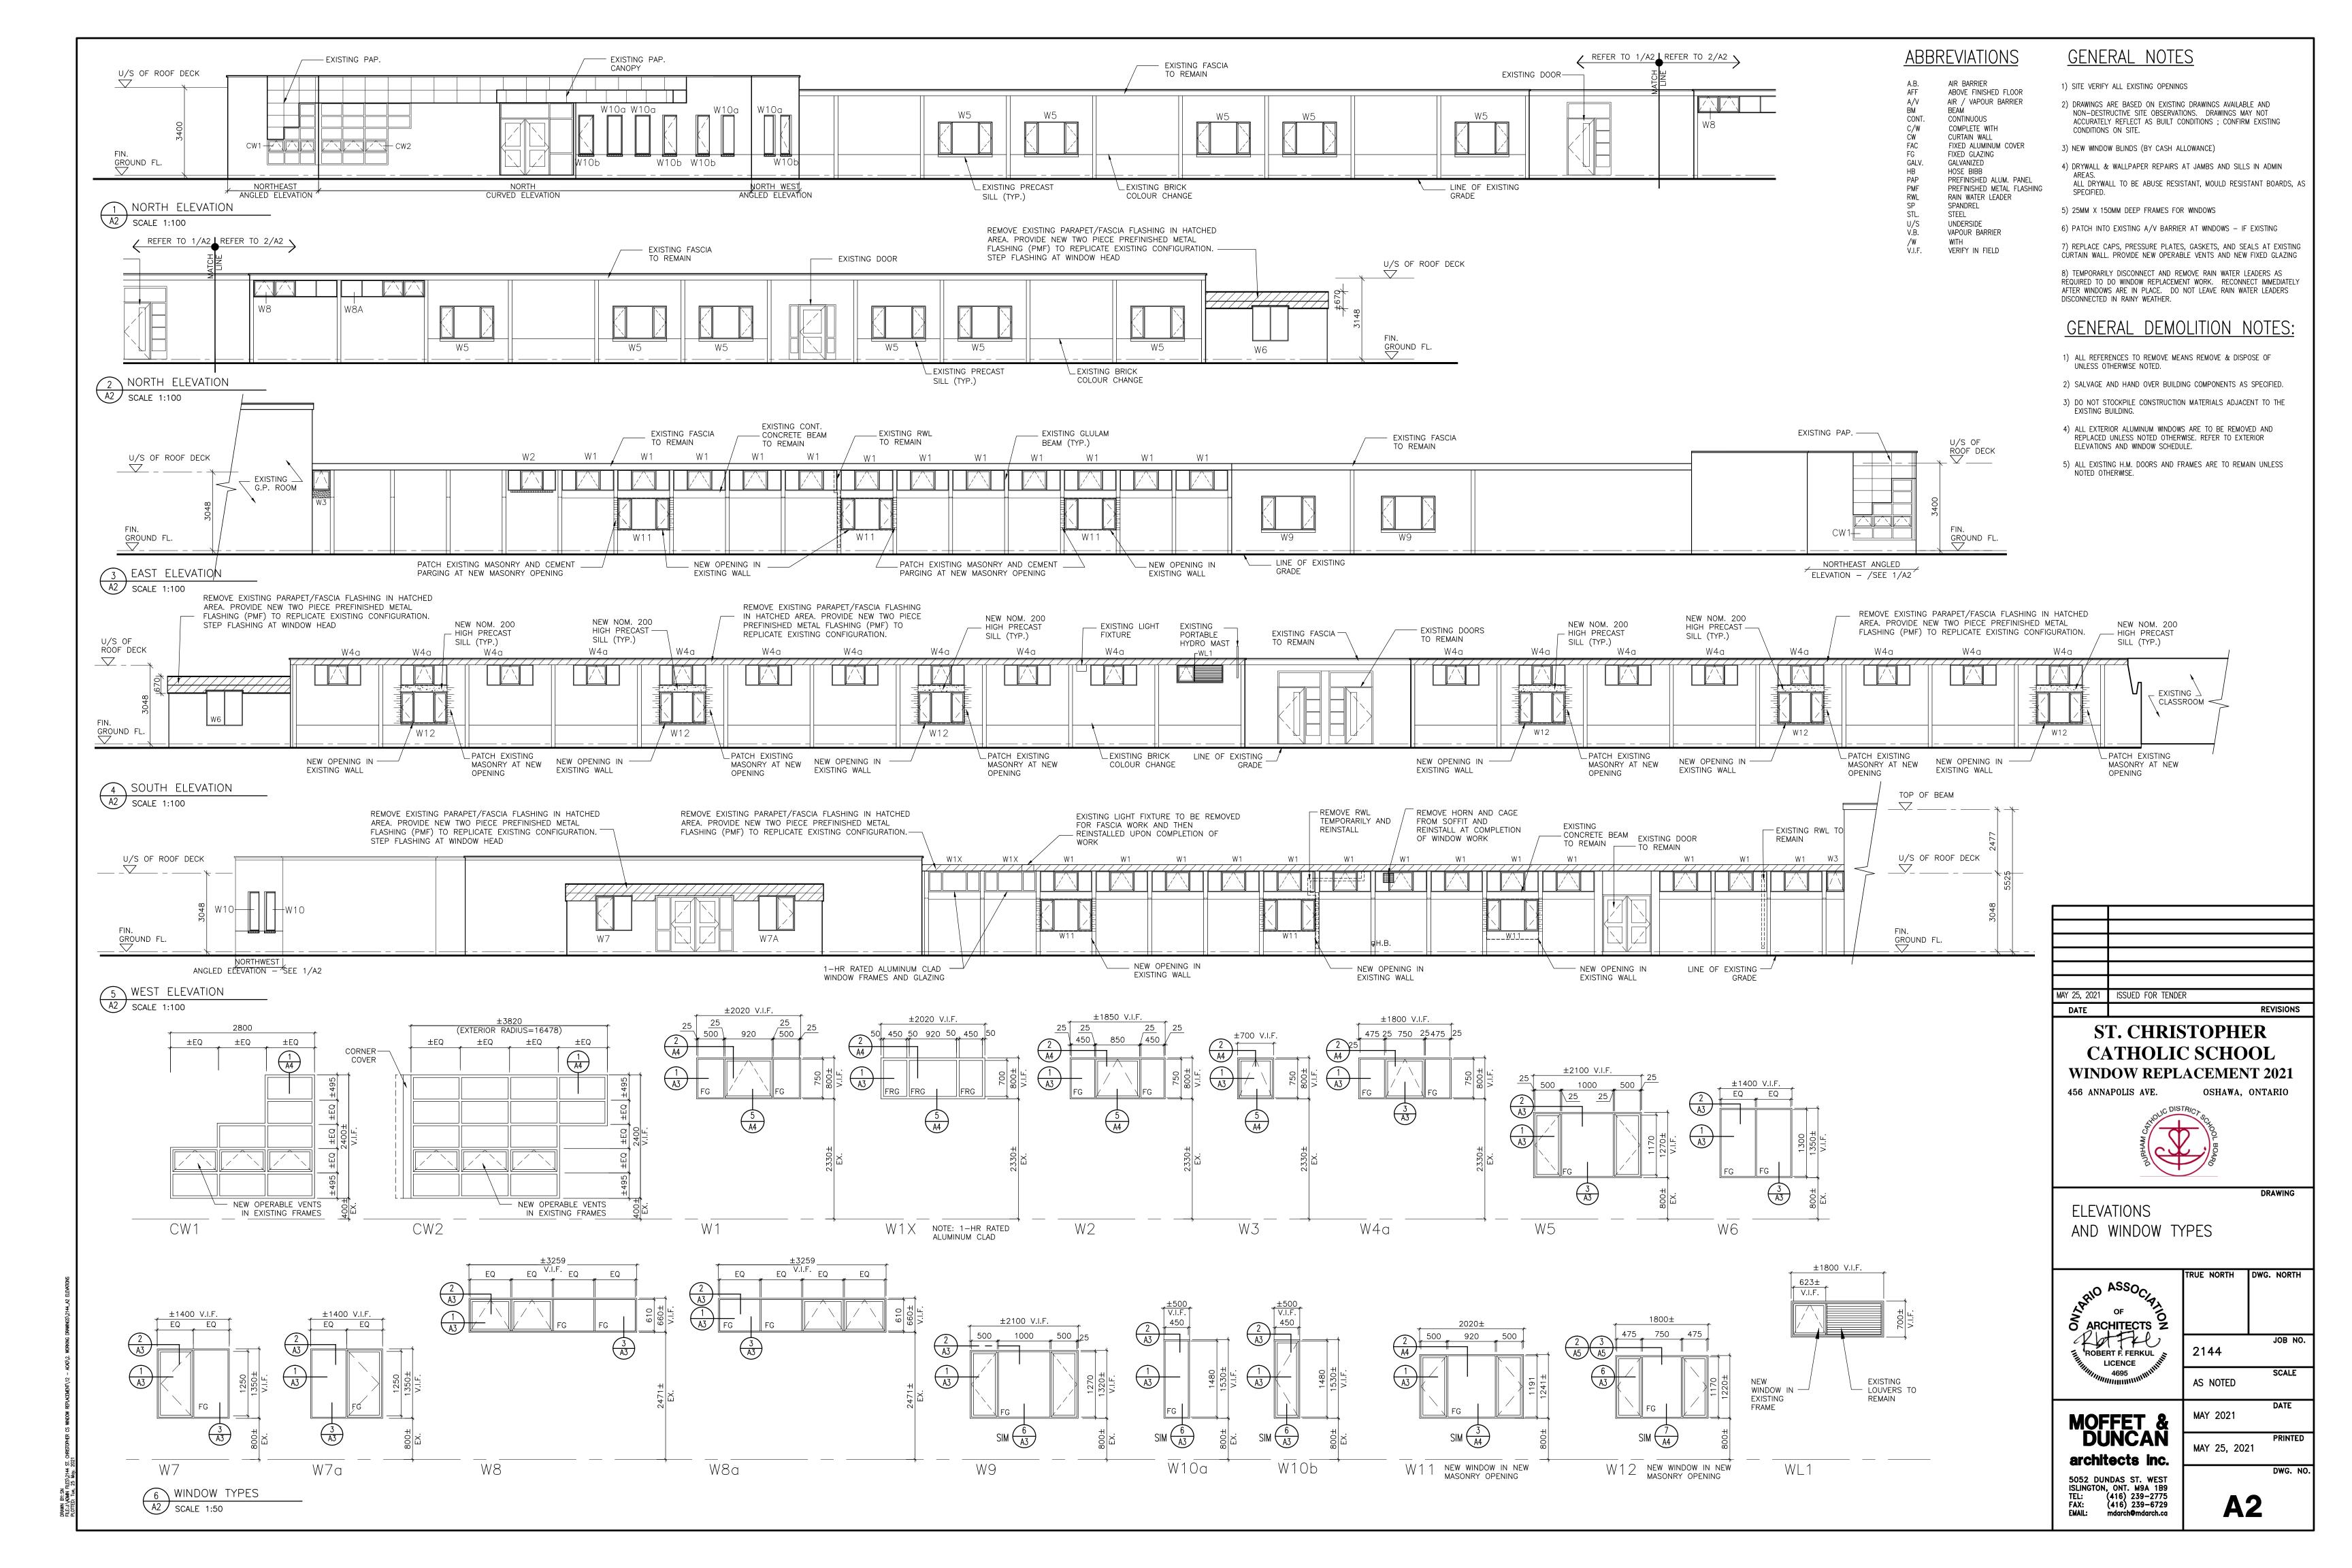


1 WINDOW FRAME DETAIL A3 SCALE 1:2

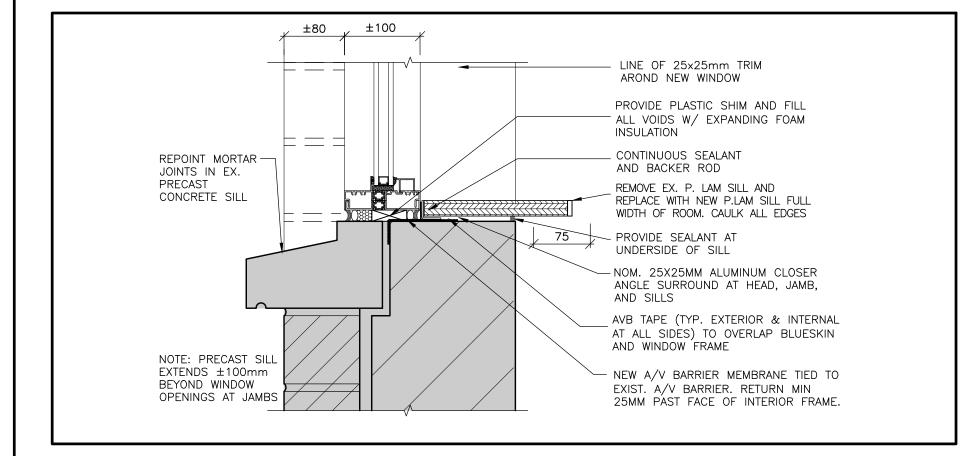


6 EXTERIOR SILL TYPE 2 PRECAST CONCRETE SILL A3 SCALE 1:5

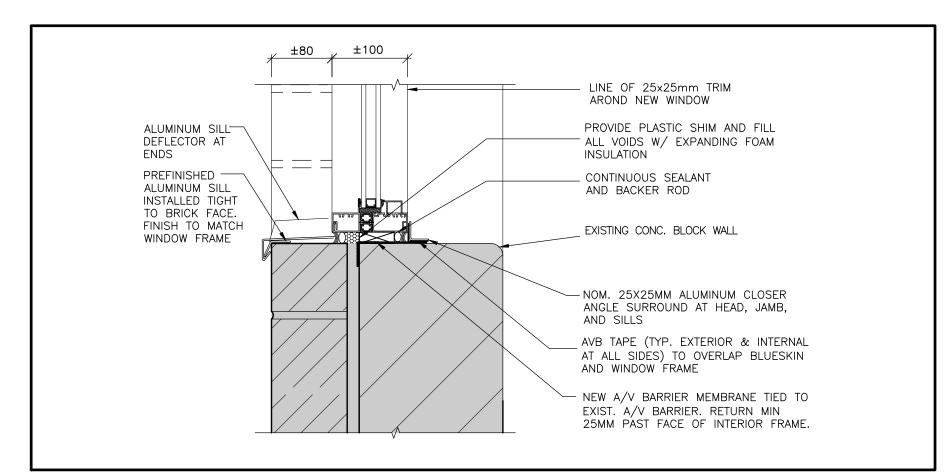


7 EXTERIOR SILL DETAIL AT WEST VESTIBULE & PLAY STORAGE 120 A3 SCALE 1:5

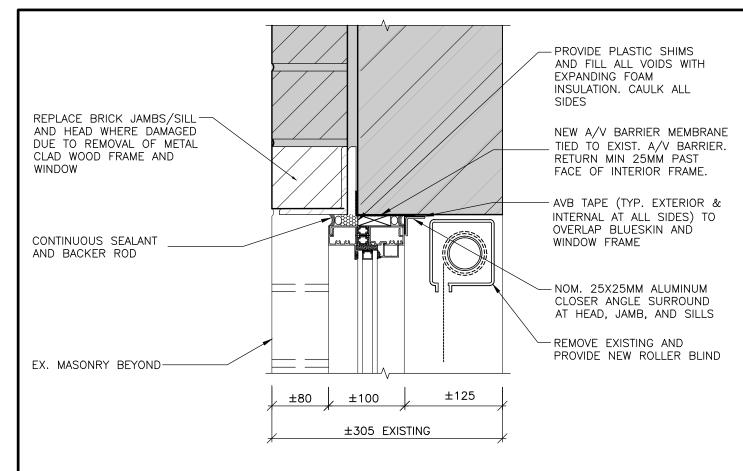


WINDOW HEAD DETAIL \A3/ SCALE 1:5

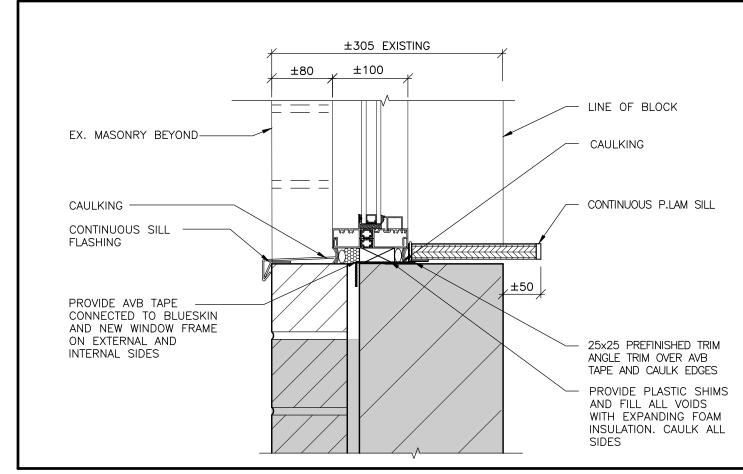


3 WINDOW SILL DETAIL \A3 SCALE 1:5

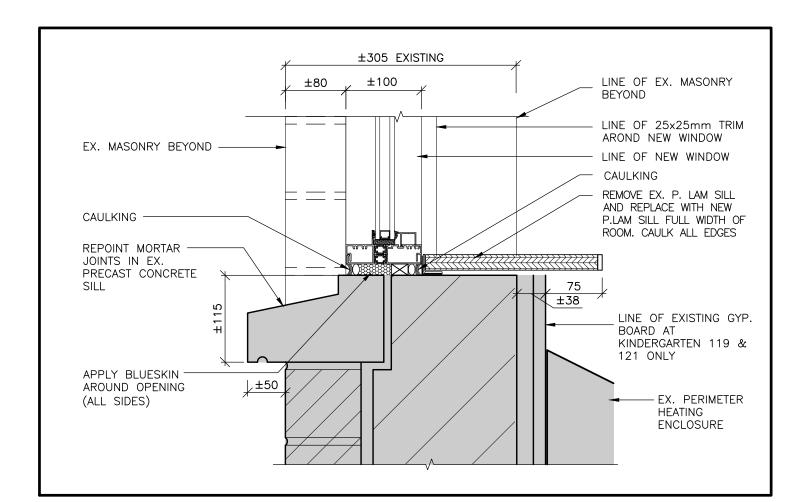


4 PRECAST EXTERIOR SILL DETAIL AT KINDERGARTEN 119 & 121 A3 SCALE 1:5

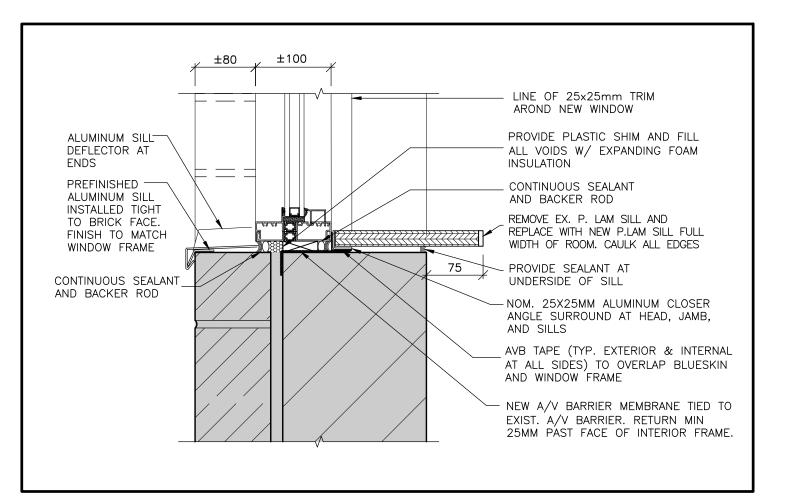

5 EXTERIOR SILL TYPE 1 PREFINISHED ALUMINUM SILL A3 SCALE 1:5

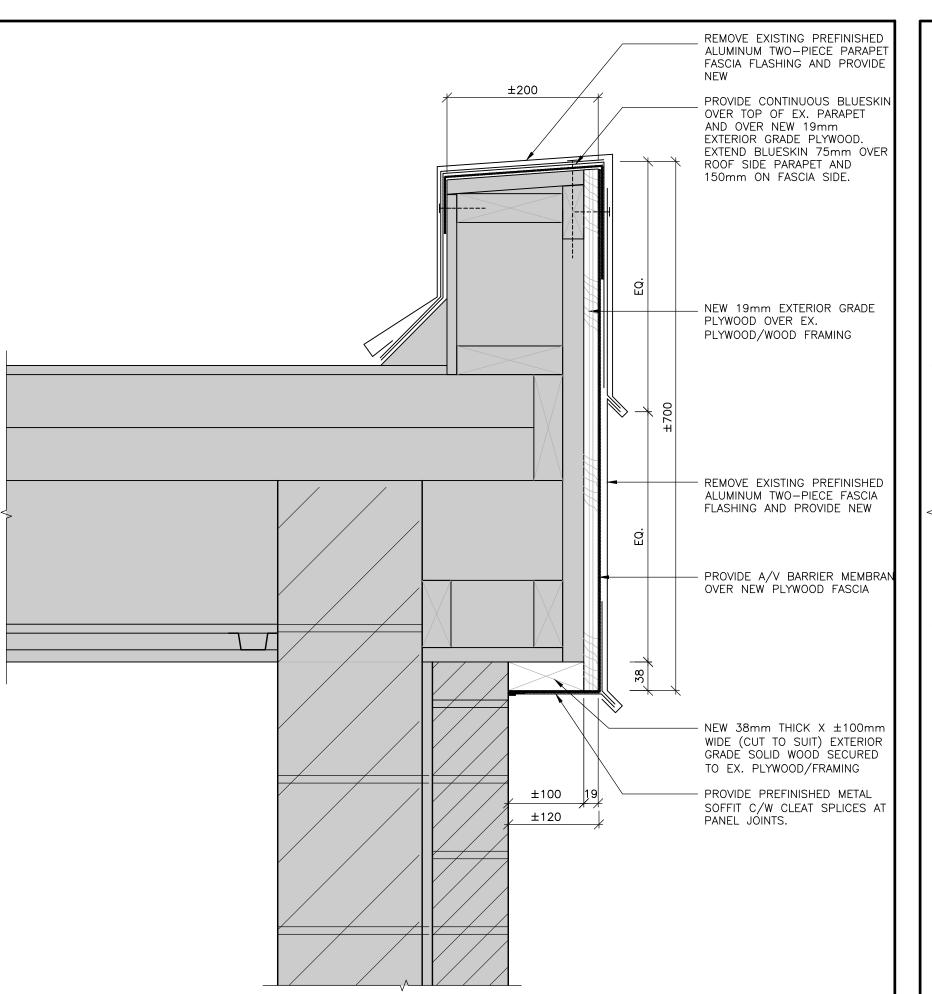

8 TYPICAL FASCIA AT SOUTH ELEVATION WINDOW TYPES AND SOUTH/NORTH ELEVATION WINDOW TYPES A3 SCALE 1:5

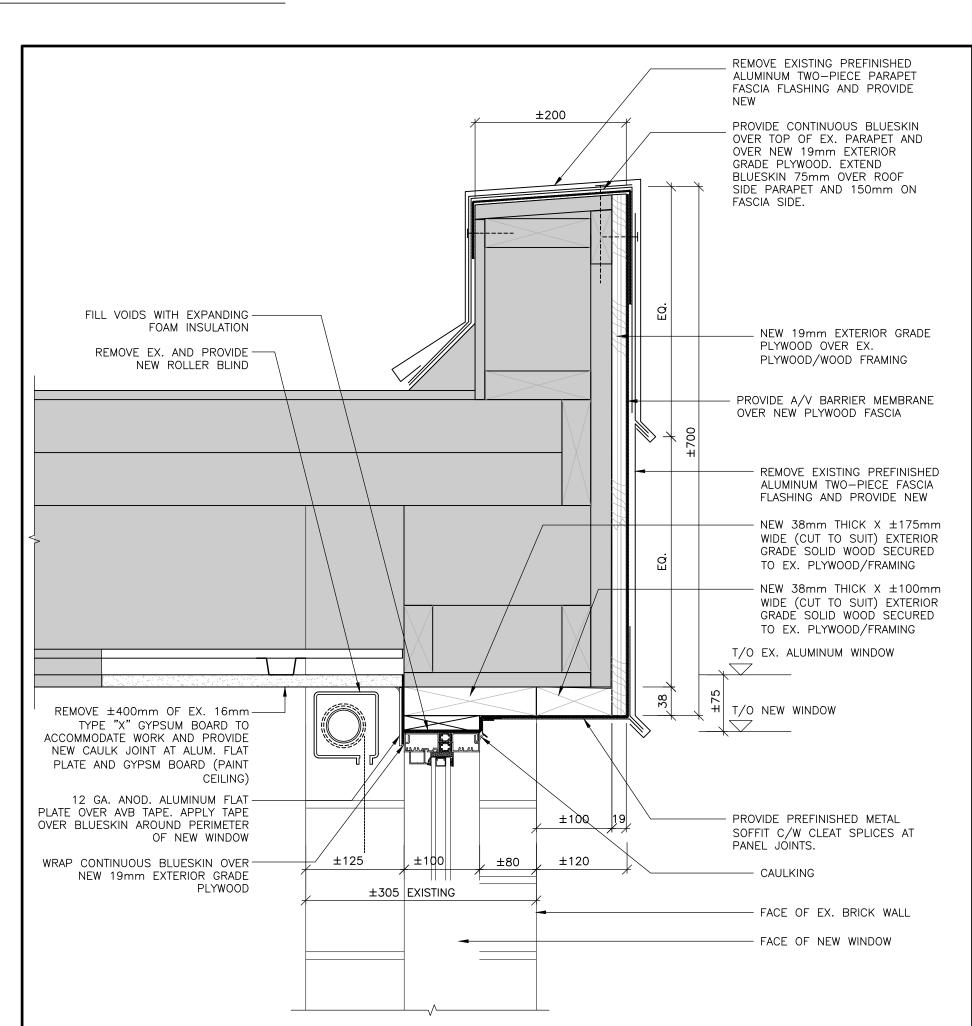

#### 9 TYPICAL FASCIA AND WINDOW HEAD DETAIL AT WINDOW TYPES A3 SCALE 1:5

GENERAL CONSTRUCTION NOTES


- .1 EXECUTE DEMOLITION / REMOVAL WORK IN CAREFUL MANNER SO AS NOT TO DAMAGE EXISTING SURFACES.

  2 REMOVE EXISTING BLINDS, AND REPLACE WITH NEW ROLLER SHADES. .3 CAREFULLY REMOVE AND DISPOSE OF ALUMINUM WINDOWS INCLUDING CAULKING AND SEALANTS.
- .4 CONTRACTOR SHALL BE RESPONSIBLE FOR MEASURING ALL WINDOW .5 PROVIDE SHOP DRAWINGS FOR ALL PRODUCTS USED INCLUDING WINDOWS, PLASTIC LAMINATE STOOLS, AND CEILING TRIM. .6 PROTECT OPENINGS WITH PLYWOOD WHEN REQUIRED FOR OVERNIGHT .7 PROTECT OPENINGS FROM ALL POSSIBLE WEATHER DAMAGE.
- .1 REPLACE DAMAGED BRICK WITH BRICK OF SIMILAR SIZE, COLOUR AND

.8 COORDINATE SCHEDULE WITH OWNER.

INDUSTRIES #40.

- TEXTURE. USE TWO (2) STAIN BRICK TO MATCH EXISTING. .1 SILPRUF SCS9000NB MANUFACTURED BY CANADIAN GENERAL ELECTRIC OR DOW CORNING 756 SMS OR TREMCO SPECTRUM 3 CONFORMING TO
- ASTM C920 TYPE S, GRADE NS, CLASS 50 FOR INTERIOR AND EXTERIOR .2 BOND BREAKER SHALL BE PRESSURE SENSITIVE PLASTIC TAPE BACKING MATERIAL WHICH WILL NOT BOND TO SEALANT 3M #226 OR VALLEY
- .3 COLOURS OF SEALANTS AND CAULKING TO LATER SELECTION BY CONSULTANT. .4 JOINT BACKING MATERIAL SHALL BE SOF ROD BY TRMECO ON VERTICAL SURFACES AND STANDARD TREMCO BACKER ROD ON HORIZONTAL
- .1 REMOVE DUST, GREASE, RUST FROM ALL SURFACES AND SAND TO ROUGH FINISH PRIOR TO PAINTING. .2 REMOVE MILDEW WITH TRI-SODIUM PHOSPHATE SOLUTION (150G) AND BLEACH (125 G) PER 3.5 L CLEAN WATER .3 PAINT SHÀLL BÉ LATEX BASED LOW VOC WITH SEMI-GLOSS FINISH TO MATCH FXISTING .4 SURFACES TO BE REPAINTED ARE TO BE PRIMED IN ACCORDANCE WITH
- MPI MAINTENANCE REPAINTING MANUAL RECOMMENDATIONS LEVEL DSD-3 FULL PRIME COAT. .5 PAINTING SHALL MEET MPI STANDARDS FOR RIN 4.2D - G5 FOR REPAINTING WORK INCLUDING 1 COAT BONDING PRIMER (MPI #17 X-GREEN) AND TWO FINISH COATS MPI #141, VOC RANGE E3. .6 PAINT INTERIOR WALLS (FULL WIDTH/HEIGHT) OF ALL WALLS WHERE WINDOWS ARE REPLACED (TYPICAL)
- (SEE SPECIFICATIONS SECTION 08 51 13 ALUMINUM WINDOWS)
- WINDOW OPENING NOTES .1 PROVIDE ±80MM LIMIT STOPS ON WINDOW OPENING IN STUDENT PLAY .2 PROVIDE ±150MM LIMIT STOPS ON WINDOW OPENING IN NON-STUDENT

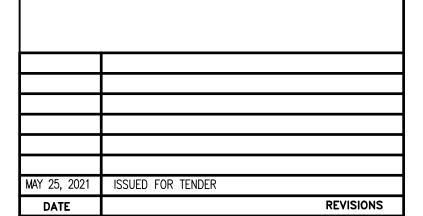


## ST. CHRISTOPHER CATHOLIC SCHOOL WINDOW REPLACEMENT 2021

456 ANNAPOLIS AVE. OSHAWA, ONTARIO



WINDOW DETAILS

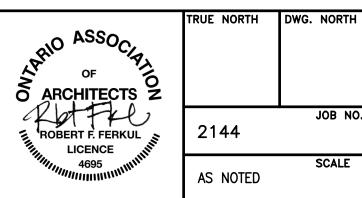


JOB NO. 2144 SCALE AS NOTED


DRAWING

MOFFET & DUNCAN architects inc. 5052 DUNDAS ST. WEST ISLINGTON, ONT. M9A 1B9 TEL: (416) 239-2775 FAX: (416) 239-6729

MAY 2021 MAY 25, 2021 DWG. NO

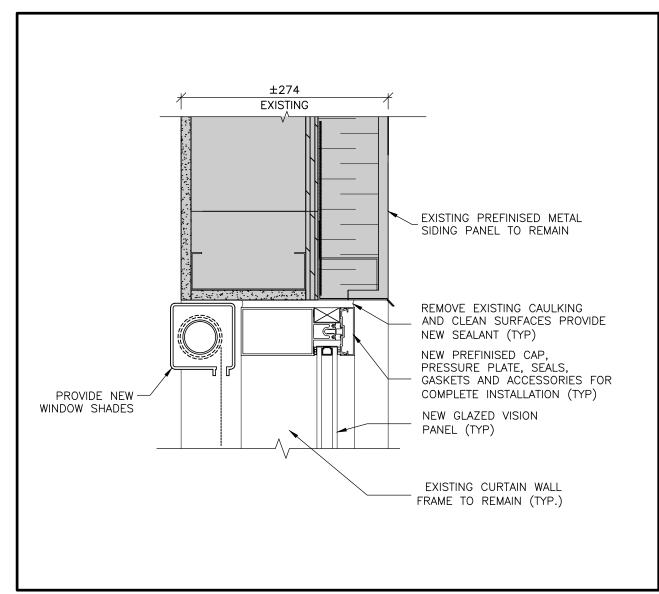

NOM. SEX 40 WD BLK'G. NOM. SEXIGO WD. BLOCKING FURRING -PREFIN ALUM CLADDING CONTINUOUS. WITH DRIP. CINTERIOR -SIM MY NO DRIP. EXIST WO ROOF DECK BEYOND -BEYOND (INTERIOR) CEXTERIOR) HEW ALUM. WINDOW REPLACEMENT UNIT

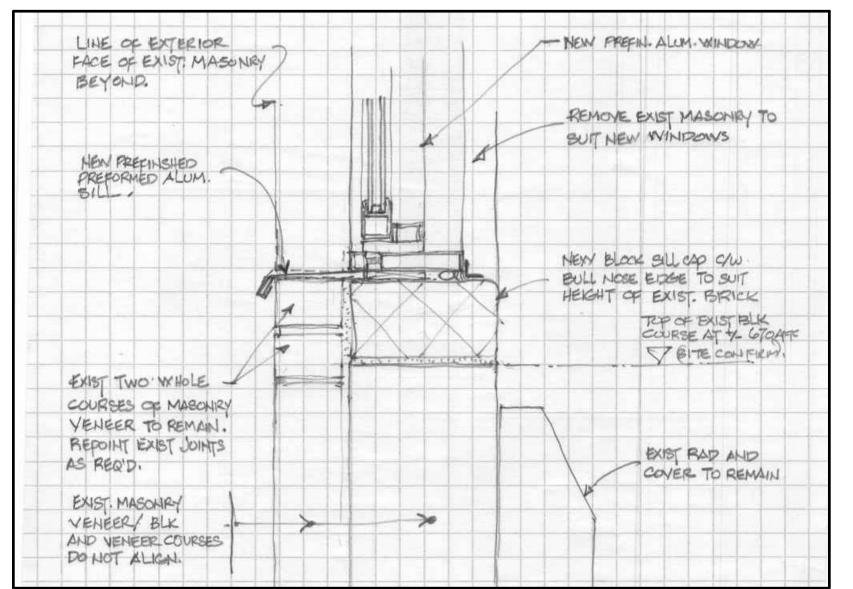


1 CURTAIN WALL HEAD A4 SCALE 1:5

2 W11 WINDOW – HEAD DETAIL A4 SCALE 1:5

3 W11 WINDOW - SILL DETAIL A4 SCALE 1:5

LINE OF EXIST GLU-LAM.

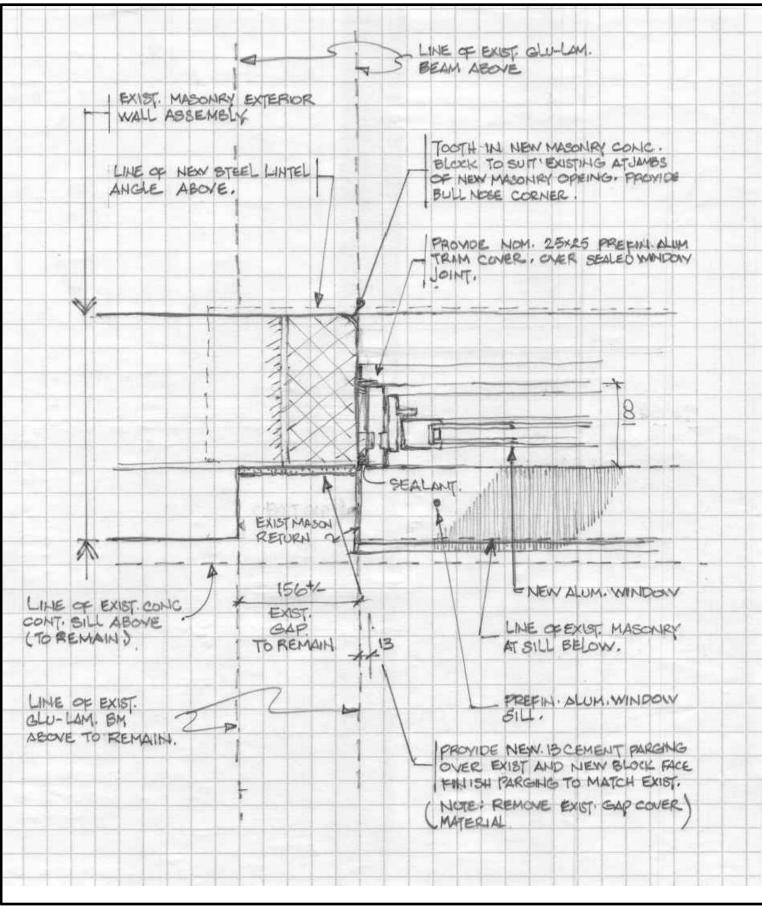

BEAM (BEYOND) TO REMAIN. 100 / REPLACEMENT WINDOW ABOVE PROVIDED PREFIN. ALUM 25 TRIM ANGLE OVER WINDOW ALIGH WINDOW IX SEALANT JOINT CTYP) EXIST. SLUPE OF EXIST. NEW STRUCT STL ANGLE (SEE STRUCT DETAIL.) GAN ANCHOR BOLTS AS NOTED. 广三三三二 CONC. SILL TO REMAIN. - PREFIN. METAL WINDOW HEAD WINDOW Z-CLIP C/W MINERAL FIBRE INSULATION C/W A/V MEMBRANE MEW ALUM, WIHDOW. WINDOW BET BACK TO BE CONFIRMED ON SITE Y LINE OF EXIST. GLU, LAM. BM BEYOND. 100 LINE OF EXIST MASOLIN FACE LINE OF INTERIOR BEYOND. FACE OF EXIST. MASONRY \* SET BACK TO ALIGH BEYOND. 14 IEXIST INTERIOR BLOCK FACE, (CONFIRM)

5 W11 WINDOW - TRANSOM DETAIL A4 SCALE 1:5

4 W11 WINDOW - JAMB DETAIL A4 SCALE 1:5

> TO BE CONFIRMED ON SITE LINE OF FINISHED FLOOR LEVEL LINE OF FINISHED \_

DOOR NOTES:


REMOVE EXISTING DOOR AND FRAME. PATCH EXISTING MASONRY TO MATCH EXISTING. 2.PROVIDE NEW H.M. DOOR AND FRAME AS FOLLOWS: HM FRAME (CUSTOM TO SUIT) 18 GA. FRAME TO SUIT EXISTING MASONRY OPENING (1890WX2120H) FRAME WIDTH 280MM TO MATCH EXISTING WIDTH X

38MM THICK C/W 1-H ULC RATING

PROVIDE 2 EQUAL M DOORS, INSULATED TO SUIT FULL SLAB DOORS, 45MM TICK, 16 GA. WITH 1-HR


DOOR AND FRAME TO BE C/W ULC LABELLED CLOSER AND PANIC SET, ALUM. THRESOLD, ASTRAGAL STRIP AND REMOVABLE MULLION.

8 NEW 1-HR DOOR FRAME A4 SCALE 1:50

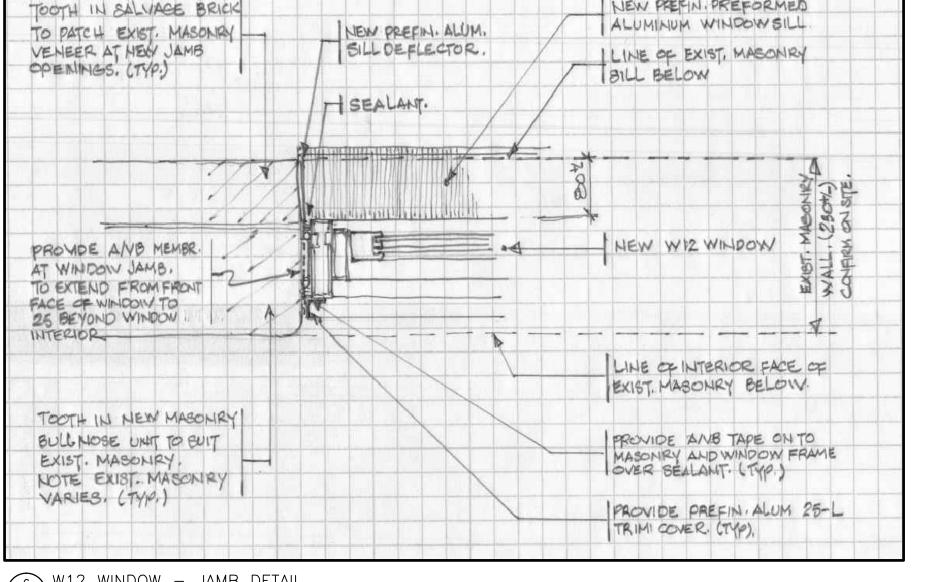

NEW PREFIN PREFORMED

6 W12 WINDOW – JAMB DETAIL A4 SCALE 1:5

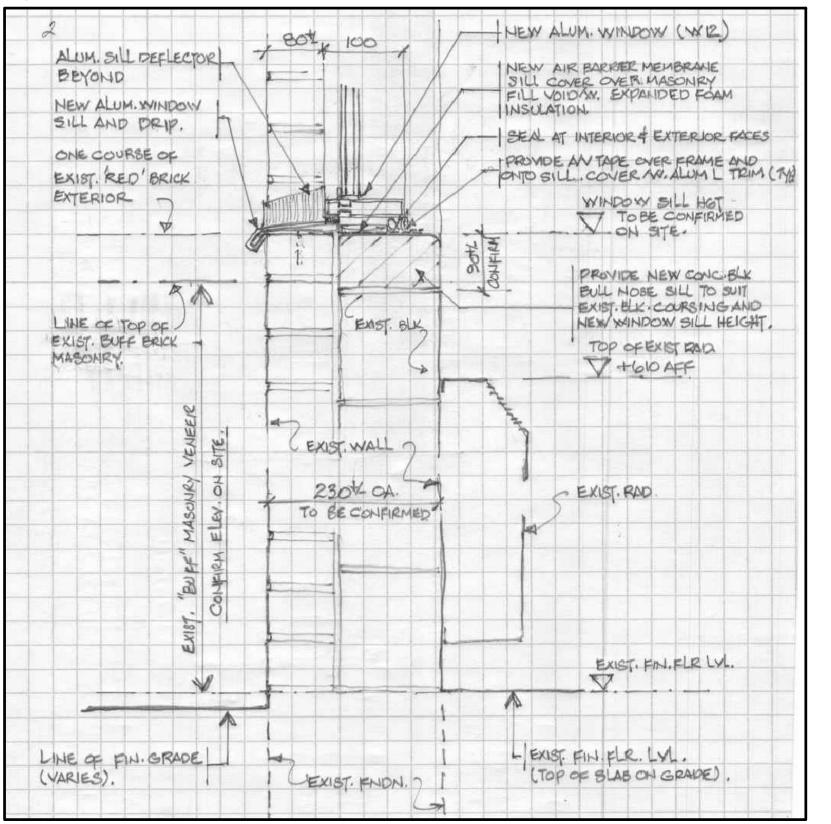

7 W12 WINDOW - SILL DETAIL A4 SCALE 1:5

GENERAL CONSTRUCTION NOTES

.1 EXECUTE DEMOLITION / REMOVAL WORK IN CAREFUL MANNER SO AS NOT TO DAMAGE EXISTING SURFACES.

2 REMOVE EXISTING BLINDS, AND REPLACE WITH NEW ROLLER SHADES.

3 CAREFULLY REMOVE AND DISPOSE OF ALUMINUM WINDOWS INCLUDING CAULKING AND SEALANTS.

4 CONTRACTOR SHALL BE RESPONSIBLE FOR MEASURING ALL WINDOW OPENINGS. .5 PROVIDE SHOP DRAWINGS FOR ALL PRODUCTS USED INCLUDING WINDOWS, PLASTIC LAMINATE STOOLS, AND CEILING TRIM. .6 PROTECT OPENINGS WITH PLYWOOD WHEN REQUIRED FOR OVERNIGHT .7 PROTECT OPENINGS FROM ALL POSSIBLE WEATHER DAMAGE.

.8 COORDINATE SCHEDULE WITH OWNER.


- .1 REPLACE DAMAGED BRICK WITH BRICK OF SIMILAR SIZE, COLOUR AND TEXTURE. USE TWO (2) STAIN BRICK TO MATCH EXISTING.
- .1 SILPRUF SCS9000NB MANUFACTURED BY CANADIAN GENERAL ELECTRIC OR DOW CORNING 756 SMS OR TREMCO SPECTRUM 3 CONFORMING TO ASTM C920 TYPE S, GRADE NS, CLASS 50 FOR INTERIOR AND EXTERIOR LOCATIONS

  .2 BOND BREAKER SHALL BE PRESSURE SENSITIVE PLASTIC TAPE BACKING MATERIAL WHICH WILL NOT BOND TO SEALANT 3M #226 OR VALLEY INDUSTRIES #40. .3 COLOURS OF SEALANTS AND CAULKING TO LATER SELECTION BY

.1 REMOVE DUST, GREASE, RUST FROM ALL SURFACES AND SAND TO


- .4 JOINT BACKING MATERIAL SHALL BE SOF ROD BY TRMECO ON VERTICAL SURFACES AND STANDARD TREMCO BACKER ROD ON HORIZONTAL
- ROUGH FINISH PRIOR TO PAINTING. .2 REMOVE MILDEW WITH TRI-SODIUM PHOSPHATE SOLUTION (150G) AND BLEACH (125 G) PER 3.5 L CLEAN WATER

  .3 PAINT SHALL BE LATEX BASED LOW VOC WITH SEMI-GLOSS FINISH TO MATCH FXISTING .4 SURFACES TO BE REPAINTED ARE TO BE PRIMED IN ACCORDANCE WITH MPI MAINTENANCE REPAINTING MANUAL RECOMMENDATIONS LEVEL DSD— 3 FULL PRIME COAT. .5 PAINTING SHALL MEET MPI STANDARDS FOR RIN 4.2D - G5 FOR REPAINTING WORK INCLUDING 1 COAT BONDING PRIMER (MPI #17 X-GREEN) AND TWO FINISH COATS MPI #141, VOC RANGE E3. .6 PAINT INTERIOR WALLS (FULL WIDTH/HEIGHT) OF ALL WALLS WHERE WINDOWS ARE REPLACED (TYPICAL)
- (SEE SPECIFICATIONS SECTION 08 51 13 ALUMINUM WINDOWS)
- WINDOW OPENING NOTES .1 PROVIDE ±80MM LIMIT STOPS ON WINDOW OPENING IN STUDENT PLAY .2 PROVIDE ±150MM LIMIT STOPS ON WINDOW OPENING IN NON-STUDENT

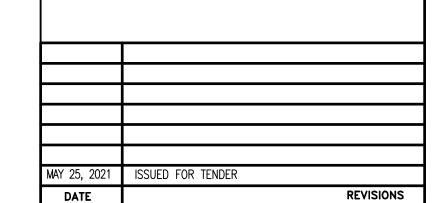


## ST. CHRISTOPHER CATHOLIC SCHOOL WINDOW REPLACEMENT 2021

456 ANNAPOLIS AVE. OSHAWA, ONTARIO

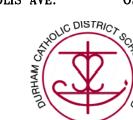

WINDOW DETAILS

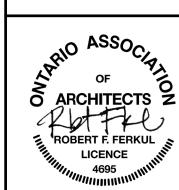

JOB NO. 2144 SCALE AS NOTED


MAY 2021

MAY 25, 2021


TRUE NORTH DWG. NORTH

MOFFET & DUNCAN architects inc. 5052 DUNDAS ST. WEST ISLINGTON, ONT. M9A 1B9
TEL: (416) 239-2775
FAX: (416) 239-6729


DWG. NO

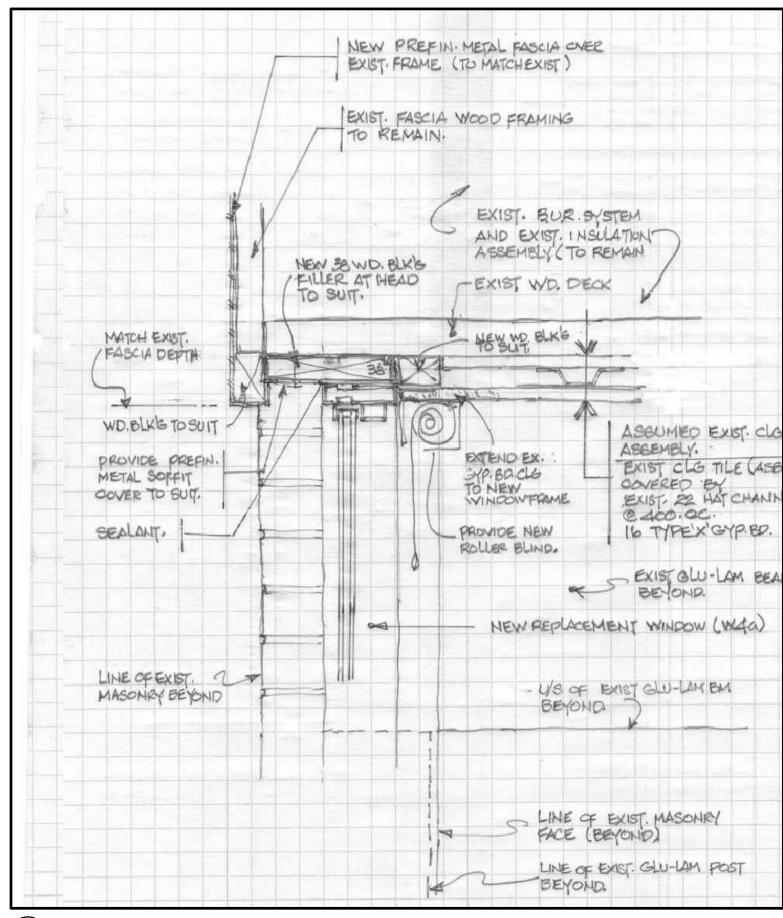

1 W12 WINDOW - HEAD DETAIL
A5 SCALE 1:5

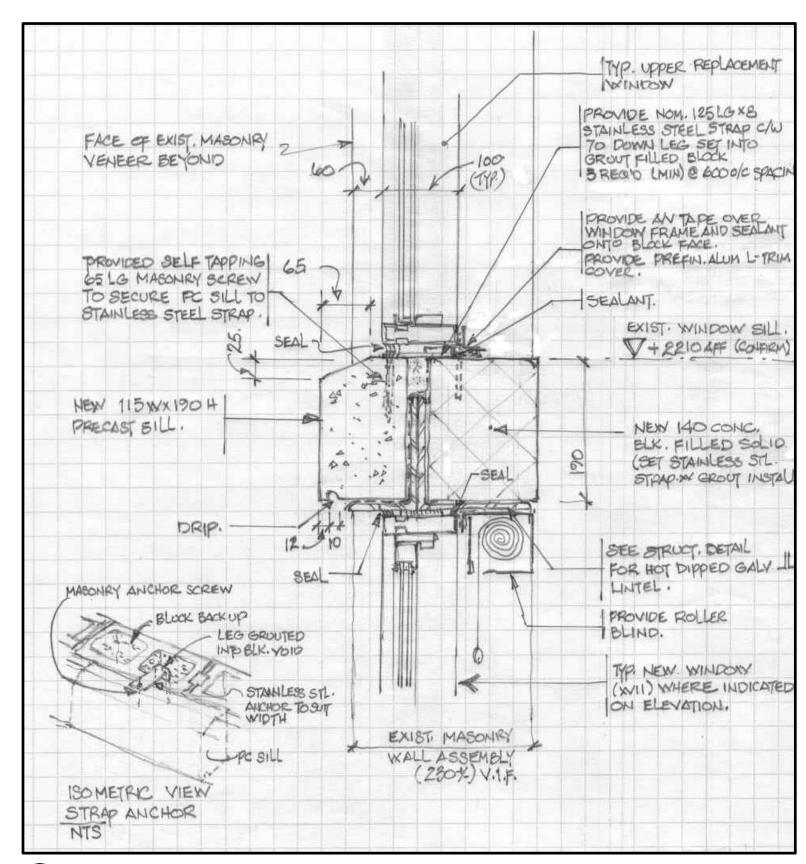

2 W12 WINDOW - TRANSOM DETAIL
A5 SCALE 1:5

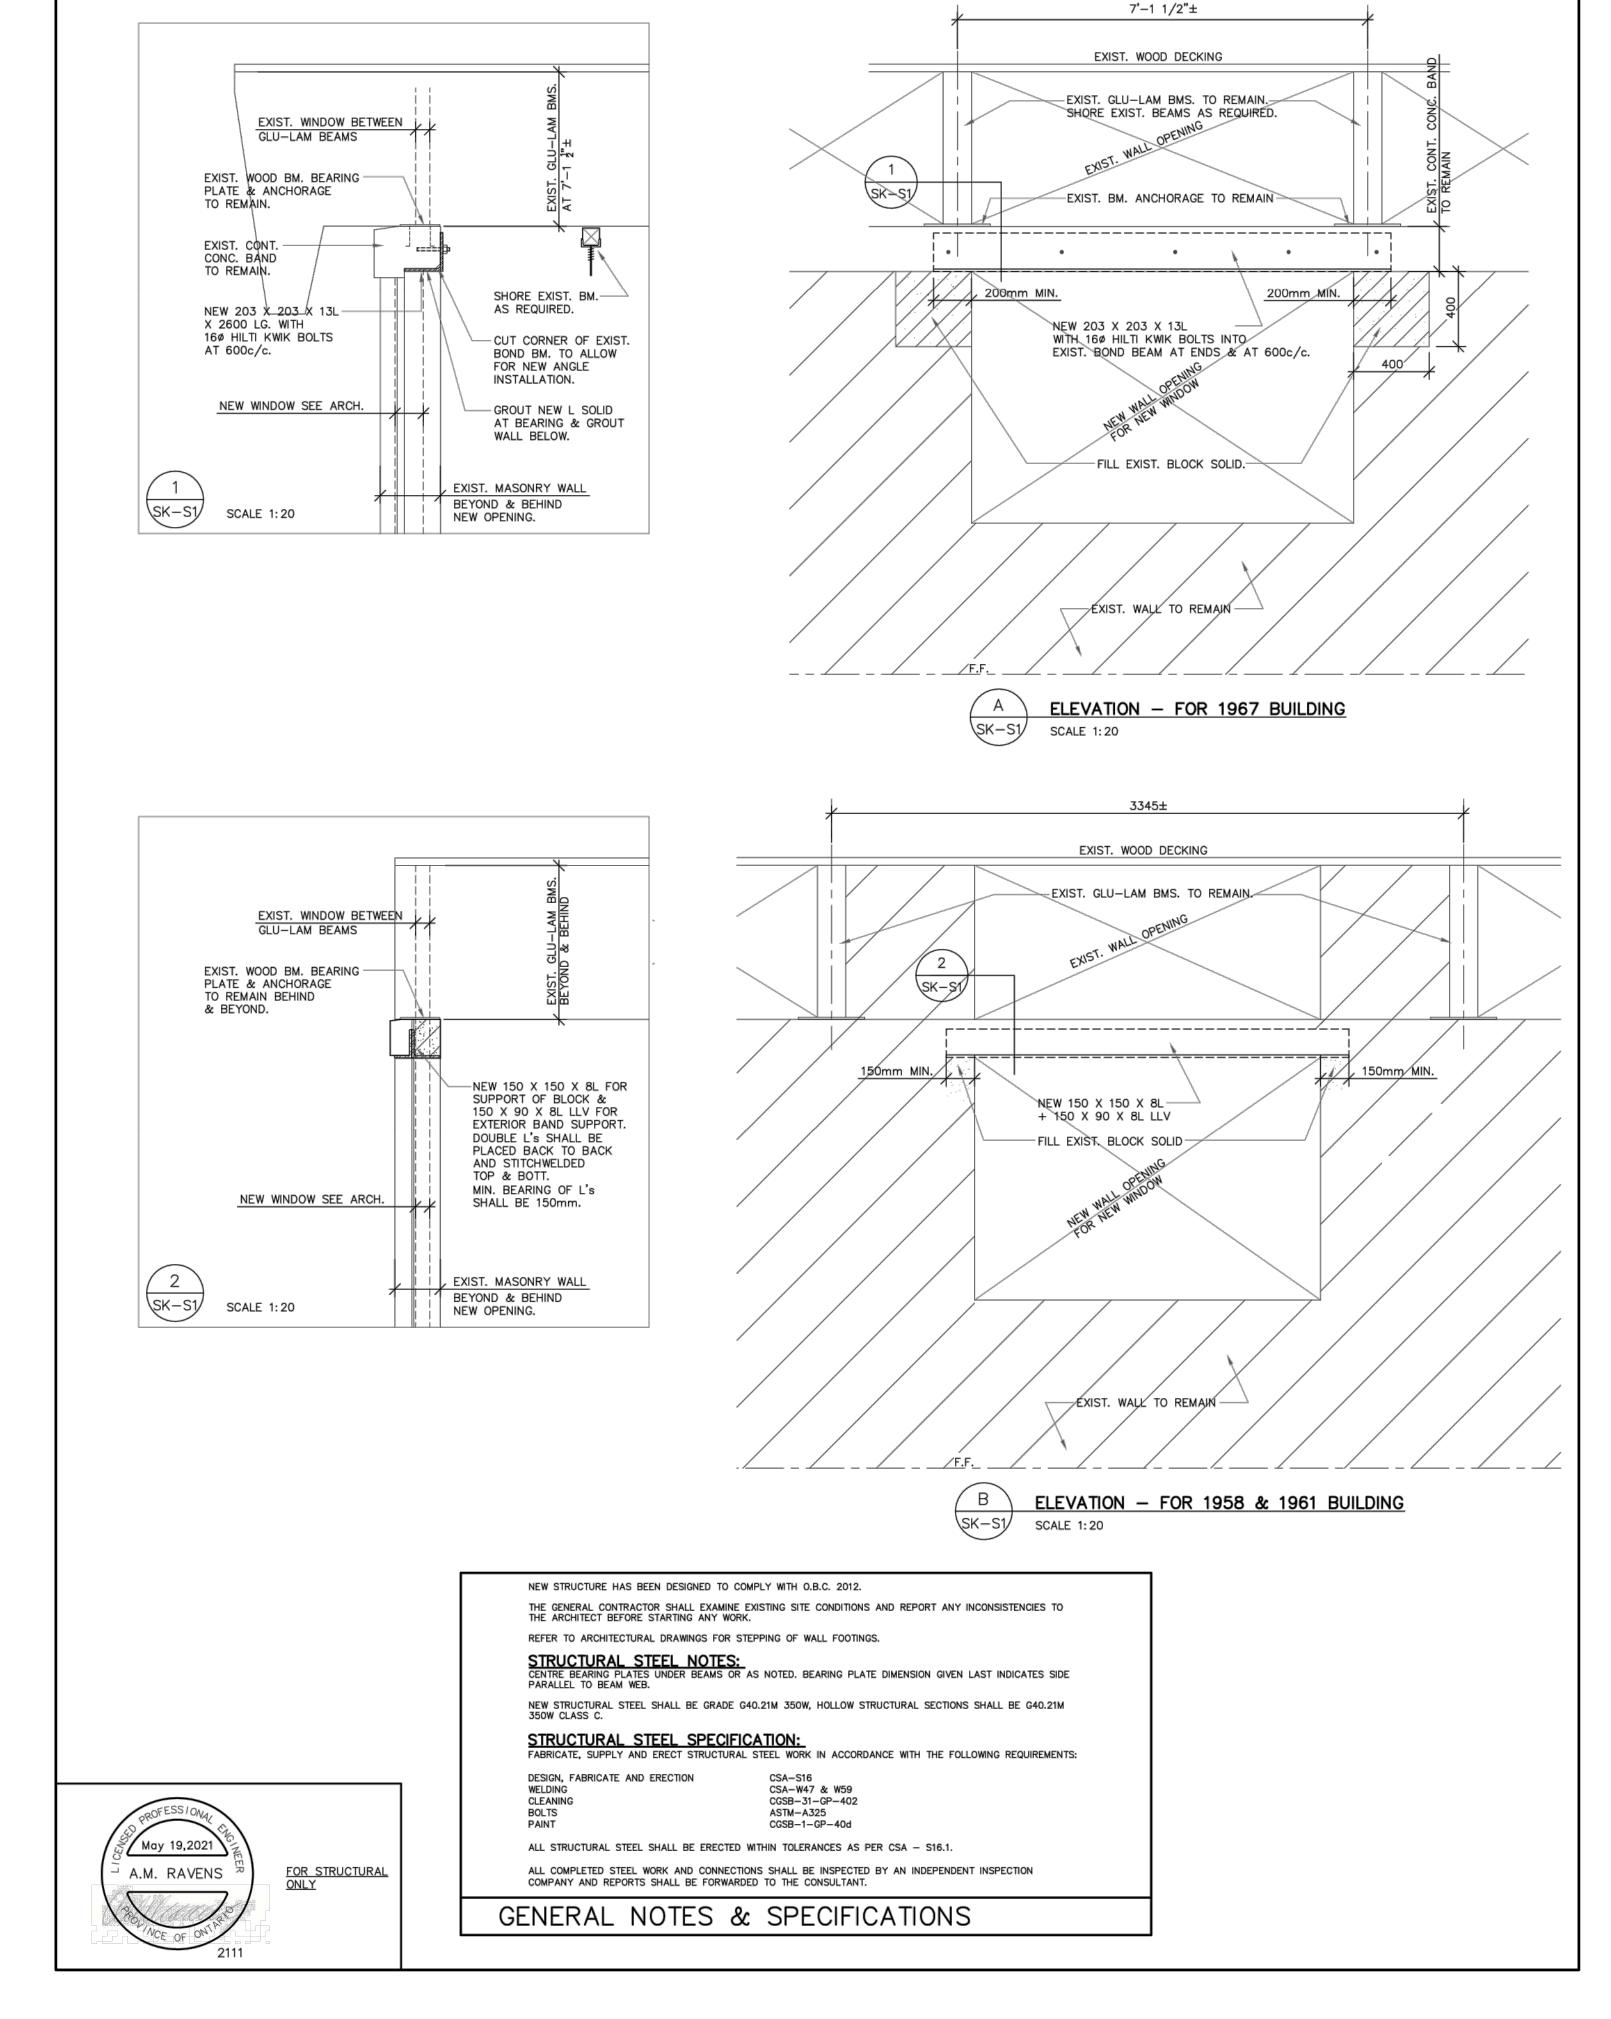

### GENERAL CONSTRUCTION NOTES

- .1 EXECUTE DEMOLITION / REMOVAL WORK IN CAREFUL MANNER SO AS NOT TO DAMAGE EXISTING SURFACES.
  .2 REMOVE EXISTING BLINDS, AND REPLACE WITH NEW ROLLER SHADES.
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  .4 CONTRACTOR SHALL BE RESPONSIBLE FOR MEASURING ALL WINDOW OPENINGS.
- OPENINGS

  .5 PROVIDE SHOP DRAWINGS FOR ALL PRODUCTS USED INCLUDING WINDOWS, PLASTIC LAMINATE STOOLS, AND CEILING TRIM.

  .6 PROTECT OPENINGS WITH PLYWOOD WHEN REQUIRED FOR OVERNIGHT SECURITY.

  .7 PROTECT OPENINGS FROM ALL POSSIBLE WEATHER DAMAGE.

  .8 COORDINATE SCHEDULE WITH OWNER.
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- INDUSTRIES #40.

  .3 COLOURS OF SEALANTS AND CAULKING TO LATER SELECTION BY CONSULTANT.

  .4 JOINT BACKING MATERIAL SHALL BE SOF ROD BY TRMECO ON VERTICAL SURFACES AND STANDARD TREMCO BACKER ROD ON HORIZONTAL SURFACES.
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  .5 PAINTING SHALL MEET MPI STANDARDS FOR RIN 4.2D G5 FOR

REPAINTING WORK INCLUDING 1 COAT BONDING PRIMER (MPI #17

.6 PAINT INTERIOR WALLS (FULL WIDTH/HEIGHT) OF ALL WALLS WHERE

X-GREEN) AND TWO FINISH COATS MPI #141, VOC RANGE E3.


WINDOWS
(SEE SPECIFICATIONS SECTION 08 51 13 ALUMINUM WINDOWS)

WINDOWS ARE REPLACED (TYPICAL)

6. WINDOW OPENING NOTES

.1 PROVIDE ±80MM LIMIT STOPS ON WINDOW OPENING IN STUDENT PLAY
AREA

.2 PROVIDE ±150MM LIMIT STOPS ON WINDOW OPENING IN NON-STUDENT

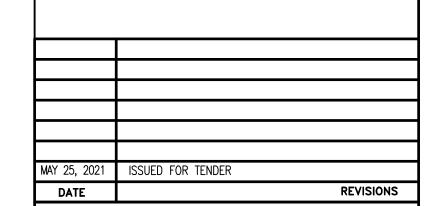


## ST. CHRISTOPHER CATHOLIC SCHOOL WINDOW REPLACEMENT 2021

456 ANNAPOLIS AVE. OSHAWA, ONTARIO



ARCHITECTURAL AND STRUCTURAL DETAILS

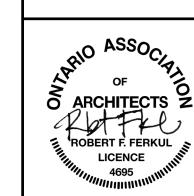

JOB NO.
2144

SCALE
AS NOTED

TRUE NORTH DWG. NORTH

MOFFET & DUNCAN

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