


SANITARY LAYOUT

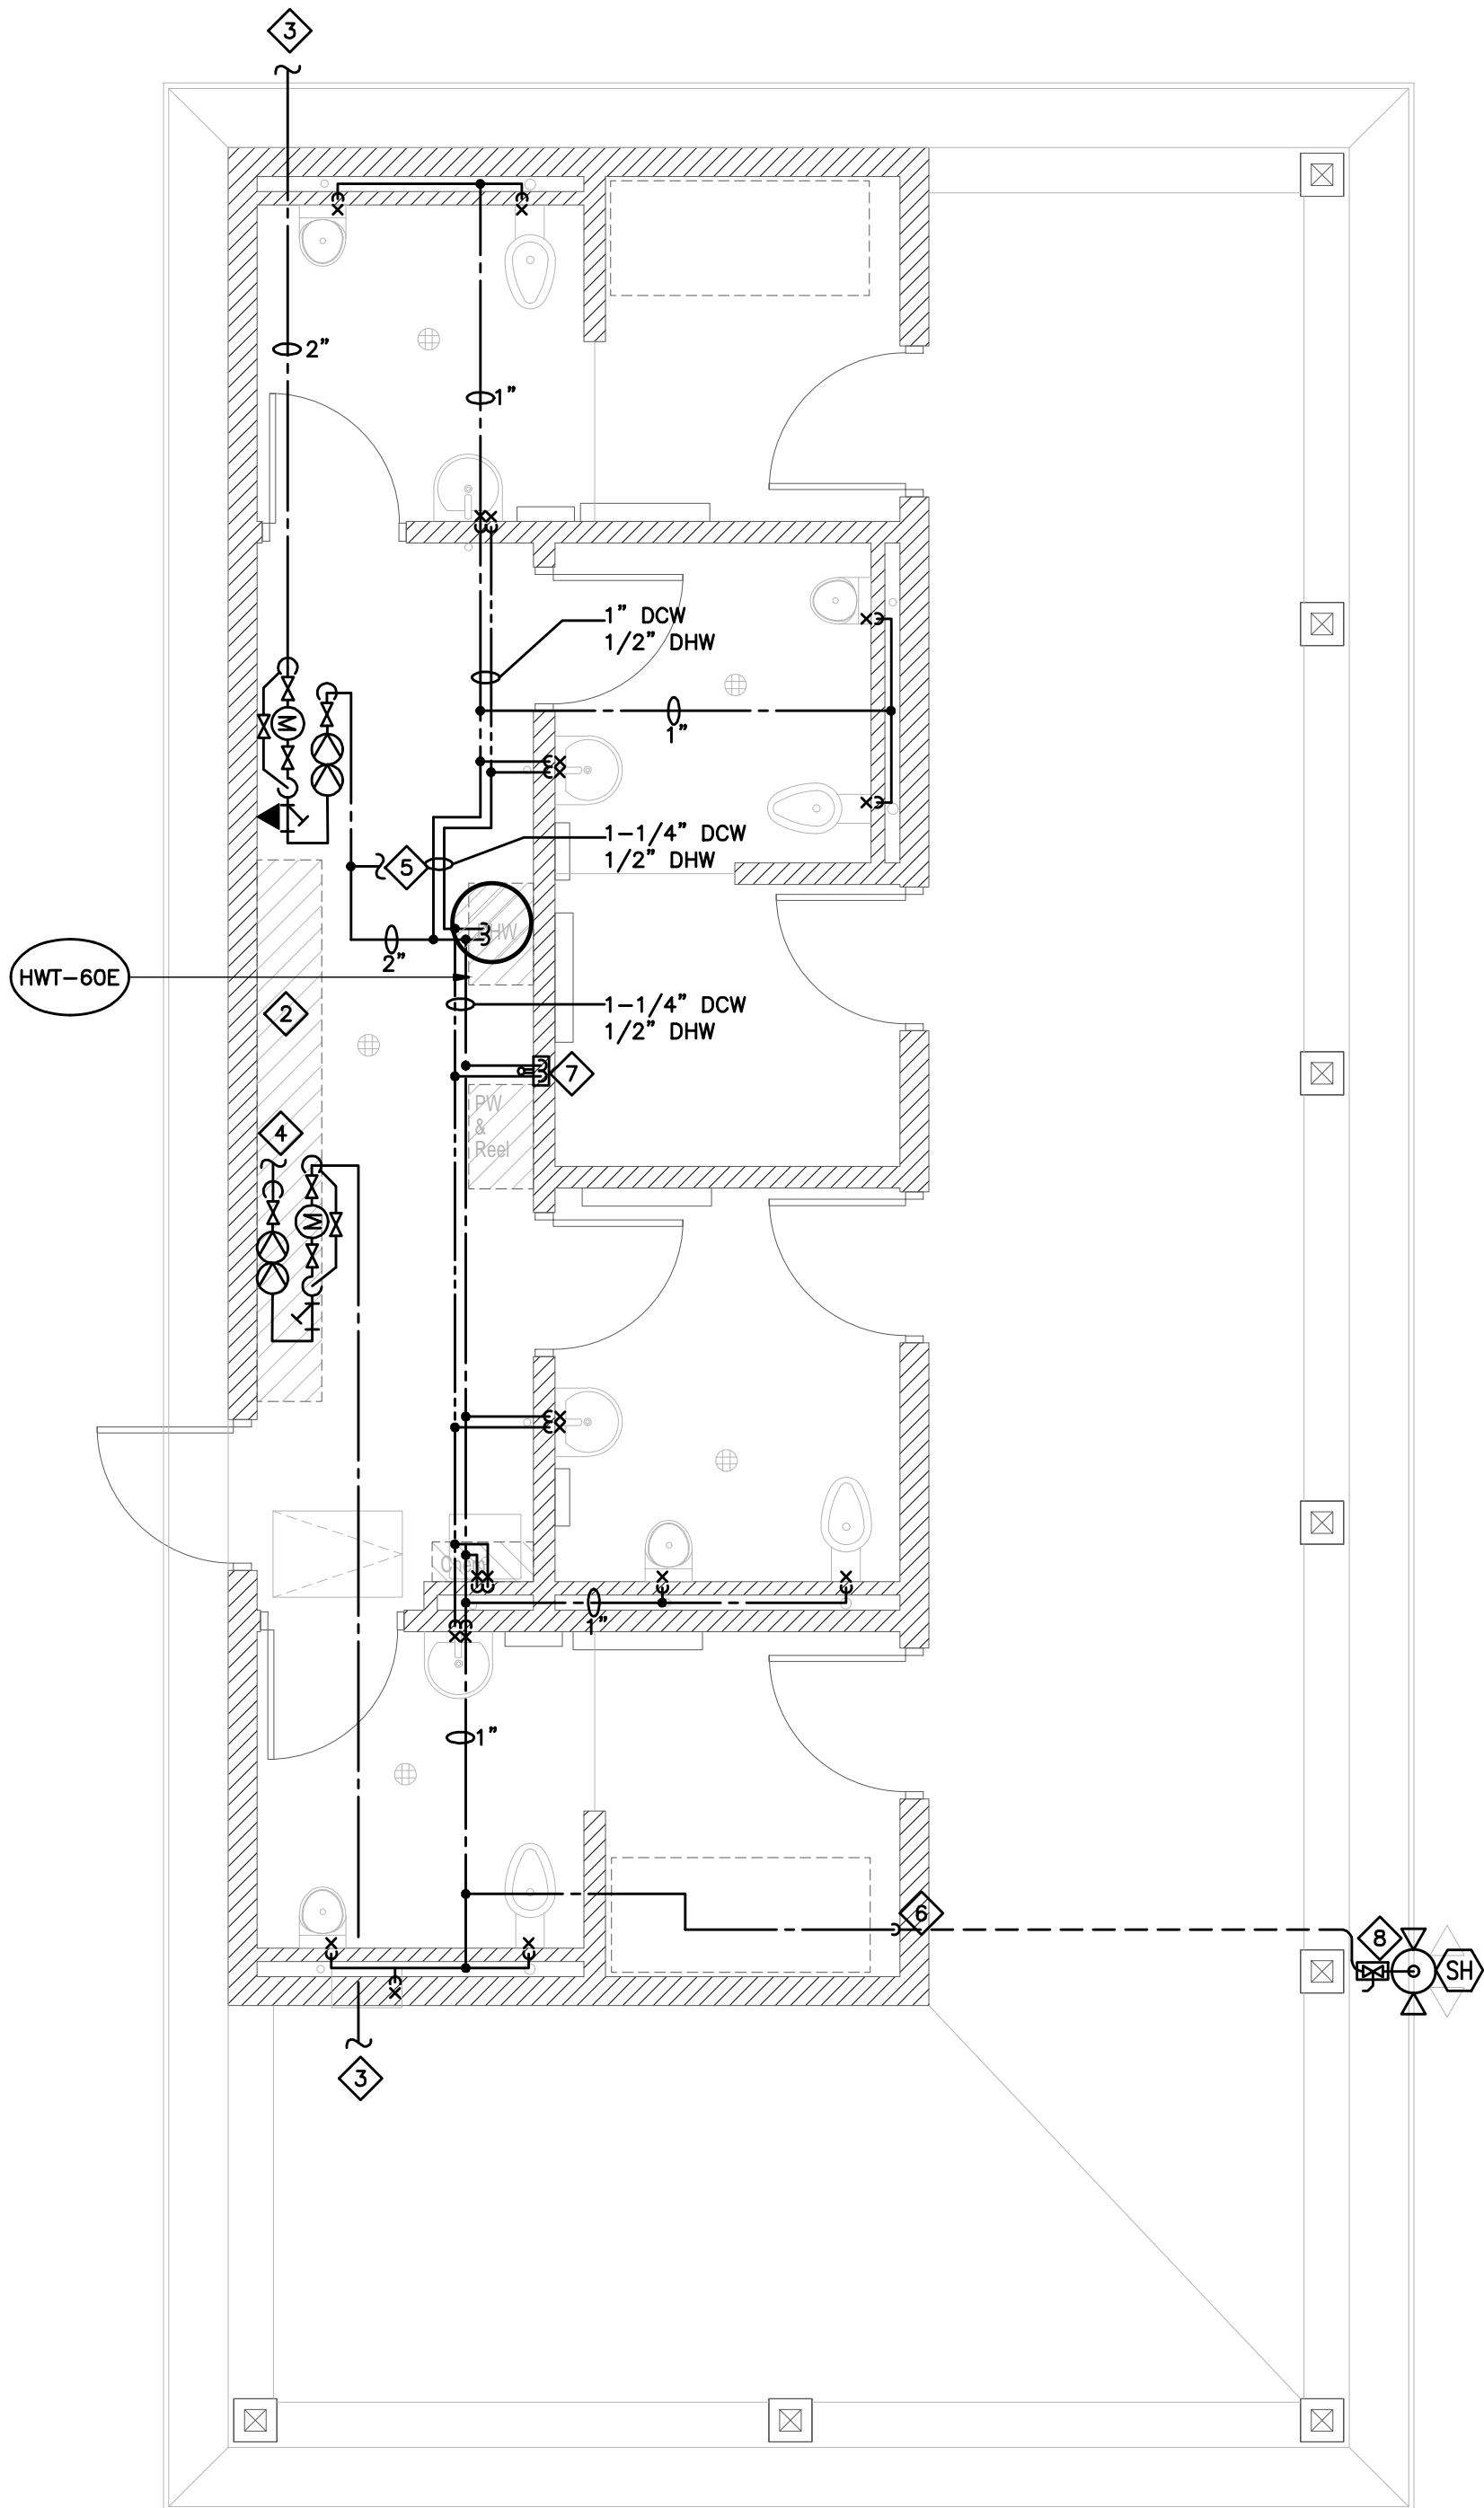

PLUMBING LAYOUT

HVAC GENERAL NOTES

- ALL EQUIPMENT AND ASSOCIATED DUCTWORK/GRILLES IS NEW UNLESS OTHERWISE NOTED.
- PAINTING OF EXPOSED DUCTWORK IS BY OTHERS.
- FLEXIBLE BRANCH DUCTWORK TO BE MAXIMUM 10FT. IN LENGTH.
- UNDERCUT DOORS FOR ALL WASHROOMS.
- ALL INTERIOR EXPOSED OPEN ENDED DUCTS TO BE FINISHED OFF WITH WIRE MESH.
- WHERE APPLICABLE ALL GOOSENECKS, OPEN ENDED DUCTS AND EXTERIOR LOUVRES TERMINATING TO THE EXTERIOR SHALL BE C/W 1/2"x1/2" GALVANIZED WIRE MESH BIRD SCREENS AND B/D/D OR MOTORIZED DAMPER WHERE SPECIED AND BE ACCESSIBLE FOR CLEANING.
- ALL MOTORIZED DAMPERS ARE C/W END SWITCHES UNLESS NOTED.
- ALL EXTERIOR LOUVRES AND VENT OPENINGS MUST BE MIN. 24" ABOVE FINISHED GRADE. ADJUST OPENING LOCATIONS OR MODIFY GRADE AS REQUIRED.
- ALL DUCTWORK SHALL CONFORM TO ASHRAE. ALL DUCTWORK SHALL AND PLENUMS SHALL BE CONSTRUCTED, INSTALLED AND SEALED AND PRESSURE TESTED AS DETAILED IN THE SMACNA HVAC DUCT CONSTRUCTION STANDARDS - METAL AND FLEXIBLE. CONTRACTOR TO SEAL DUCT WITH ZERO VOC DUCT SEALANT. WHERE DUCTWORK IS EXPOSED SEAL WITH CLEAR SILICONE.
- RADIUS OF ELBOW SHALL BE AT LEAST 1.5 TIMES THE WIDTH OF THE DUCT. WHERE A RADIUS IS NOT POSSIBLE TURNING VANES MUST BE INTRODUCED.

KEYED NOTES

- REFER TO SITE SERVICING DWGS FOR CONTINUATION OF 4" LEAVING SANITARY
- SPLASH PAD WATER SYSTEM BY OTHERS
- REFER TO SITE SERVICING DWGS FOR CONTINUATION OF 2" DCW MAIN
- 2" DCW TO SPLASH PAD WATER SYSTEM (BY OTHERS)
- 2" DCW TO IRRIGATION SYSTEM (BY OTHERS)
- 1" DCW DN UNDERSLAB TO SERVE SHOWER
- 1" H+C WATER DN TO HOSE BIB SERVING PRESSURE WASHER SYSTEM
- 1" UNDERSLAB DCW TO SERVE SHOWER. PROVIDE RECESSED VALVE BOX AND DRAIN VALVE FOR WINTERIZATION.

PLUMBING NOTES

- ALL EXISTING EQUIPMENT, PIPING, ETC BEING RE-USED SHALL BE INSPECTED AND LOCATED BEFORE AND AFTER DEMOLITION AND PRIOR TO ANY NEW CONSTRUCTION. DETAILS OF PERFORMANCE/CONDITION/SIZING AND LOCATION SHALL BE SUPPLIED TO THE ENGINEER AND OWNER. ANY EXTRA WORK AND REQUIRED TO THE ABOVE MENTIONED SHALL BE DETERMINED PRIOR TO NEW CONSTRUCTION. CONTRACTOR TO ALLOW FOR THE INSPECTION IN HIS PRICE INCLUDING X-RAYING, AIR FLOW MEASUREMENT, SCANNING AND CAMERA SCOPE TO EXISTING BURIED DRAINS. NO EXTRAS WILL BE ALLOWED ONCE NEW CONSTRUCTIONS STARTS.
- ALL PLUMBING/DRAINAGE AND EQUIPMENT IS NEW UNLESS OTHERWISE NOTED.
 - NEW WATER CLOSETS ARE SIZED FOR FLUSH VALVES UNLESS NOTED. ANY DISCREPANCIES MUST BE BROUGHT TO THE ATTENTION OF THE ENGINEER.
 - PROVIDE WATER HAMMER ARRESTORS ON HOT AND COLD WATER SUPPLIES TO ALL QUICK VALVES, SOLENOIDS, AND PLUMBING FIXTURES. AND LOCATE IN AN UPRIGHT POSITION BETWEEN THE LAST TWO FIXTURES ON A LINE, OR HORIZONTALLY AT THE END OF LINE CLOSEST TO SUPPLY SOURCE. ON PROJECTS EXCEEDING FIVE STORIES IN HEIGHT, PROVIDE WATER HAMMER ARRESTORS ON DOMESTIC WATER RISERS AS FOLLOWS. LOCATE ARRESTORS AT THE END OF RISER OPPOSITE SUPPLY SOURCE. ARRESTOR SHALL BE TWO PIPE SIZES LARGER THAN THE RISER IS AT THE CONNECTION POINT, NOT EXCEEDING THE LARGEST PIPE SIZE DIAMETER IN THE RISER WATER HAMMER ARRESTORS.
 - ALL TRAPS SERVING FLOOR DRAINS SHALL BE PRIMED AND ALL TRAPS SEAL PRIMERS SHALL BE C/ B.F.P.
 - PRIOR TO CONSTRUCTION CONTRACTOR SHALL INSPECT OR OBTAIN AS NECESSARY STATIC WATER PRESSURE AT BUILDING AND INFORM ENGINEER. AFTER CONSTRUCTION CONTRACTOR SHALL INSPECT STATIC WATER PRESSURE AT THE FURTHEST DOWNSTREAM FIXTURE.
 - ALL BACK FLOW PREVENTORS SHALL BE INSTALLED AND TESTED AS PER B64.10-07 AND B64.10.1-07 STANDARDS. ALL INSTALLATION AND TESTING MUST BE LICENCED AS PER THE ABOVE MENTIONED STANDARD.
 - UNLESS SPECIFIED ON THESE DRAWINGS ALL PLUMBING FIXTURES ARE TO BE SPECIFIED BY OTHERS. PLUMBER SHALL PURCHASE AND INSTALL THE FIXTURES AND ASSOCIATED FITTINGS TO FINAL CONNECTIONS. ALL ROUGH IN LOCATIONS AND INSTALLATION SHALL SUIT ARCHITECTURAL AND APPROVED FIXTURE SHOP DRAWINGS. PROVIDE PARTITION VALVE STOPS FOR ALL FIXTURES AND RISERS/WASHROOM GROUPINGS. (INSTALL PARTITION STOPS SO THEY LAND UNDERNEATH LAV'S AND OR BEHIND WATER CLOSETS). ALL EXPOSED DOMESTIC PIPING SHALL BE COPPER FOR FINAL CONNECTION.
 - UNLESS SPECIFIED ON THESE DRAWINGS STEAM SHOWERS, WALK-IN COOLERS, WATER TREATMENT, SAUNA EQUIPMENT, DISHWASHERS, FRIDGES WASHERS, STEAM DRYERS ETC ARE TO BE SUPPLIED BY OTHERS. PLUMBER SHALL ROUGH-IN TO DRYWALL STAGE AND MAKE ALL FINAL CONNECTIONS. ALL ROUGH IN LOCATIONS AND REQUIRED P&D SHALL SUIT ARCHITECTURAL AND APPROVED FIXTURE SHOP DRAWINGS.
 - PROVIDE ACCESSIBLE ISOLATION VALVES FOR EACH FIXTURE AND EACH PIECE OF EQUIPMENT.
 - PLUMBER TO PIPE DRAINS AS REQUIRED FOR ALL AIR HANDLERS, WALK-IN COOLERS, BACKFLOW PREVENTORS, HRV UNITS, HUMIDIFIERS, HOT WATER TANK, COILS ETC TO NEAREST HUB DRAIN AS PER MANUFACTURERS RECOMMENDATIONS. REVIEW HVAC/P&D DRAWINGS/SCHEMATICS FOR EQUIPMENT LOCATIONS, DRAIN REQUIREMENTS AND PROVIDE HUB DRAIN AS REQUIRED. EXACT LOCATION TO BE CO-ORDINATED AT SITE WITH APPLICABLE TRADES.
 - CONTRACTOR TO ALLOW FOR BACK WATER VALVES ON LEAVING DRAINS. THIS SHALL BE DISCUSSED AS IT PERTAINS TO LOCAL JURISDICTION PRIOR TO BACK FILLING AND POURING OF FLOOR.
 - THIS CONTRACTOR IS RESPONSIBLE FOR ALL PLUMBING SERVICES WITHIN BUILDING OR TO CONNECTION POINTS SUPPLIED BY SITE SERVICING ENGINEER AND OR LANDSCAPE DESIGNER. REFER TO LATEST SITE SERVICING DRAWINGS FOR SIZE AND LOCATION OF INCOMING SERVICES CONNECTION POINTS. ALL SITE SERVICING INFO MUST BE VERIFIED AT SITE. CONTRACTOR TO REFER TO HEATING SCHEMATIC TO DETERMINE WORK BY THEM.
 - ALL PLUMBING SHALL RUN ON THE WARM SIDE OF AN INSULATED WALL/CEILING/FLOOR. WHERE PLUMBING ISN'T ADEQUATELY PROTECTED ENGINEER SHALL BE CONTACTED.
 - FINAL LOCATIONS AND QUANTITY OF HOSE-BIBBS TO BE APPROVED BY OWNER PRIOR TO INSTALLATION. WHERE LOCATIONS ARE NOT SHOWN ON THESE DRAWINGS ALLOW FOR 3 HOSE-BIBBS. EACH HOSE-BIBB SHALL HAVE A ACCESSIBLE WINTER SHUT-OFF VALVE.
 - WHERE SPECIFIED FIXTURES IN PUBLIC WASHROOMS REQUIRE A MIXED WATER TEMPERATURE AND DO NOT HAVE MIXING CAPABILITIES, CONTRACTOR SHALL PROVIDE A MIXING VALVE IN AN ACCESSIBLE LOCATION AS CLOSE TO THE GROUP OF FIXTURES AS POSSIBLE.
 - ALL DOMESTIC AND DRAINAGE PIPING FOR BARRIER FREE SINKS/LAVS TO BE PROTECTED WITH INSULATION AND PVC JACKET

PLUMBING VENTING NOTES

- ALL VENTING TO TERMINATE WITH 3" VENT THRU ROOF.
- CONTRACTOR TO CONNECT ALL NEW VENTING INTO EXISTING AND/OR PROVIDE NEW VENTING AS REQUIRED.
- VENT TERMINATION THRU ROOF SHALL BE A MIN. 10FT FROM FRESH AIR OPENINGS.

GENERAL PLUMBING FIXTURE SIZING NOTES

- REFER TO PLAN FOR COMBINED FIXTURE AND MAIN SIZING. PLUMBER SHALL REVIEW ALL SCHEMATICS/EQUIPMENT SCHEDULES FOR WORK NOT DETAILED ON FLOOR PLANS. REFER TO BELOW FOR INDIVIDUAL FIXTURE PLUMBING SIZES.
- THE BELOW SCHEDULE IS A GENERAL SCHEDULE AND FIXTURES ONLY APPLY WHERE TAGGED ON PLANS:

WATER CLOSET FLUSH VALVE (WC)
3" DRAIN, 1-1/2" VENT, 1" C/W

URINAL (UR)
2" DRAIN, 1-1/2" VENT, 3/4" C/W

LAVATORY (LV), MISC SINKS (S)
2" DRAIN, 1-1/2" VENT, 1/2" H&C/W

JANITORS SINK (JS)
3" DRAIN, 1-1/2" VENT, 3/4" H&C/W

SHOWERS (SH)
2" DRAIN, 1-1/2" VENT, 3/4" H&C/W. HIGH DEMAND SHOWERS WITH BODY JETS/RAINFALL SHOWER HEADS AND SOAKER TUBS SHALL BE C/W 1" H&C/W SUPPLY.

FLOOR HUB FUNNEL FLOOR DRAINS (FD),(HD),(FFD)
2" ABOVE GRADE, 3" BURIED

HOSEBIBB (HB)
3/4" C/W

DRAINAGE SLOPES

UNLESS NOTED ALL DRAINS SLOPES ARE AS FOLLOWS:

3" AND UNDER SHALL RUN AT 2.0% SLOPE

4" TO 6" SHALL RUN AT 1.0% SLOPE

8" AND UP SHALL BE NOTED ON PLANS




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3	05.26.2020	ISSUED FOR PERMIT
2	05.24.2018	ISSUED FOR REVIEW
1	05.01.2018	ISSUED FOR REVIEW

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CONSTRUCTION NORTH



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COMFORT STATION
GARNET GRAHAM PARK

KAWARTHA LAKES ONTARIO

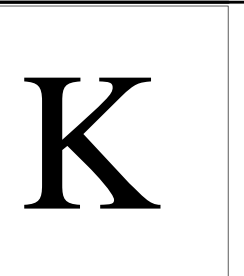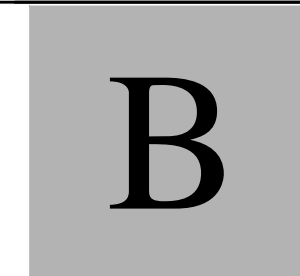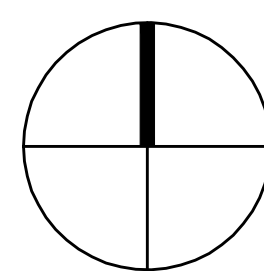MECHANICAL




PLOT DATE PROJECT No.
18-776

DRAWING TITLE

PLUMBING & DRAINAGE
LAYOUTS

DATE	2018	M-1
DRAWN BY	JW	
SCALE	1/4"=1'-0"	

OF 3

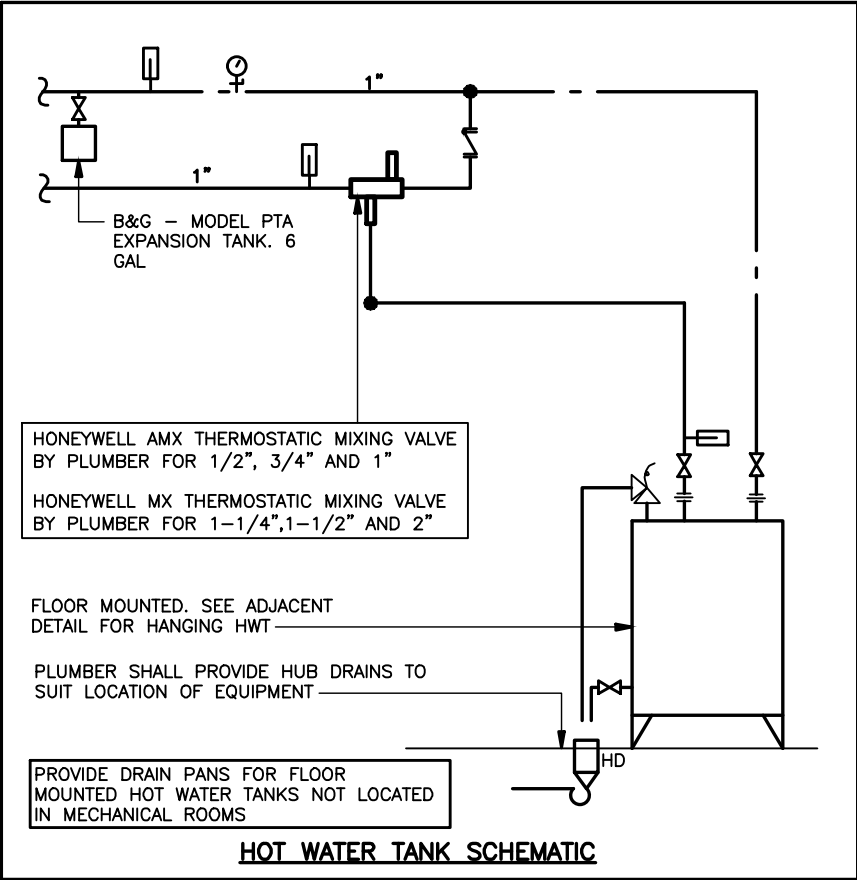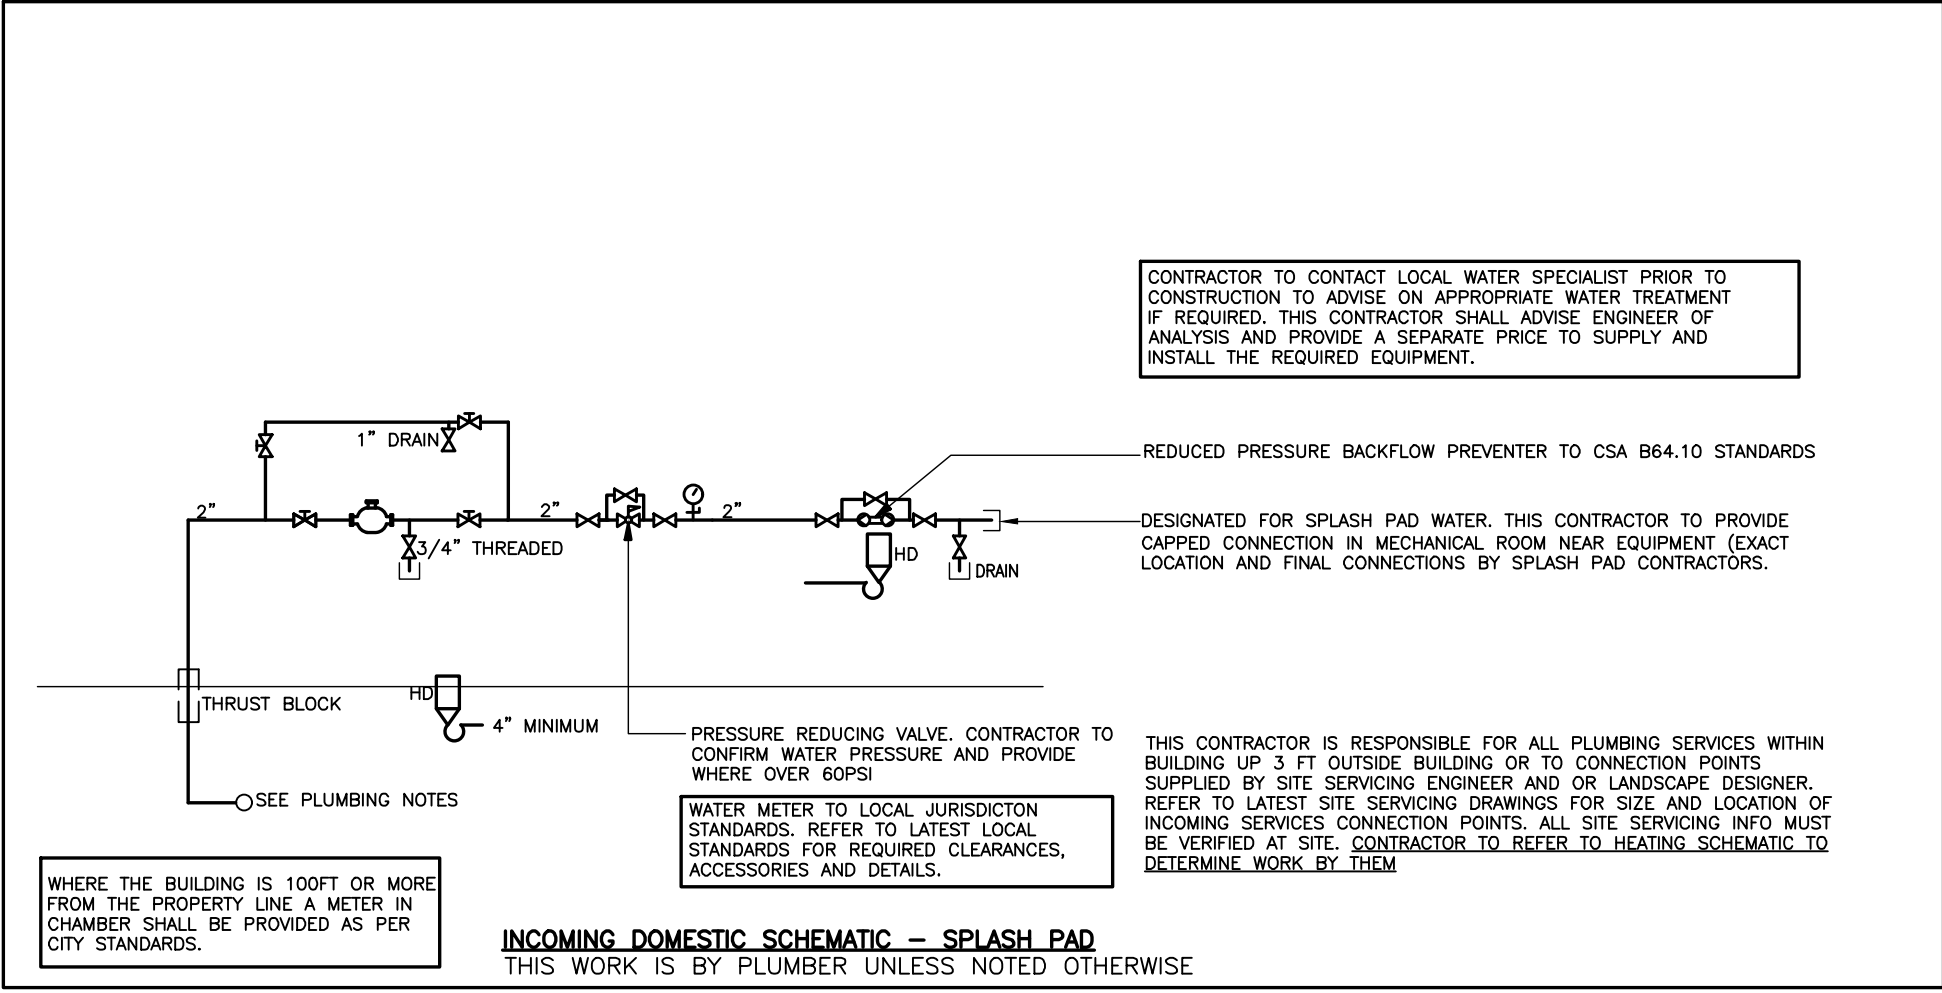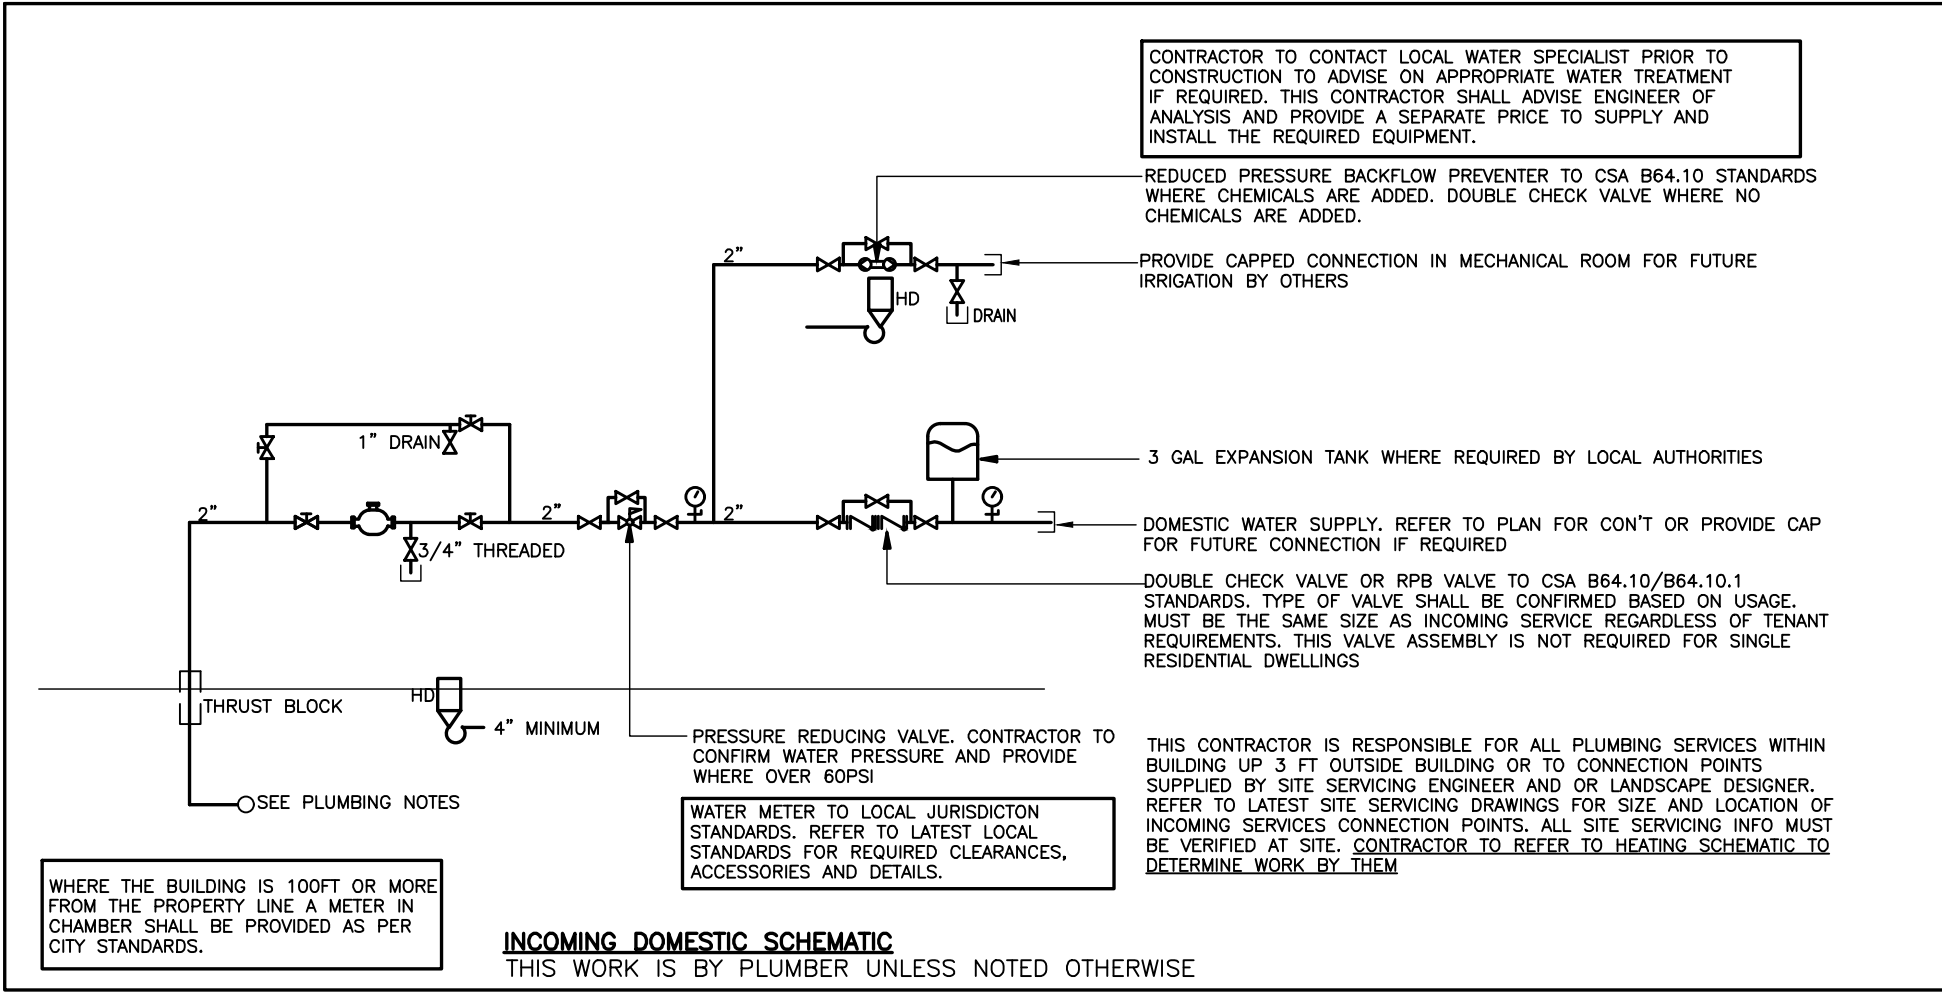



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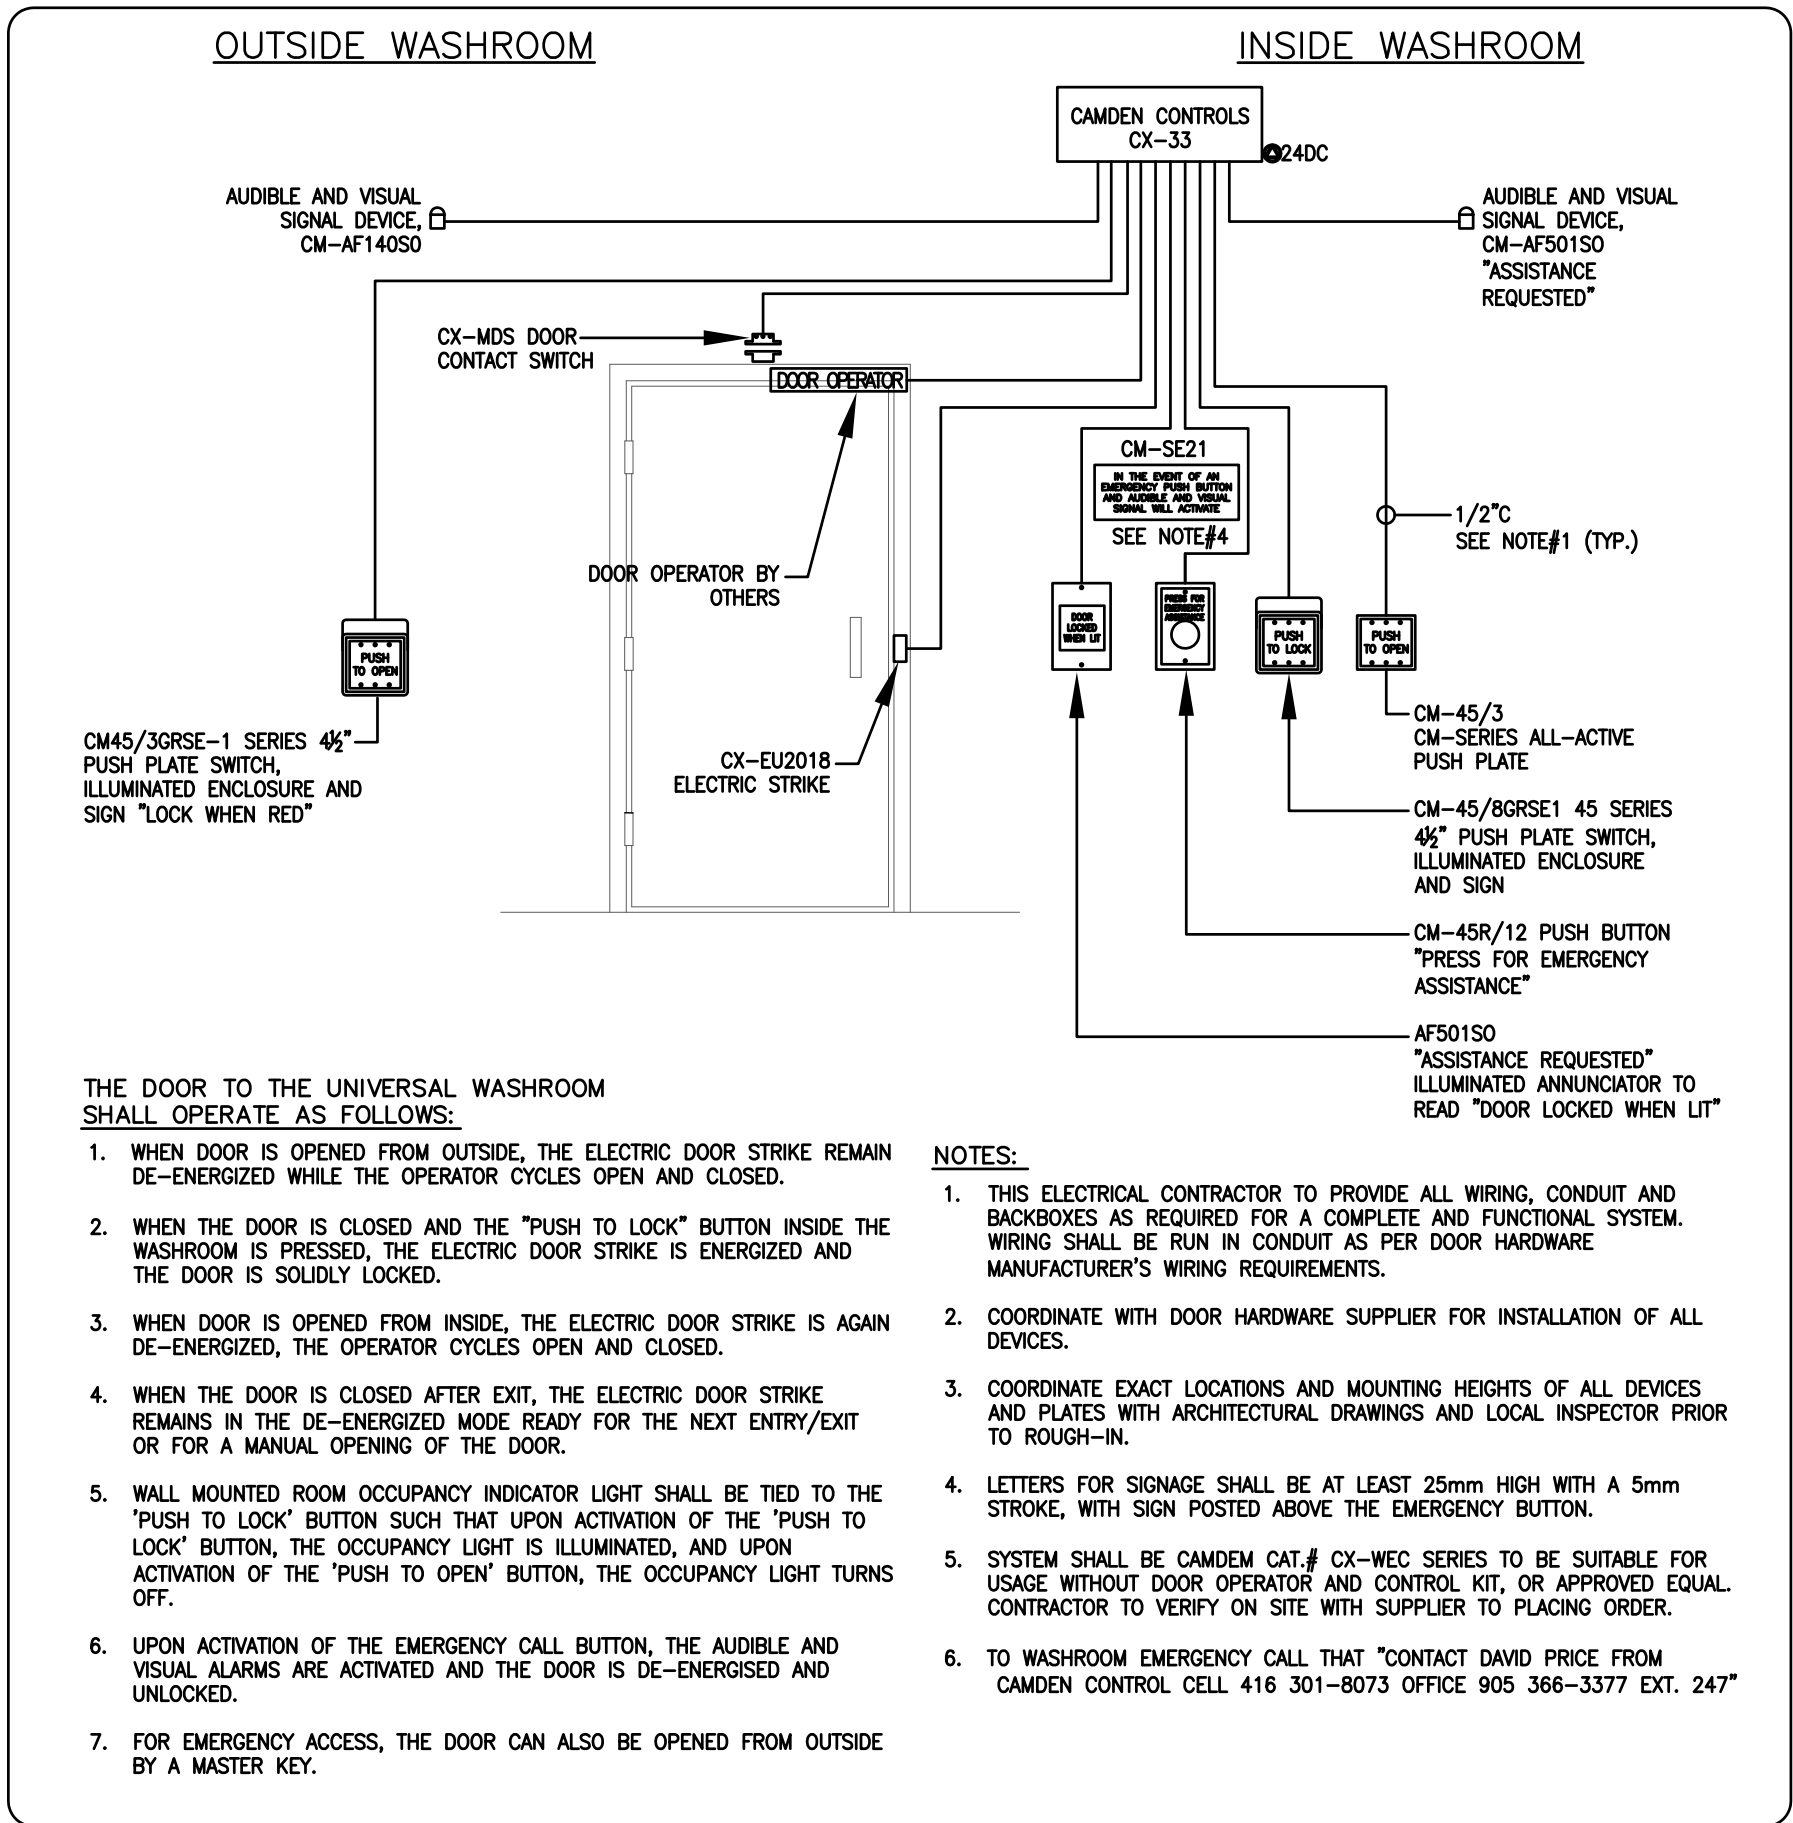
PLOT DATE PROJECT No.
18-776

DRAWING TITLE

MECHANICAL DETAILS

DATE	2018	M-3
DRAWN BY	JW	
SCALE	NTS	

OF 3

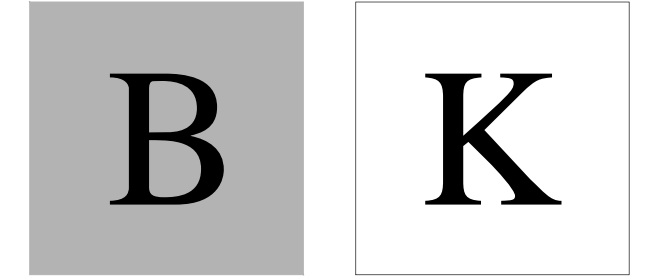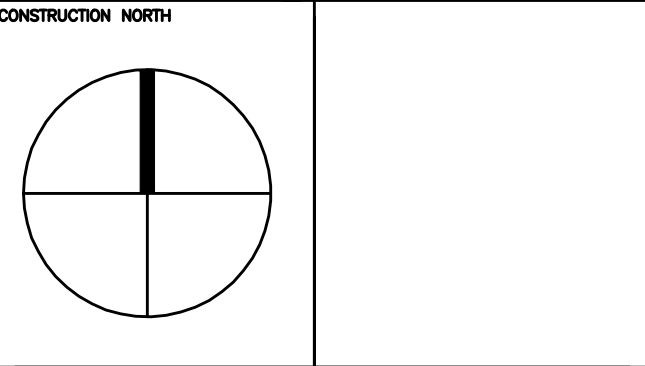

1 UNIVERSAL WASHROOM DOOR AND CALL FOR ASSISTANCE SYSTEM

E2 SCALE: N.T.S.

PANEL SCHEDULE								
PANEL	AMPS	VOLTAGE	PHASE	WIRE	CIRCUIT	TYPE	MOUNTING	
A	200	120/240	1	3	42	NEW	SURFACE	
NOTES:								
* ON LIGHTING CONTACTOR								
MAIN BREAKER TO MATCH EXISTING SERVICE SIZE								
3.0KW								
SUPPLY/INSTALL ALL QUANTITY AND SIZE OF BREAKERS REQUIRED FOR SPLASH PAD.								
VIA TIMER/CONTACTOR								

PANEL SCHEDULE								
PANEL	AMPS	VOLTAGE	PHASE	WIRE	CIRCUIT	TYPE	MOUNTING	
B	60	120/240	1	3	12	NEW	SURFACE	
NOTES:								
THIS PANEL IS CONTROLLED BY TIMER								
AUTO DOOR/CALL FOR ASSISTANCE 15A								
AUTO DOOR/CALL FOR ASSISTANCE 15A								
AUTO DOOR OPERATORS 15A								
SPARE 15A								
SPARE 15A								
SPACE								
DOOR STRIKE POWER SUPPLY 15A								
SPACE								
TVSS 30A 2P								

- 120V 25A 1P FOR 3KW HOT WATER TANK. CCT# A-7
- NEW OVERHEAD ELECTRICAL SERVICE. REPLACE EXISTING OVERHEAD FEEDERS WITH NEW TO SUIT NEW PANEL/LAYOUT. COORDINATE ALL WORK WITH HYDRO SERVICE PROVIDER.
- NEW PANEL 'A' AND SUB PANEL 'B' AND METER. PANEL B SERVES AUTO DOORS AND DOOR STRIKE POWER SUPPLY. PANEL B IS CONTROLLED BY A 24HR/7DAY PROGRAMMABLE TIMER SET TO DE-ENERGIZE PANEL AFTER HOURS. DOORS STRIKES SHALL BE WIRED IN 'FAIL SECURE' MODE TO LOCK DOORS AFTER HOURS.
- 1/2" CONDUIT FROM URINAL TO URINAL AND/OR TOILET TO TOILET, RUN BACK UNDER SINK FOR AUTOFLUSH LOW VOLTAGE WIRING
- SECURITY CAMERA. RUN 1/2" C W/ PULLSTRING FROM EACH CAMERA AND RUN BACK INTO ELECTRICAL ROOM.
- LIGHTS AND EXHAUST FAN CONTROLLED BY CEILING MOUNTED OCCUPANCY SENSOR. CIRCUIT NUMBER AS SHOWN.
- POWER SUPPLY UNDER SINK FOR AUTO SINK/TOILET/URINAL
- CHAIN HUNG LIGHT ON OCC SENSOR. DUPLEX RECEPTACLE. CCT# A-11
- COMBO CO/SMOKE. CONNECT INTO LOCAL BRANCH LIGHTING CIRCUIT. NON-SWITCHED (BEFORE OCCUPANCY SENSOR)
- SOFFIT LIGHTS. TYPE AS NOTED. ON LIGHTING CONTROL. CCT# A-15
- DOOR STRIKES TO BE FED FROM PONY PANEL 'B' WHICH DE-ENERGIZES AND LOCKS DOORS AFTERHOURS. TYPICAL
- DC LED LAMPHEAD. WIRED BACK TO BATTERY UNIT IN ELEC ROOM.
- WASHROOM CALL FOR ASSISTANCE SYSTEM. CIRCUIT AS NOTED. SUPPLY/INSTALL CAMDEN DOOR CONTROL INC. WASHROOM CALL FOR ASSISTANCE SYSTEM. REFER TO DETAIL (1/E2). [CONTACT DAVID PRICE/MARKETING MANAGER/CAMDEN DOOR CONTROLS/OFFICE] 905 366-3377 EXT. 247/MARKETING@CAMDENCNTRLS.COM
- AUTO DOOR OPERATOR & PUSH BUTTONS. FED FROM PONY PANEL 'B'. CIRCUIT NUMBER AS NOTED.
- PHOTOCELL. EXACT LOC'N TBD. WITH 24HR/7DAY EXTERIOR ELECTRONIC LIGHTING CONTROL TIMER OVERRIDE AND LIGHTING CONTACTOR PANEL BY ELEC CONTRACTOR.
- EXHAUST FAN ON TIMER. CCT# A-4
- NEW INCOMING TELEPHONE SERVICE LOCATION. INSTALL OUTLET NEXT TO ELEC PANELS FOR SECURITY EQUIPMENT.

