

Architects Engineers Project Managers



201-250 Water Street, Whitby, Ontario Canada L1N 0G5

Tele: 905-666-5252 Toronto: 905-427-4495 Fax: 905-666-5256 Email: bba@bba-archeng.com www.bba-archeng.com

Addendum No. 2

Page 1 of 1

Project No.: 19037

Date: April 8, 2019

Project: Durham College Whitby Farming Expansion

1610 Champlain Ave, Whitby, Ontario

The following information supplements and/or supersedes the bid documents issued on March 19, 2019. This Addendum forms part of the contract documents and is to be read, interpreted, and coordinated with all other parts. The cost of all contained herein is to be included in the contract sum. The following revisions supersede the information contained in the original drawings and specifications issued for the above-named project to the extent referenced and shall become part thereof.

GENERAL ADDENDUM ITEMS

1.1 The following dates are outdoor events held at the Centre for Food (CFF). The awarded General Contractor is to ensure no work shall be going on during the following date and time. The site to be left tidy for these events.

May 23 from 6:00pm-11:00pm June 7 from 2:00pm-11:00pm June 11 from 11:00am-9:00pm

- 1.2 Revised Site Plan A102:
 - a) Additional new sanitary invert and main indicated on 1/A102, along with associated demolition as noted on 2/A102.
 - b) Site legend added for drawing clarity.
- 1.3 New Civil Site Plan drawing CV-1

SPECIFICATIONS

1.4 BASE BID

The Base Bid for this project includes the following: All Utilities and Services

All Culties and Servi

All Foundation work

All Site Restoration

Post Harvest Building

MECHANICAL/ELECTRICAL

1.5 Refer to MEI Addendum No. 1 date April 5 2019 attached outlining mechanical and electrical revisions to the contract documents.

END OF ADDENDUM NO. 2

Barry Bryan Associates

Architects, Engineers, Project Managers

Crystal Gardner, OAA

CG/nb

Attachments: Drawings No. A102 and CV-1 (2 Pages)

MEI Addendum ADDM1 (2 Pages)

CONTRACTOR TO CONTACT MGM CONSULTING INC. IMMEDIATELY SHOULD THERE BE ANY CONFLICTS BETWEEN EXISTING CONDITIONS AND PROPOSED GRADING AND/OR SERVICING DESIGN, OR CONFLICTS IN CONSTRUCTING THE WORK AS PER THE INTENT OF THE APPROVED DESIGN PRIOR TO CONSTRUCTION.

1. ALL WORK TO CONFORM TO THE LATEST MUNICIPAL STANDARDS AND SPECIFICATIONS AS WELL AS THE LATEST ADOPTED ONTARIO PROVINCIAL

STANDARD DRAWINGS AND SPECIFICATIONS. 2. ALL DISTURBED AREAS TO BE RESTORED TO ORIGINAL CONDITION OR BETTER

TO SATISFACTION OF THE MUNICIPALITY AND MGM CONSULTING INC. 3. CONTRACTOR TO LOCATE AND PROTECT ALL EXISTING SERVICES AND UTILITIES PRIOR TO AND DURING CONSTRUCTION

4. CONTRACTOR TO LOCATE AND CONFIRM ALL EXISTING UTILITIES AND SERVICE INFORMATION PRIOR CONSTRUCTION 5. CONTRACTOR TO ENSURE ADEQUATE CLEARANCE FROM ALL EXISTING


SERVICES AND UTILITIES 6. CONTRACTOR TO CONFIRM ALL EXISTING INVERTS PRIOR TO INTERNAL

7. CONTRACTOR TO CONFIRM THE PAVEMENT STRUCTURE THICKNESS' BASED ON

THE GEOTECHNICAL REPORT. 8. WATERMAIN TO BE INSTALLED WITH A 1.8m MINIMUM COVER.

9. ALL SEWER AND WATERMAIN CROSSINGS TO HAVE A MINIMUM VERTICAL SEPARATION OF 0.5m.

10. SANITARY MANHOLES PER OPSD 701.010, GRATE PER OPSD 401.010.

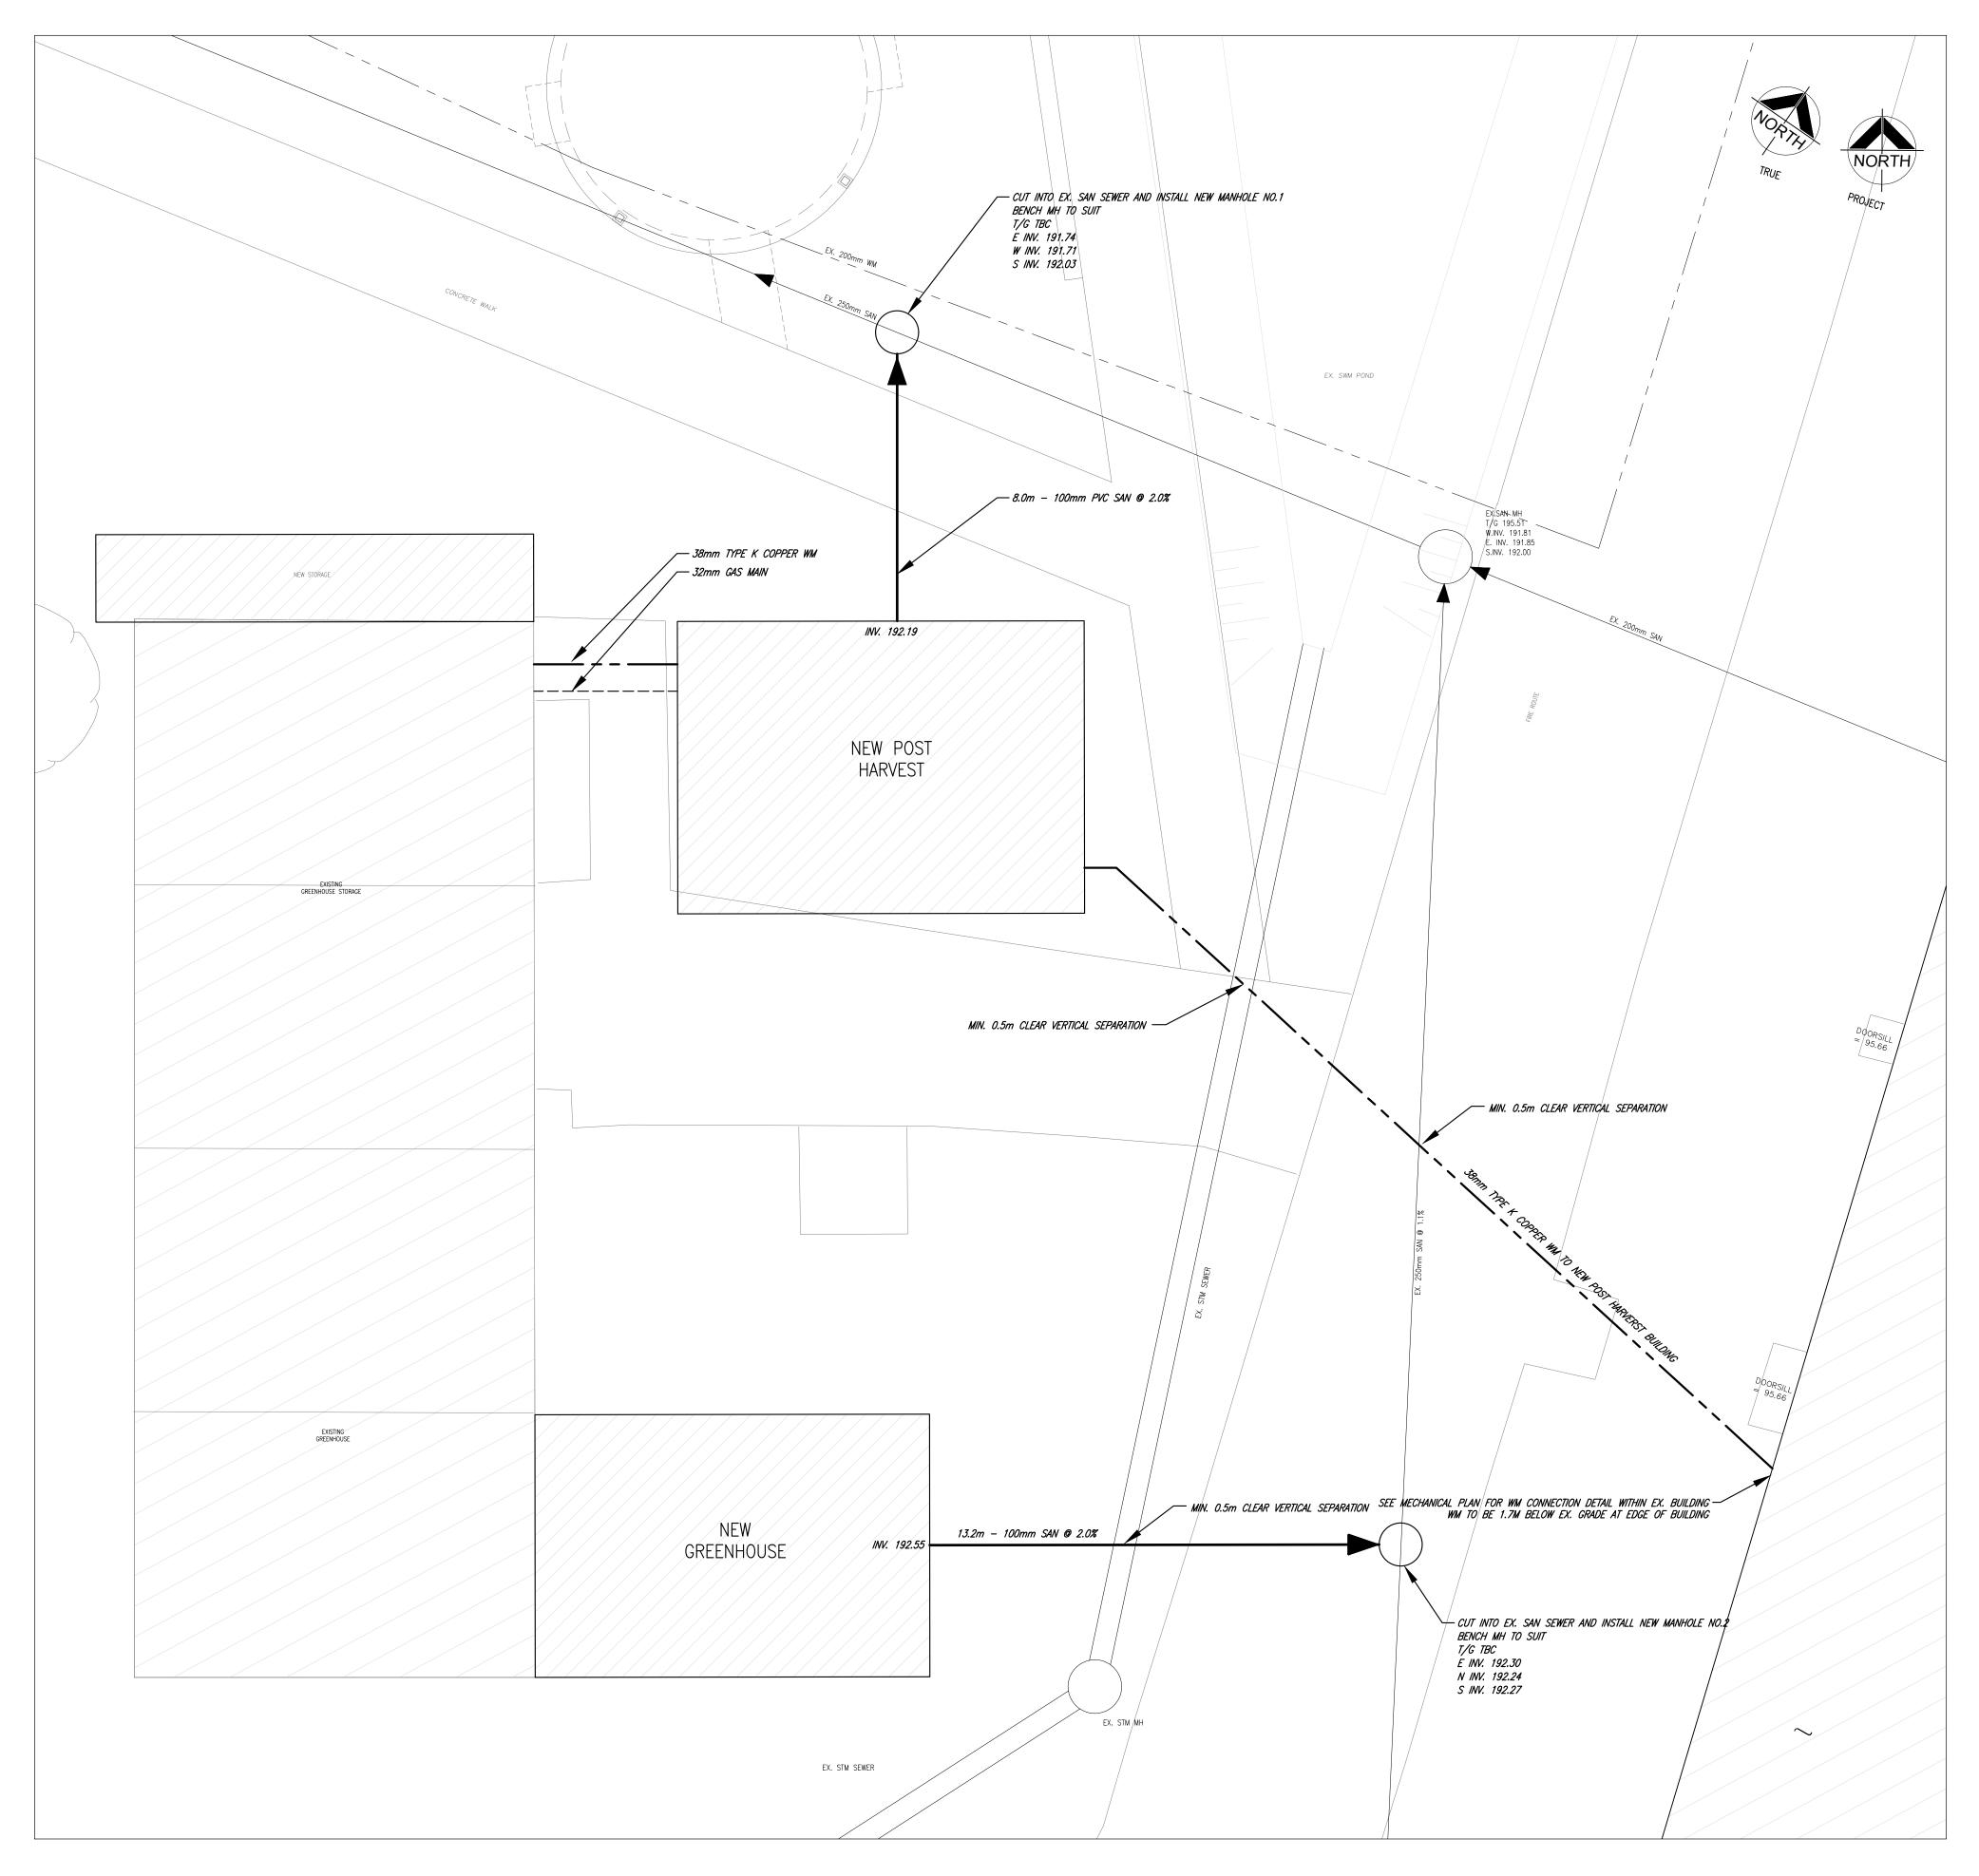


DO NOT SCALE THE DRAWINGS CHECK AND VERIFY ALL DIMENSIONS AT THE SITE.

ALL DRAWINGS, SPECIFICATIONS AND RELATED DOCUMENTS ARE THE COPYRIGHT PROPERTY OF THE CONSULTANT AND MUST BE RETURNED UPON REQUEST. REPRODUCTION OF DRAWINGS IN PART OR WHOLE WITHOUT THE PERMISSION OF THE CONSULTANT IS FORBIDDEN.

DRAWINGS ARE NOT TO BE USED FOR CONSTRUCTION UNTIL SIGNED AND SEALED BY THE CONSULTANT.

NO.	ISSUES	DATE	BY
1	ISSUED FOR PERMIT	29/03/19	JB
2	ISSUED FOR ADDENDUM 1	03/04/19	JB

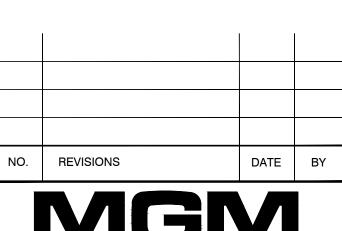

CONSULTING INC

Consulting Engineering & Project Management 400 Bronte Street South Tel: (905)567-8678 Fax: (905)875-1339 Email: mgm@mgm.on.ca www.mgm.on.ca

GENERAL NOTES

- THIS DRAWING IS THE PROPERTY OF MADONNA ENGINEERING INC. AND CANNOT BE REPRODUCED WITHOUT WRITTEN PERMISSION.
- ALL MEASUREMENTS MUST BE VERIFIED ON SITE BY CONTRACTOR
 AND REPORT ANY DISCREPANCIES TO MADONNA ENGINEERING
 INC. BEFORE PROCEEDING WITH THE WORK.
- DO NOT SCALE DRAWINGS. THIS DRAWING SHALL NOT BE USED FOR CONSTRUCTION UNLESS NOTED AS "ISSUED FOR CONSTRUCTION" BELOW.

PROJECT:

Weston Farming Expansion

1610 CHAMPLAIN AVENUE WHITBY, ONTARIO L1N 9B2

DURHAM COLLEGE

DRAWING:

SERVICING PLAN





% COMPLETE:

BARRY BRYAN **ASSOCIATES** Architects Engineers Project Managers 250 Water Street Suite 201 Whitby, Ontario L1N 0G5

Tel: (905) 666-5252 Fax: (905) 666-5256 e-mail: bba@bba-archeng.com

MAR. 2019 1:150 FILE:


DESIGN BY:

DRAWN BY:

CHECKED BY:

PROJECT NO: 2019-20

DRAWING NO: CV-1

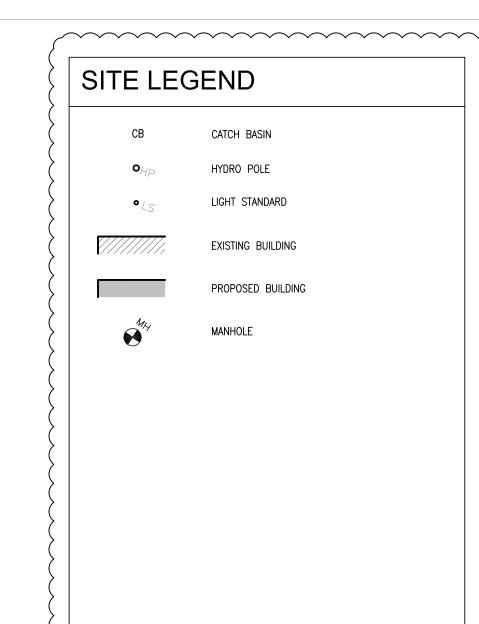

DEMOLITION NOTES

- 1 REMOVE EXISTING ASPHALT
- SAWCUT REMOVE ASPHALT UP TO THIS POINT; FOR 300mm BEYOND SAWCUT, GRIND AWAY ASPHALT TO A DEPTH OF 40mm FOR NEW ASPHALT LAP JOINT
- REMOVE AND SALVAGE PAVING STONES FOR REUSE
- 4 REMOVE PAVING STONES UP TO THIS POINT
- REMOVE AND SALVAGE PAVING STONES FOR REUSE; STORE AS DIRECTED BY COLLEGE
- 6 EXISTING GREENHOUSE TO BE REMOVED FOR REUSE BY COLLEGE; STORE ON SITE WHERE DIRECTED BY COLLEGE STAFF
- EXISTING BOULDERS; TO BE MOVED AND REPLACED AS NECESSARY FOR SITE WORK
- REMOVE EXISTING SOD AS REQUIRED FOR NEW CONSTRUCTION AND SITE WORK SEE MECHANICAL AND ELECTRICAL DRAWINGS
- 9 CORE EXISTING CONCRETE SLAB ON GRADE FOR NEW WATER MAIN SEE MECHANICAL DRAWINGS

CORE EXISTING CONCRETE SLAB ON GRADE FOR NEW ELECTRICAL CONNECTION — SEE ELECTRICAL DRAWINGS

REMOVE EXISTING ASPHALT(C/W SAWCUTS) THROUGH FIRE ROUTE AS REQUIRED FOR SITE WORK - SEE MÉCHANICAL AND ELECTRICAL DRAWINGS; EXCAVATION THROUGH FIRE ROUTE TO BE COMPLETED AFTER HOURS AND ACCESS MAINTAINED THROUGH WORKING HOURS

PROPOSED LAYOUT NOTES

- REPLACE DAMAGED SOD AROUND NEW WORK
- . NEW ASPHALT TO LAP WITH EXISTING ASPHALT TO A LEVEL TRANSITION BETWEEN THE TWO
- . PRE-FAB SHIPPING CONTAINER BY FREIGHT FARM, ZIPGROW INC., OR APPROVED EQUIVALENT




ALL DRAWINGS, SPECIFICATIONS AND RELATED DOCUMENTS ARE THE COPYRIGHT PROPERTY OF THE CONSULTANT AND MUST BE RETURNED UPON REQUEST. REPRODUCTION OF DRAWINGS IN PART OR WHOLE WITHOUT THE PERMISSION OF THE CONSULTANT IS FORBIDDEN.


DRAWINGS ARE NOT TO BE USED FOR CONSTRUCTION UNTIL SIGNED AND SEALED BY THE CONSULTANT.

DO NOT SCALE THE DRAWINGS CHECK AND VERIFY ALL DIMENSIONS AT THE SITE.

NO.	ISSUES	DATE	ВҮ
1	80% CLIENT REVIEW	MAR 21 2019	BBA
2	ISSUED FOR PERMIT/TENDER	MAR 29 2019	BBA
3	ISSUED FOR ADDENDUM 1	APR 3 2019	BBA

DATE BY

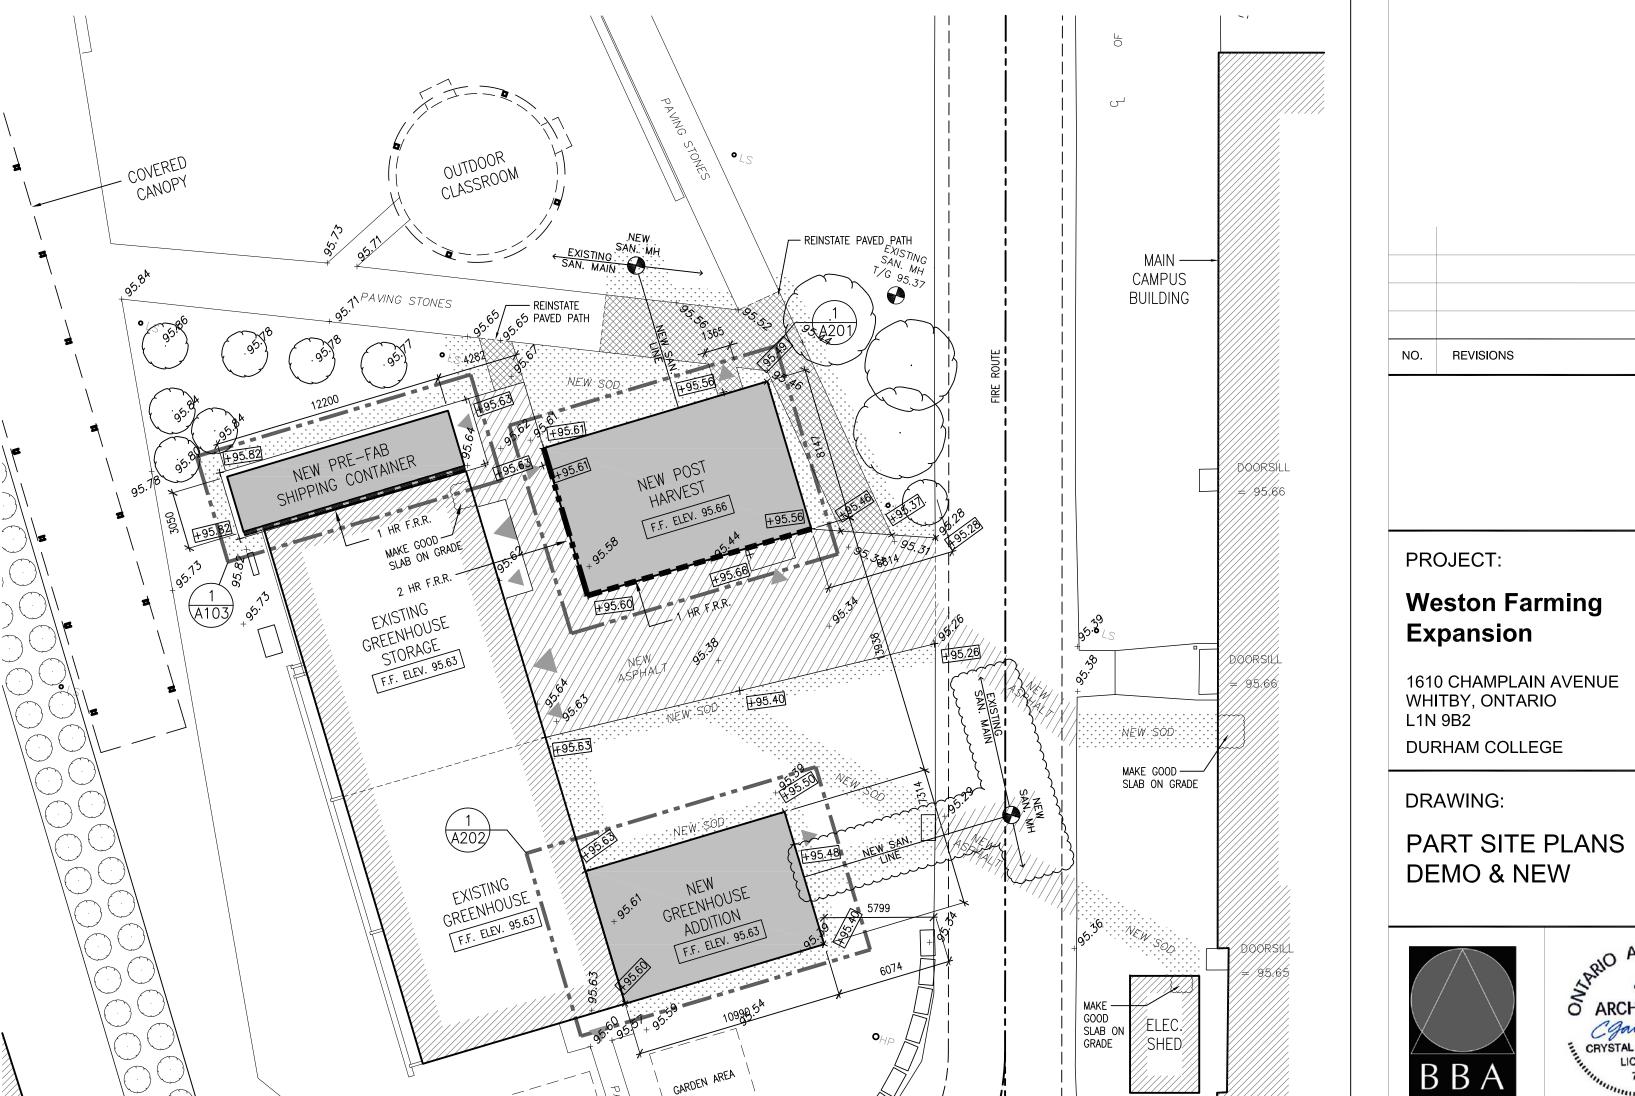

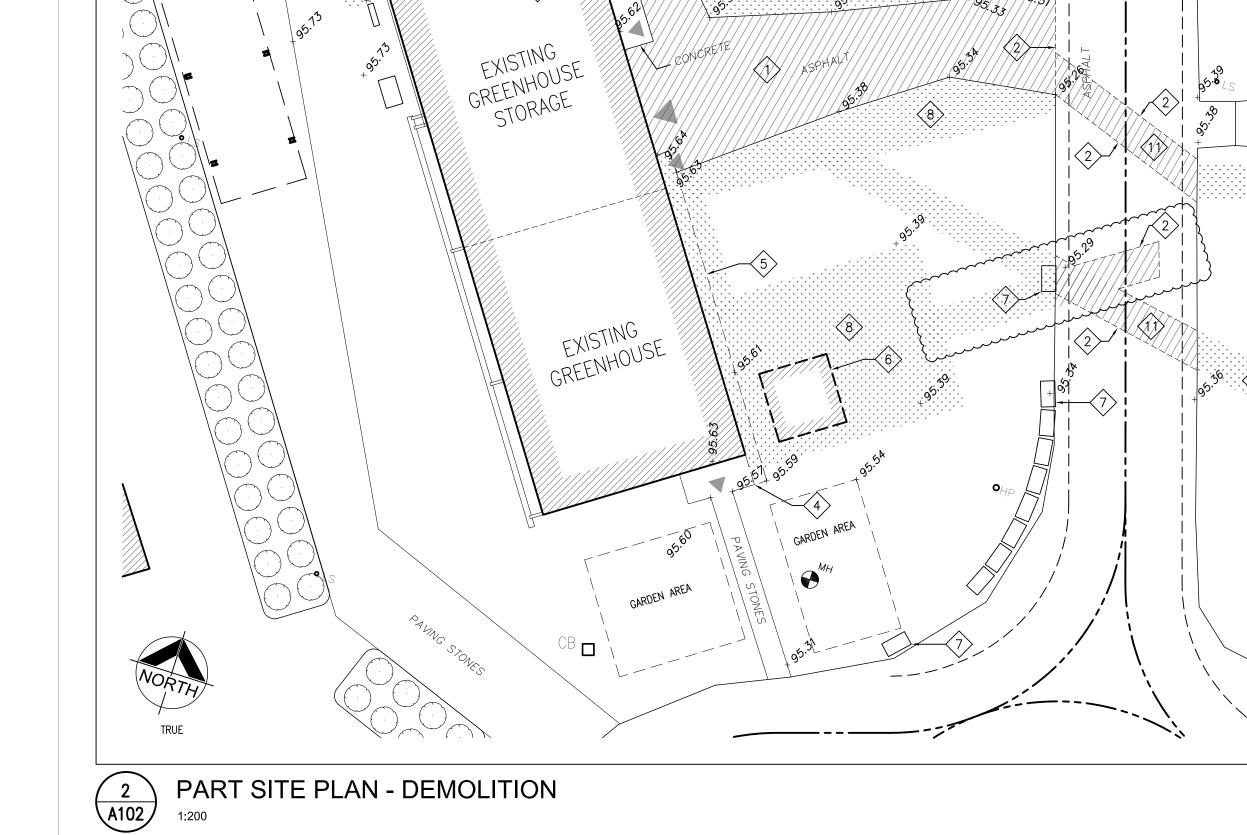

CLASSROOM

ALL EXCAVATION TO BE BY HYDRO EXCAVATION

COVERED CANOPY



CAMPUS

BUILDING

ÉLEC, SHED

DOORSILL

=/95,66

PART SITE PLAN - NEW

EXISTING CB ...

BARRY BRYAN ASSOCIATES

Architects Engineers Project Managers 250 Water Street Suite 201

PROJECT NO:

DRAWN BY: CHECKED BY: CM/CE/DM MAR. 2019

DESIGN BY: CG

ARCHITECTS 2

CRYSTAL MOHAMMED
LICENCE
7871

Whitby, Ontario L1N 0G5 Tel: (905) 666-5252 Fax: (905) 666-5256 e-mail: bba@bba-archeng.com

DRAWING NO: A102 19037

AS NOTED

Weston Farming Expansion 1610 Champlain Ave. Whitby, ON Addendum ADDM1



MADONNA ENGINEERING INC.

93 Woodstream Blvd, Unit 10 Woodbridge, Ontario L4L 7Y7

T: (905) 265-1911 F: (905) 265-1998

То:	Barry Bryan Associates 250 Water St., Suite 201 Whitby, Ontario L1N 0G5	From:	Madonna Engineering Inc. Jeremy Hogan			
Phone:	905-666-5252	Date:	April 5, 2019			
Re:	ADDM1	CC:	Anton Freundorfer			
Attn:	Crystal Gardner	Project No.:	19-0028			
□URGEN ☑BY EM	_	□PLEASE COMMENT □BY FAX	□PLEASE REPLY □BY HAND □BY PICK-UP			
This Addendum ADDM1 forms part of the contract documents.						

1. Reference

1. Drawing, M-6, Mechanical Schedules, Rev. 04, April 5, 2019. Not issued with this ADDM1. Refer to sketch SKM-ADDM1-M6.1.

2. Description

- 1. <u>SKM-ADDM1-M6.1:</u>
 - 1. Addition of S2 and S3 to Plumbing Fixture Schedule.

3. Reason for Revision

1. Clarification.

End of ADDM1

	FIXTURES		EDULE PIPE CONNECTION		ECTION	
SYMBOL	SPECIFICATION	TRAP	COLD WATER	HOT WATER	DRAIN	VEN ⁻
S1	HAND SINK	1-1/2 " ø	1/2"ø	1/2 " ø	1-1/2"ø	1-1/4
~~~	NOVANNI #7501—SH 711 X 711 MM (28 X 28") SINGLE STAINLESS STEEL UTILITY SINK ON LEGS, 711 X 711 MM (28 X 28 IN), 304 TYPE, 16 GAUGE, SATIN FINISH, COVED FRONT TO BACK, 203 MM (8 IN) BACKSPLASH, ROUNDED RIM, STAINLESS STEEL LEGS WITH ADJUSTABLE FEET, 89 MM (3 1/2 IN) CUP DRAIN ASSEMBLY SITUATED IN CENTER OF BOWL. PREDRILLED BACKSPLASH HAS SPECIFIED FAUCET.  ZURN #Z841B4—XL WALL MOUNT, TWO HANDLE FAUCET, LOW LEAD, CAST BRASS BODY, LONG SWIVEL INLETS, 102 TO 213 MM (4 TO 8 3/8 IN) CENTER, CERAMIC DISC CARTRIDGES, POLISHED CHROME FINISH, 102 MM (4 IN) VANDAL—RESISTANT COLORCODED METAL WRIST BLADE HANDLES, 137 MM (5 3/8 IN) SWING/RIGID GOOSENECK WITH 8.3 L/MIN. (2.2 USGPM) PRESSURE COMPENSATING AERATOR, INCORPORATED CHECKSTOPS, 13 MM (1/2 IN) NPT FEMALE INLETS.  ZURN #Z8702—9BD 38 MM (1 1/2") CAST BRASS ADJUSTABLE P—TRAP, 38 MM (1 1/2 IN) WITH CLEANOUT, DEEP SEAL FLANCE, POLISHED CHROME FINISH:		•	~~		
 S2	TRIPLE BASIN SINK	1-1/2"ø	1/2"ø	1/2"ø	1-1/2 <b>"</b> ø	1-1/4
	NOVANNI #7511—SH 1915 X 700 MM (75—3/8" X 27—5/8") TRIPLE BOWL STAINLESS STEEL SCULLERY SINK ON LEGS, 304 TYPE, 16 GAUGE, SATIN FINISH, COVED FRONT TO BACK, 203 MM (8 IN) BACKSPLASH, ROUNDED RIM, STAINLESS STEEL LEGS WITH ADJUSTABLE FEET, 89 MM (3 1/2 IN) CUP DRAIN ASSEMBLY SITUATED IN CENTER OF BOWL. PREDRILLED BACKSPLASH HAS SPECIFIED FAUCET.  ZURN #Z841B4—XL (QTY—3) WALL MOUNT, TWO HANDLE FAUCET, LOW LEAD, CAST BRASS BODY, LONG SWIVEL INLETS, 102 TO 213 MM (4 TO 8 3/8 IN) CENTER, CERAMIC DISC CARTRIDGES, POLISHED CHROME FINISH, 102 MM (4 IN) VANDAL—RESISTANT COLORCODED METAL WRIST BLADE HANDLES, 137 MM (5 3/8 IN) SWING/RIGID GOOSENECK WITH 8.3 L/MIN. (2.2 USGPM) PRESSURE COMPENSATING AERATOR, INCORPORATED CHECKSTOPS, 13 MM (1/2 IN) NPT FEMALE INLETS.  ZURN #Z8702—9BD 38 MM (1 1/2") CAST BRASS ADJUSTABLE P—TRAP, 38 MM (1 1/2 IN) WITH CLEANOUT, DEEP SEAL FLANGE, POLISHED CHROME FINISH.					
\$3	SINGLE BASIN SINK  NOVANNI #75SP752814-SH 1915 X 700 MM (75-3/8" X 27-5/8") SINGLE STAINLESS STEEL UTILITY SINK ON LEGS, 304 TYPE, 16 GAUGE, SATIN FINISH, COVED FRONT TO BACK, 203 MM (8 IN) BACKSPLASH, ROUNDED RIM, STAINLESS STEEL LEGS WITH ADJUSTABLE FEET, 89 MM (3 1/2 IN) CUP DRAIN ASSEMBLY SITUATED IN CENTER OF BOWL. PREDRILLED BACKSPLASH HAS SPECIFIED FAUCET.  ZURN #Z841B4-XL WALL MOUNT, TWO HANDLE FAUCET, LOW LEAD, CAST BRASS BODY, LONG SWIVEL INLETS, 102 TO 213 MM (4 TO 8 3/8 IN) CENTER, CERAMIC DISC CARTRIDGES, POLISHED CHROME FINISH, 102 MM (4 IN) VANDAL-RESISTANT COLORCODED METAL WRIST BLADE HANDLES, 137 MM (5 3/8 IN) SWING/RIGID GOOSENECK WITH 8.3 L/MIN. (2.2 USGPM) PRESSURE COMPENSATING AERATOR, INCORPORATED CHECKSTOPS, 13 MM (1/2 IN) NPT FEMALE INLETS.  ZURN #Z8702-9BD 38 MM (1 1/2") CAST BRASS ADJUSTABLE P-TRAP, 38 MM (1 1/2 IN) WITH CLEANOUT, DEEP SEAL FLANGE, POLISHED CHROME FINISH.	1-1/2 <b>"</b> ø	1/2 <b>"</b> ø	1/2 <b>"</b> ø	1-1/2"ø	1-1/4
<b>₩</b>	FOHNEL-FLOOR DRAIN	~ <del>**</del>			~~~	1-1/

### THIS SKETCH SHALL BE READ IN CONJUNCTION WITH DRAWING M-6 AND ADDM1

	WESTON FARMING EXPANSION 1610 CHAMPLAIN AVE. WHITBY, ON	JH	2019-04-05	SKETCH No.
MADONNA ENGINEERING INC. 93 Woodstream Blvd Unit 10 Woodbridge, Ontario L4L 7Y7 Tel: (905) 265 1911 Fax: (905) 265 1998		SCALE NTS	CHECKED AM	SKM-ADDM1-M6.1
PLUMBING FIXTURE SCHED	REVISED ——	PREJECT NUMBER 19-0028		